
# Appendix G

**Design Drawing Package** 

## SAN JACINTO RIVER WASTE PITS NORTHERN IMPOUNDMENT FINAL 100% REMEDIAL DESIGN HARRIS COUNTY, TEXAS

JULY 2024 11215702

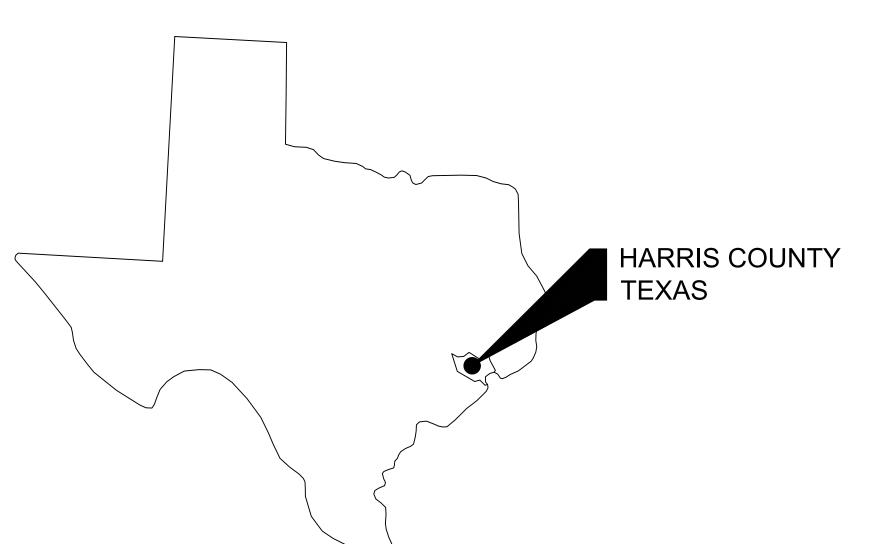


STATE OF TEXAS VICINITY MAP




HARRIS COUNTY

**VICINITY MAP** 

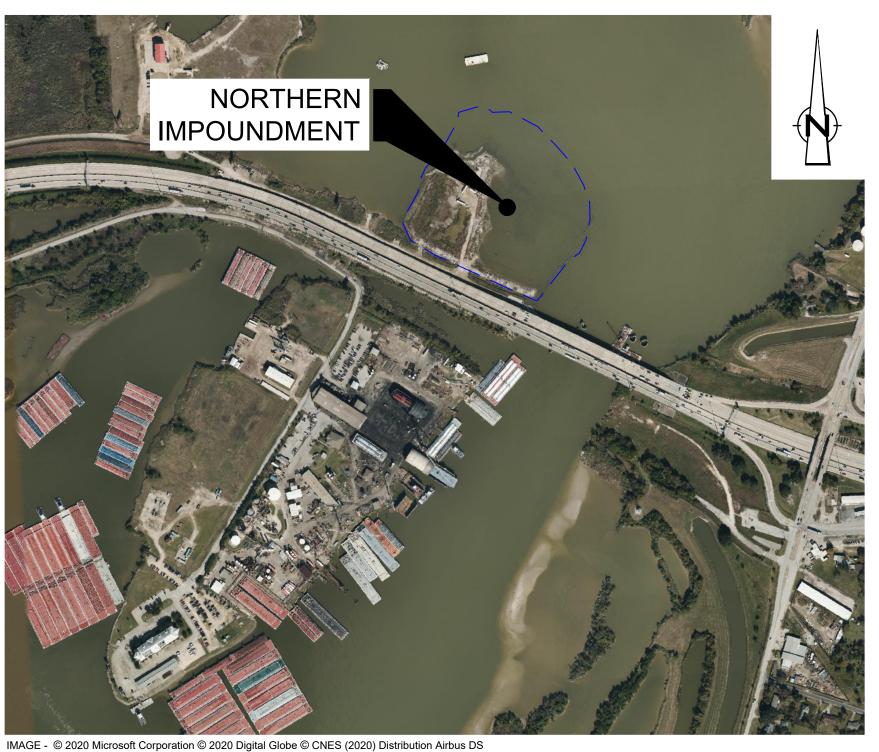





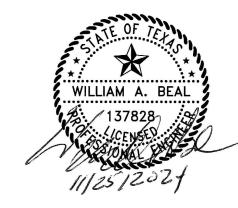






DRAWING NAME **GENERAL SERIES COVER SHEET** CIVIL SERIES OVERALL PLAN **EXISTING CONDITIONS** SSA AREA AND NORTHERN IMPOUNDMENT WORKS SOIL EROSION AND SEDIMENT CONTROL PLAN - OVERALL SOIL EROSION AND SEDIMENT CONTROL PLAN - SEASONAL SOIL FROSION AND SEDIMENT CONTROL DETAILS PROJECT TRAFFIC CONTROL PLAN **EXCAVATION PLAN - OVERALI EXCAVATION PLAN NORTHWES EXCAVATION PLAN NORTHEAS EXCAVATION PLAN SOUTHEAS EXCAVATION PLAN SOUTHWEST** EXCAVATION SECTION - 1 OF 6 **EXCAVATION SECTION - 2 OF 6 EXCAVATION SECTION - 3 OF 6** EXCAVATION SECTION - 4 OF 6 EXCAVATION SECTION - 5 OF 6 EXCAVATION SECTION - 6 OF 6 TYPICAL SEASONAL EXCAVATION SEQUENCING TYPICAL EXCAVATION SEQUENCING - 1 OF 2 TYPICAL EXCAVATION SEQUENCING - 2 OF 2 RESTORATION PLAN TYPICAL CONSTRUCTION SEQUENCING - 1 OF 2 TYPICAL CONSTRUCTION SEQUENCING - 2 OF 2 TYPICAL DETAILS - 1 OF 3 TYPICAL DETAILS - 2 OF 3 TYPICAL DETAILS - 3 OF 3 PILE WALL LAYOUT PLAN DOUBLE PILE WALL PLAN AND PROFILE - 1 OF 4 DOUBLE PILE WALL PLAN AND PROFILE - 2 OF 4 DOUBLE PILE WALL PLAN AND PROFILE - 3 OF 4 DOUBLE PILE WALL PLAN AND PROFILE - 4 OF 4 SOUTH WALL PLAN AND PROFILE - 1 OF 2 SOUTH WALL PLAN AND PROFILE - 2 OF 2 DOUBLE PILE WALL SECTIONS - 1 OF 7 DOUBLE PILE WALL SECTIONS - 2 OF 7 DOUBLE PILE WALL SECTIONS - 3 OF 7 DOUBLE PILE WALL SECTIONS - 5 OF 7 DOUBLE PILE WALL SECTIONS - 6 OF 7 DOUBLE PILE WALL SECTIONS - 7 OF 7 SOUTH WALL SECTIONS - 1 OF 3 SOUTH WALL SECTIONS - 2 OF 3 SOUTH WALL SECTIONS - 3 OF 3 DREDGING NORTHWEST CORNER WORKS PLAN DREDGING NORTHWEST CORNER DREDGING CONTROLS DREDGING NORTHWEST CORNER DRY EXCAVATION DREDGING NORTHWEST CORNER WET EXCAVATION DREDGING NORTHWEST CORNER SECTIONS 1 OF 2 DREDGING NORTHWEST CORNER SECTIONS 2 OF 2 DREDGING NORTHWEST CORNER SEQUENCING 1 OF 3 C-52 C-53 C-54 DREDGING NORTHWEST CORNER SEQUENCING 2 OF 3 DREDGING NORTHWEST CORNER SEQUENCING 3 OF 3 DREDGING NORTHWEST CORNER FINAL GRADE C-55 C-56 C-57 DREDGING NORTHWEST CORNER DREDGING DETAILS RESTORATION SECTIONS 1 OF 2 **RESTORATION SECTIONS 2 OF 2** STRUCTURAL SERIES STRUCTURAL NOTES S-02 STRUCTURAL LAYOUT PLAN STRUCTURAL SECTIONS S-03 S-04 STRUCTURAL DETAILS 1 OF 2

S-05 STRUCTURAL DETAILS 2 OF 2
S-06 FRP BARRIER WALL

PROCESS FLOW AND INSTRUMENTATION SERIES

WATER TREATMENT SYSTEM PROCESS FLOW DIAGRAM SYMBOLS WATER TREATMENT SYSTEM PROCESS FLOW DIAGRAM SCHEDULES WATER TREATMENT SYSTEM PROCESS FLOW DIAGRAM (NON-CONTACT WATER) P-03 WATER TREATMENT SYSTEM P&ID (NON-CONTACT WATER) (1 OF 3) WATER TREATMENT SYSTEM P&ID (NON-CONTACT WATER) (2 OF 3 WATER TREATMENT SYSTEM P&ID (NON-CONTACT WATER) (3 OF 3) WATER TREATMENT SYSTEM P&ID (CONTACT WATER) (2 OF 4) WATER TREATMENT SYSTEM P&ID (CONTACT WATER) (3 OF 4) WATER TREATMENT SYSTEM P&ID (CONTACT WATER) (4 OF 4 WATER TREATMENT SYSTEM SITE PLAN (NON-CONTACT WATER) WATER TREATMENT SYSTEM EQUIPMENT LAYOUT (NON-CONTACT WATER) WATER TREATMENT SYSTEM SITE PLAN (CONTACT WATER) WATER TREATMENT SYSTEM EQUIPMENT LAYOUT (CONTACT WATER) (1 OF 2) WATER TREATMENT SYSTEM EQUIPMENT LAYOUT (CONTACT WATER) (2 OF 2) P-16 HELICAL PILE DETAILS MECHANICAL SCHEDULE

THIS DOCUMENT IS RELEASED FOR THE PURPOSE OF EPA REVIEW UNDER THE AUTHORITY OF CLARENCE R. HOEKSTRA, P.E. 147937, WILLIAM ALLEN BEAL, P.E. 137828, SATISH CHILKA, P.E. 145120, AND NORTON FOGEL, P.E. 144491 ON 11/25/2024. IT IS NOT TO BE USED FOR CONSTRUCTION PURPOSES, BIDDING, RECORDATION, CONVEYANCE OR SALES PURPOSES.

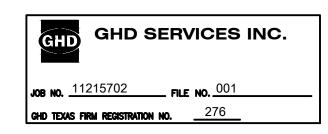

100% EPA SUBMITTAL



GHD
2237 S Acadian Thruway Suite 701
Baton Rouge Louisiana 70808 USA
T 225 292 9007

Reuse of Documents

This document and the ideas and designs incorporated herein, as an instrument of professional service, is the property of GHD and shall not be reused in whole or in part for any other project without GHD's written authorization. © 2024 GHD

SAN JACINTO RIVER
WASTE PITS

NORTHERN IMPOUNDMENT FINAL 100% REMEDIAL DESIGN HARRIS COUNTY, TEXAS

	HARRIS COL	JN I Y,	IEX	45	
8	100% EPA SUBMITTAL	JC	CRH	11/25/202	
7	FOR CLIENT REVIEW	JC	CRH	11/21/202	
6	100% EPA SUBMITTAL	MW	CRH	07/17/202	
No.	Issue	Drawn	Approved	Date	
Drawn <b>JC</b>		Designer RH			
)rafti Chec	~ въ	Design Check	LL		
Project CM Coordinator		Date	Nov 25, 2024		
this document shall not be used for onstruction unless signed and sealed for onstruction.		Scale N.T.S.			
Original Size		_	ar is one in ginal size d		

Project No. **11215702** 

Arch D


**COVER SHEET** 

Sheet No.

G-01

Sheet **1** of **83** 

Plot Date: 25 November 2024 - 4:37 PM

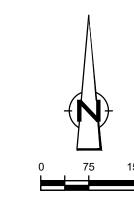





Reuse of Documents

This document and the ideas and designs incorporated herein, as an instrument of professional service, is the property of GHD and shall not be reused in whole or in part for any other project without GHD's written authorization. © 2024 GHD

— – – — TxDOT RIGHT OF WAY — — TCRA CAP PERIMETER \_\_\_\_\_ x \_\_\_\_ FENCELINE SHORELINE
TOP OF BANK

\_\_\_\_\_ \\ \_\_\_\_ PIPELINE

---- TOE OF SLOPE OVERHEAD ELECTRICAL ——O——O GUARDRAIL

> MONITORING WELL POWER POLE LIGHT POLE

■ SJSB002 BORING LOCATION

ASPHALT CONCRETE GRAVEL

## **SAN JACINTO RIVER WASTE PITS**

NORTHERN IMPOUNDMENT FINAL 100% REMEDIAL DESIGN HARRIS COUNTY, TEXAS

7	100% EPA SUBMITTAL	JC	CRH	11/25
6	FOR CLIENT REVIEW	JC	CRH	11/21
5	100% EPA SUBMITTAL	MW	CRH	07/17
No.	Issue	Drawn	Approved	Da
Draw	n <b>JC</b>	Designer	RH	
Drafting BS Check		Design Check	LL	
Proje Coor	ct dinator <b>CM</b>	Date	Nov 25, 20	)24
	document shall not be used for uction unless signed and sealed for uction.	Scale	1" = 150'	
Origii	nal Size  Arch D	_	Bar is one in iginal size d	

Project No. **11215702** 


**OVERALL** 

**PLAN** 

Sheet No.

C-01


Sheet **2** of **83** 

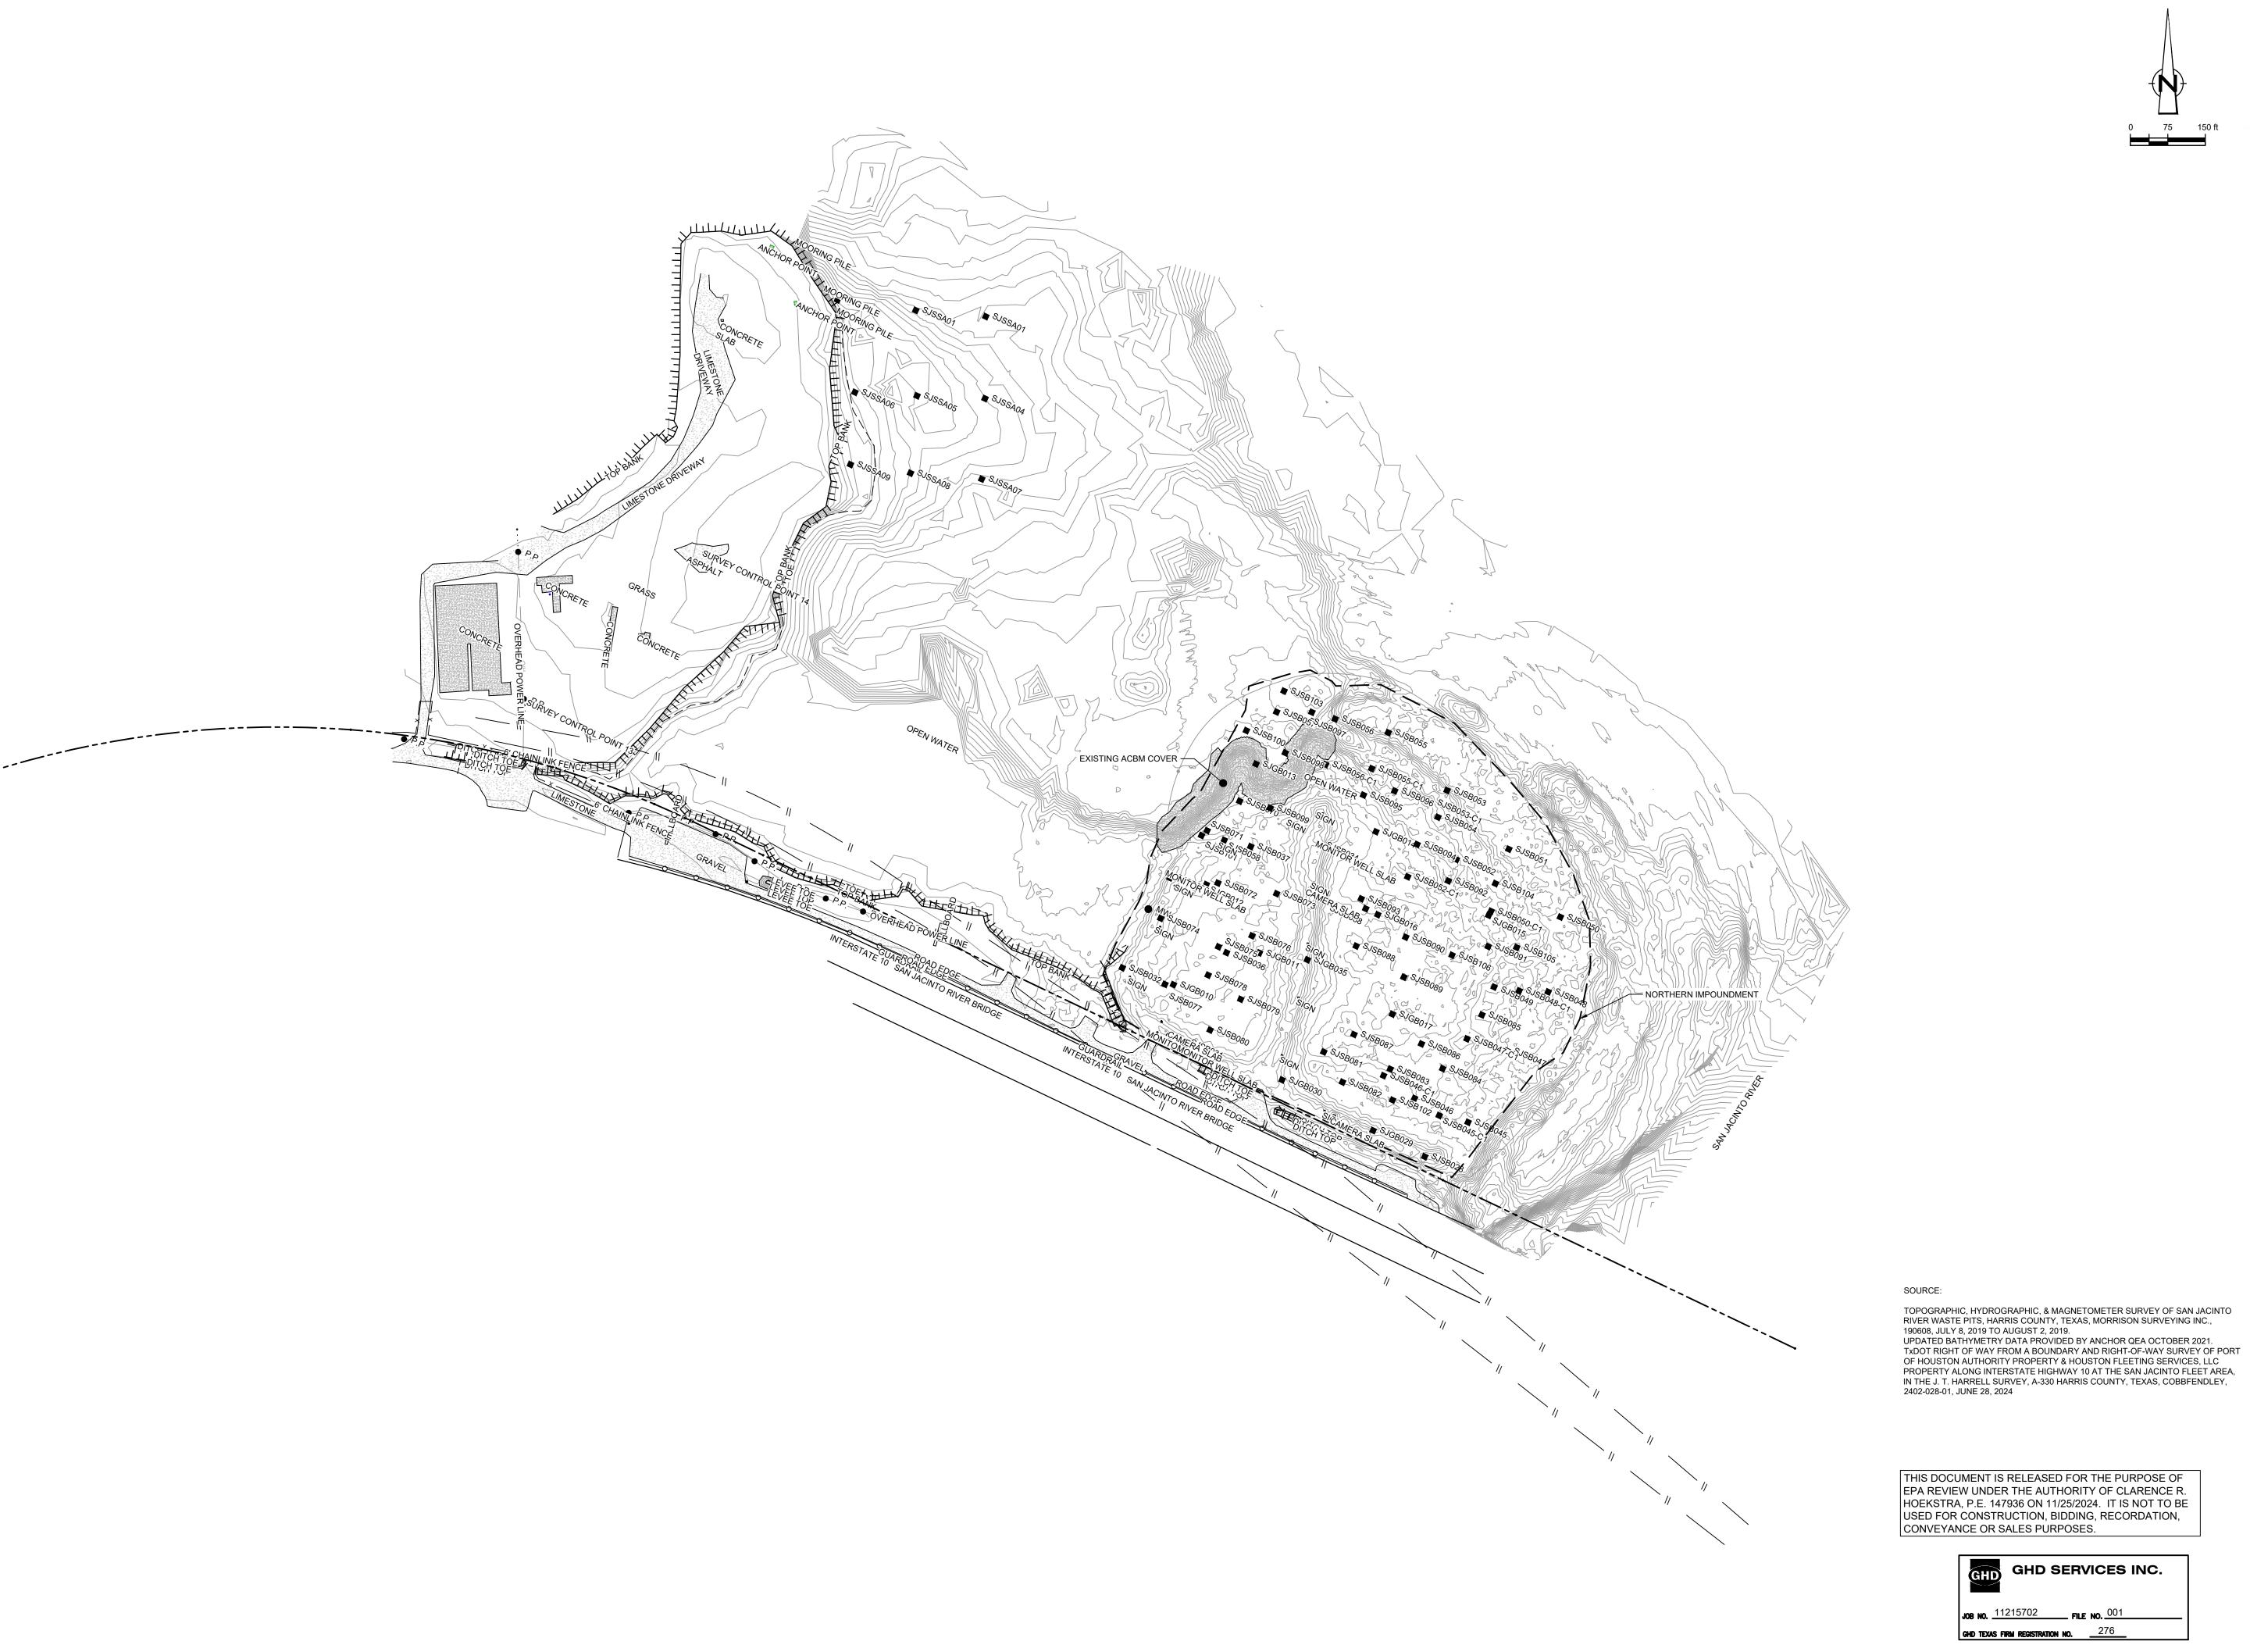

GHD SERVICES INC.

100% EPA SUBMITTAL

Plot Date: 25 November 2024 - 3:05 PM

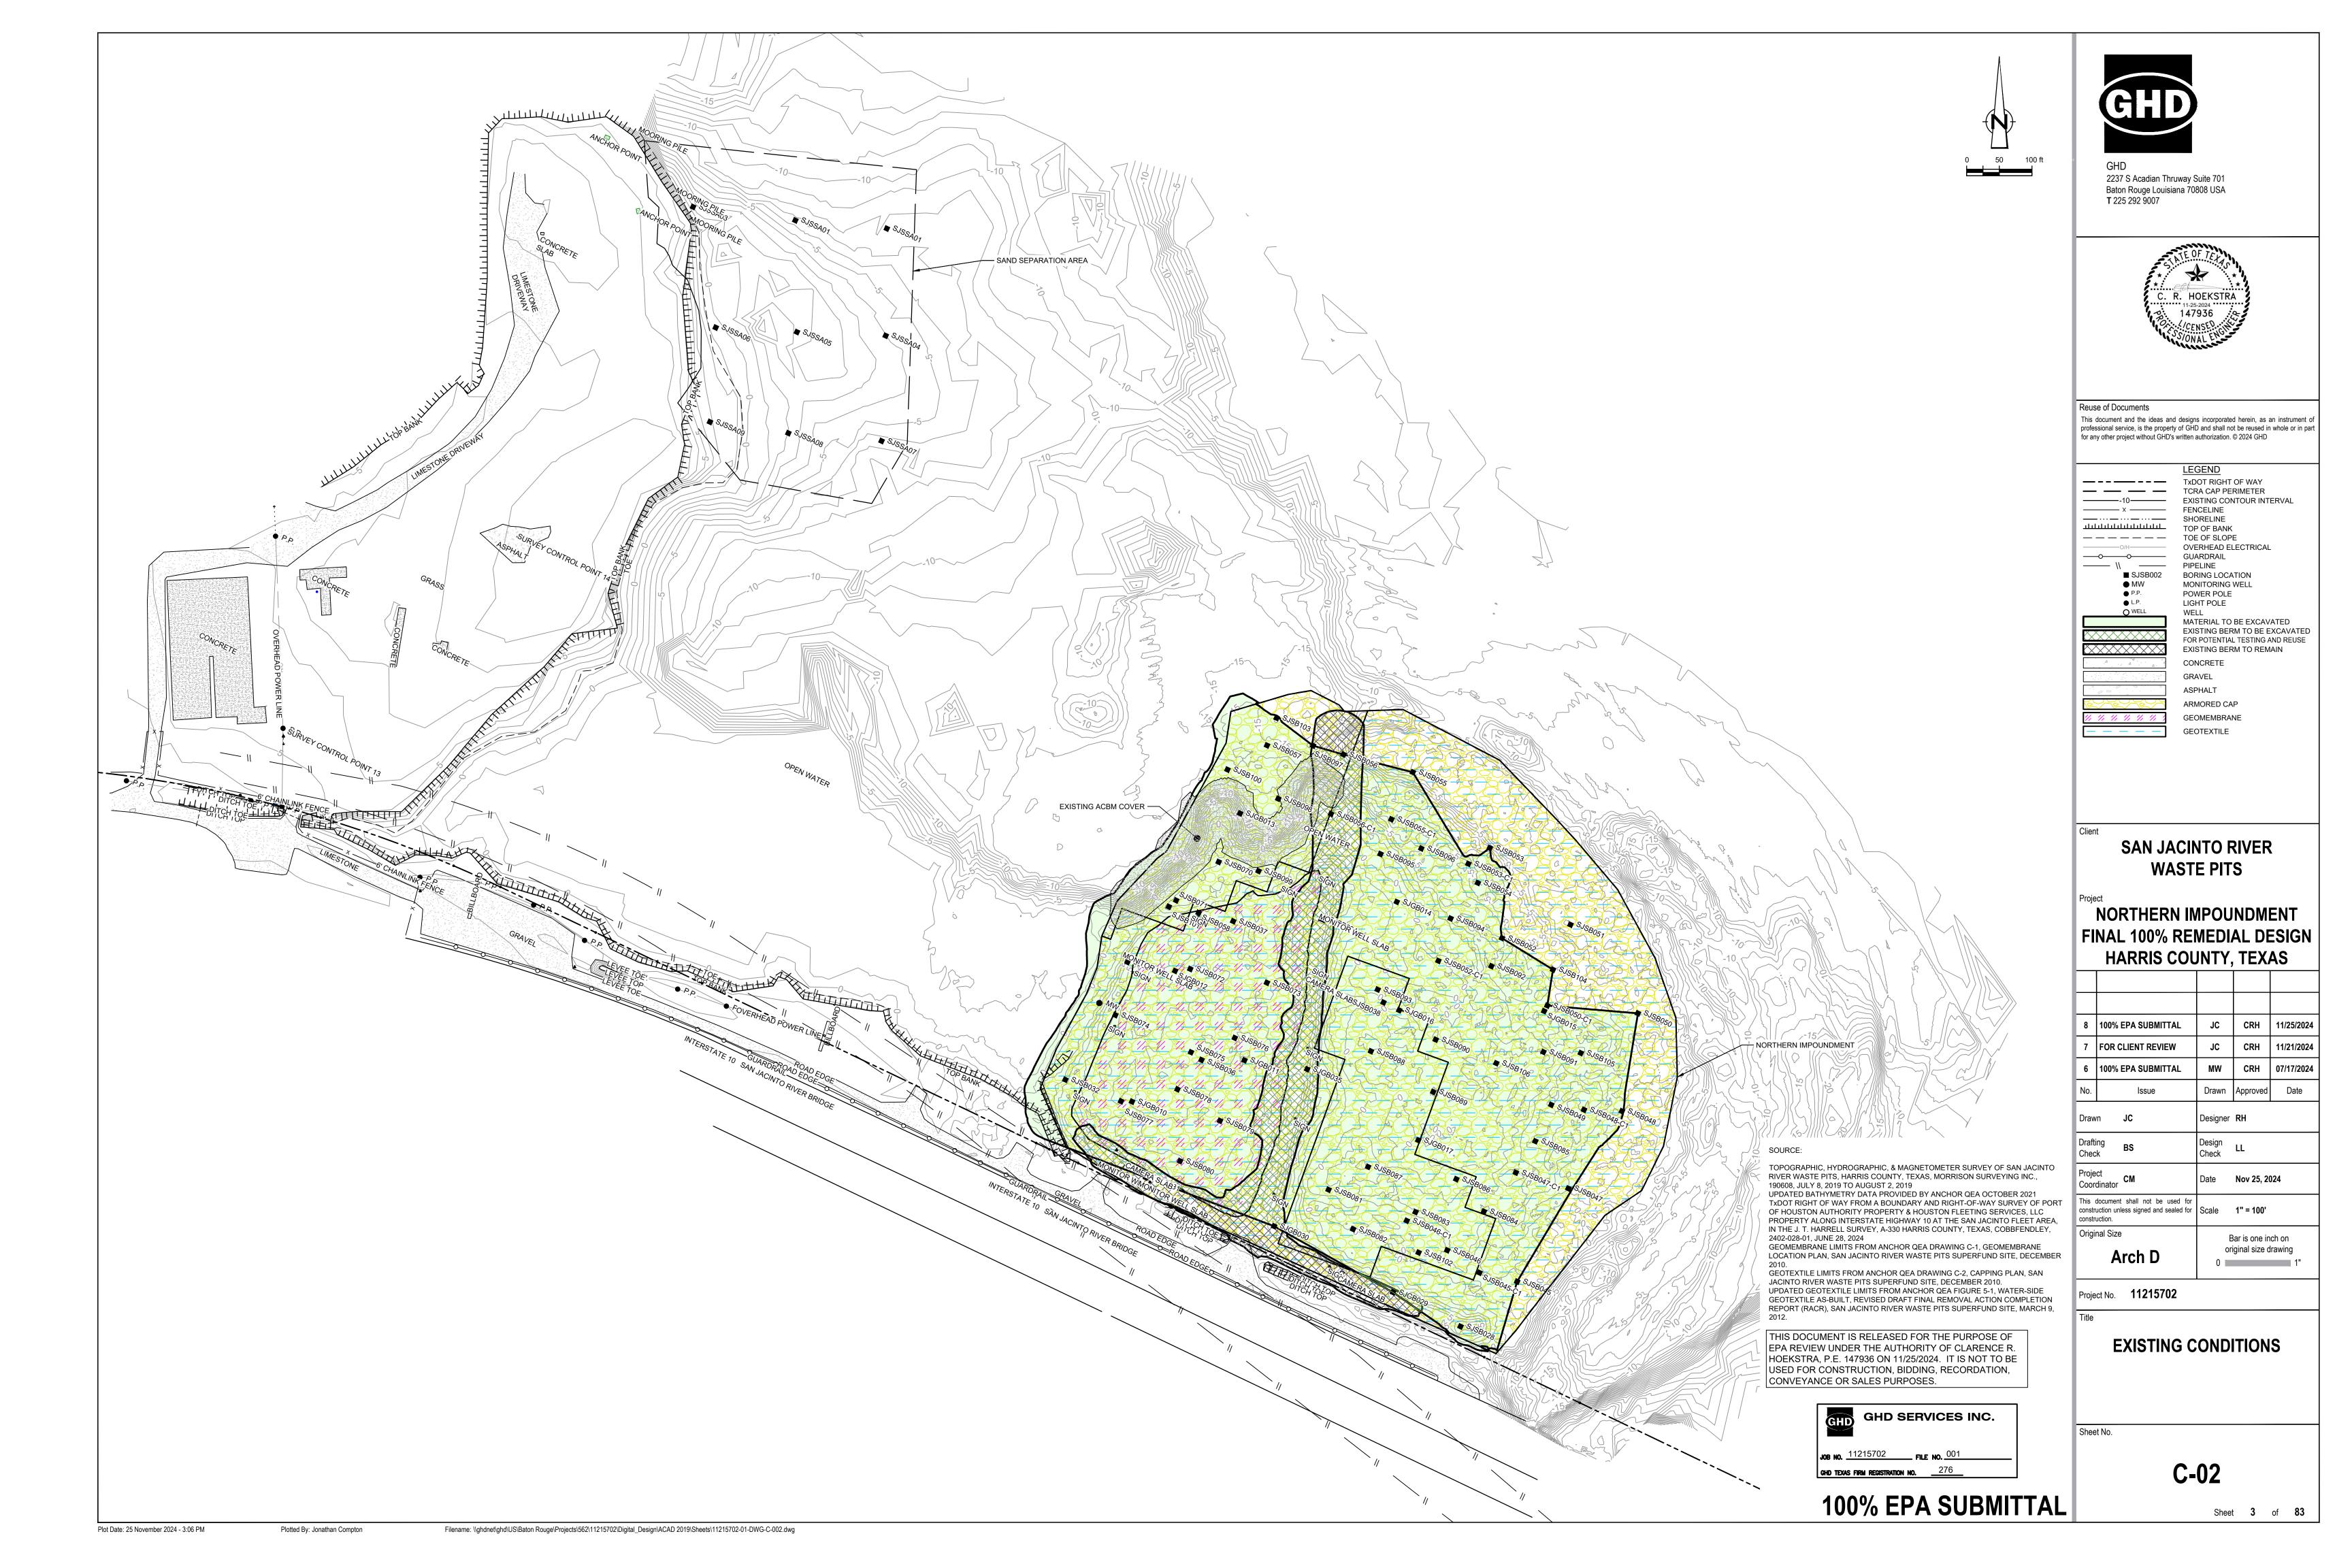







### Reuse of Documents

This document and the ideas and designs incorporated herein, as an instrument of professional service, is the property of GHD and shall not be reused in whole or in part for any other project without GHD's written authorization. © 2024 GHD

ı		
	10	LEGEND  TXDOT RIGHT OF WAY TCRA CAP PERIMETER EXISTING CONTOUR INTERVAL FENCELINE SHORELINE TOP OF BANK TOE OF SLOPE OVERHEAD ELECTRICAL GUARDRAIL
	SJSB002  MW P.P. L.P. WELL	PIPELINE BORING LOCATION MONITORING WELL POWER POLE LIGHT POLE WELL MATERIAL TO BE EXCAVATED EXISTING BERM TO BE EXCAVATE FOR POTENTIAL TESTING AND REUSI EXISTING BERM TO REMAIN
ı		CONCRETE
ı		GRAVEL
		ASPHALT AZ26-700 PILE AZ36-700 PILE AZ42-700 PILE FRP BARRIER WALL PLANNED IMPROVEMENTS FOR NORTHERN IMPOUNDMENT ACCE SOIL TYPE S1
ı		RAISED BENCH
		EXTERIOR SCOUR PROTECTION
		INTERIOR SCOUR PROTECTION

**SAN JACINTO RIVER WASTE PITS** 

NORTHERN IMPOUNDMENT FINAL 100% REMEDIAL DESIGN HARRIS COUNTY, TEXAS

CRH 11/25/2024

Date Nov 25, 2024

Bar is one inch on original size drawing

	8	100% EPA SUBMITTAL	JC	CRH	
	7	FOR CLIENT REVIEW	JC	CRH	
	6	100% EPA SUBMITTAL	MW	CRH	
	No.	Issue	Drawn	Approved	
	Draw	n <b>JC</b>	Designer	RH	
ACINTO C.,	Draft Chec	· BS	Design Check	LL	
21 OF PORT	Proje Coor	ct dinator <b>CM</b>	Date	Nov 25, 20	)
LLC ET AREA, IDLEY,	REA,	document shall not be used for uction unless signed and sealed for uction.	Scale	1" = 100'	
	Origi	nal Size  Arch D		Bar is one in iginal size d	

Arch D

Project No. **11215702** 

SSA AREA AND NORTHERN IMPOUNDMENT **WORKS** 

Sheet No.

C-03

Sheet **4** of **83** 







### Reuse of Documents

This document and the ideas and designs incorporated herein, as an instrument of professional service, is the property of GHD and shall not be reused in whole or in part for any other project without GHD's written authorization. © 2024 GHD

	LLGLIND
	TxDOT RIGHT OF WAY
	TCRA CAP PERIMETER
	EXISTING CONTOUR INTERVAL
X	FENCELINE
	SHORELINE
	TOP OF BANK
	TOE OF SLOPE
O/H	OVERHEAD ELECTRICAL
0	GUARDRAIL
\\	PIPELINE
SJSB002	BORING LOCATION
MW	MONITORING WELL
<ul><li>P.P.</li></ul>	POWER POLE
♠ L.P.	LIGHT POLE
O WELL	WELL
	MATERIAL TO BE EXCAVATED

EXISTING BERM TO BE EXCAVATED FOR POTENTIAL TESTING AND REUSE EXISTING BERM TO REMAIN

CONCRETE

GRAVEL

ASPHALT

ASPHALT

AZ26-700 PILE

AZ36-700 PILE

AZ42-700 PILE

FRP BARRIER WALL

SILT FENCE

TURBIDITY CURTAIN

OIL BOOM
PLANNED IMPROVEMENTS FOR
NORTHERN IMPOUNDMENT ACCESS
RAISED BENCH
EXTERIOR SCOUR PROTECTION

SAN JACINTO RIVER

INTERIOR SCOUR PROTECTION

## NORTHERN IMPOUNDMENT FINAL 100% REMEDIAL DESIGN HARRIS COUNTY, TEXAS

**WASTE PITS** 

8	100% EPA SUBMITTAL	JC	CRH	11/25/20
7	FOR CLIENT REVIEW	JC	CRH	11/21/20
6	100% EPA SUBMITTAL	MW	CRH	07/17/20
No.	Issue	Drawn	Approved	Date
Draw	n <b>JC</b>	Designer	RH	
Drafting BS		Design Check	LL	
Proje Coor	ct dinator	Date	Nov 25, 20	)24
This document shall not be used for construction unless signed and sealed for construction.		Scale	1" = 100'	
Origi	Original Size		Bar is one in	ch on
Arch D		or 0	iginal size d	lrawing

Project No. **11215702** 


Title

SOIL EROSION AND SEDIMENT CONTROL PLAN OVERALL

Sheet No.

C-04

Sheet 5 of 83

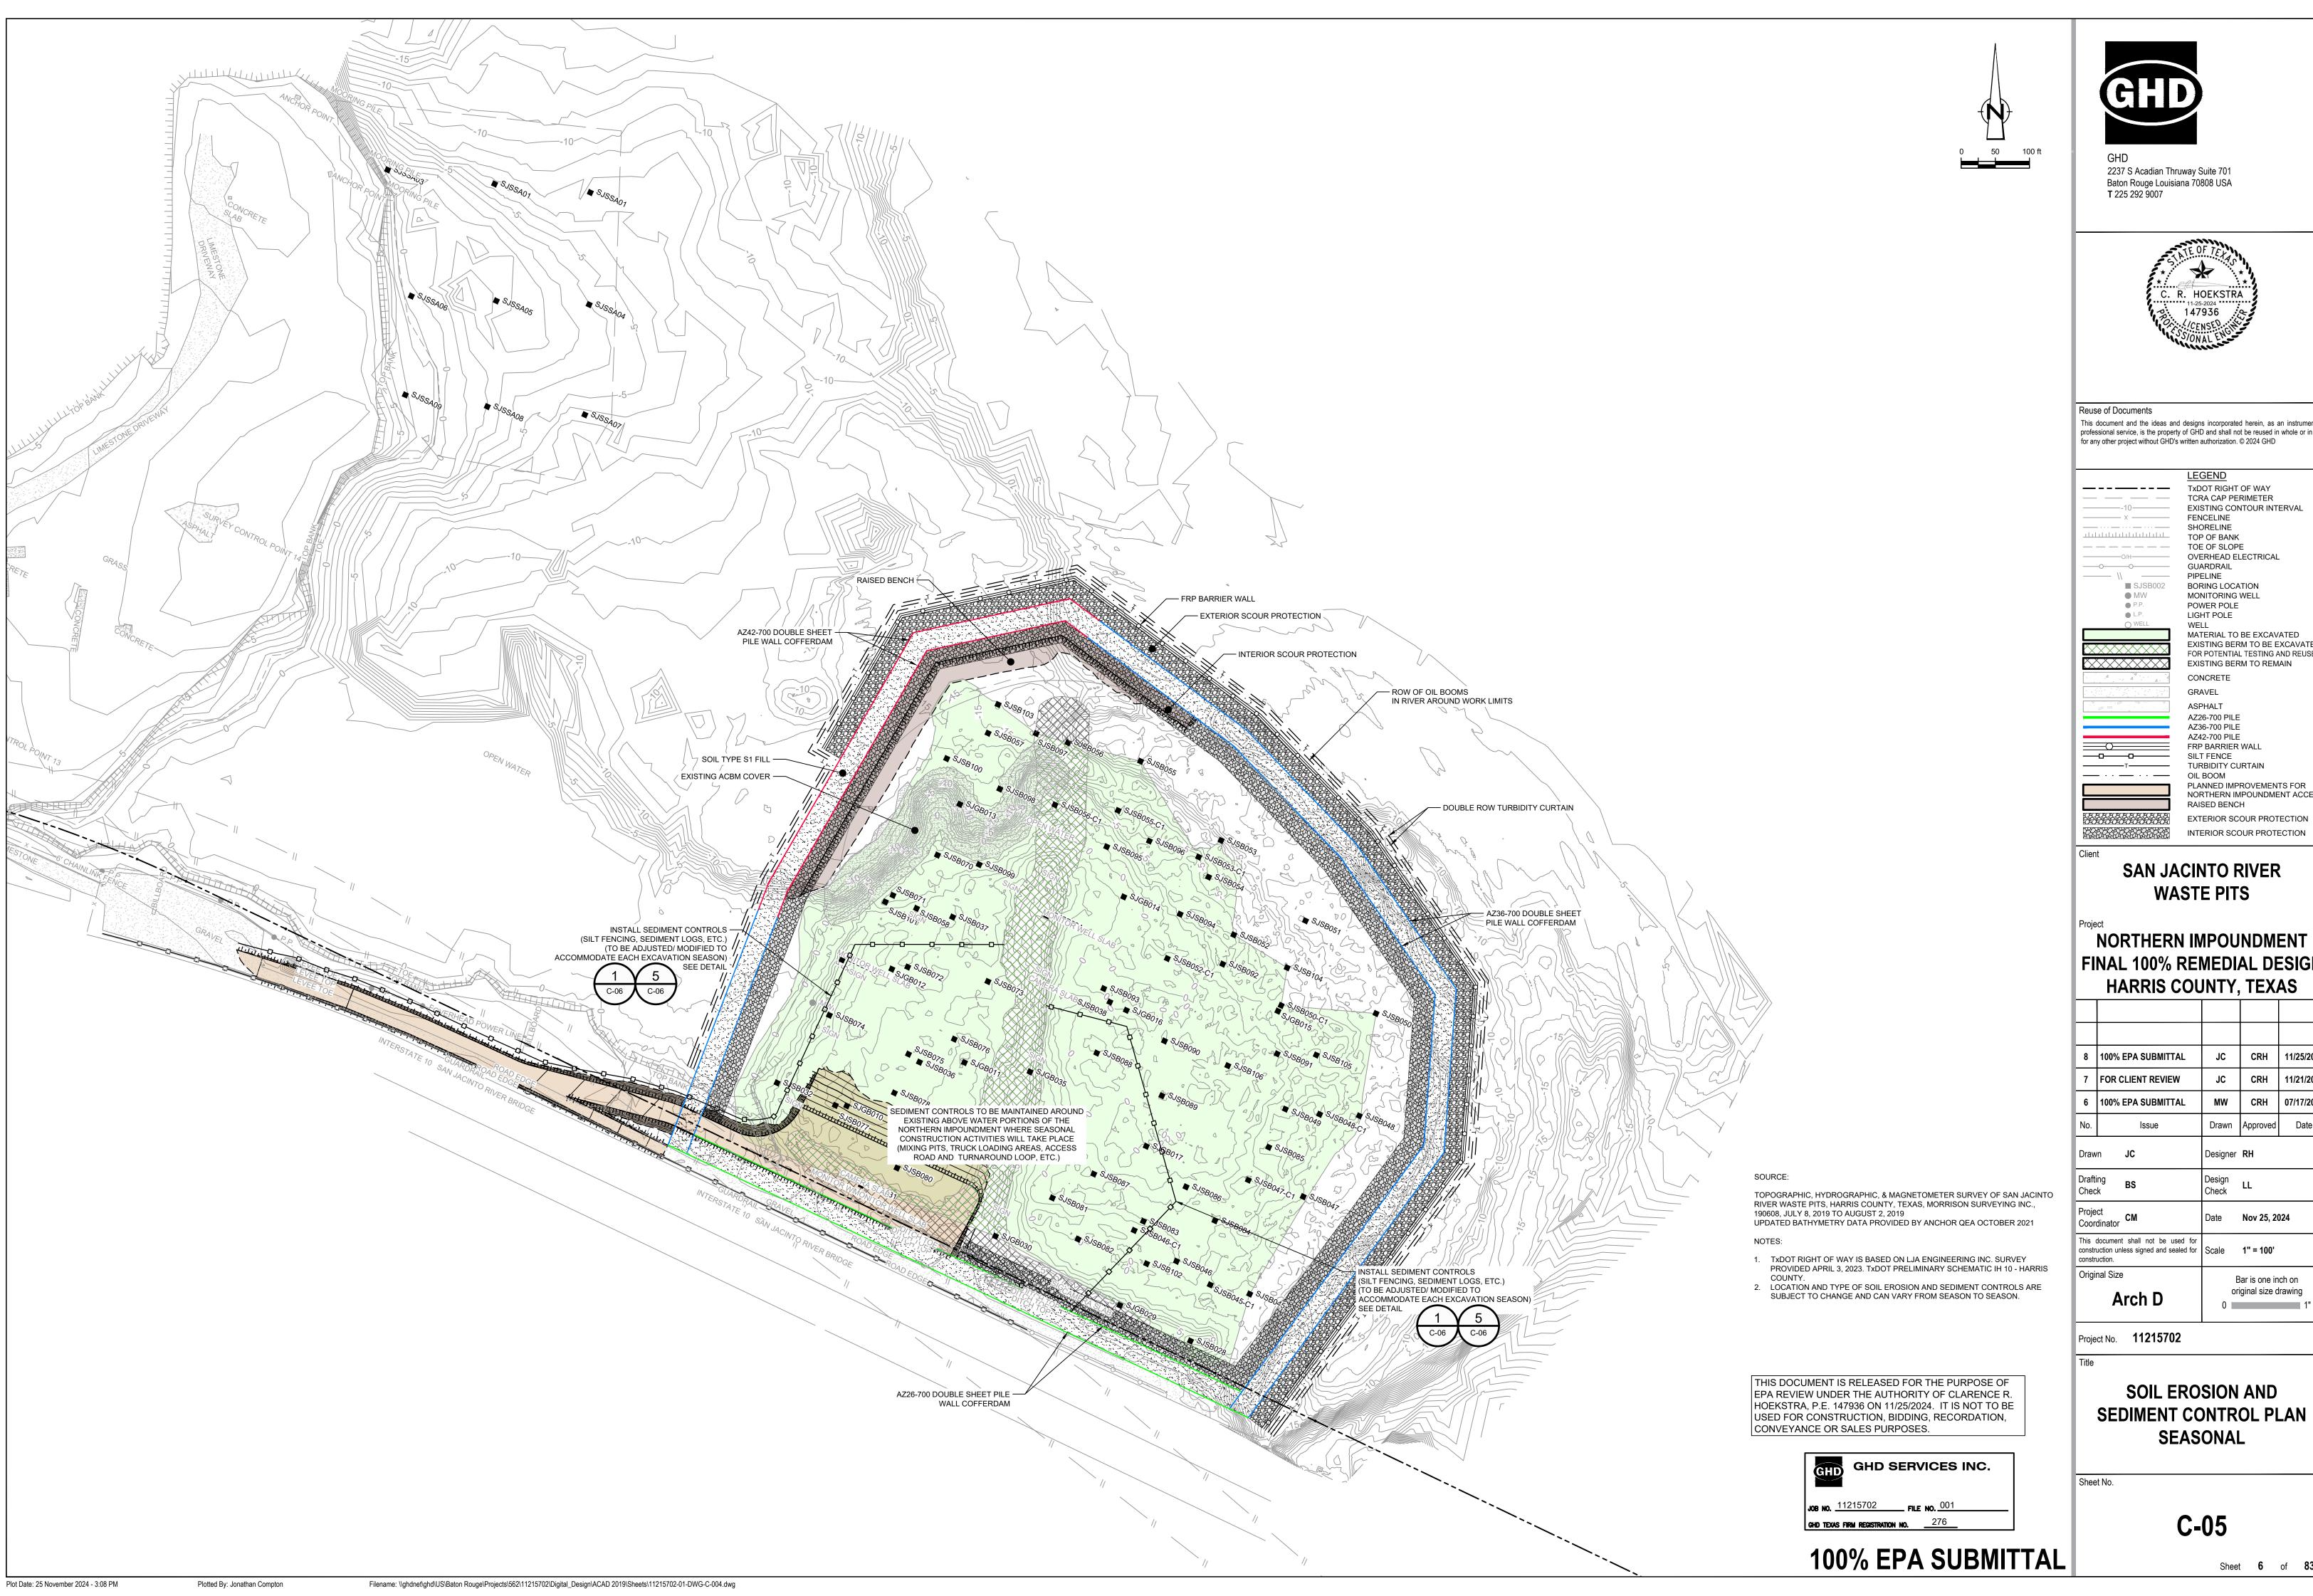



This document and the ideas and designs incorporated herein, as an instrument of professional service, is the property of GHD and shall not be reused in whole or in part

	<u>LEGEND</u>
	TXDOT RIGHT OF WAY
	TCRA CAP PERIMETER
-10	EXISTING CONTOUR INTERVAL
X	FENCELINE
	SHORELINE
	TOP OF BANK
	TOE OF SLOPE
O/H	OVERHEAD ELECTRICAL
0	GUARDRAIL
\\	PIPELINE
SJSB002	BORING LOCATION
MW	MONITORING WELL
P.P.	POWER POLE
♠ L.P.	LIGHT POLE
○ WELL	\\/_I I

MATERIAL TO BE EXCAVATED EXISTING BERM TO BE EXCAVATED FOR POTENTIAL TESTING AND REUSE EXISTING BERM TO REMAIN CONCRETE

GRAVEL ASPHALT AZ26-700 PILE AZ36-700 PILE AZ42-700 PILE FRP BARRIER WALL

SILT FENCE TURBIDITY CURTAIN OIL BOOM PLANNED IMPROVEMENTS FOR NORTHERN IMPOUNDMENT ACCESS RAISED BENCH

**SAN JACINTO RIVER** 

## **WASTE PITS**


## NORTHERN IMPOUNDMENT FINAL 100% REMEDIAL DESIGN HARRIS COUNTY, TEXAS


ı					
ı	8	100% EPA SUBMITTAL	JC	CRH	11/25/20
ı	7	FOR CLIENT REVIEW	JC	CRH	11/21/20
ı	6	100% EPA SUBMITTAL	MW	CRH	07/17/20
ı	No.	Issue	Drawn	Approved	Date
ı	Drawn JC  Drafting BS Check  Project CM Coordinator  This document shall not be used for construction unless signed and sealed for construction.		Designer	RH	
ı			Design Check	LL	
ı			Date	Nov 25, 20	024
			Scale	1" = 100'	
	Original Size		_	ar is one in ginal size d	• • • • • • • • • • • • • • • • • • • •

**SOIL EROSION AND** SEDIMENT CONTROL PLAN **SEASONAL** 

C-05

Sheet **6** of **83** 

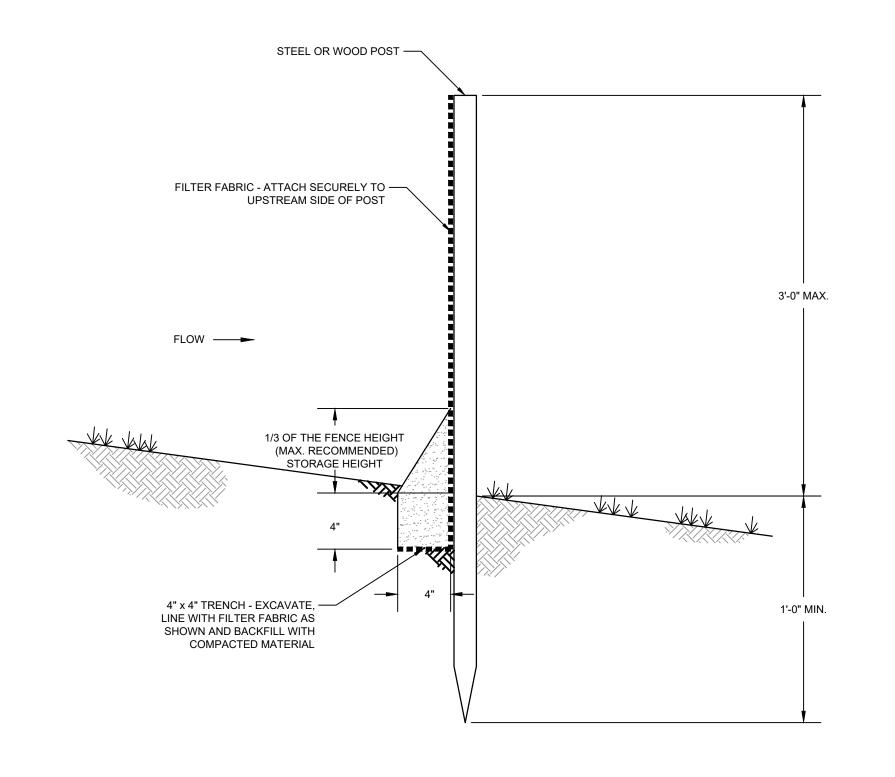

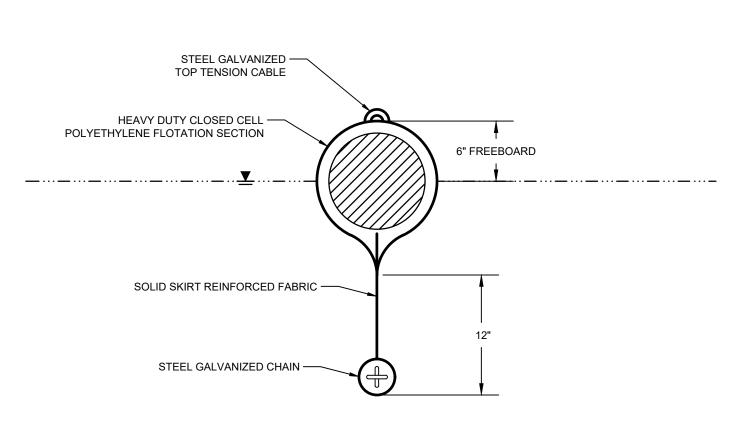

1. OIL BOOM SHALL CONFORM TO COAST GUARD OPA 90 REGULATION AND ASTM F-1523

NON-ABSORBENT OIL BOOM

<u>NOTES</u>

2. OIL BOOM SHALL BE CONTINUOUS TYPE.

FLOTATION CORE TYPE III PERMEABLE HEAVY DUTY -TURBIDITY CURTAIN OR EQUIVALENT AS REQUIRED CHAIN BALLAST — HALF WATER DEPTH

BUOYANCY TO PROVIDE

12" MIN. FREEBOARD

TOP LOAD LINE —


VINYL COATED CABLE

1. TURBIDITY CURTAIN SHALL BE TYPE III ACCORDING TO DEPARTMENT OF THE ARMY, US ARMY CORPS OF ENGINEERS WASHINGTON, DC, ENGINEERING AND DESIGN "HANDBOOK FOR THE PREPARATION OF STORM WATER POLLUTION PREVENTION PLANS FOR CONSTRUCTION ACTIVITIES", APPENDIX 'C' BMP 27 TURBIDITY CURTAIN, DOCUMENT EP1110-1-16, 1997. 2. CURTAIN SYSTEM SHALL BE EQUIPPED WITH LOAD TRANSFER TYPE PANEL CONNECTORS 3. INCLUDE MOORING SYSTEM IF REQUIRED.

**TURBIDITY CURTAINS** 


TEMPORARY SILT FENCE

10' C/C (TYP.) — 2" SQ WOODEN STAKES — 1' DIA. SEDIMENT LOG 2" SQ WOODEN STAKES PLACED 10' ON CENTER

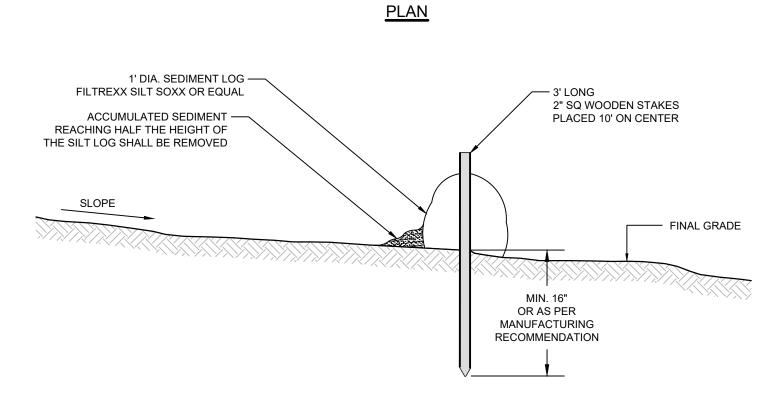

<u>SECTION</u> 5 SEDIMENT LOG

THIS DOCUMENT IS RELEASED FOR THE PURPOSE OF EPA REVIEW UNDER THE AUTHORITY OF CLARENCE R. HOEKSTRA, P.E. 147936 ON 11/25/2024. IT IS NOT TO BE USED FOR CONSTRUCTION, BIDDING, RECORDATION, CONVEYANCE OR SALES PURPOSES.

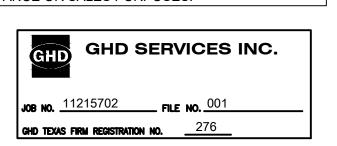

**100% EPA SUBMITTAL** 



2237 S Acadian Thruway Suite 701 Baton Rouge Louisiana 70808 USA **T** 225 292 9007



Reuse of Documents This document and the ideas and designs incorporated herein, as an instrument of professional service, is the property of GHD and shall not be reused in whole or in part for any other project without GHD's written authorization. © 2024 GHD

**SAN JACINTO RIVER WASTE PITS** 

NORTHERN IMPOUNDMENT FINAL 100% REMEDIAL DESIGN HARRIS COUNTY, TEXAS

1					
ı					
ı	7	100% EPA SUBMITTAL	JC	CRH	11/25/20
ı	6	FOR CLIENT REVIEW	JC	CRH	11/21/20
ı	5	100% EPA SUBMITTAL	MW	CRH	07/17/20
ı	No.	Issue	Drawn	Approved	Date
ı	Draw	n <b>JC</b>	Designer	RH	
ı	Drafti Chec	° В5	Design Check	LL	
	Proje Coor	ct dinator <b>CM</b>	Date	Nov 25, 20	024
l	This document shall not be used for construction unless signed and sealed for construction.		Scale	N.T.S.	
ı	Origi	nal Size	В	ar is one in	ch on

original size drawing Arch D

Project No. **11215702** 


**SOIL EROSION AND** SEDIMENT CONTROL DETAILS

Sheet No.

C-06

Sheet **7** of **83** 

Bar is one inch on

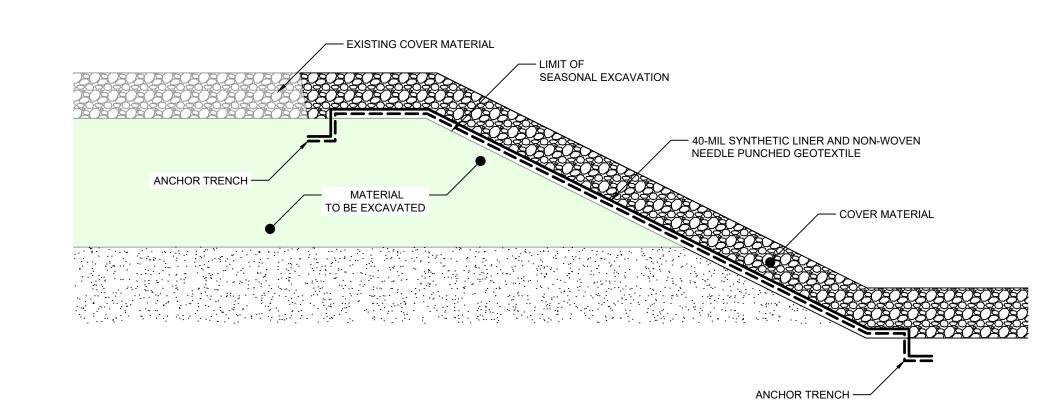



TEMPORARY SEASONAL COVER


Plot Date: 25 November 2024 - 3:08 PM


Plotted By: Jonathan Compton


Filename: \\ghdnet\ghd\US\Baton Rouge\Projects\562\11215702\Digital\_Design\ACAD 2019\Sheets\11215702-01-DWG-C-006.dwg

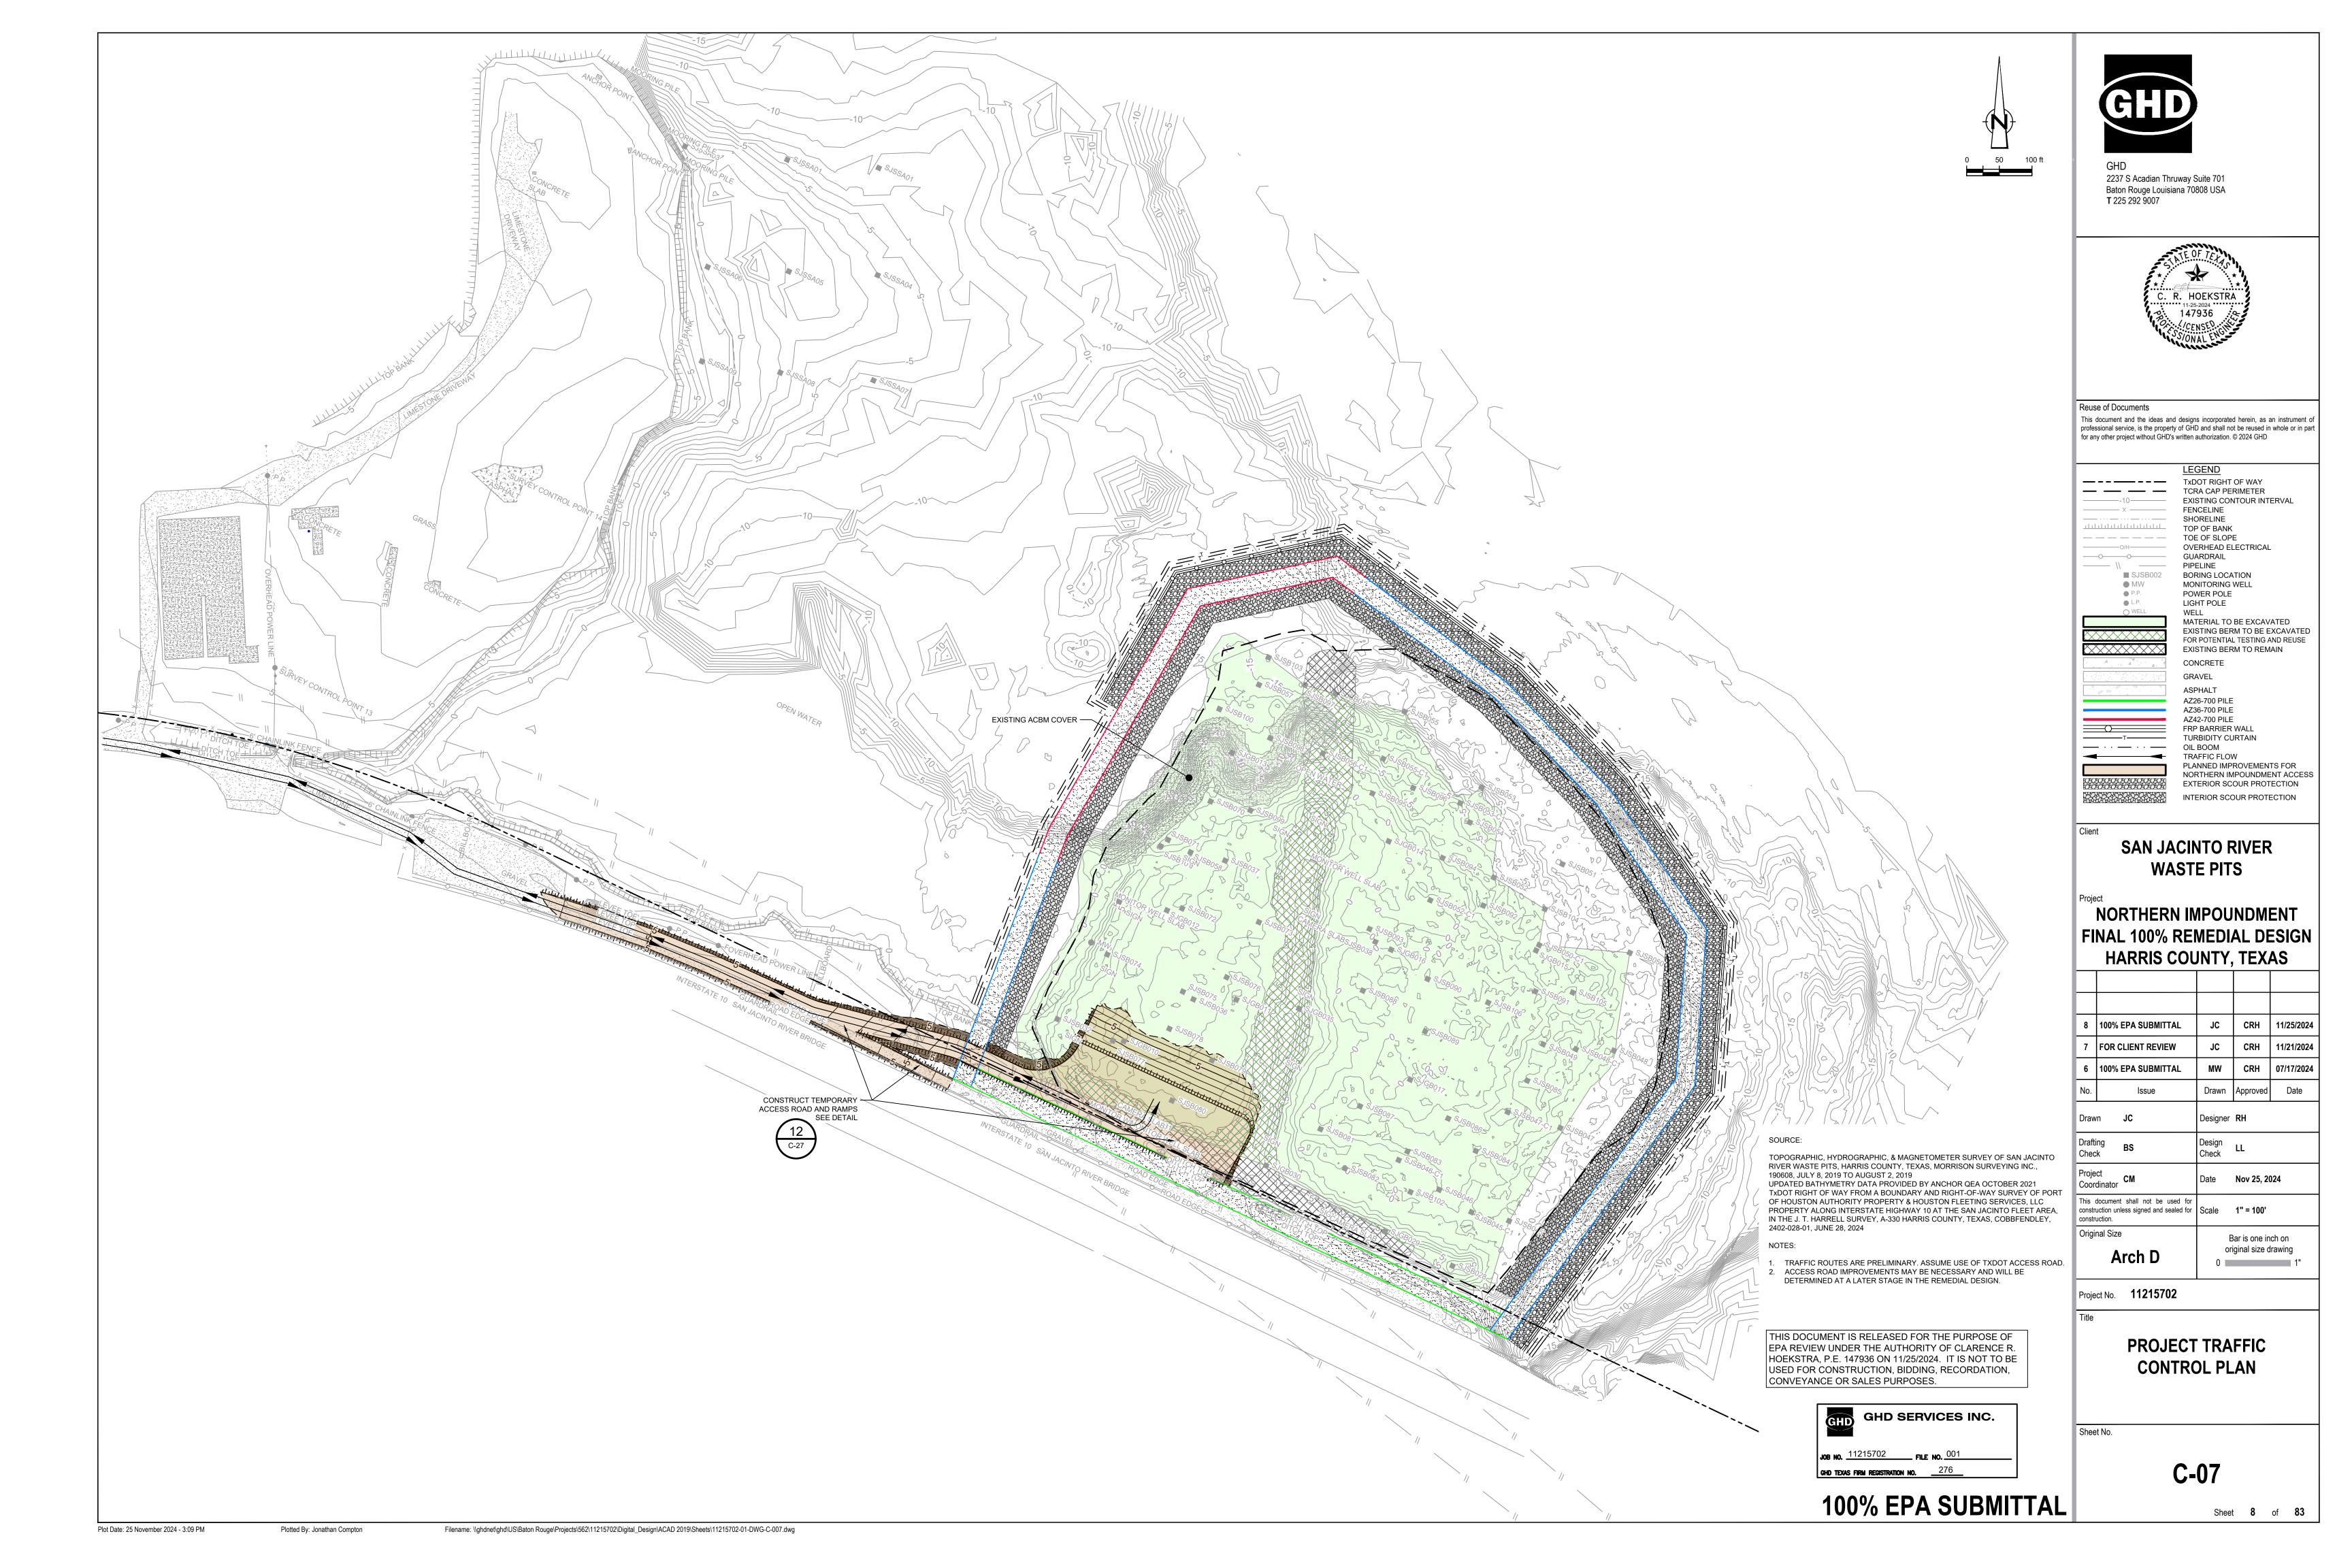


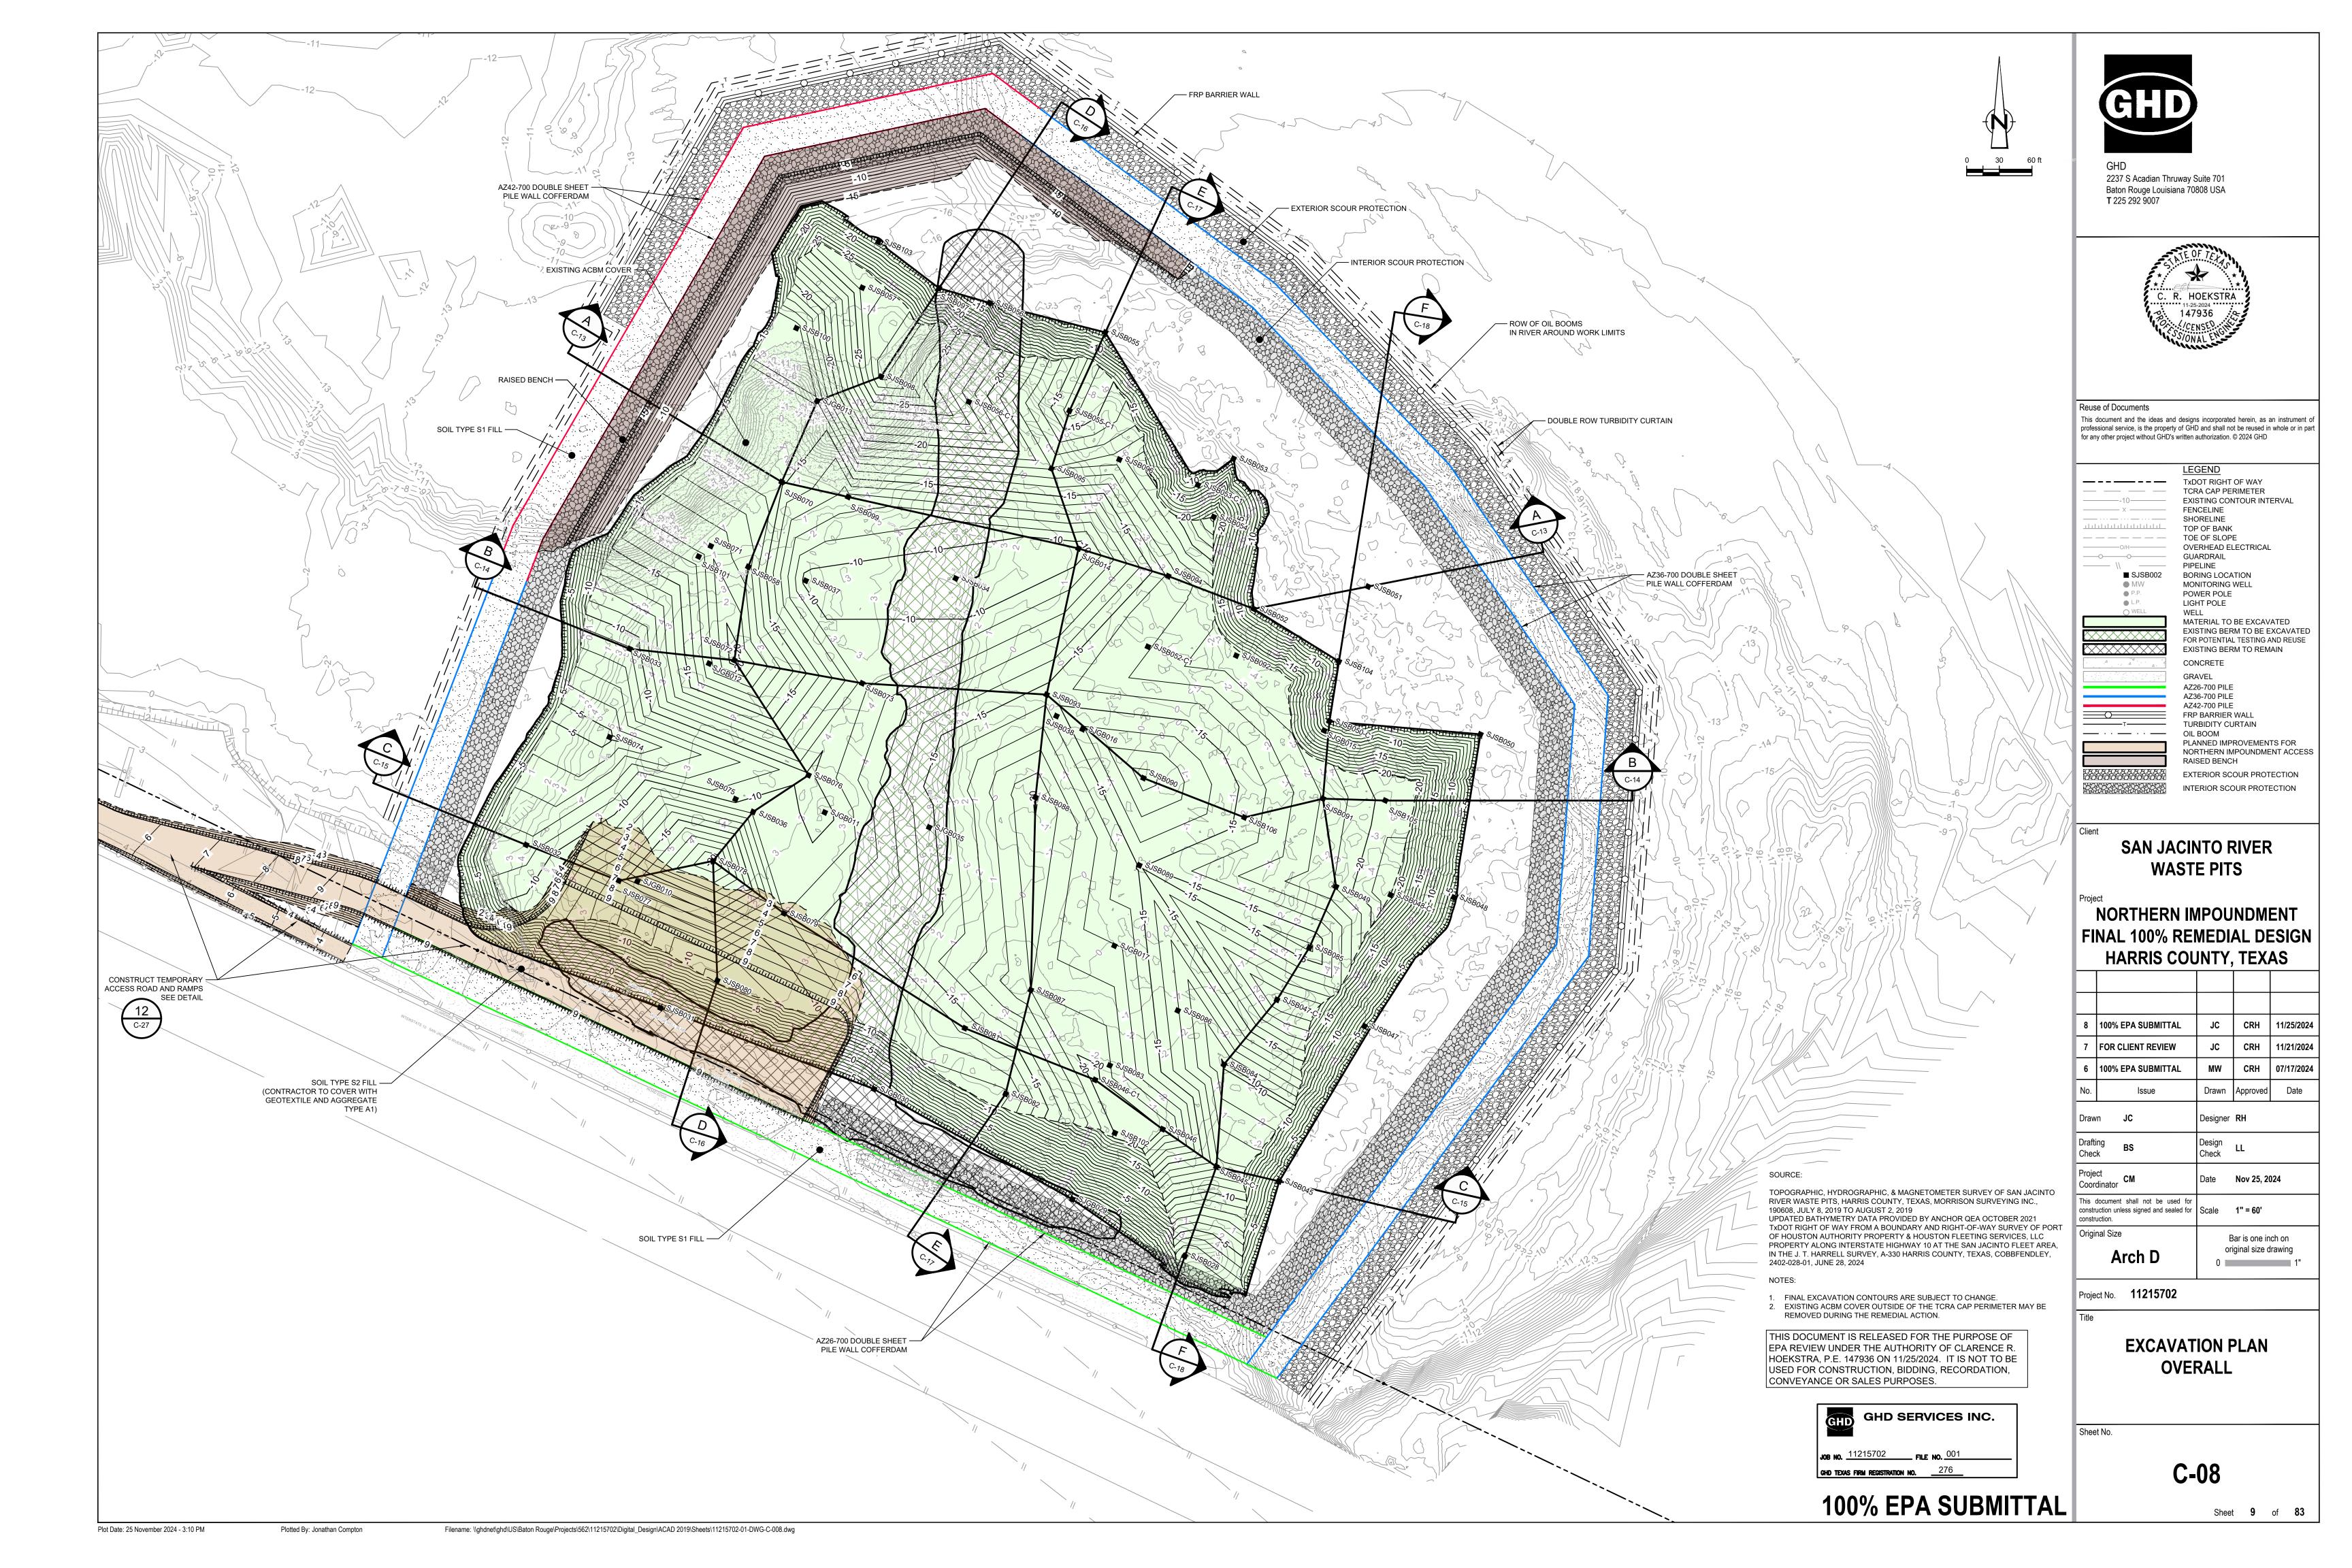


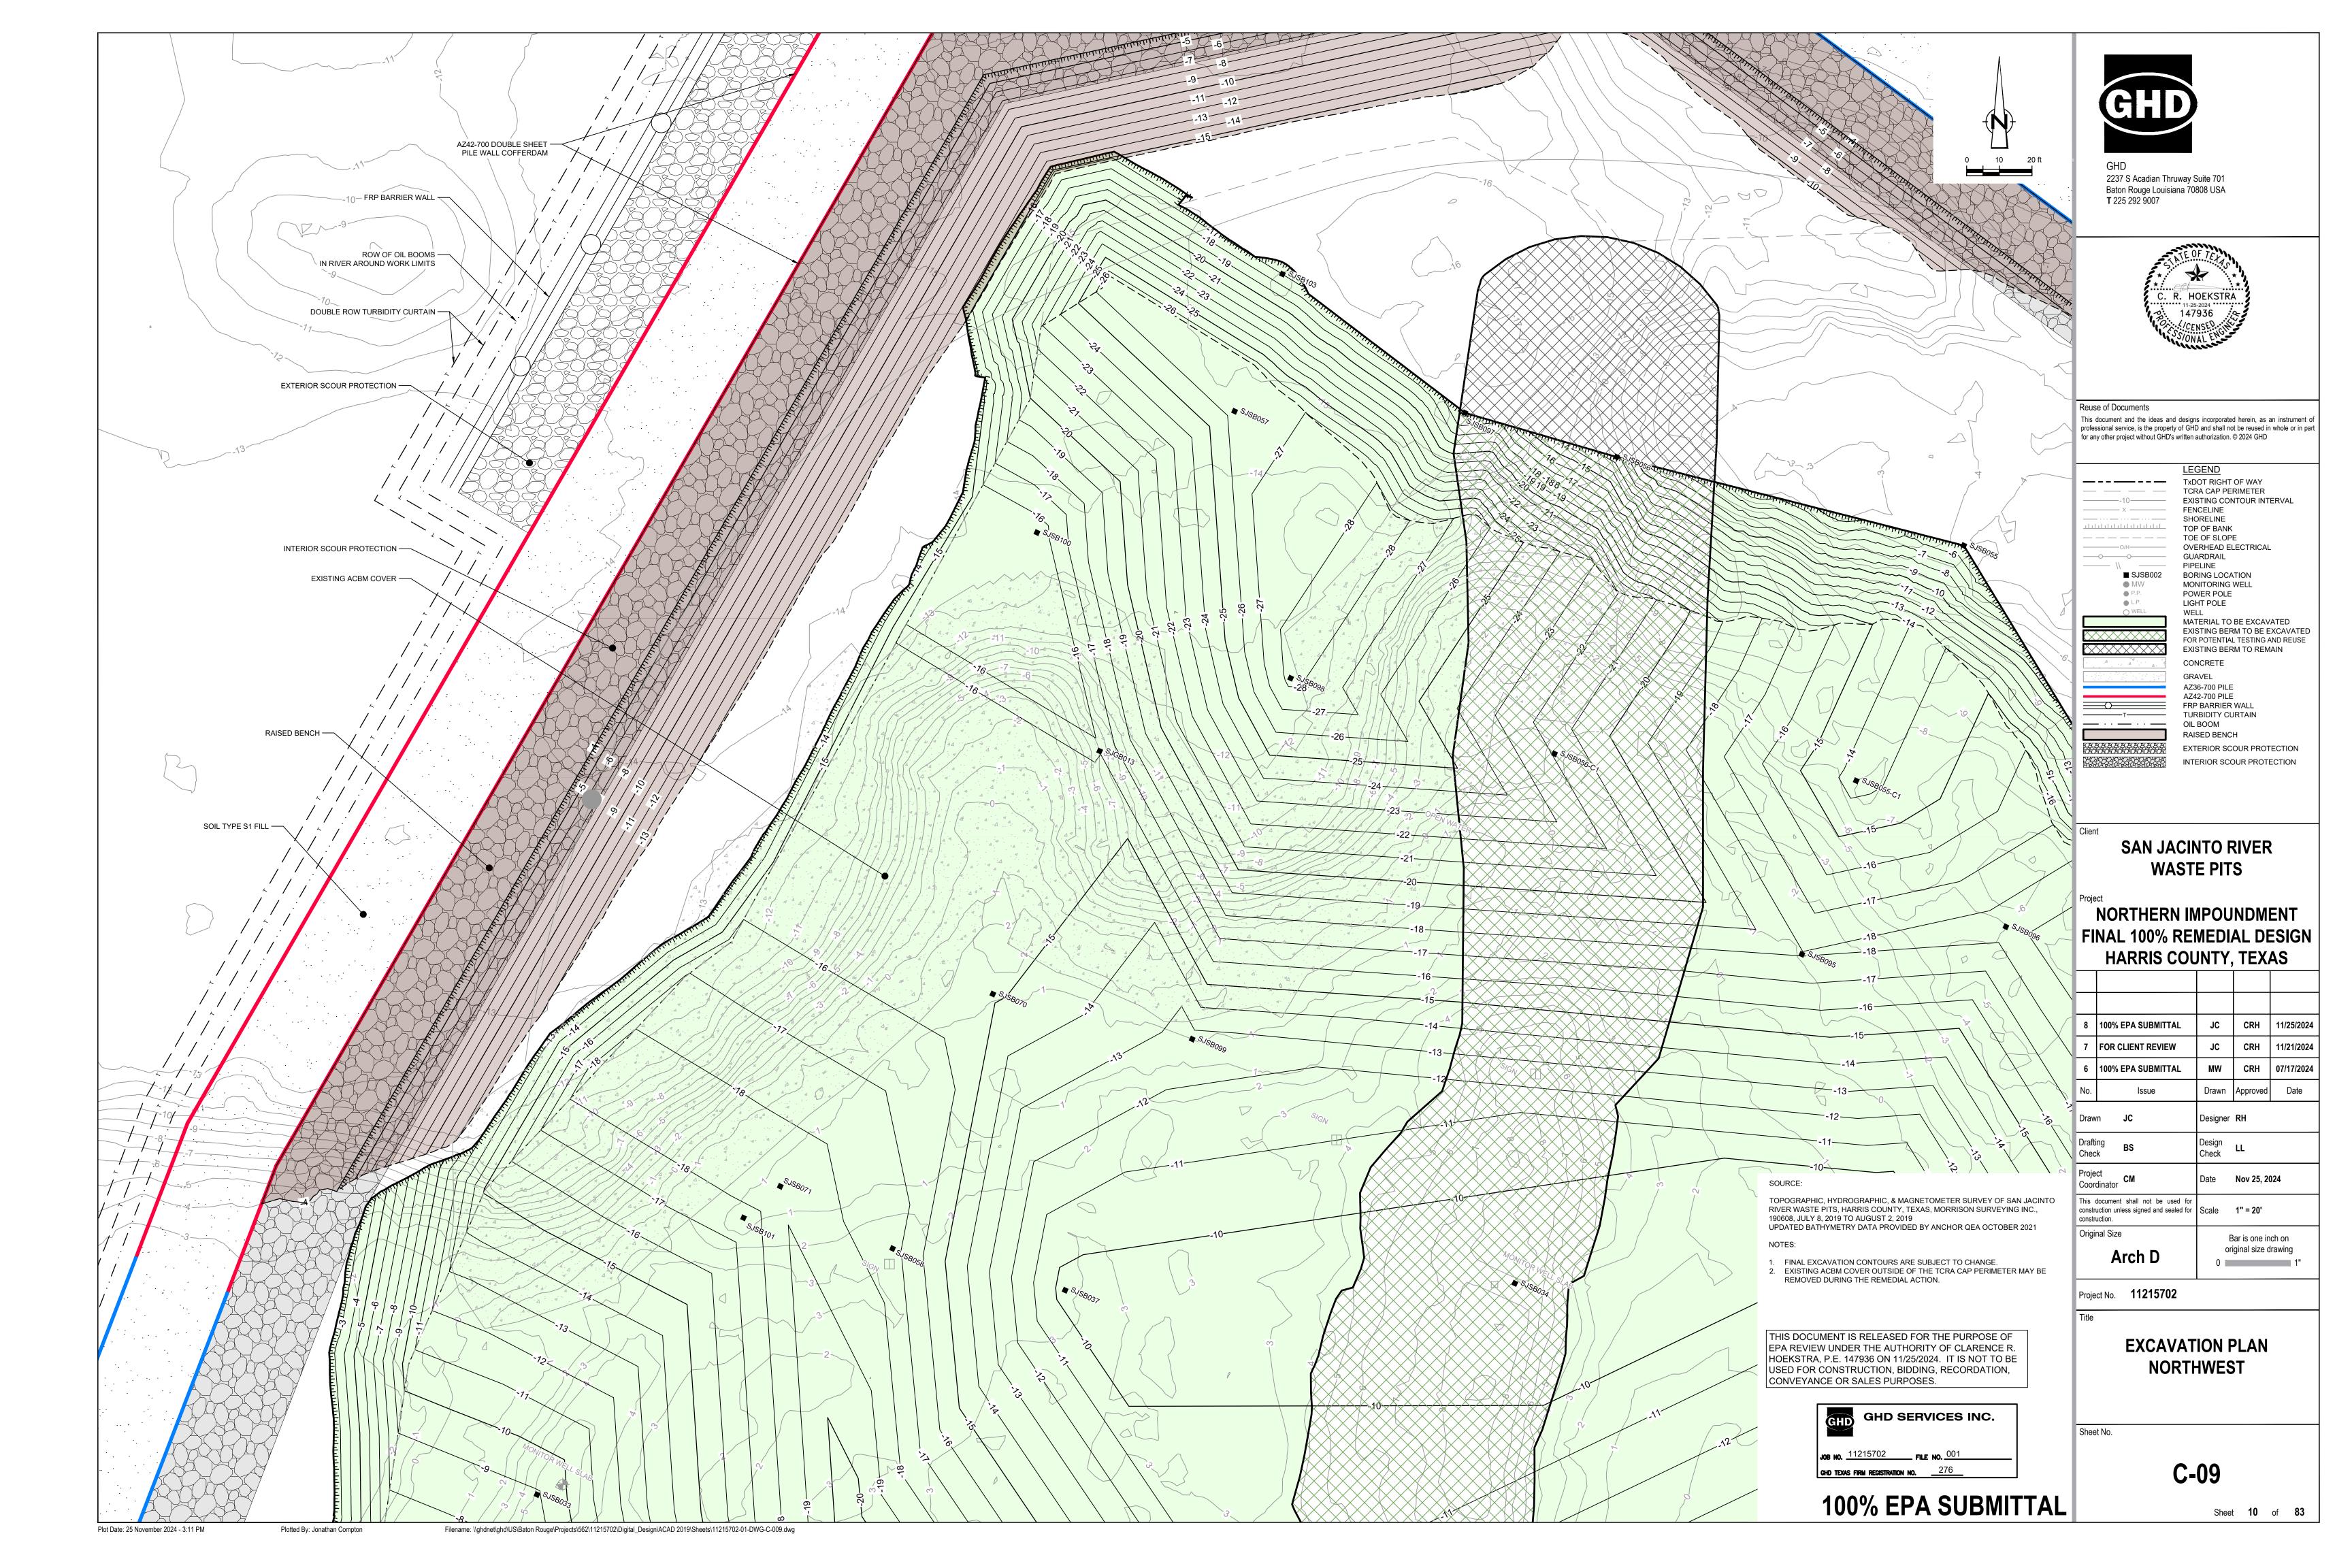


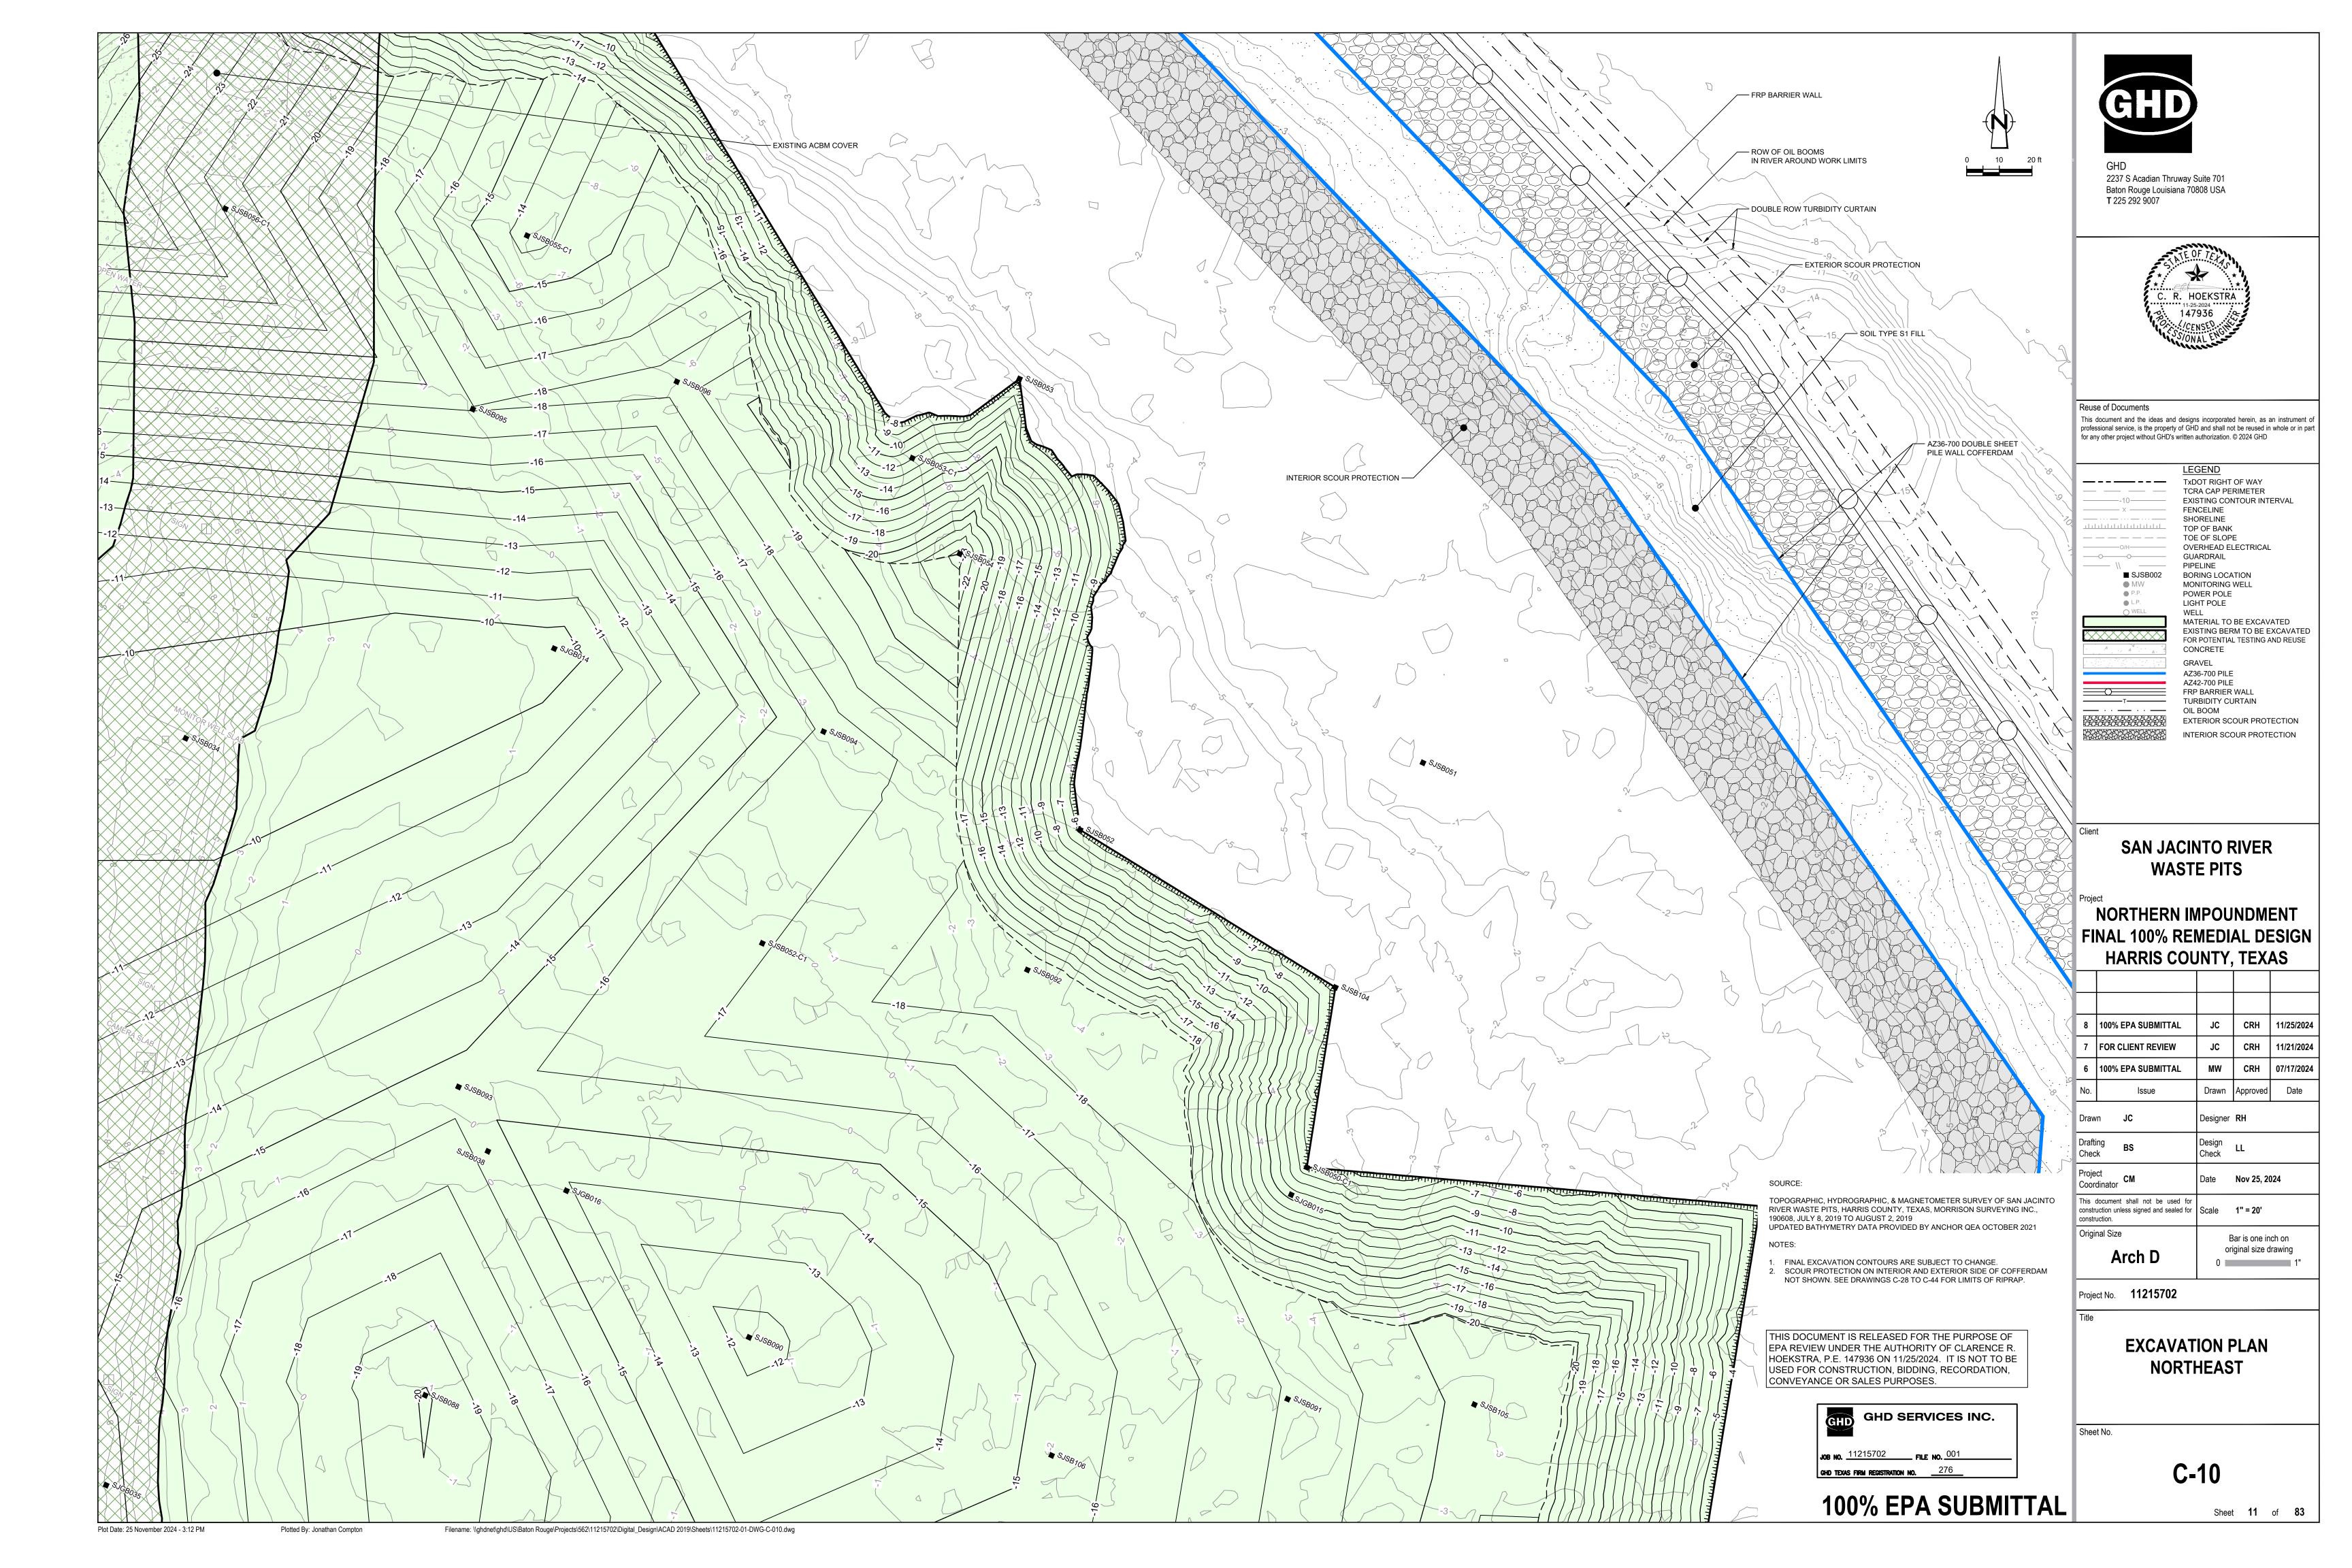

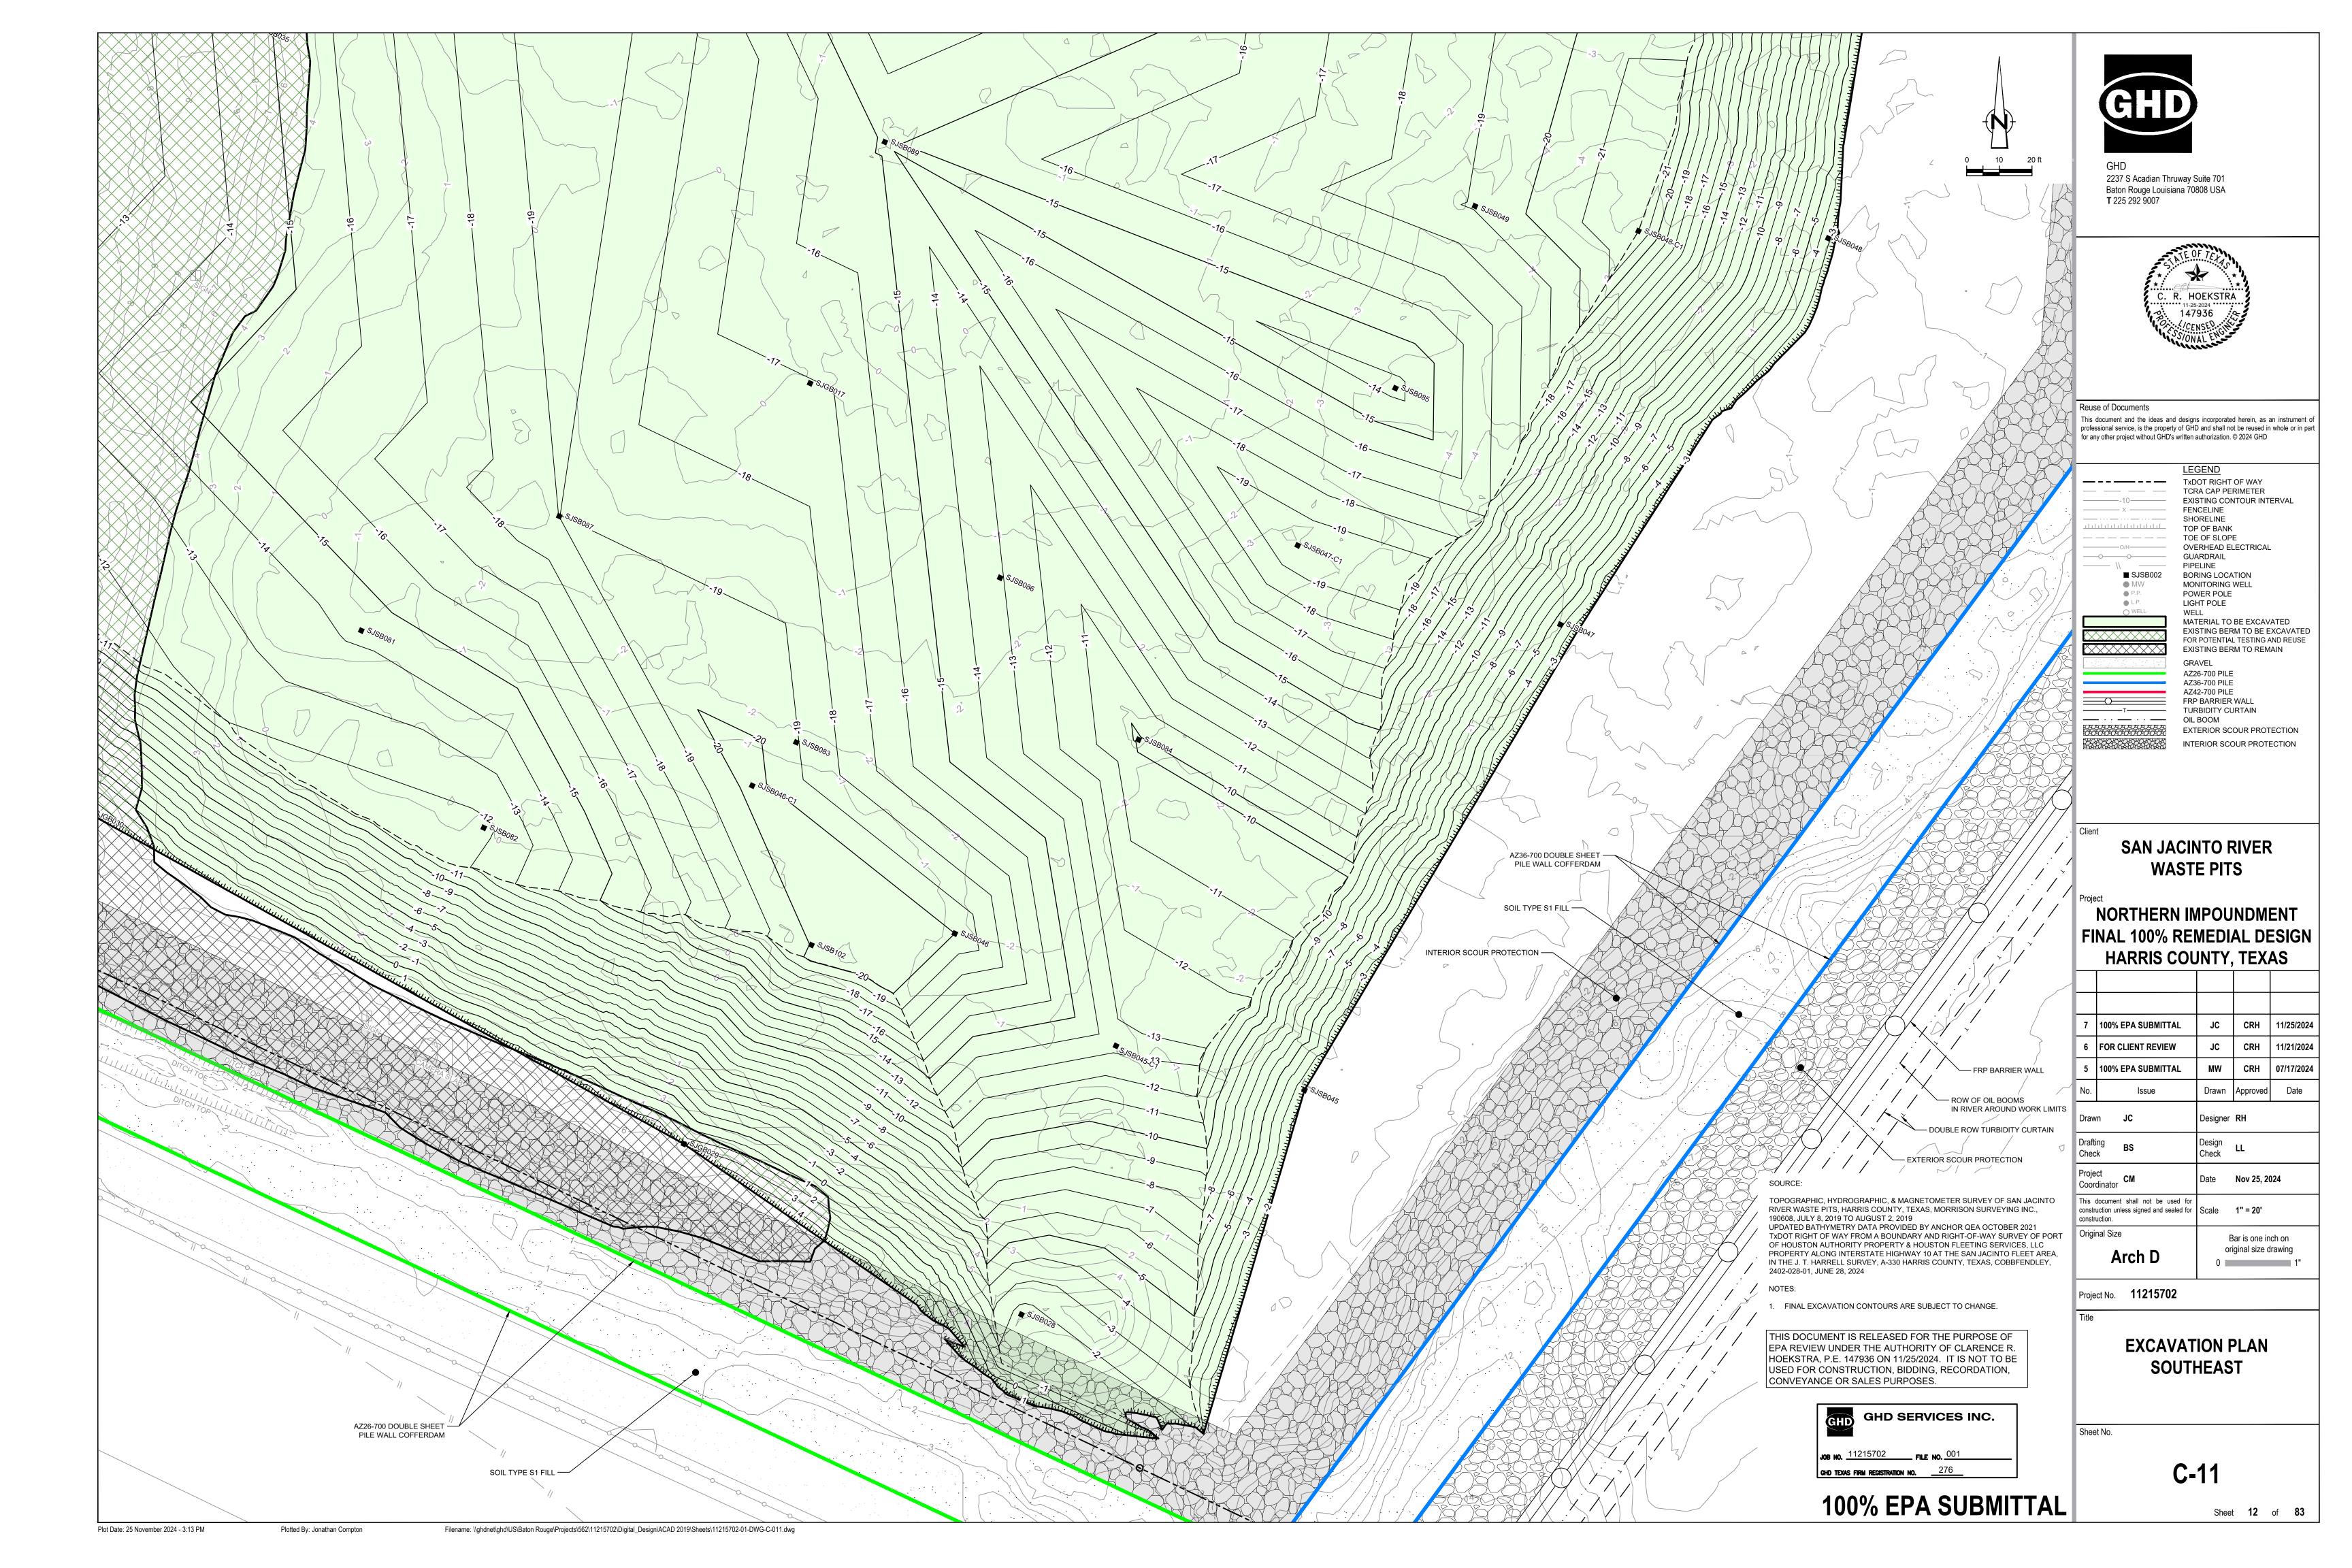

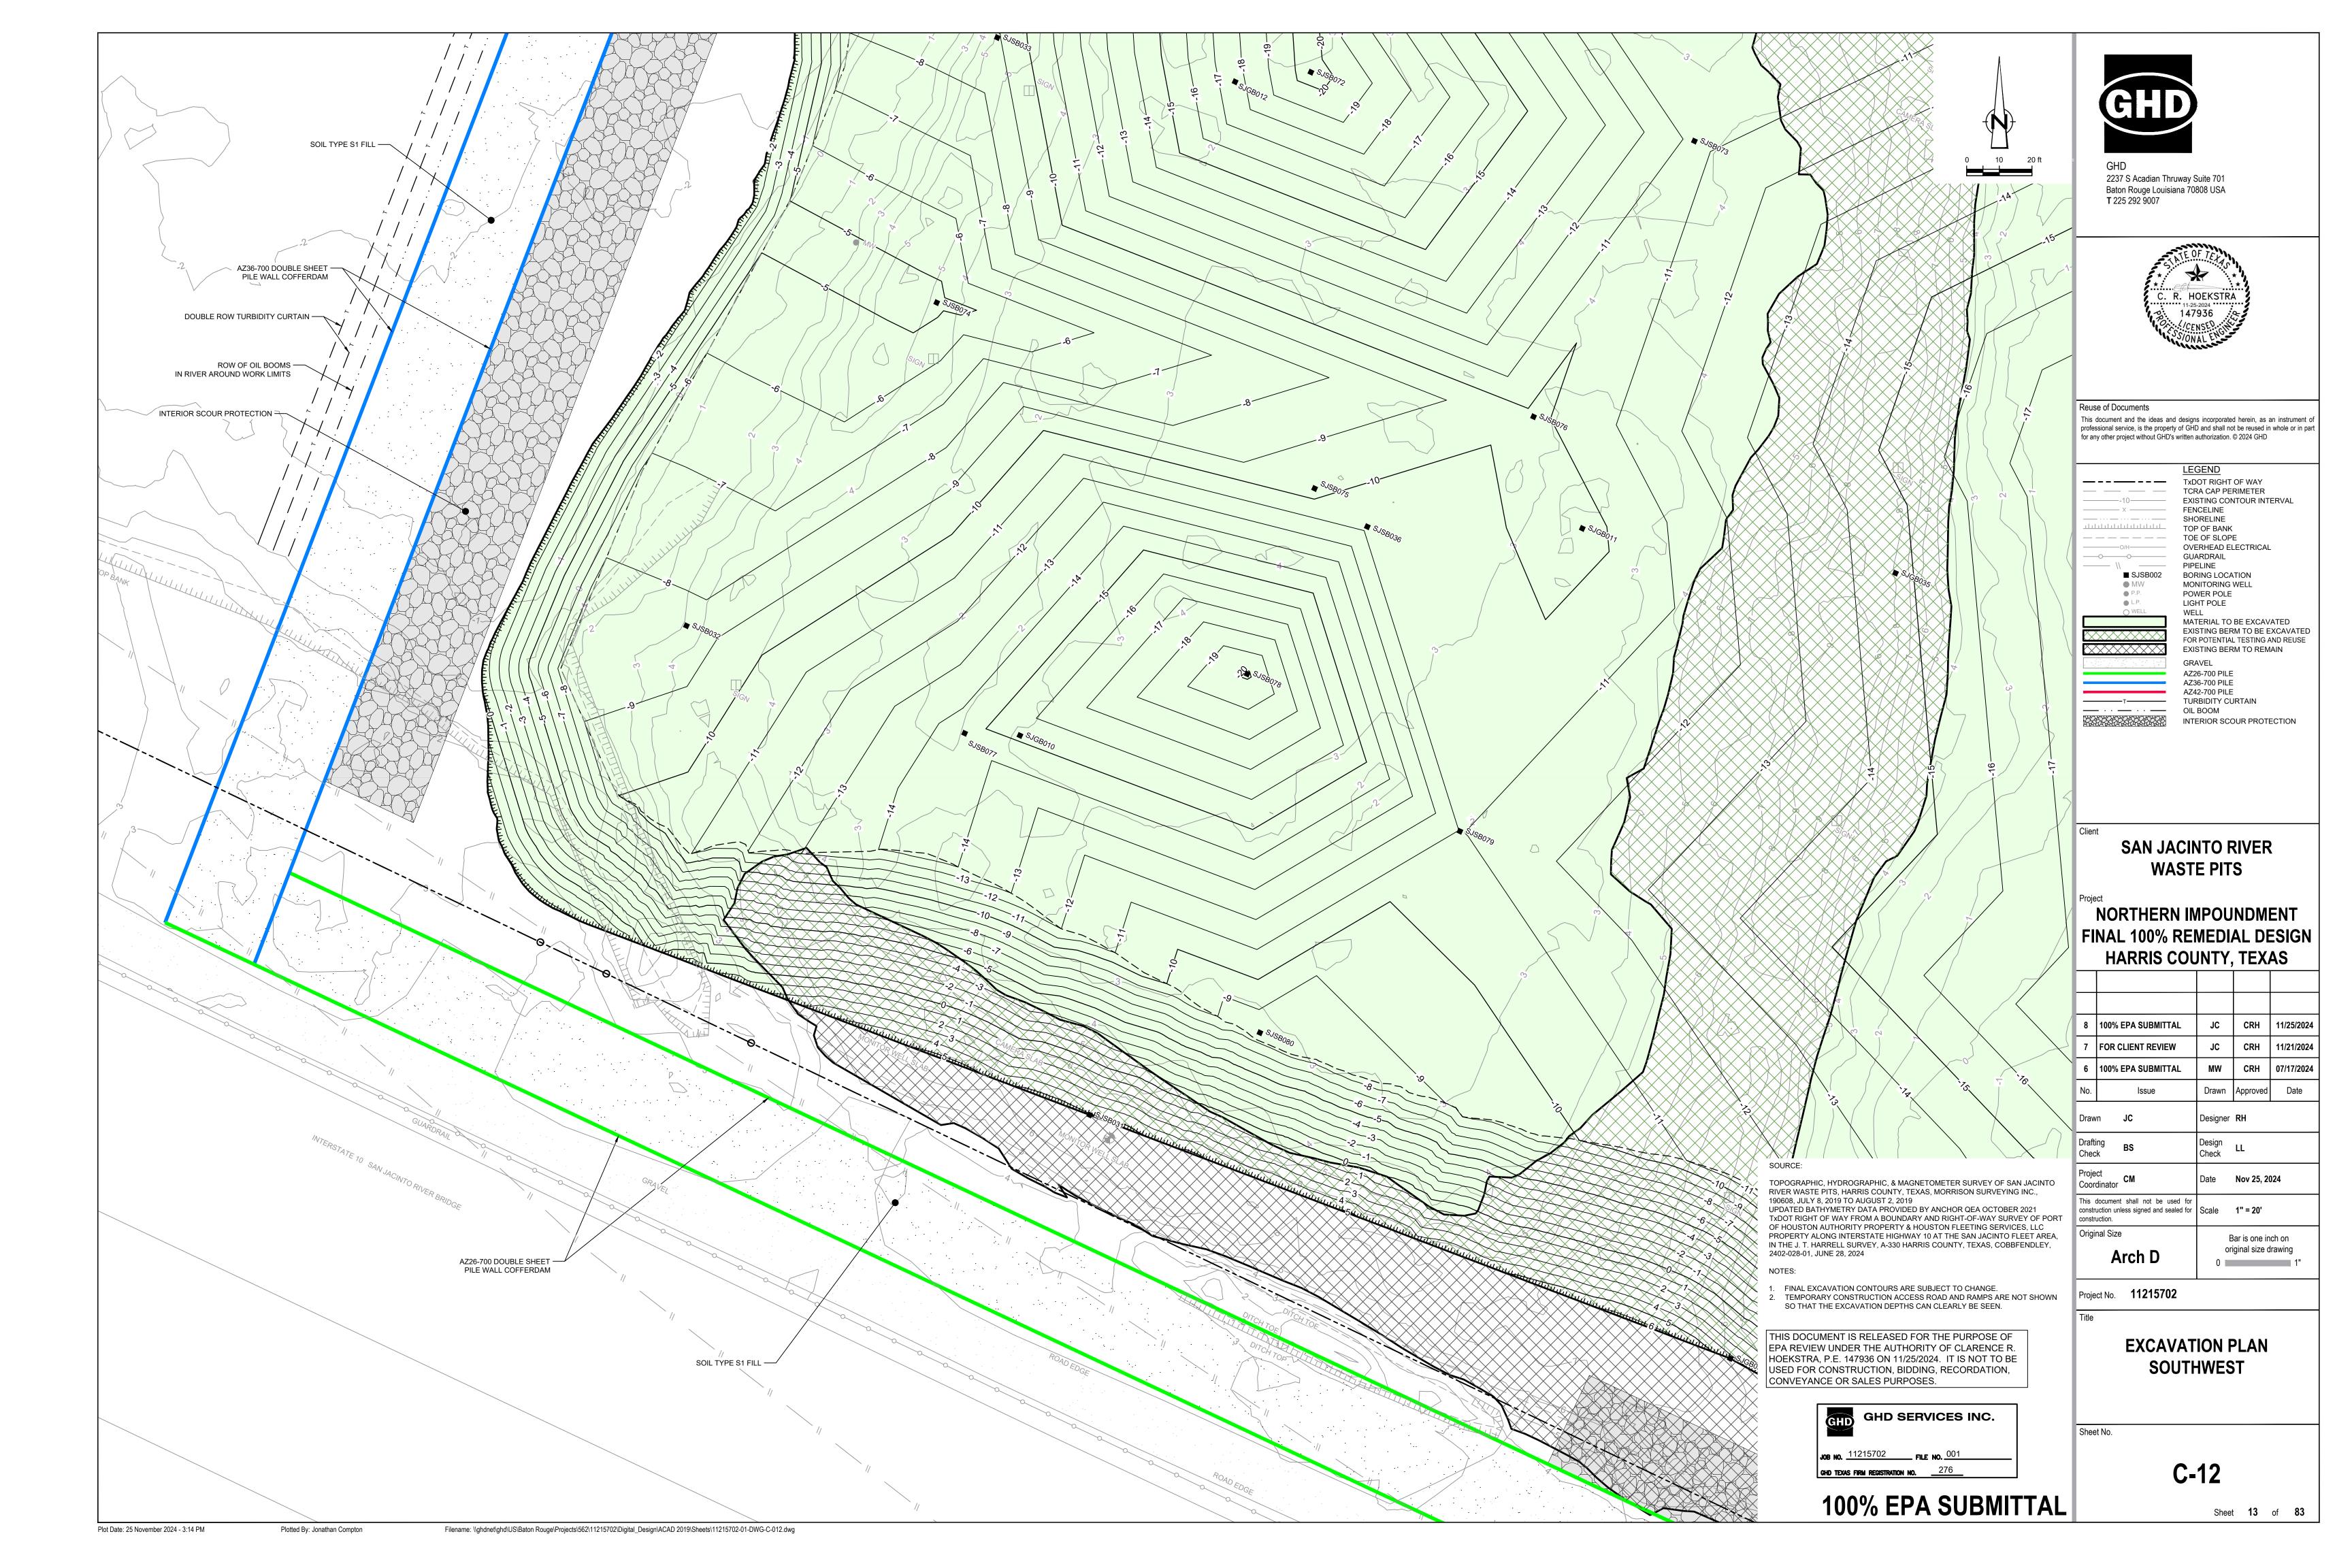


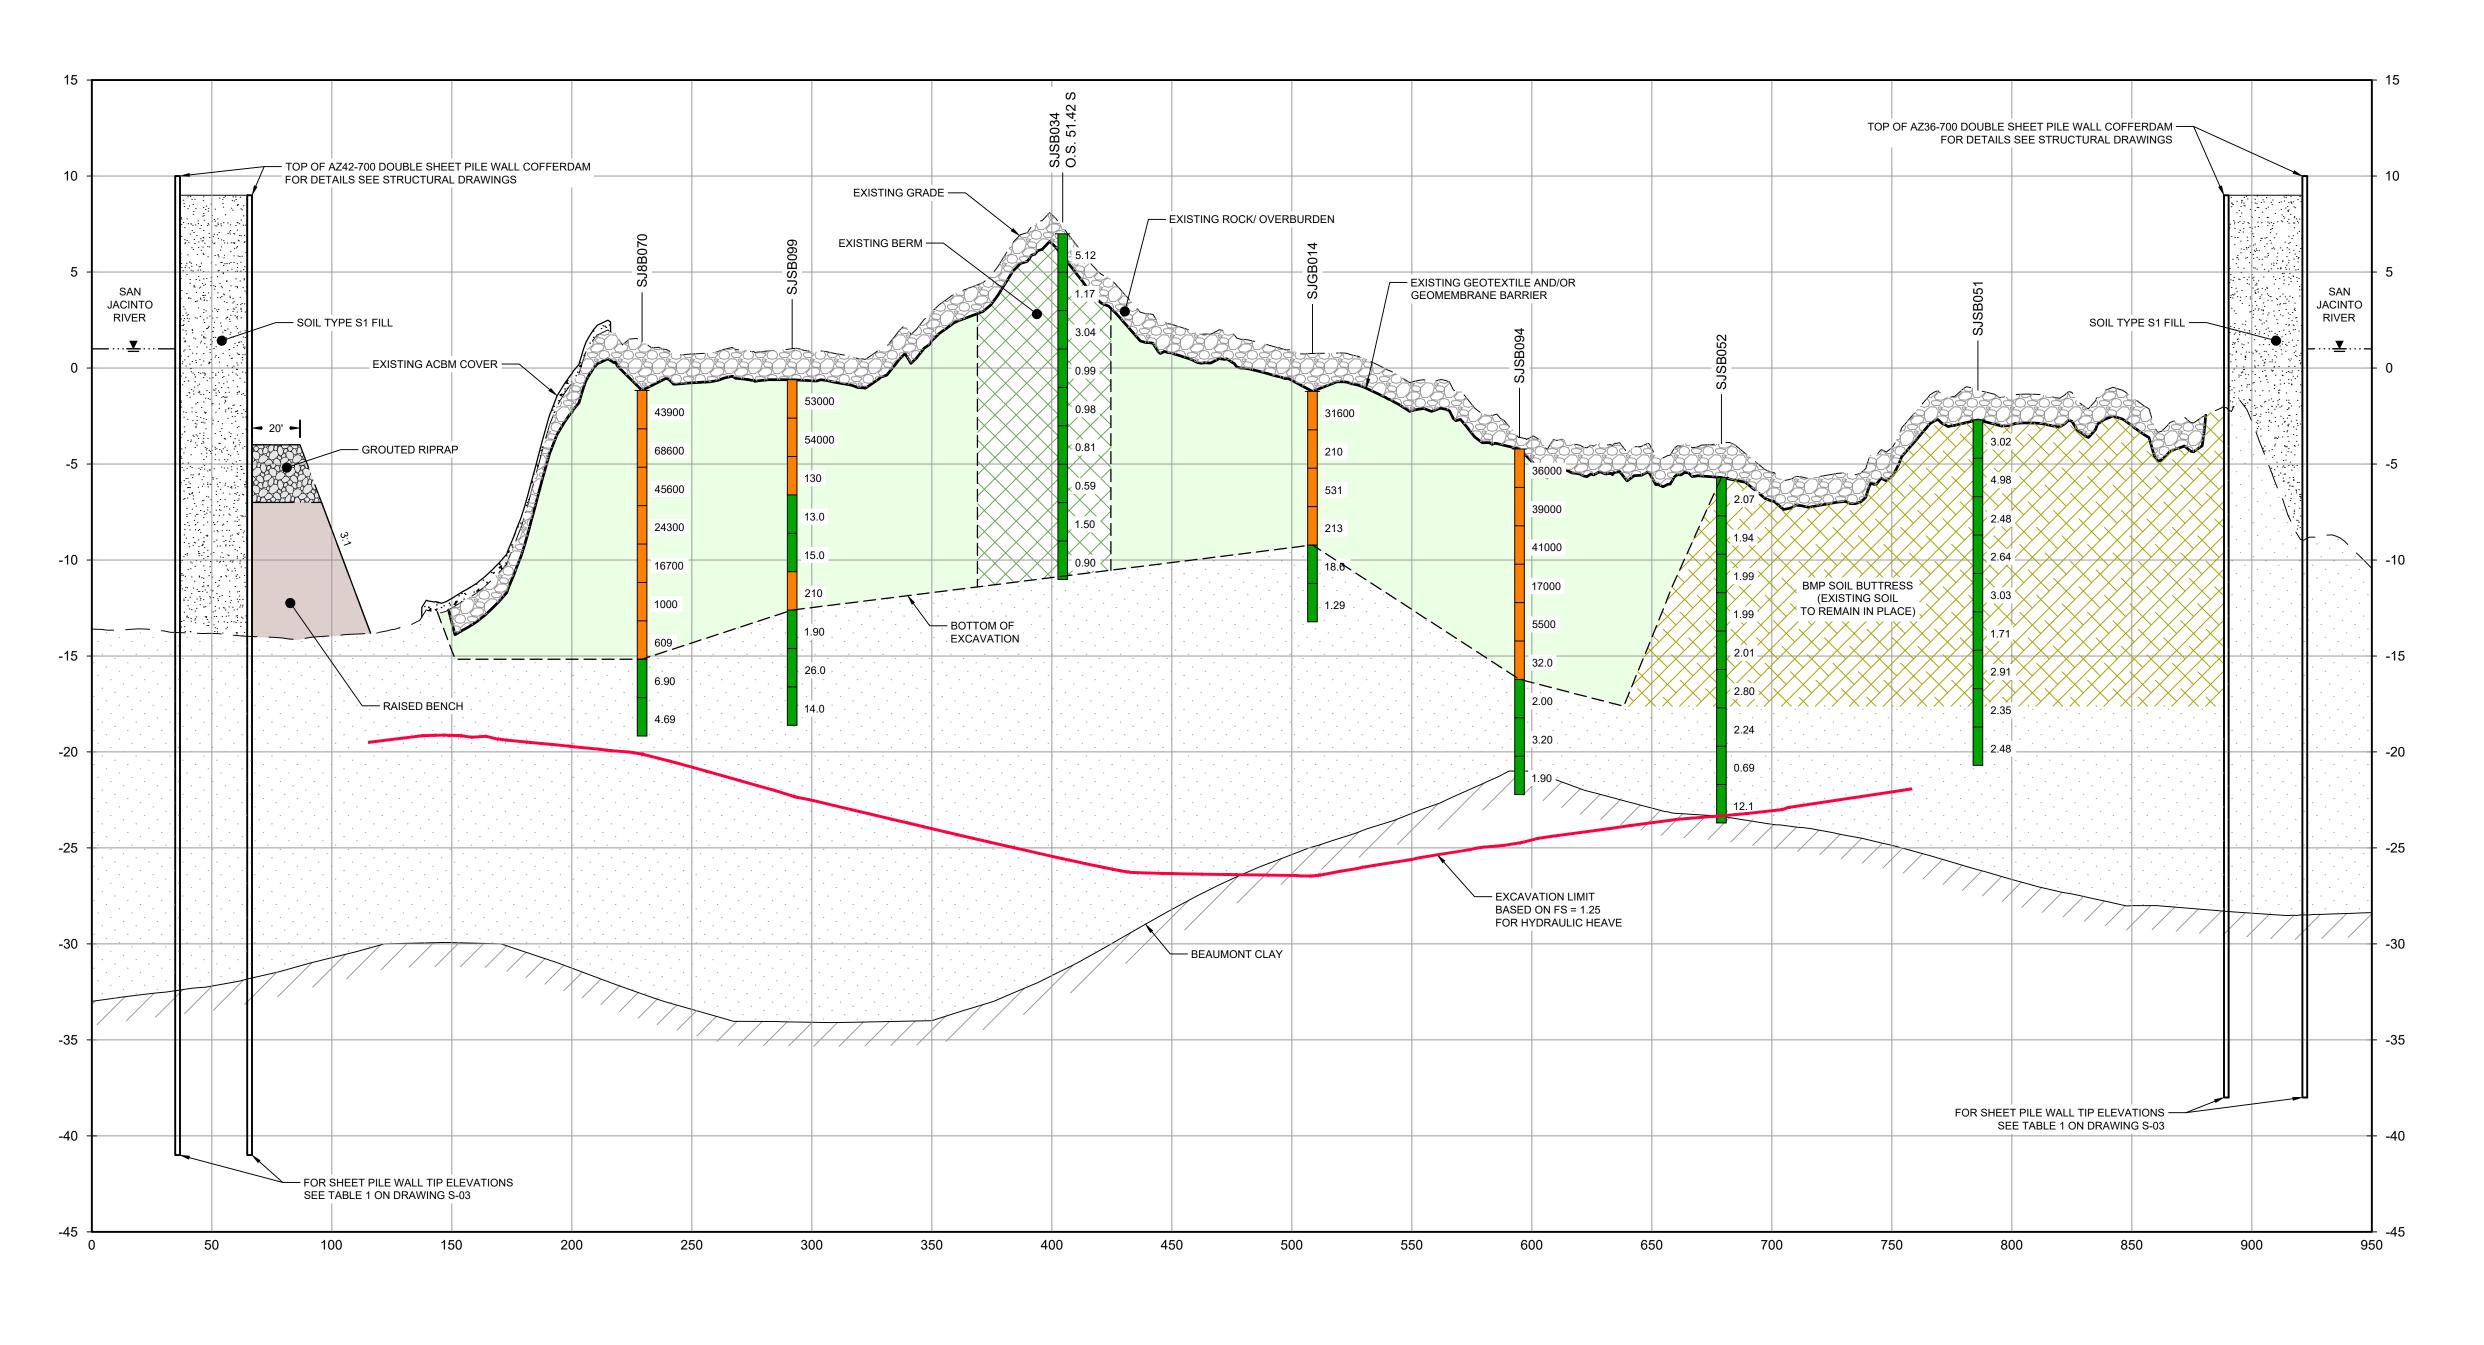

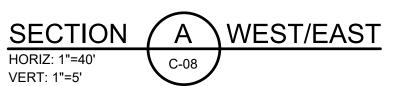

BOTTOM OF EXCAVATION IS SUBJECT TO CHANGE.
 SCOUR PROTECTION ON INTERIOR AND EXTERIOR SIDE OF COFFERDAM NOT SHOWN. SEE DRAWINGS C-28 TO C-44 FOR LIMITS OF RIPRAP.

THIS DOCUMENT IS RELEASED FOR THE PURPOSE OF EPA REVIEW UNDER THE AUTHORITY OF CLARENCE R. HOEKSTRA, P.E. 147936 ON 11/25/2024. IT IS NOT TO BE USED FOR CONSTRUCTION, BIDDING, RECORDATION, CONVEYANCE OR SALES PURPOSES.

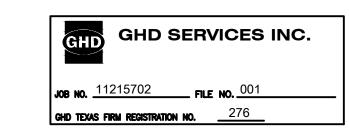

100% EPA SUBMITTAL



2237 S Acadian Thruway Suite 701 Baton Rouge Louisiana 70808 USA **T** 225 292 9007



Reuse of Documents

This document and the ideas and designs incorporated herein, as an instrument of professional service, is the property of GHD and shall not be reused in whole or in part for any other project without GHD's written authorization. © 2024 GHD

> SOILS WITH CONCENTRATIONS <30 ng/kg  $TEQ_{DF,M}$  TCDD SOILS WITH CONCENTRATIONS

>30 ng/kg TEQ<sub>DF,M</sub> TCDD

EXCAVATION LIMIT BASED ON FS = 1.25 FOR HYDRAULIC HEAVE MATERIAL TO BE EXCAVATED

EXISTING BERM TO BE EXCAVATED FOR POTENTIAL TESTING AND REUSE BMP SOIL BUTTRESS (EXISTING SOIL TO REMAIN IN PLACE) INTERIOR SCOUR PROTECTION RAISED BENCH

**SAN JACINTO RIVER WASTE PITS** 

NORTHERN IMPOUNDMENT FINAL 100% REMEDIAL DESIGN HARRIS COUNTY, TEXAS

ı					
	8	8 100% EPA SUBMITTAL		CRH	11/25/20
	7	FOR CLIENT REVIEW	JC	CRH	11/21/20
	6	100% EPA SUBMITTAL	MW	CRH	07/17/20
	No.	Issue	Drawn	Approved	Date
	Drawn JC  Drafting BS Check  Project CM Coordinator		Designer	RH	
			Design Check	LL	
			Date	Nov 25, 20	024
	constr	This document shall not be used for construction unless signed and sealed for construction.		AS SHOWN	
	Original Size		В	ar is one in	ich on

Project No. **11215702** 

Arch D

**EXCAVATION SECTION** 1 OF 6

Sheet No.

**C-13** 


Sheet **14** of **83** 

original size drawing

Plot Date: 25 November 2024 - 3:15 PM

Plotted By: Jonathan Compton

Filename: \\ghd\net\ghd\US\Baton Rouge\Projects\562\11215702\Digital\_Design\ACAD 2019\Sheets\11215702-01-DWG-C-013.dwg

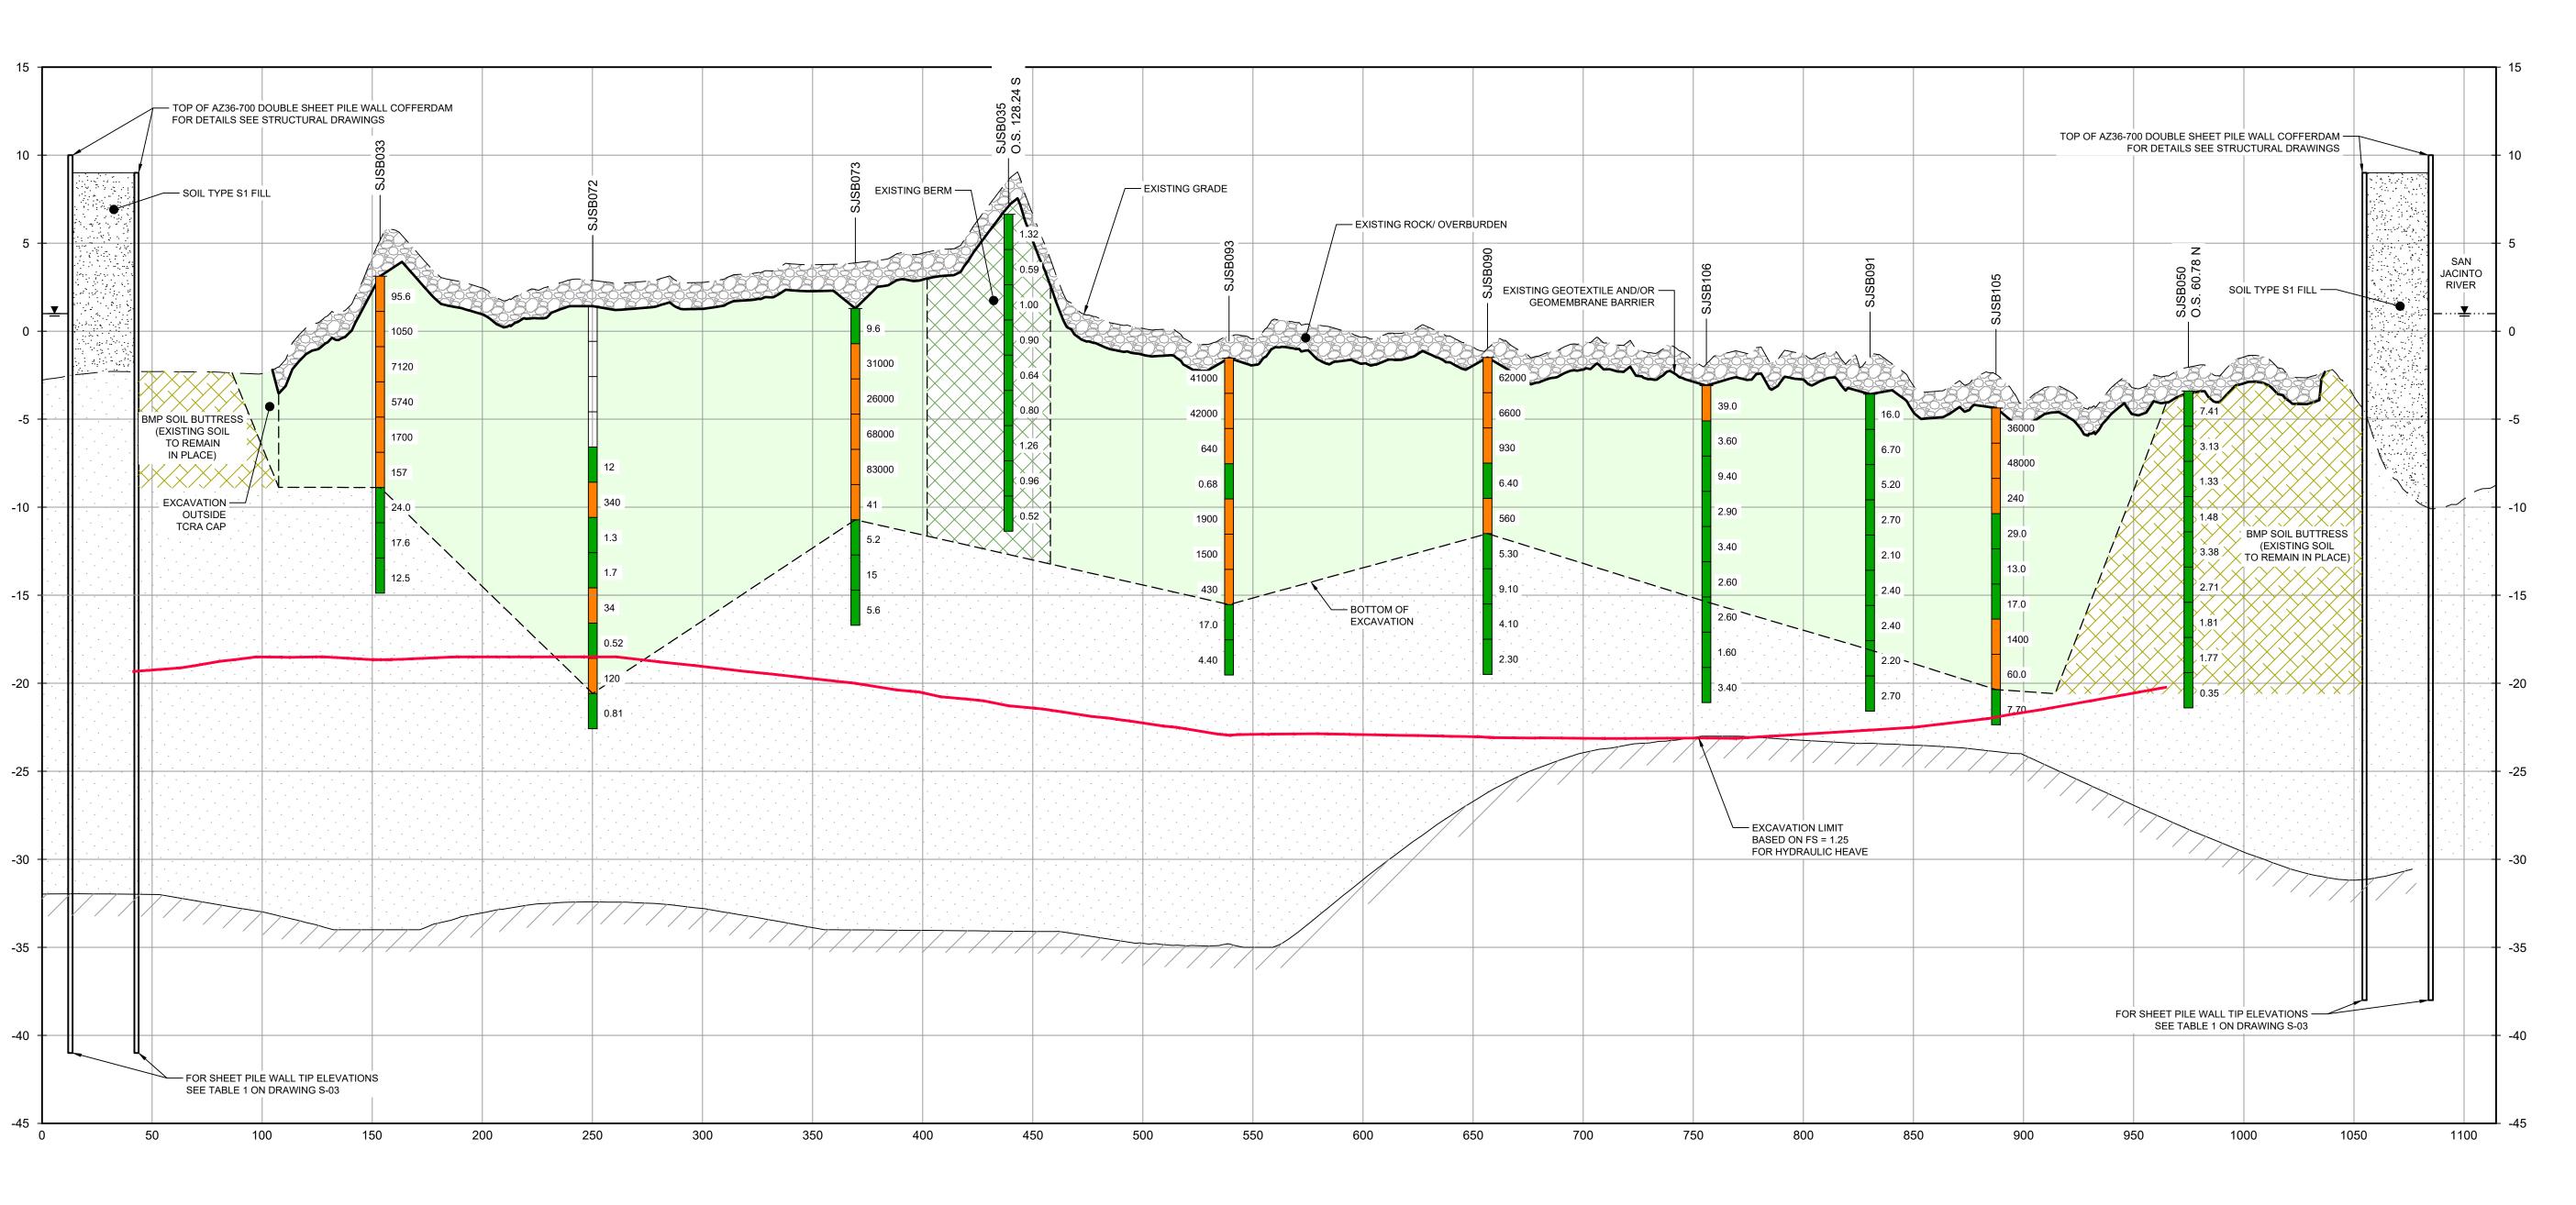

B WEST/EAST C-08 VERT: 1"=5'

BOTTOM OF EXCAVATION IS SUBJECT TO CHANGE.
 SCOUR PROTECTION ON INTERIOR AND EXTERIOR SIDE OF COFFERDAM NOT SHOWN. SEE DRAWINGS C-28 TO C-44 FOR LIMITS OF RIPRAP.

THIS DOCUMENT IS RELEASED FOR THE PURPOSE OF EPA REVIEW UNDER THE AUTHORITY OF CLARENCE R. HOEKSTRA, P.E. 147936 ON 11/25/2024. IT IS NOT TO BE USED FOR CONSTRUCTION, BIDDING, RECORDATION, CONVEYANCE OR SALES PURPOSES.



100% EPA SUBMITTAL



2237 S Acadian Thruway Suite 701 Baton Rouge Louisiana 70808 USA **T** 225 292 9007



Reuse of Documents

This document and the ideas and designs incorporated herein, as an instrument of professional service, is the property of GHD and shall not be reused in whole or in part for any other project without GHD's written authorization. © 2024 GHD

SOILS WITH CONCENTRATIONS

<30 ng/kg TEQ<sub>DF,M</sub> TCDD SOILS WITH CONCENTRATIONS >30 ng/kg TEQ<sub>DF,M</sub> TCDD

EXCAVATION LIMIT BASED ON FS = 1.25 FOR HYDRAULIC HEAVE MATERIAL TO BE EXCAVATED EXISTING BERM TO BE EXCAVATED FOR POTENTIAL TESTING AND REUSE BMP SOIL BUTTRESS (EXISTING SOIL TO REMAIN IN PLACE)

**SAN JACINTO RIVER WASTE PITS** 

NORTHERN IMPOUNDMENT FINAL 100% REMEDIAL DESIGN HARRIS COUNTY, TEXAS

	7	100% EPA SUBMITTAL	JC	CRH	11/25/2
	6	FOR CLIENT REVIEW	JC	CRH	11/21/2
	5	100% EPA SUBMITTAL	MW	CRH	07/17/2
	No.	Issue	Drawn	Approved	Date
	Draw	n <b>JC</b>	Designer	RH	
	Drafting Check  Project CM Coordinator  This document shall not be used for construction unless signed and sealed for construction.		Design Check	LL	
			Date	Nov 25, 20	)24
			Scale	AS SHOW	/N
	Original Size		В	Bar is one in	ch on

Arch D

Project No. **11215702** 


**EXCAVATION SECTION** 2 OF 6


Sheet No.

C-14

Sheet **15** of **83** 

Bar is one inch on original size drawing

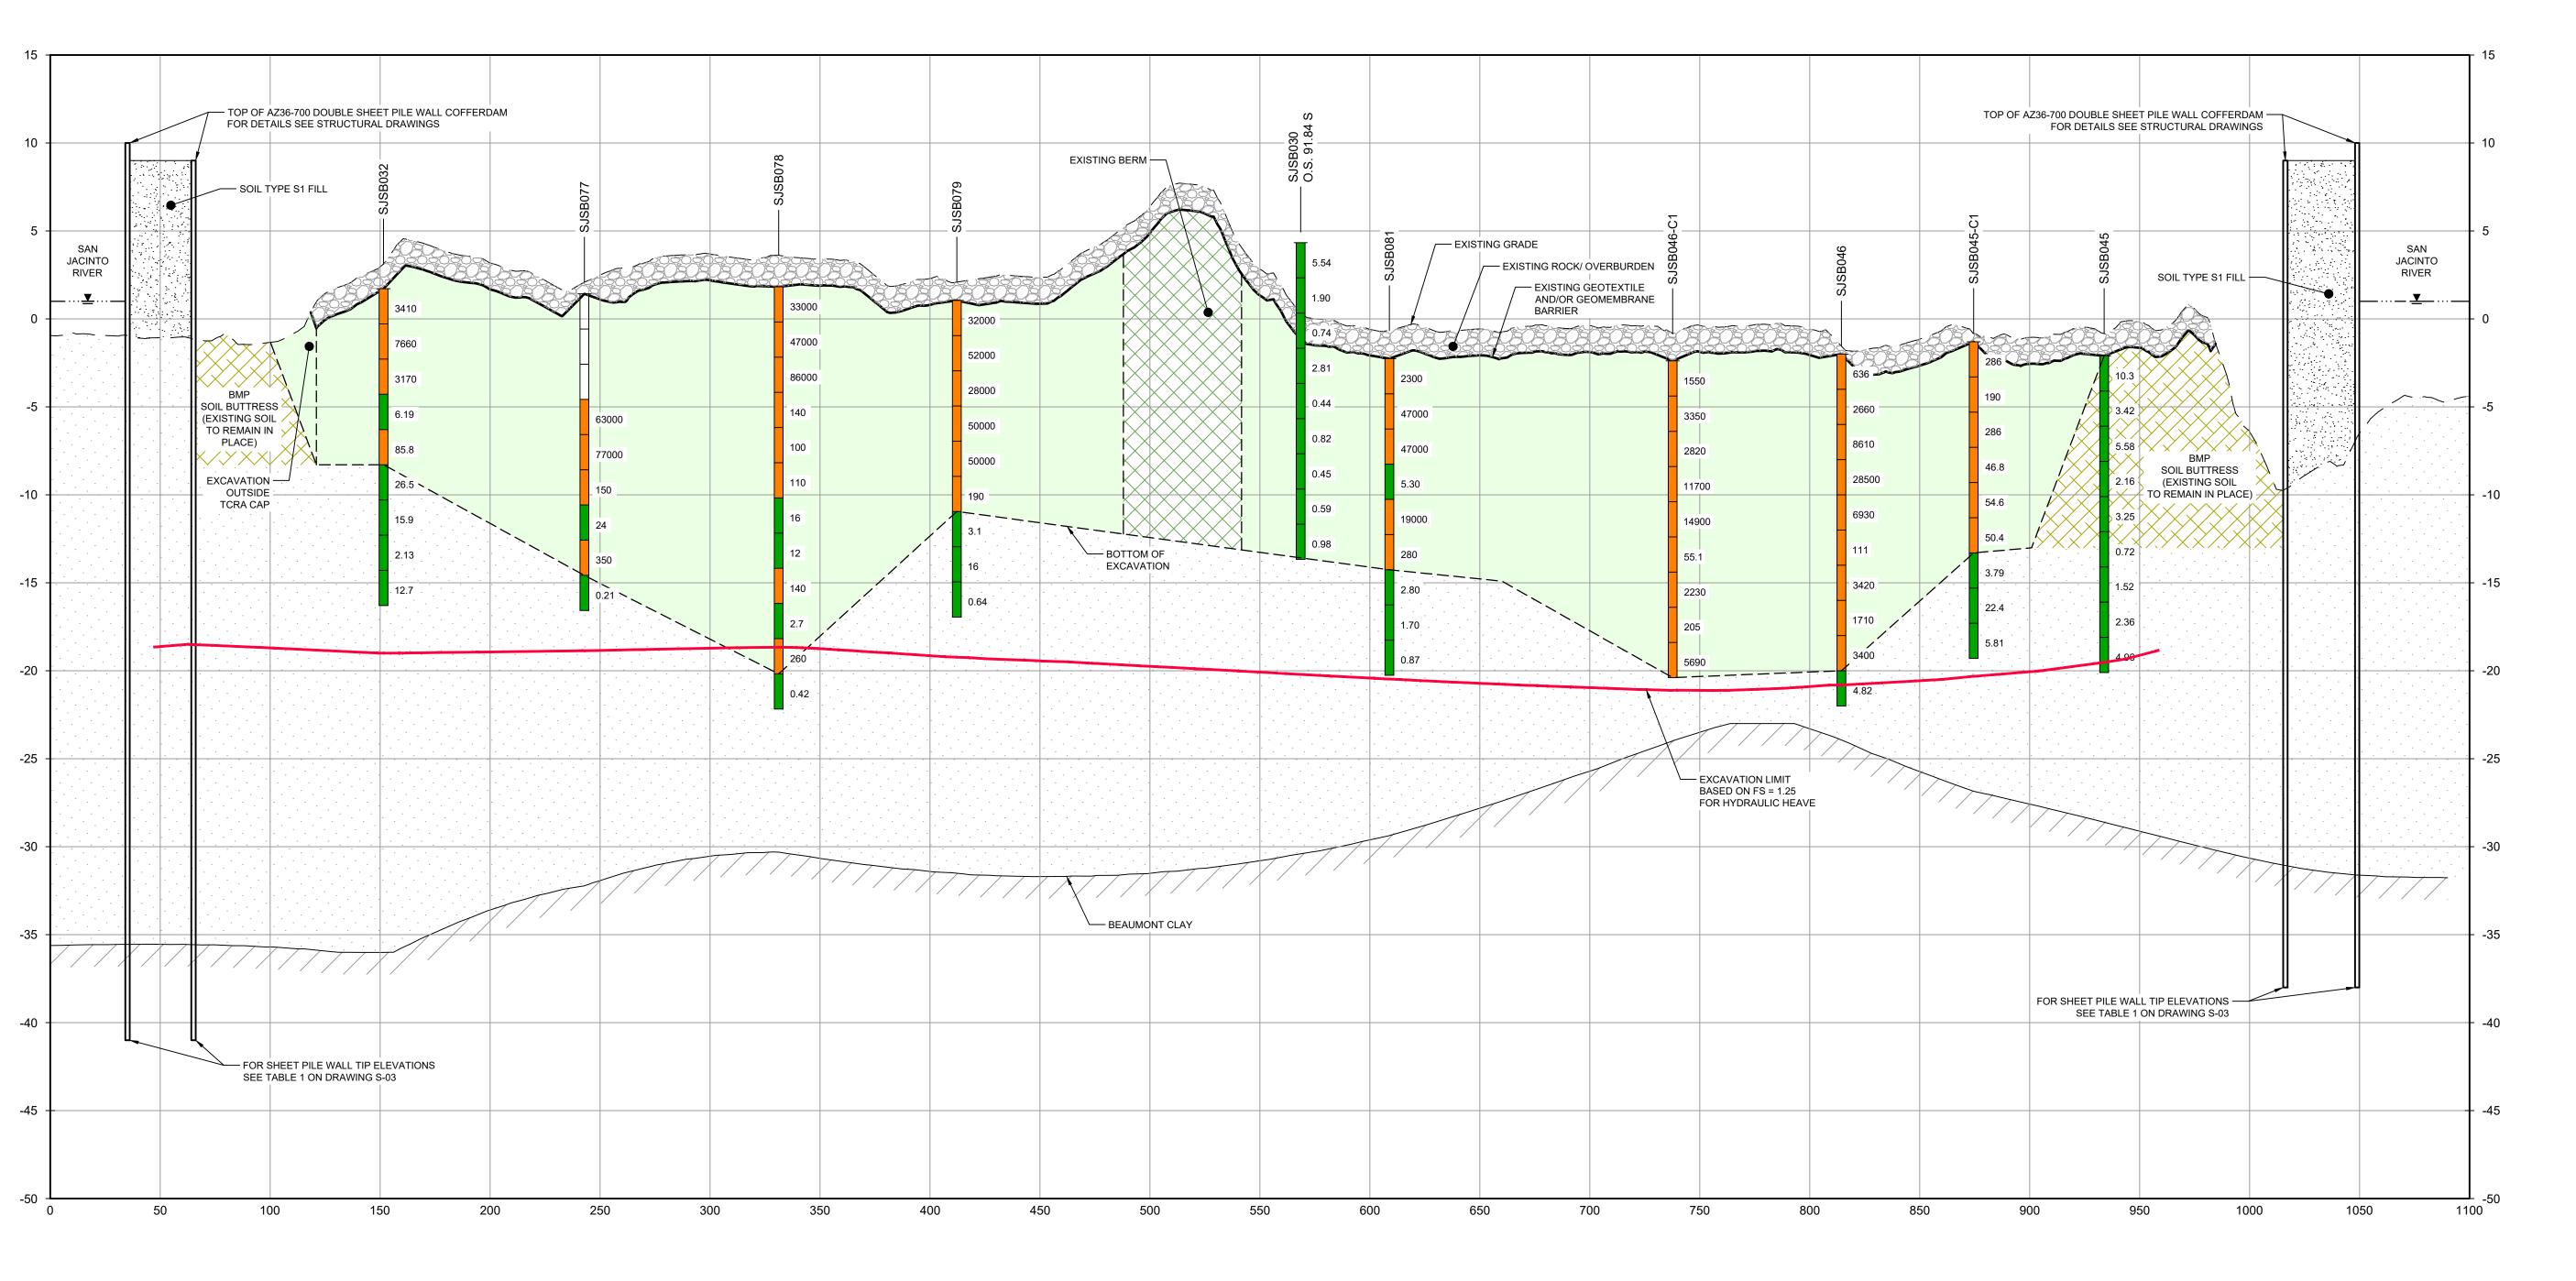


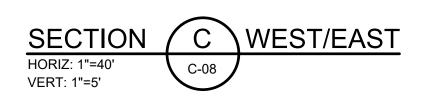

NOTES:

 BOTTOM OF EXCAVATION IS SUBJECT TO CHANGE.
 SCOUR PROTECTION ON INTERIOR AND EXTERIOR SIDE OF COFFERDAM NOT SHOWN. SEE DRAWINGS C-28 TO C-44 FOR LIMITS OF RIPRAP.

THIS DOCUMENT IS RELEASED FOR THE PURPOSE OF EPA REVIEW UNDER THE AUTHORITY OF CLARENCE R. HOEKSTRA, P.E. 147936 ON 11/25/2024. IT IS NOT TO BE USED FOR CONSTRUCTION, BIDDING, RECORDATION, CONVEYANCE OR SALES PURPOSES.

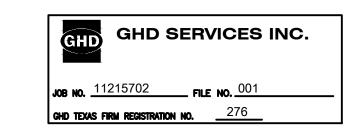

100% EPA SUBMITTAL



2237 S Acadian Thruway Suite 701 Baton Rouge Louisiana 70808 USA T 225 292 9007



Reuse of Documents

This document and the ideas and designs incorporated herein, as an instrument of professional service, is the property of GHD and shall not be reused in whole or in part for any other project without GHD's written authorization. © 2024 GHD

SOILS WITH CONCENTRATIONS
<30 ng/kg TEQ<sub>DF,M</sub> TCDD

SOILS WITH CONCENTRATIONS
>30 ng/kg TEQ<sub>DF,M</sub> TCDD

<30 ng/kg TEQ<sub>DF,M</sub> TCDD
SOILS WITH CONCENTRATIONS
>30 ng/kg TEQ<sub>DF,M</sub> TCDD
EXCAVATION LIMIT BASED ON
FS = 1.25 FOR HYDRAULIC HEAVE
MATERIAL TO BE EXCAVATED
EXISTING BERM TO BE EXCAVATED
FOR POTENTIAL TESTING AND REUSE
BMP SOIL BUTTRESS (EXISTING SOIL

TO REMAIN IN PLACE)

SAN JACINTO RIVER WASTE PITS

NORTHERN IMPOUNDMENT FINAL 100% REMEDIAL DESIGN HARRIS COUNTY, TEXAS

7	100% EPA SUBMITTAL	JC	CRH	11/25/2
6	FOR CLIENT REVIEW	JC	CRH	11/21/2
5	100% EPA SUBMITTAL	MW	CRH	07/17/2
No.	Issue	Drawn	Approved	Dat
Draw	n <b>JC</b>	Designer	RH	
Drafting BS Check		Design Check	LL	
Project CM Coordinator		Date	Nov 25, 20	)24
This document shall not be used for construction unless signed and sealed for construction		Scale	AS SHOW	/N

Arch D

Project No. **11215702** 

Title

Original Size


EXCAVATION SECTION 3 OF 6

Sheet No.

C-15

Sheet **16** of **83** 

Bar is one inch on original size drawing

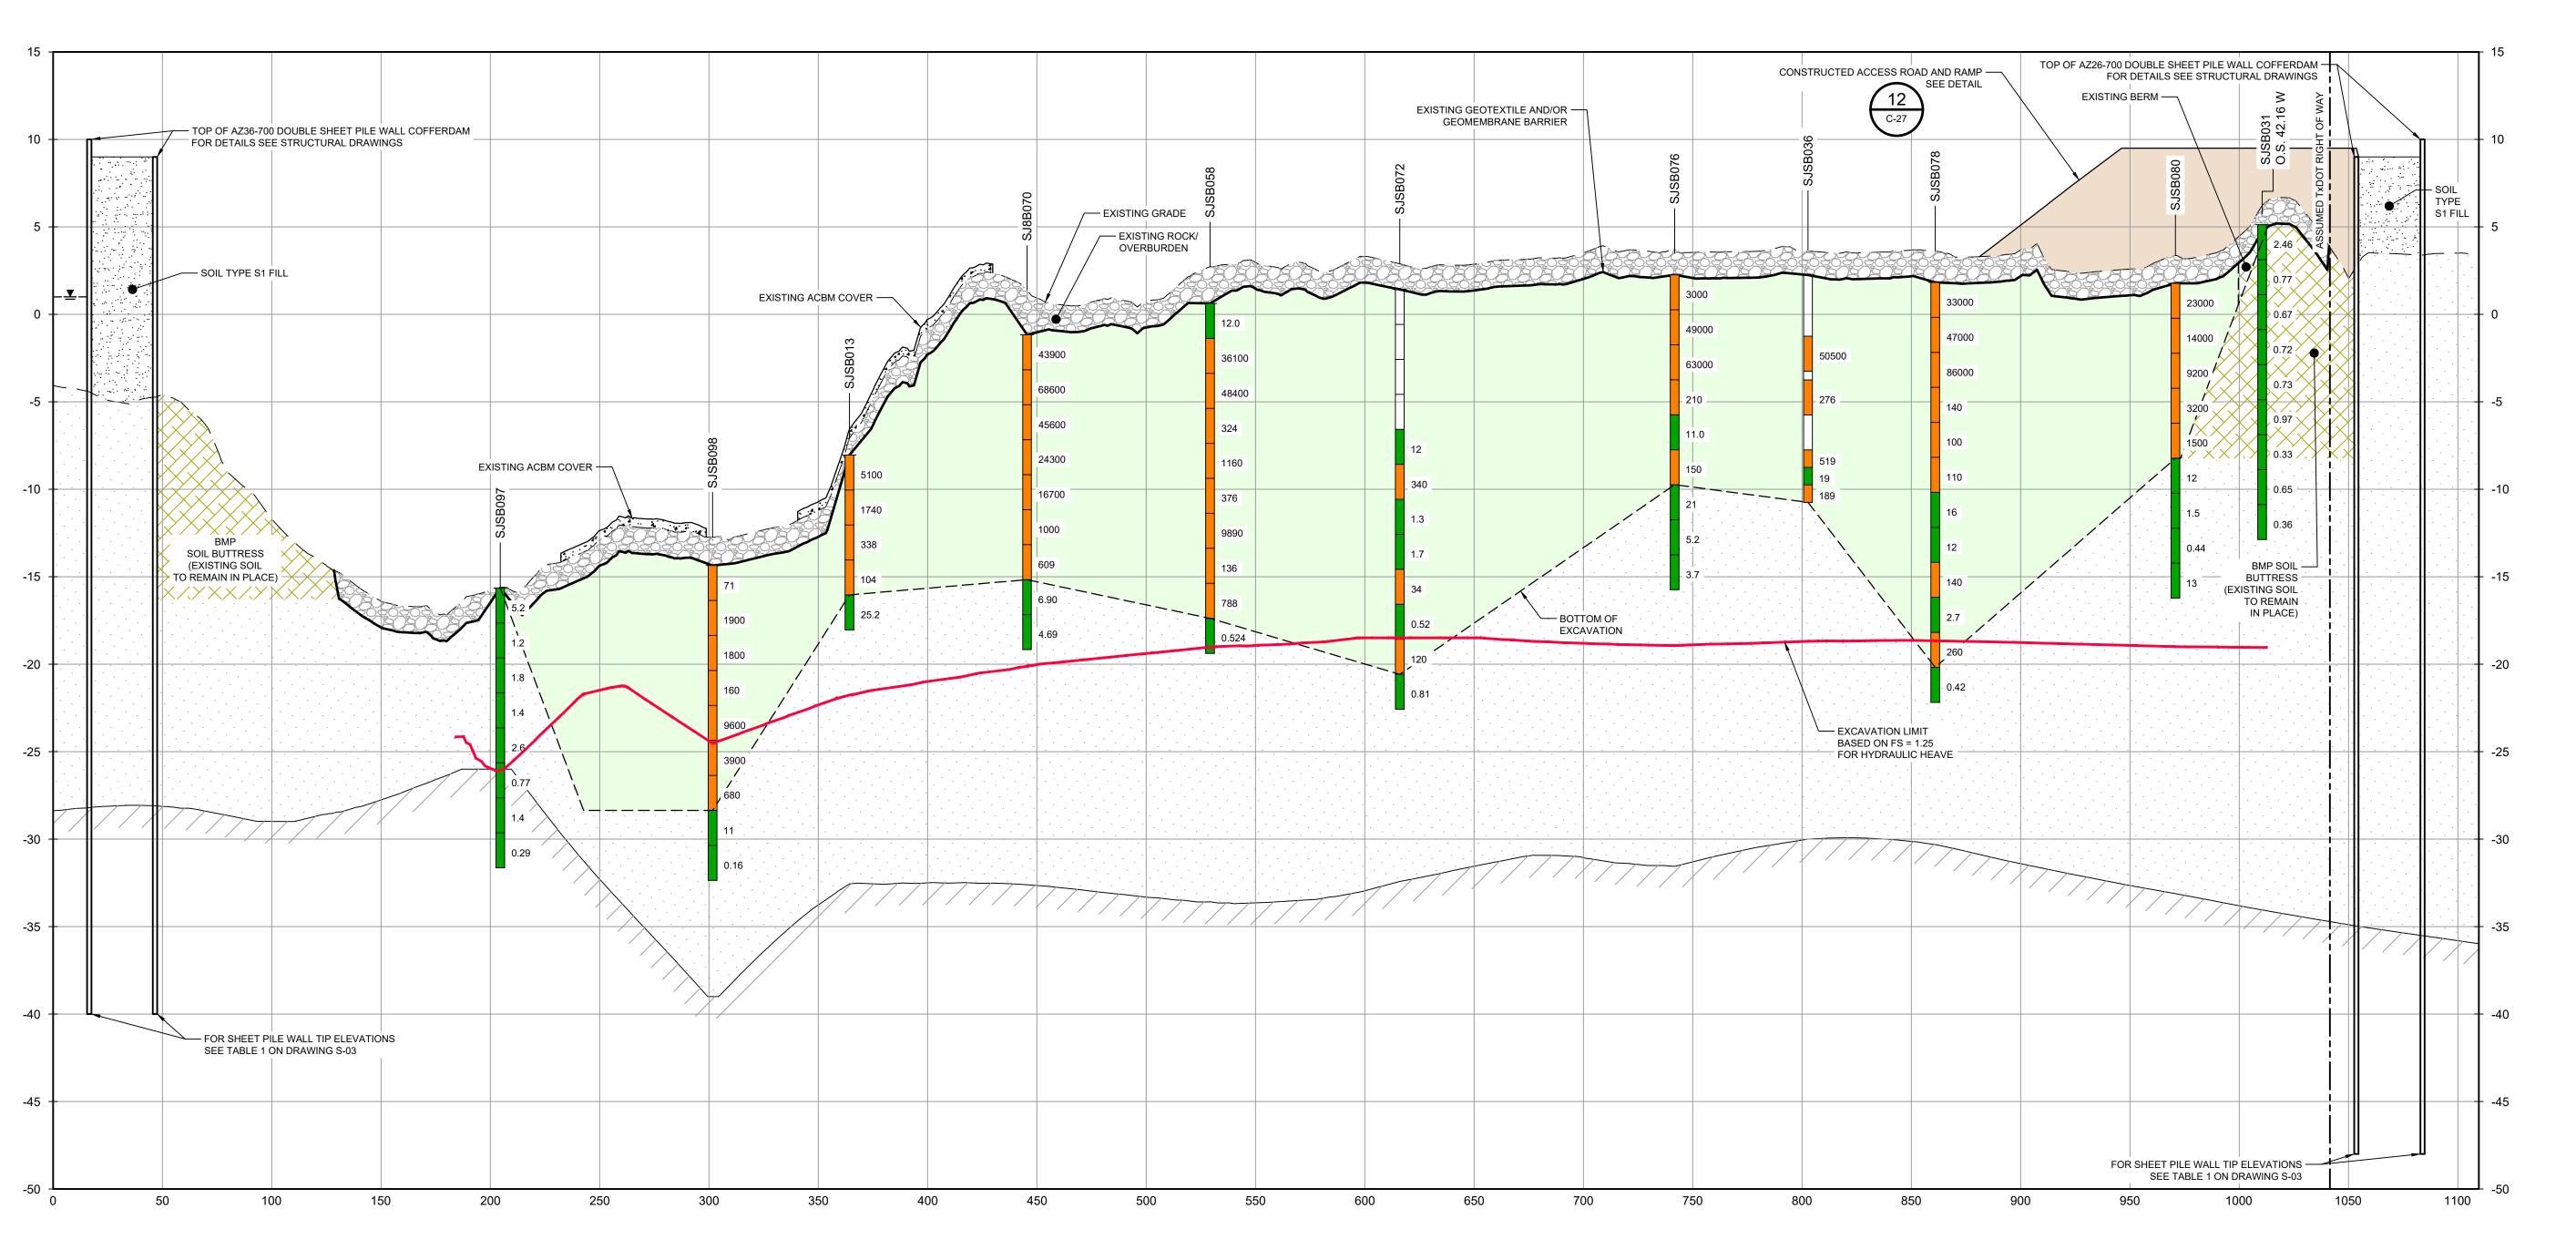

SOURCE:

TXDOT RIGHT OF WAY FROM A BOUNDARY AND RIGHT-OF-WAY SURVEY OF PORT OF HOUSTON AUTHORITY PROPERTY & HOUSTON FLEETING SERVICES, LLC PROPERTY ALONG INTERSTATE HIGHWAY 10 AT THE SAN JACINTO FLEET AREA, IN THE J. T. HARRELL SURVEY, A-330 HARRIS COUNTY, TEXAS, COBBFENDLEY, 2402-028-01, JUNE 28, 2024

1. BOTTOM OF EXCAVATION IS SUBJECT TO CHANGE. 2. SCOUR PROTECTION ON INTERIOR AND EXTERIOR SIDE OF COFFERDAM NOT SHOWN. SEE DRAWINGS C-28 TO C-44 FOR LIMITS OF RIPRAP.


THIS DOCUMENT IS RELEASED FOR THE PURPOSE OF EPA REVIEW UNDER THE AUTHORITY OF CLARENCE R. HOEKSTRA, P.E. 147936 ON 11/25/2024. IT IS NOT TO BE USED FOR CONSTRUCTION, BIDDING, RECORDATION,

CONVEYANCE OR SALES PURPOSES.



100% EPA SUBMITTAL



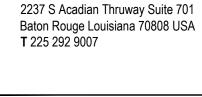



Reuse of Documents

This document and the ideas and designs incorporated herein, as an instrument of professional service, is the property of GHD and shall not be reused in whole or in part for any other project without GHD's written authorization. © 2024 GHD

SOILS WITH CONCENTRATIONS

<30 ng/kg TEQ<sub>DF,M</sub> TCDD SOILS WITH CONCENTRATIONS >30 ng/kg TEQ<sub>DF,M</sub> TCDD EXCAVATION LIMIT BASED ON FS = 1.25 FOR HYDRAULIC HEAVE MATERIAL TO BE EXCAVATED EXISTING BERM TO BE EXCAVATED FOR POTENTIAL TESTING AND REUSE

BMP SOIL BUTTRESS (EXISTING SOIL TO REMAIN IN PLACE) PLANNED IMPROVEMENTS FOR NORTHERN IMPOUNDMENT ACCESS

**SAN JACINTO RIVER WASTE PITS** 

NORTHERN IMPOUNDMENT FINAL 100% REMEDIAL DESIGN HARRIS COUNTY, TEXAS

8	100% EPA SUBMITTAL	JC	CRH	11/25/2
7	FOR CLIENT REVIEW	JC	CRH	11/21/2
6	100% EPA SUBMITTAL	MW	CRH	07/17/2
No.	Issue	Drawn	Approved	Dat
Drawn <b>JC</b>		Designer	RH	
Drafting BS Check		Design Check	LL	
Project CM Coordinator		Date	Nov 25, 20	)24
This document shall not be used for construction unless signed and sealed for construction.		Scale AS SHOWN		
Original Size		Е	ar is one in	ch on

Bar is one inch on original size drawing Arch D

Project No. **11215702** 

**EXCAVATION SECTION** 


4 OF 6

Sheet No.

C-16

Sheet **17** of **83** 

D NORTH/SOUTH C-08 VERT: 1"=5'

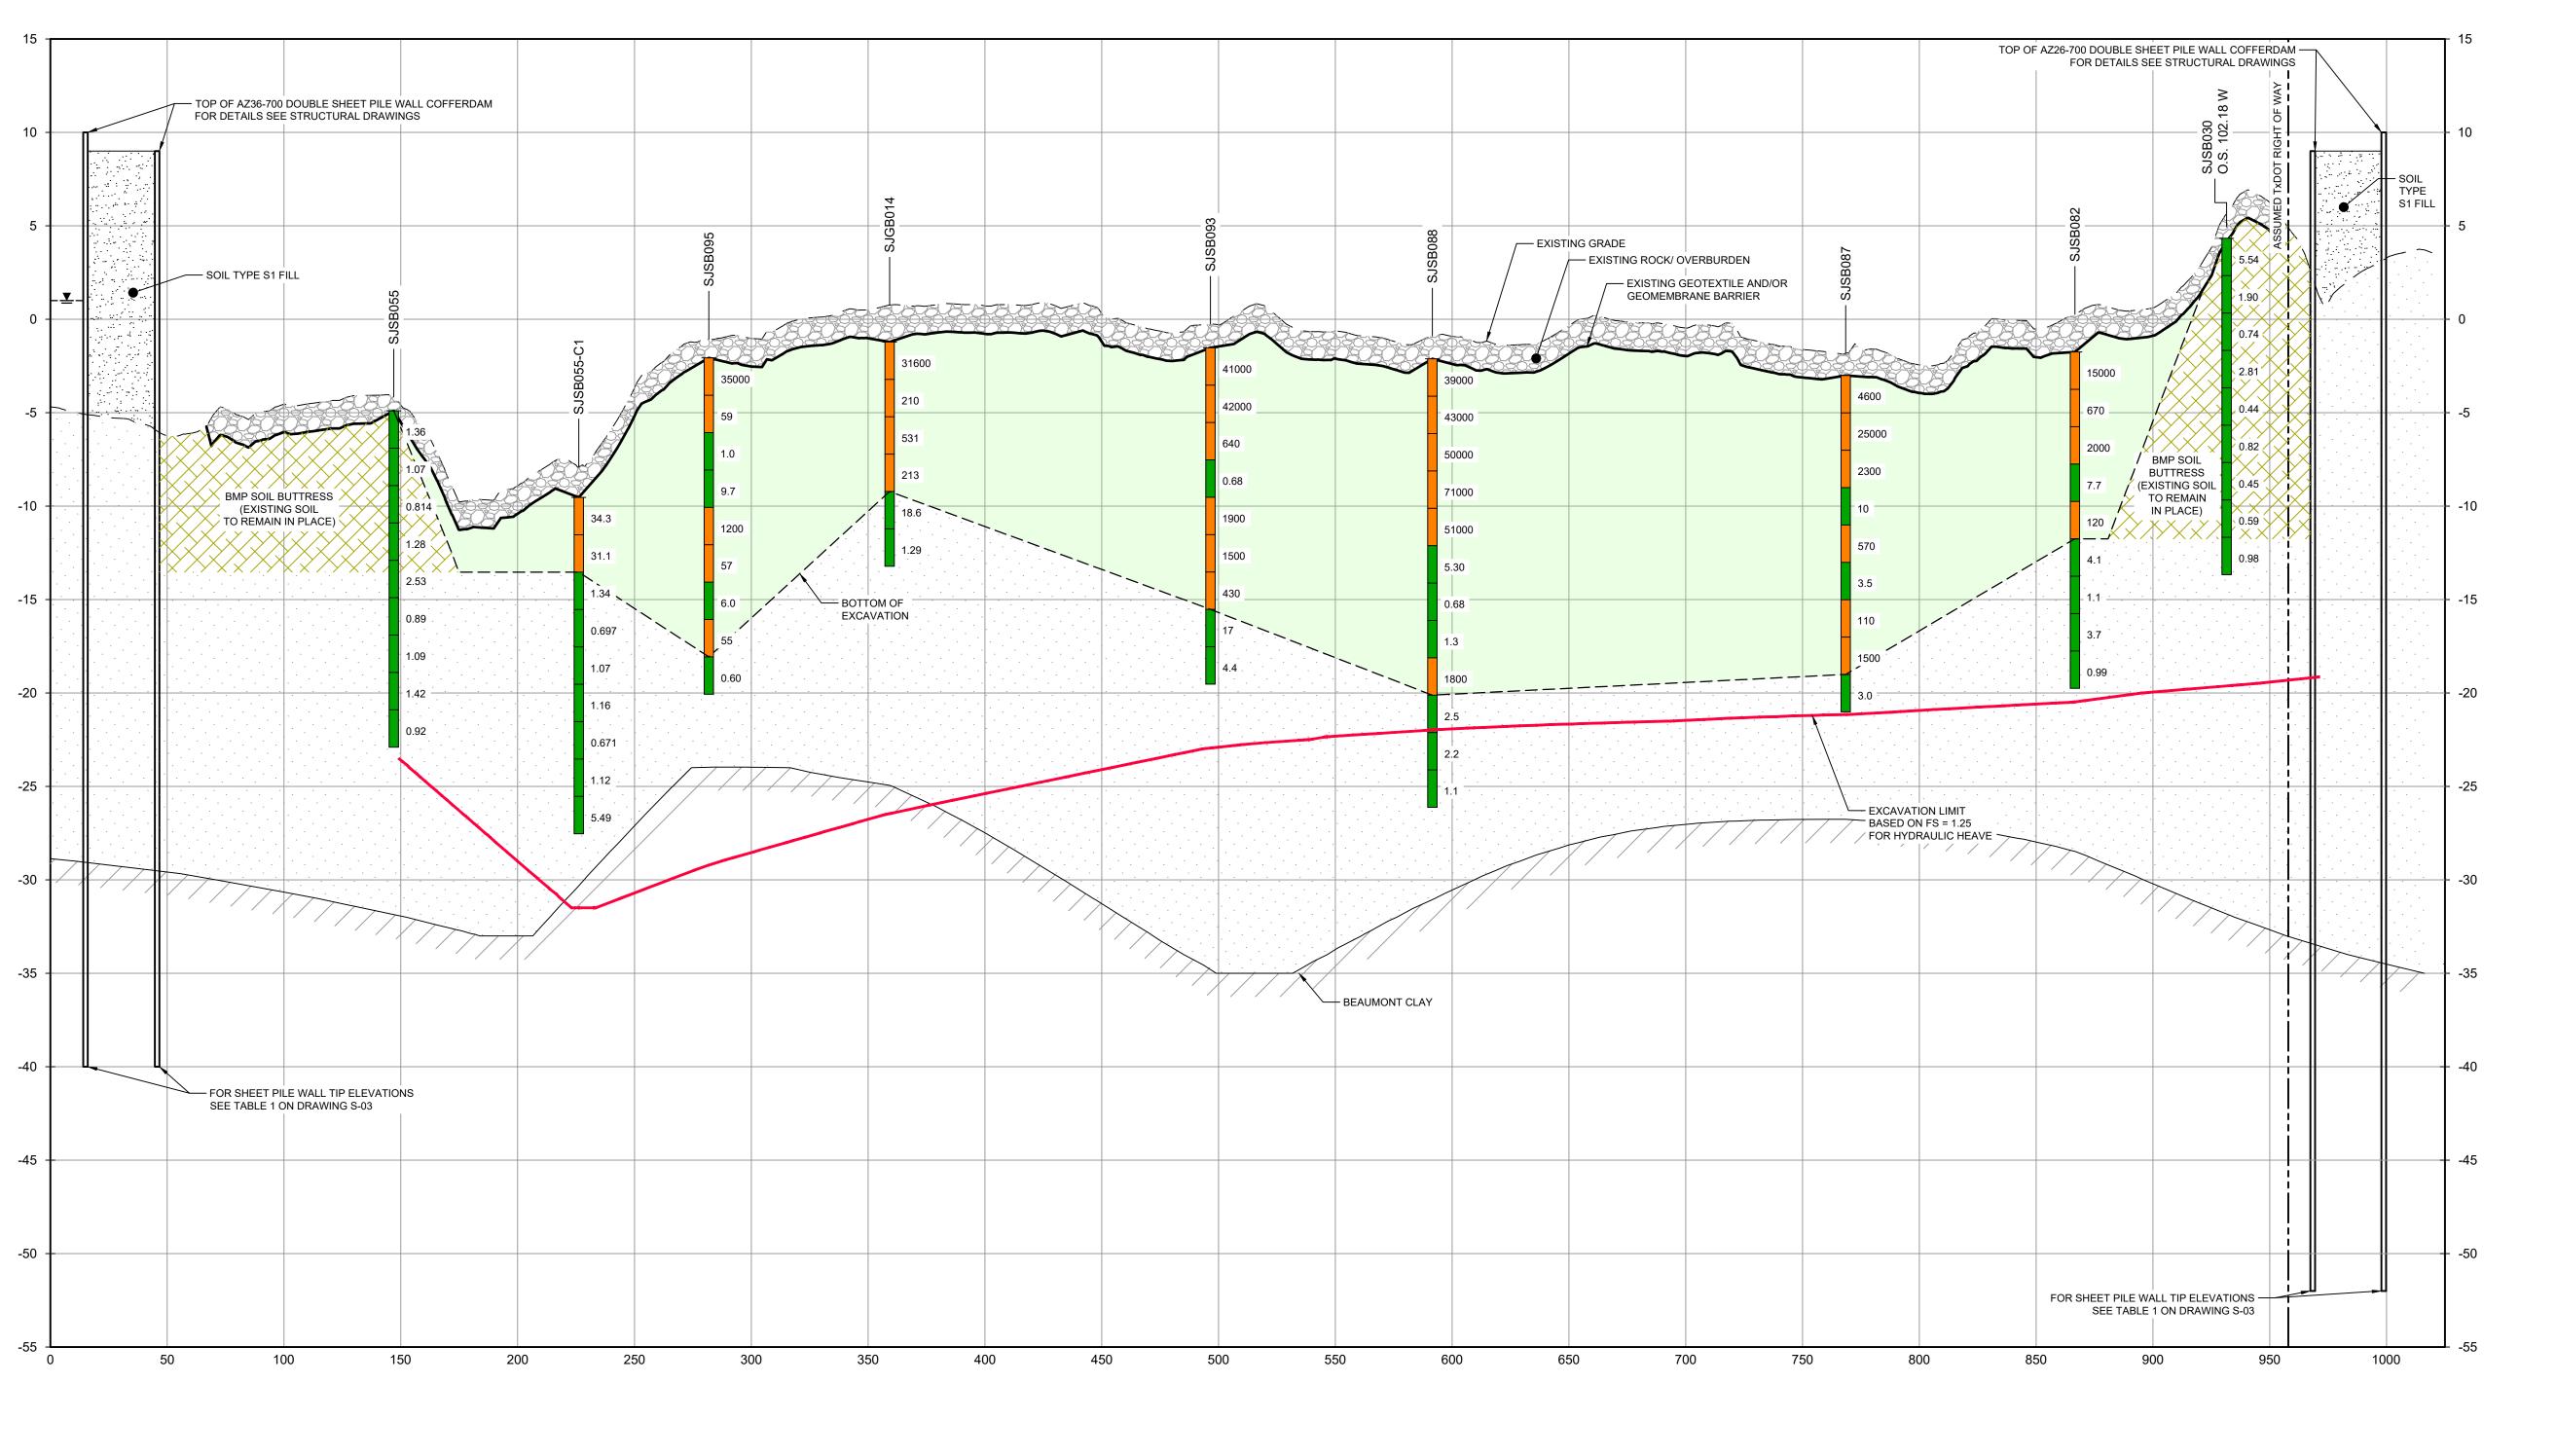

SECTION E NORTH/SOUTH
HORIZ: 1"=40'
VERT: 1"=5'


SOURCE:

TXDOT RIGHT OF WAY FROM A BOUNDARY AND RIGHT-OF-WAY SURVEY OF PORT OF HOUSTON AUTHORITY PROPERTY & HOUSTON FLEETING SERVICES, LLC PROPERTY ALONG INTERSTATE HIGHWAY 10 AT THE SAN JACINTO FLEET AREA, IN THE J. T. HARRELL SURVEY, A-330 HARRIS COUNTY, TEXAS, COBBFENDLEY, 2402-028-01, JUNE 28, 2024

## NOTES:

 BOTTOM OF EXCAVATION IS SUBJECT TO CHANGE.
 SCOUR PROTECTION ON INTERIOR AND EXTERIOR SIDE OF COFFERDAM NOT SHOWN. SEE DRAWINGS C-28 TO C-44 FOR LIMITS OF RIPRAP.

THIS DOCUMENT IS RELEASED FOR THE PURPOSE OF EPA REVIEW UNDER THE AUTHORITY OF CLARENCE R. HOEKSTRA, P.E. 147936 ON 11/25/2024. IT IS NOT TO BE USED FOR CONSTRUCTION, BIDDING, RECORDATION, CONVEYANCE OR SALES PURPOSES.

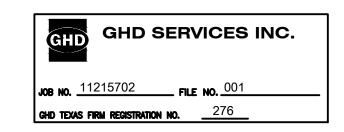

100% EPA SUBMITTAL



GHD 2237 S Acadian Thruway Suite 701 Baton Rouge Louisiana 70808 USA T 225 292 9007



Reuse of Documents

This document and the ideas and designs incorporated herein, as an instrument of professional service, is the property of GHD and shall not be reused in whole or in part for any other project without GHD's written authorization. © 2024 GHD

SOILS WITH CONCENTRATIONS
<30 ng/kg TEQ<sub>DF,M</sub> TCDD

SOILS WITH CONCENTRATIONS

<30 ng/kg TEQ<sub>DF,M</sub> TCDD
SOILS WITH CONCENTRATIONS
>30 ng/kg TEQ<sub>DF,M</sub> TCDD
EXCAVATION LIMIT BASED ON
FS = 1.25 FOR HYDRAULIC HEAVE

EXCAVATION LIMIT BASED ON FS = 1.25 FOR HYDRAULIC HEAVE MATERIAL TO BE EXCAVATED EXISTING BERM TO BE EXCAVATED FOR POTENTIAL TESTING AND REUSE BMP SOIL BUTTRESS (EXISTING SOIL TO REMAIN IN PLACE)

SAN JACINTO RIVER
WASTE PITS

NORTHERN IMPOUNDMENT FINAL 100% REMEDIAL DESIGN HARRIS COUNTY, TEXAS

	8	100% EPA SUBMITTAL	JC	CRH	11/25
	7	FOR CLIENT REVIEW	JC	CRH	11/21
	6	100% EPA SUBMITTAL	MW	CRH	07/17
	No.	Issue	Drawn	Approved	Da
	Draw	n <b>JC</b>	Designer	RH	
	Drafting BS Check		Design Check	LL	
	Proje Coor	ct dinator <b>CM</b>	Date	Nov 25, 20	024
RT		document shall not be used for uction unless signed and sealed for	Scale	AS SHOW	/N

Original Size

Bar is one inch on original size drawing 0 1"

Project No. **11215702** 

Title


EXCAVATION SECTION 5 OF 6

Sheet No.

C-17

Sheet **18** of **83** 

Plot Date: 25 November 2024 - 3:15 PM

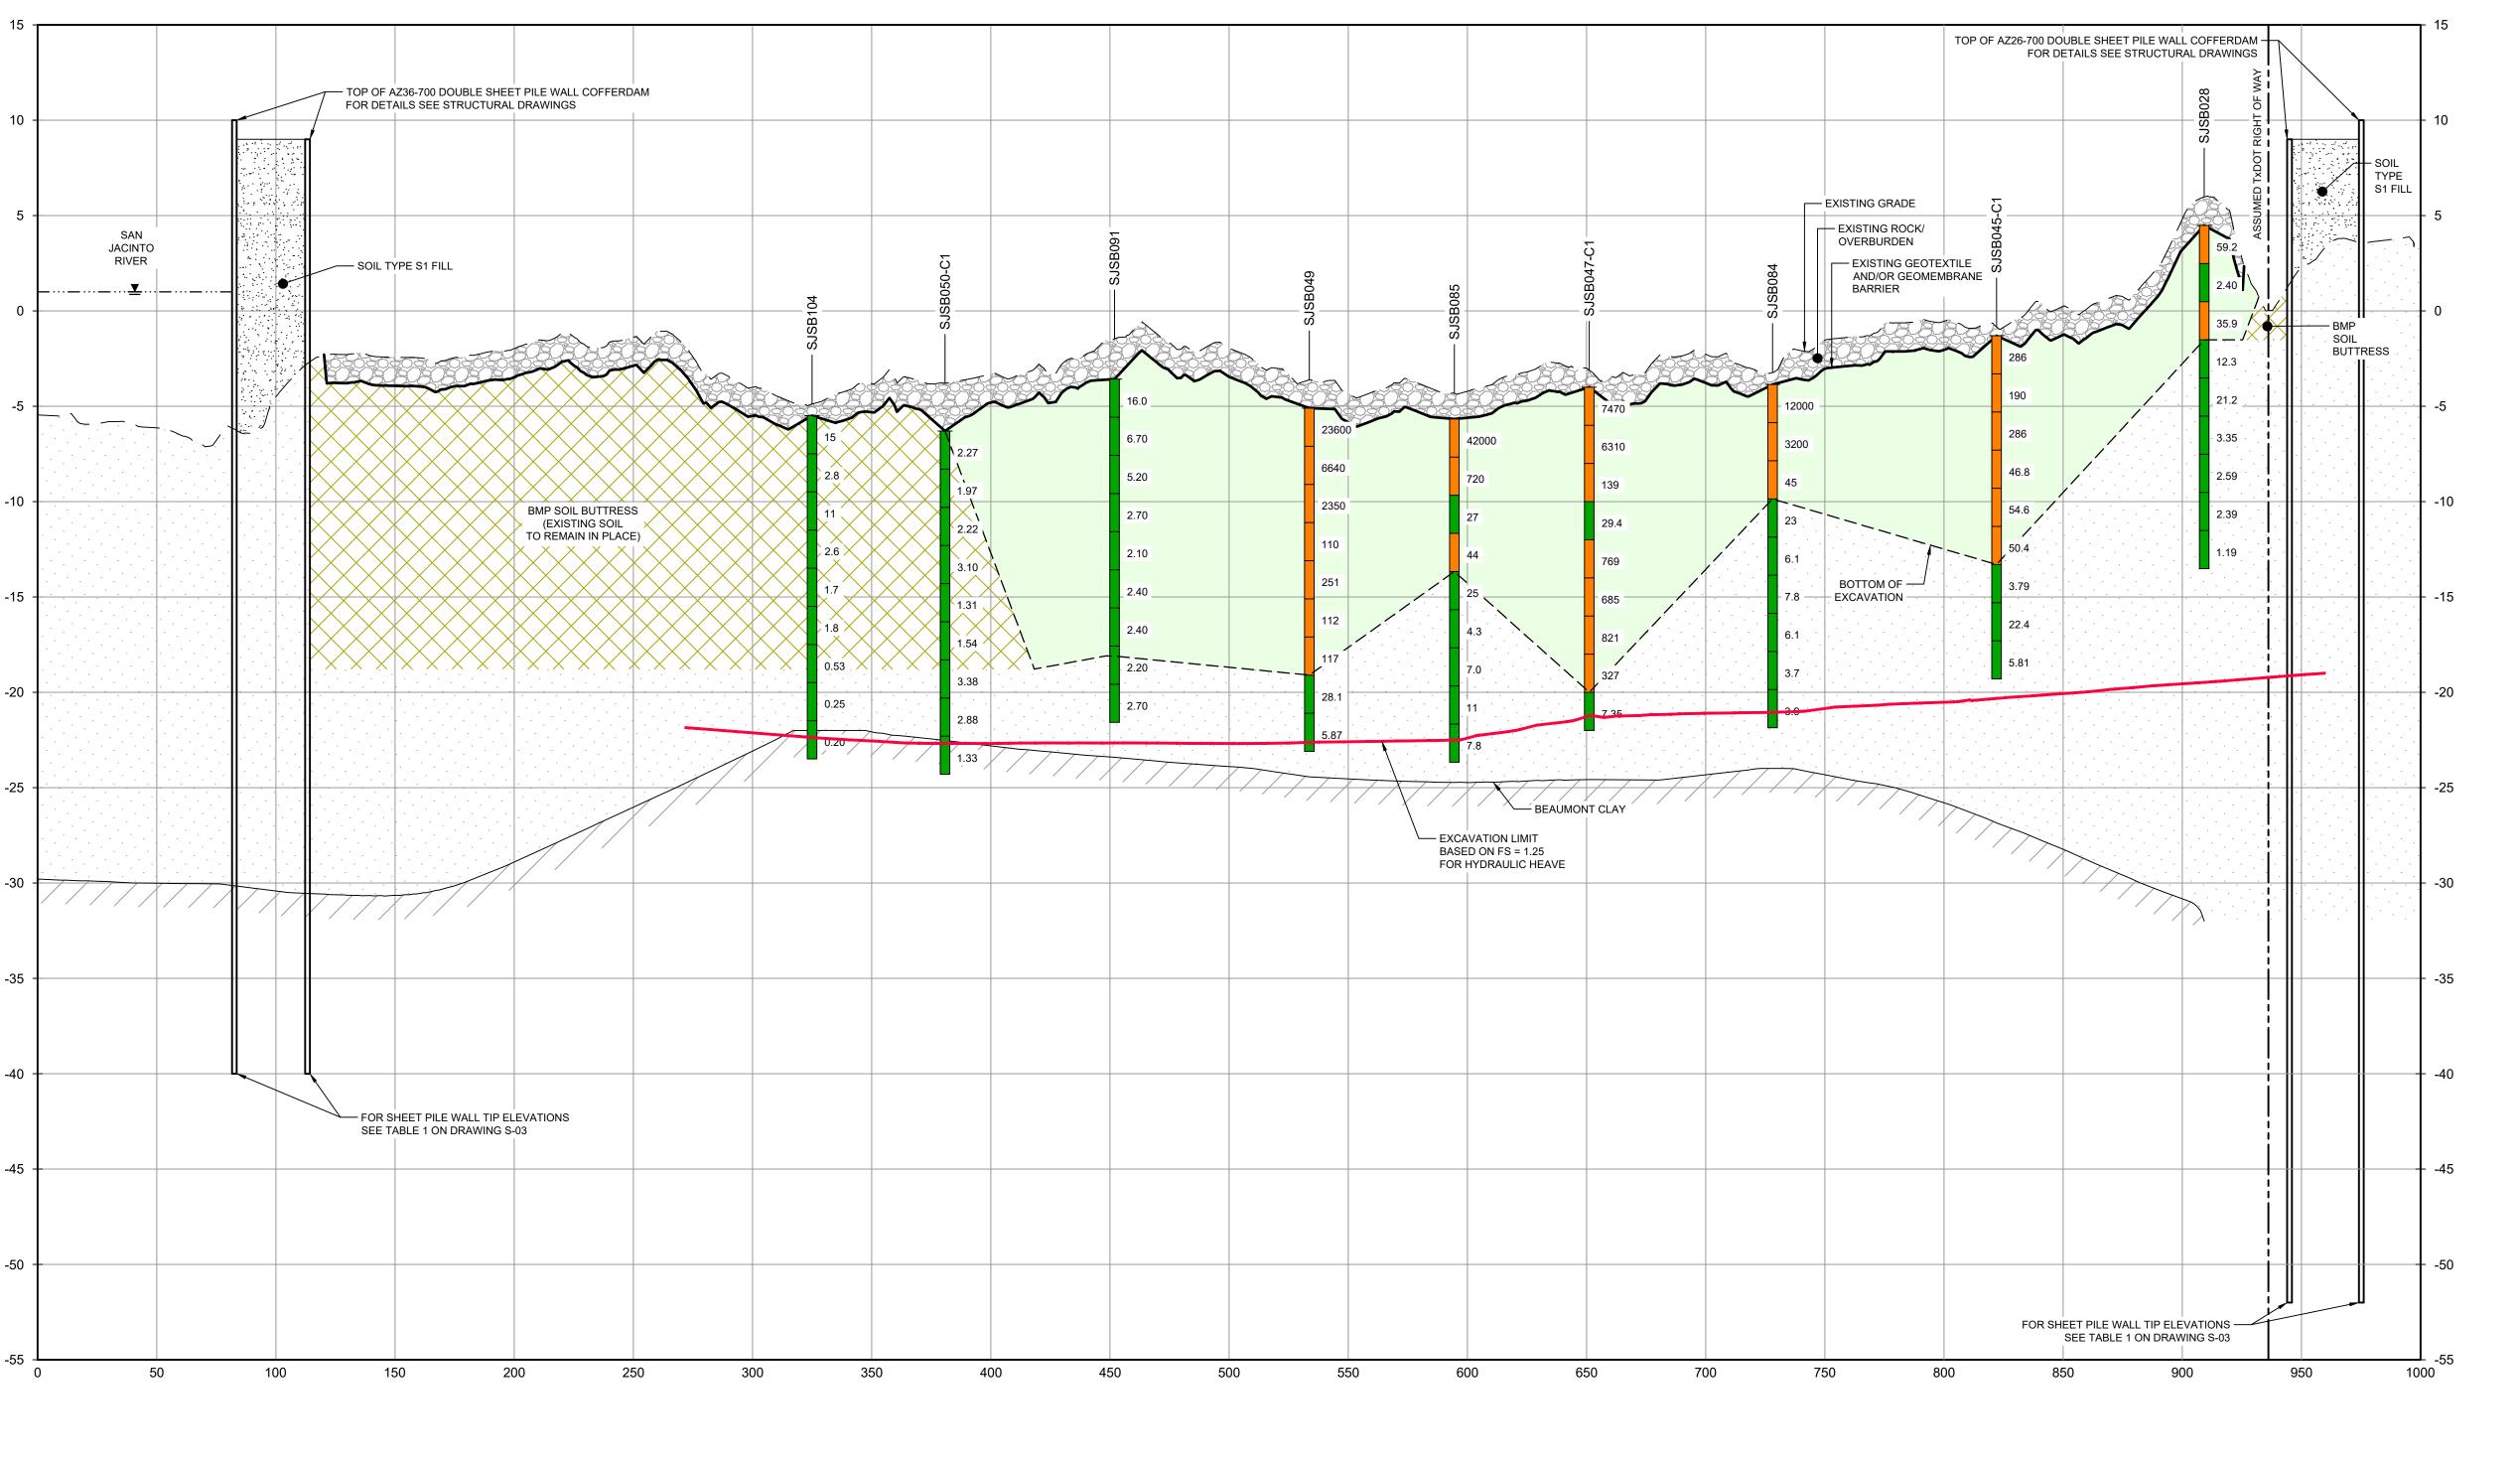

F NORTH/SOUTH C-08 VERT: 1"=5'

SOURCE:

TXDOT RIGHT OF WAY FROM A BOUNDARY AND RIGHT-OF-WAY SURVEY OF PORT OF HOUSTON AUTHORITY PROPERTY & HOUSTON FLEETING SERVICES, LLC PROPERTY ALONG INTERSTATE HIGHWAY 10 AT THE SAN JACINTO FLEET AREA, IN THE J. T. HARRELL SURVEY, A-330 HARRIS COUNTY, TEXAS, COBBFENDLEY, 2402-028-01, JUNE 28, 2024

1. BOTTOM OF EXCAVATION IS SUBJECT TO CHANGE. 2. SCOUR PROTECTION ON INTERIOR AND EXTERIOR SIDE OF COFFERDAM NOT SHOWN. SEE DRAWINGS C-28 TO C-44 FOR LIMITS OF RIPRAP.

THIS DOCUMENT IS RELEASED FOR THE PURPOSE OF EPA REVIEW UNDER THE AUTHORITY OF CLARENCE R. HOEKSTRA, P.E. 147936 ON 11/25/2024. IT IS NOT TO BE

USED FOR CONSTRUCTION, BIDDING, RECORDATION,

GHD TEXAS FIRM REGISTRATION NO. \_\_\_276

CONVEYANCE OR SALES PURPOSES. GHD SERVICES INC.

**100% EPA SUBMITTAL** 



2237 S Acadian Thruway Suite 701 Baton Rouge Louisiana 70808 USA **T** 225 292 9007



Reuse of Documents

This document and the ideas and designs incorporated herein, as an instrument of professional service, is the property of GHD and shall not be reused in whole or in part for any other project without GHD's written authorization. © 2024 GHD

SOILS WITH CONCENTRATIONS

<30 ng/kg TEQ<sub>DF,M</sub> TCDD SOILS WITH CONCENTRATIONS >30 ng/kg TEQ<sub>DF,M</sub> TCDD EXCAVATION LIMIT BASED ON

FS = 1.25 FOR HYDRAULIC HEAVE MATERIAL TO BE EXCAVATED EXISTING BERM TO BE EXCAVATED FOR POTENTIAL TESTING AND REUSE BMP SOIL BUTTRESS (EXISTING SOIL TO REMAIN IN PLACE)

Client **SAN JACINTO RIVER** 

NORTHERN IMPOUNDMENT FINAL 100% REMEDIAL DESIGN HARRIS COUNTY, TEXAS

**WASTE PITS** 

7	100% EPA SUBMITTAL	J	CRH	11/25/202
6	FOR CLIENT REVIEW	J	CRH	11/21/202
5	100% EPA SUBMITTAL	MW	CRH	07/17/202
No.	Issue	Drawn	Approved	Date
Draw	Drawn <b>JC</b>		RH	
Drafti Chec	· RS	Design Check	LL	
Proje Coor	ct dinator	Date	Nov 25, 20	024

Original Size Bar is one inch on original size drawing Arch D 0 1"

This document shall not be used for construction unless signed and sealed for Scale AS SHOWN

Project No. **11215702** 

**EXCAVATION SECTION** 

6 OF 6

Sheet No.

C-18

Sheet **19** of **83** 


Plot Date: 25 November 2024 - 3:15 PM

Plotted By: Jonathan Compton

Filename: \\ghdnet\ghd\US\Baton Rouge\Projects\562\11215702\Digital\_Design\ACAD 2019\Sheets\11215702-01-DWG-C-013.dwg





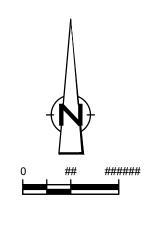





Reuse of Documents

This document and the ideas and designs incorporated herein, as an instrument of professional service, is the property of GHD and shall not be reused in whole or in part for any other project without GHD's written authorization. © 2024 GHD

**— – – — T**XDOT RIGHT OF WAY TCRA CAP PERIMETER EXISTING CONTOUR INTERVAL FENCELINE SHORELINE TOP OF BANK TOE OF SLOPE GUARDRAIL PIPELINE SJSB002 **BORING LOCATION** MONITORING WELL

EXISTING BERM TO BE EXCAVATED FOR POTENTIAL TESTING AND REUSE EXISTING BERM TO REMAIN CONCRETE AZ26-700 PILE AZ36-700 PILE AZ42-700 PILE 

POWER POLE LIGHT POLE

MATERIAL TO BE EXCAVATED

PHASE OF EXCAVATION EXTERIOR SCOUR PROTECTION INTERIOR SCOUR PROTECTION

**SAN JACINTO RIVER** 

**WASTE PITS** 

JC

CRH 11/25/2024

NORTHERN IMPOUNDMENT FINAL 100% REMEDIAL DESIGN HARRIS COUNTY, TEXAS

	FOR CLIENT REVIEW	JC	CRH	11/21/20
	100% EPA SUBMITTAL	MW	CRH	07/17/20
).	Issue	Drawn	Approved	Date
aw	n <b>JC</b>	Designer	RH	
afti ec	ng k <b>BS</b>	Design Check	LL	
oje or	ct dinator	Date	Nov 25, 20	)24
str	document shall not be used for uction unless signed and sealed for uction.	Scale	1" = 200'	
igii	nal Size  Arch D		ar is one in ginal size d	

100% EPA SUBMITTAL

Project No. **11215702** 


**SEASONAL EXCAVATION SEQUENCING** 


**TYPICAL** 


Sheet No.

C-19



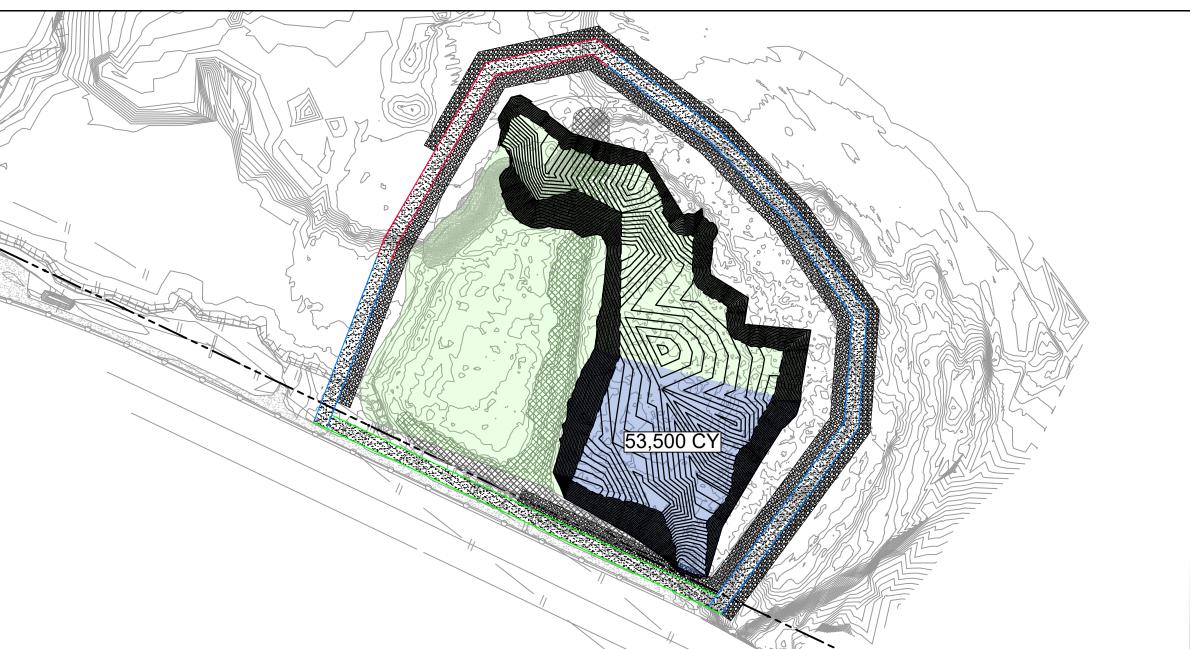

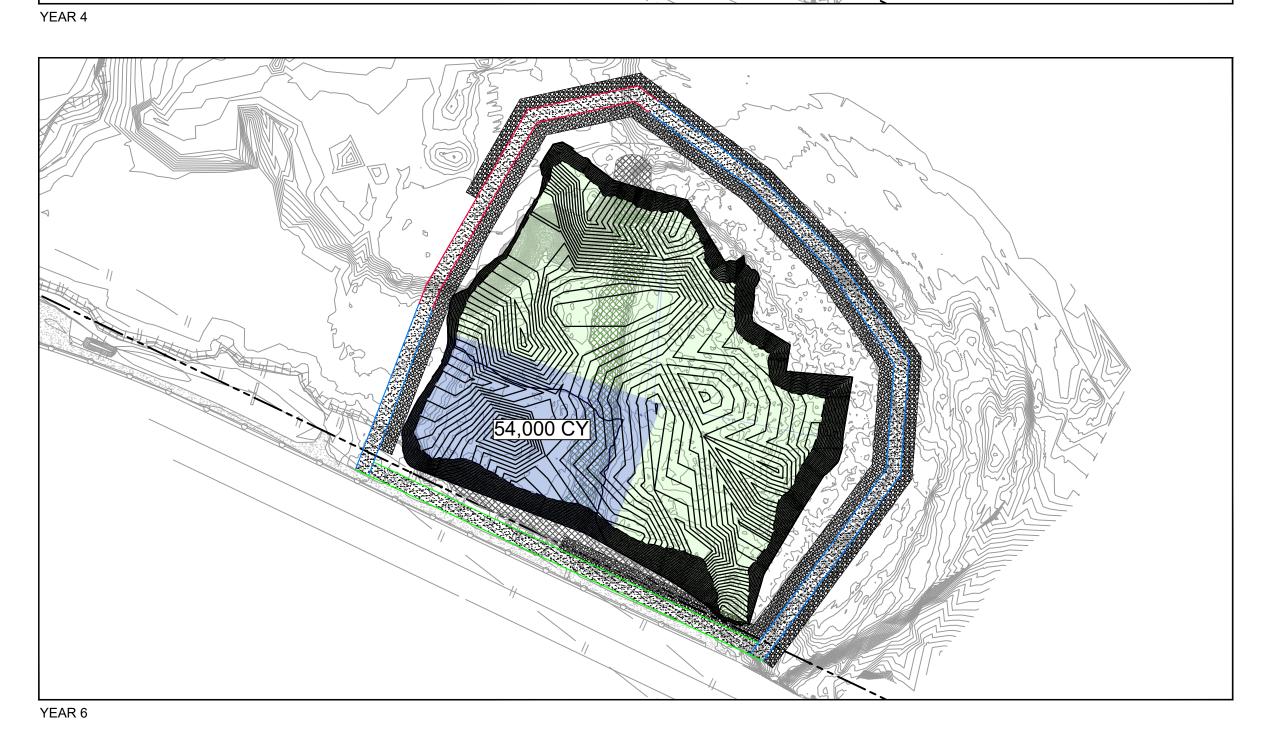

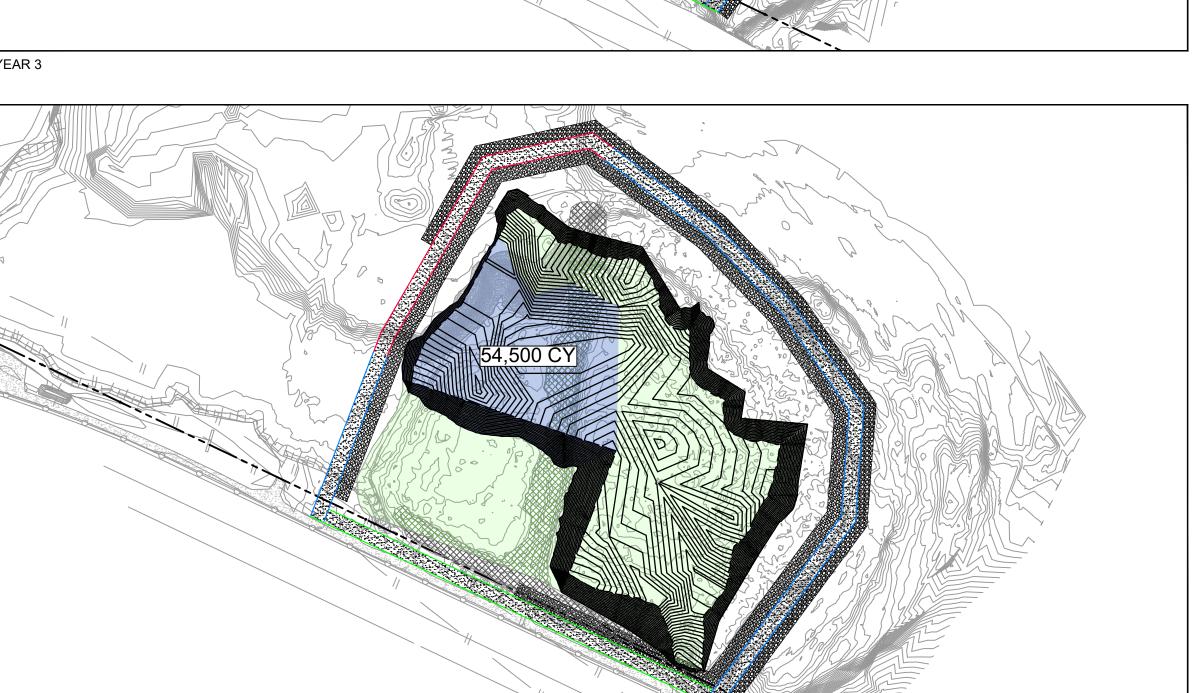

SEASONAL EXCAVATION VOLUMES							
DUACE	TCRA CAP	CENTER BERM MATERIAL		RIAL CONTAMINATED MATE		ERIAL	
PHASE	(CY)	CUT (CY)	FILL (CY)	NET (CUT; CY)	CUT (CY)	FILL (CY)	NET (CUT; CY)
YEAR 2	2,440	4,300	0	4,300	10,200	0	10,200
YEAR 3	7,800	2,350	0	2,350	51,150	0	51,150
YEAR 4	7,000	20	0	20	53,480	0	53,480
YEAR 5	5,560	11,230	0	11,230	43,270	0	43,270
YEAR 6	5,520	12,760	0	12,760	41,240	0	41,240
TOTAL	28.320	30 660	0	30 660	199 340	0	199 340

NOTES:

1. CENTER BERM MATERIAL MAY NOT BE IMPACTED MATERIAL. CHEMICAL SAMPLING SHALL BE CONDUCTED ON CENTER BERM MATERIAL. IF DIOXIN CONTAMINATION IS FOUND TO BE PRESENT THEN THE CENTER BERM MATERIAL SHALL BE DISPOSED OFF-SITE AND WILL NOT BE AVAILABLE FOR

RE-USE.
2. VOLUME CALCULATIONS CONDUCTED USING TOOLS AND MEASUREMENTS IN AUTODESK AUTOCAD CIVIL 3D 2024.

SOURCE:

TOPOGRAPHIC, HYDROGRAPHIC, & MAGNETOMETER SURVEY OF SAN JACINTO RIVER WASTE PITS, HARRIS COUNTY, TEXAS, MORRISON SURVEYING INC., 190608, JULY 8, 2019 TO AUGUST 2, 2019
UPDATED BATHYMETRY DATA PROVIDED BY ANCHOR QEA OCTOBER 2021
TXDOT RIGHT OF WAY FROM A BOUNDARY AND RIGHT-OF-WAY SURVEY OF


PORT OF HOUSTON AUTHORITY PROPERTY & HOUSTON FLEETING SERVICES, LLC PROPERTY ALONG INTERSTATE HIGHWAY 10 AT THE SAN JACINTO FLEET AREA, IN THE J. T. HARRELL SURVEY, A-330 HARRIS COUNTY, TEXAS, COBBFENDLEY, 2402-028-01, JUNE 28, 2024

NOTES:


1. TYPICAL EXCAVATION SEQUENCING ASSUMES BMP INSTALLATION AND SITE PREPARATION WILL BE COMPLETED IN YEAR 1, REMEDIATION OF THE NORTHWEST CORNER IN YEAR 2, AND BMP REMOVAL AND SITE RESTORATION WILL BE COMPLETED IN YEAR 7.

2. SEASONAL EXCAVATION AREAS, VOLUMES, AND SEQUENCING ARE APPROXIMATE AND SUBJECT TO CHANGE.


THIS DOCUMENT IS RELEASED FOR THE PURPOSE OF EPA REVIEW UNDER THE AUTHORITY OF CLARENCE R. HOEKSTRA, P.E. 147936 ON 11/25/2024. IT IS NOT TO BE USED FOR CONSTRUCTION, BIDDING, RECORDATION, CONVEYANCE OR SALES PURPOSES.

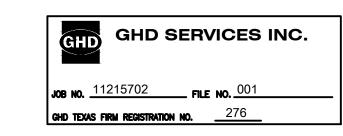

**100% EPA SUBMITTAL** 

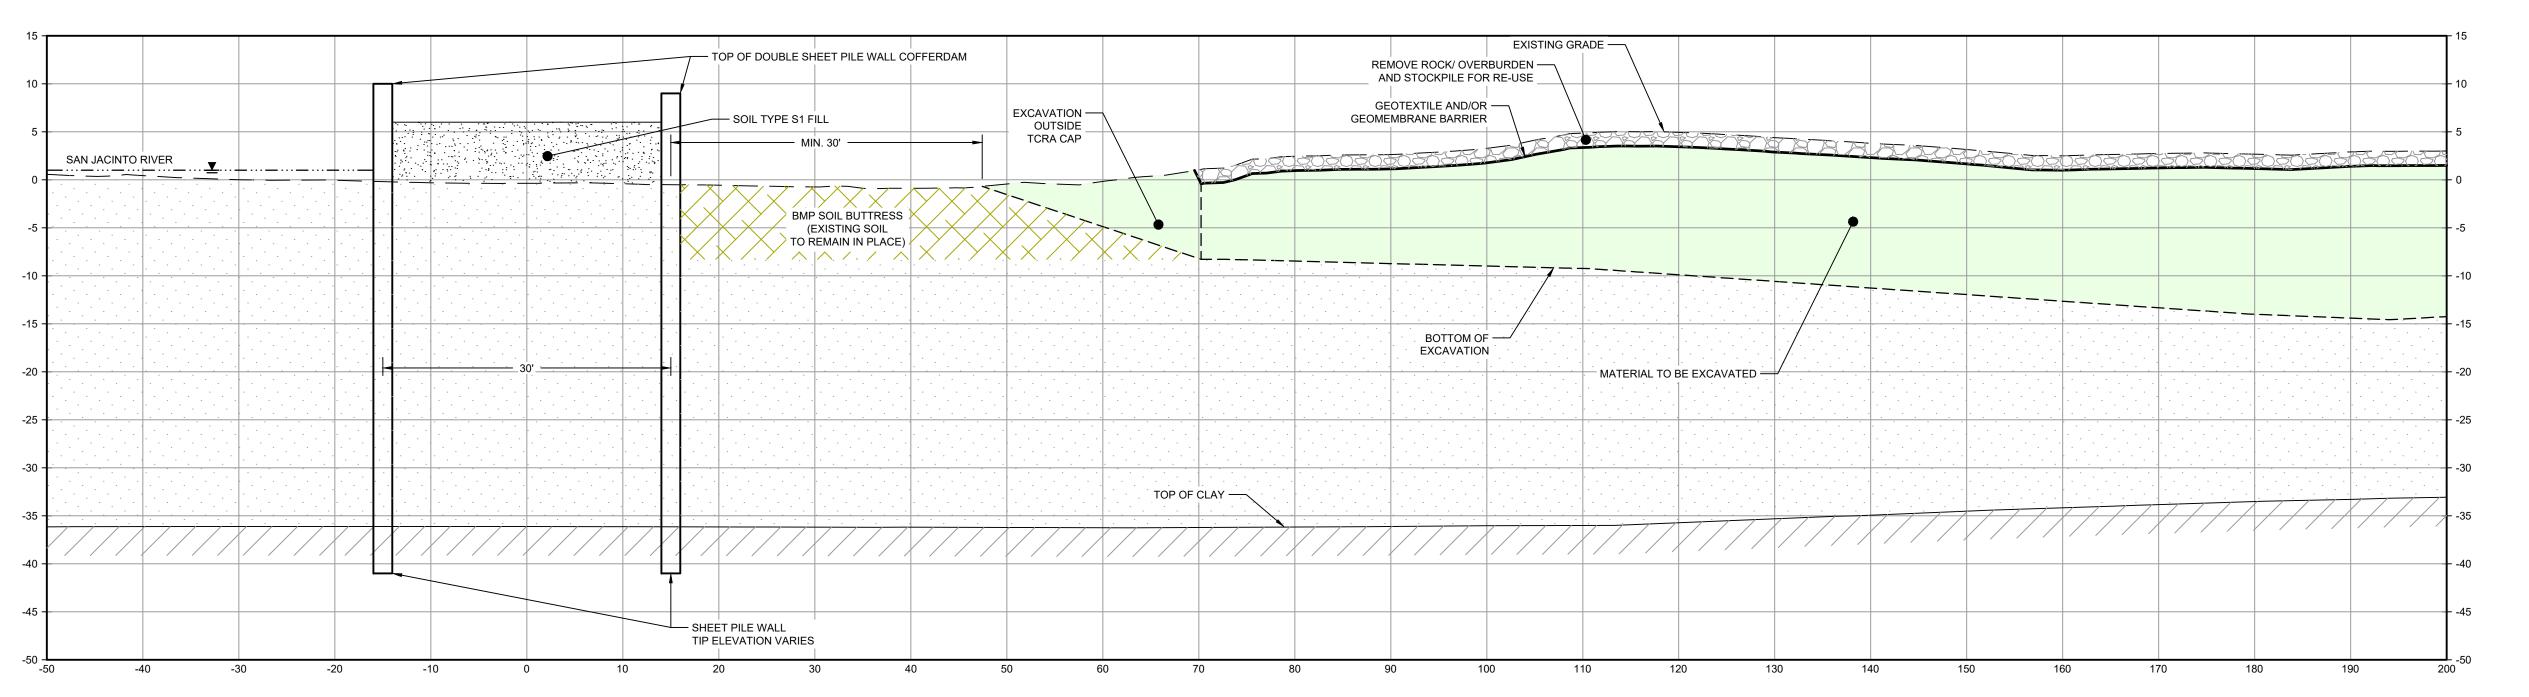

1. INSTALL PILE WALL COFFERDAM AROUND PERIMETER OF EXCAVATION AND DEWATER.

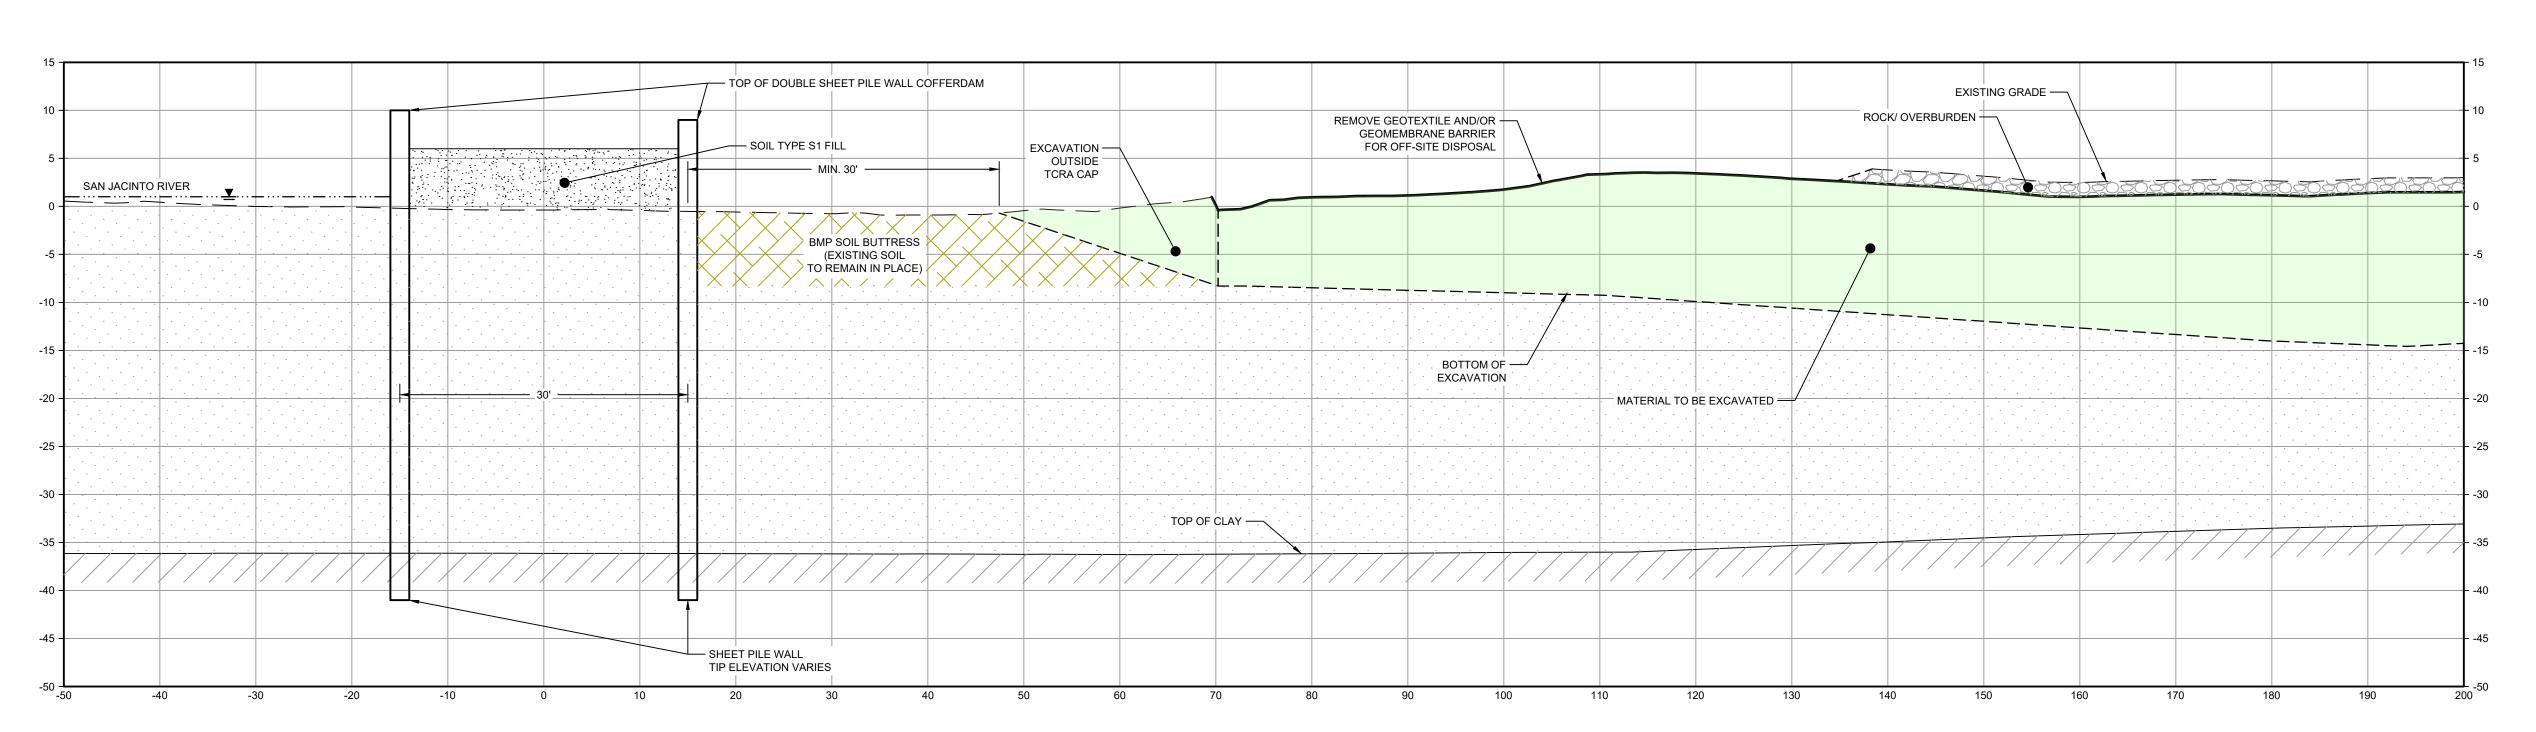


NOTES:

REMOVE ROCK LAYER TO BE STOCKPILED ON SITE. REUSED AS TEMPORARY COVER AT END OF SEASONAL EXCAVATION.

PHASE 2

- 1. BOTTOM OF EXCAVATION IS SUBJECT TO CHANGE. 2. SCOUR PROTECTION ON INTERIOR AND EXTERIOR SIDE OF COFFERDAM NOT SHOWN. SEE DRAWINGS C-28 TO C-44 FOR LIMITS OF RIPRAP.
- 3. FRP BARRIER WALL NOT SHOWN FOR CLARITY.

THIS DOCUMENT IS RELEASED FOR THE PURPOSE OF EPA REVIEW UNDER THE AUTHORITY OF CLARENCE R. HOEKSTRA, P.E. 147936 ON 11/25/2024. IT IS NOT TO BE USED FOR CONSTRUCTION, BIDDING, RECORDATION, CONVEYANCE OR SALES PURPOSES.

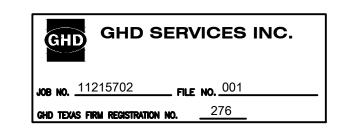

**100% EPA SUBMITTAL** 



2237 S Acadian Thruway Suite 701 Baton Rouge Louisiana 70808 USA **T** 225 292 9007



Reuse of Documents

This document and the ideas and designs incorporated herein, as an instrument of professional service, is the property of GHD and shall not be reused in whole or in part for any other project without GHD's written authorization. © 2024 GHD

<u>LEGEND</u>

MATERIAL TO BE EXCAVATED BMP SOIL BUTTRESS (EXISTING SOIL TO REMAIN IN PLACE)

**SAN JACINTO RIVER WASTE PITS** 

NORTHERN IMPOUNDMENT FINAL 100% REMEDIAL DESIGN HARRIS COUNTY, TEXAS

5	100% EPA SUBMITTAL	JC	CRH	11/25/
4	FOR CLIENT REVIEW	JC	CRH	11/21/
3	100% EPA SUBMITTAL	MW	CRH	07/17/
No.	Issue	Drawn	Approved	Da
Draw	n <b>JC</b>	Designer	RH	
	Drafting BS Check		LL	
	Project Coordinator <b>CM</b>		Nov 25, 2024	
This document shall not be used for construction unless signed and sealed for		Scale	AS SHOW	/N

Arch D

Project No. **11215702** 

construction. Original Size


> TYPICAL EXCAVATION **SEQUENCING** 1 OF 2

Sheet No.

C-20


Sheet **21** of **83** 

Bar is one inch on original size drawing

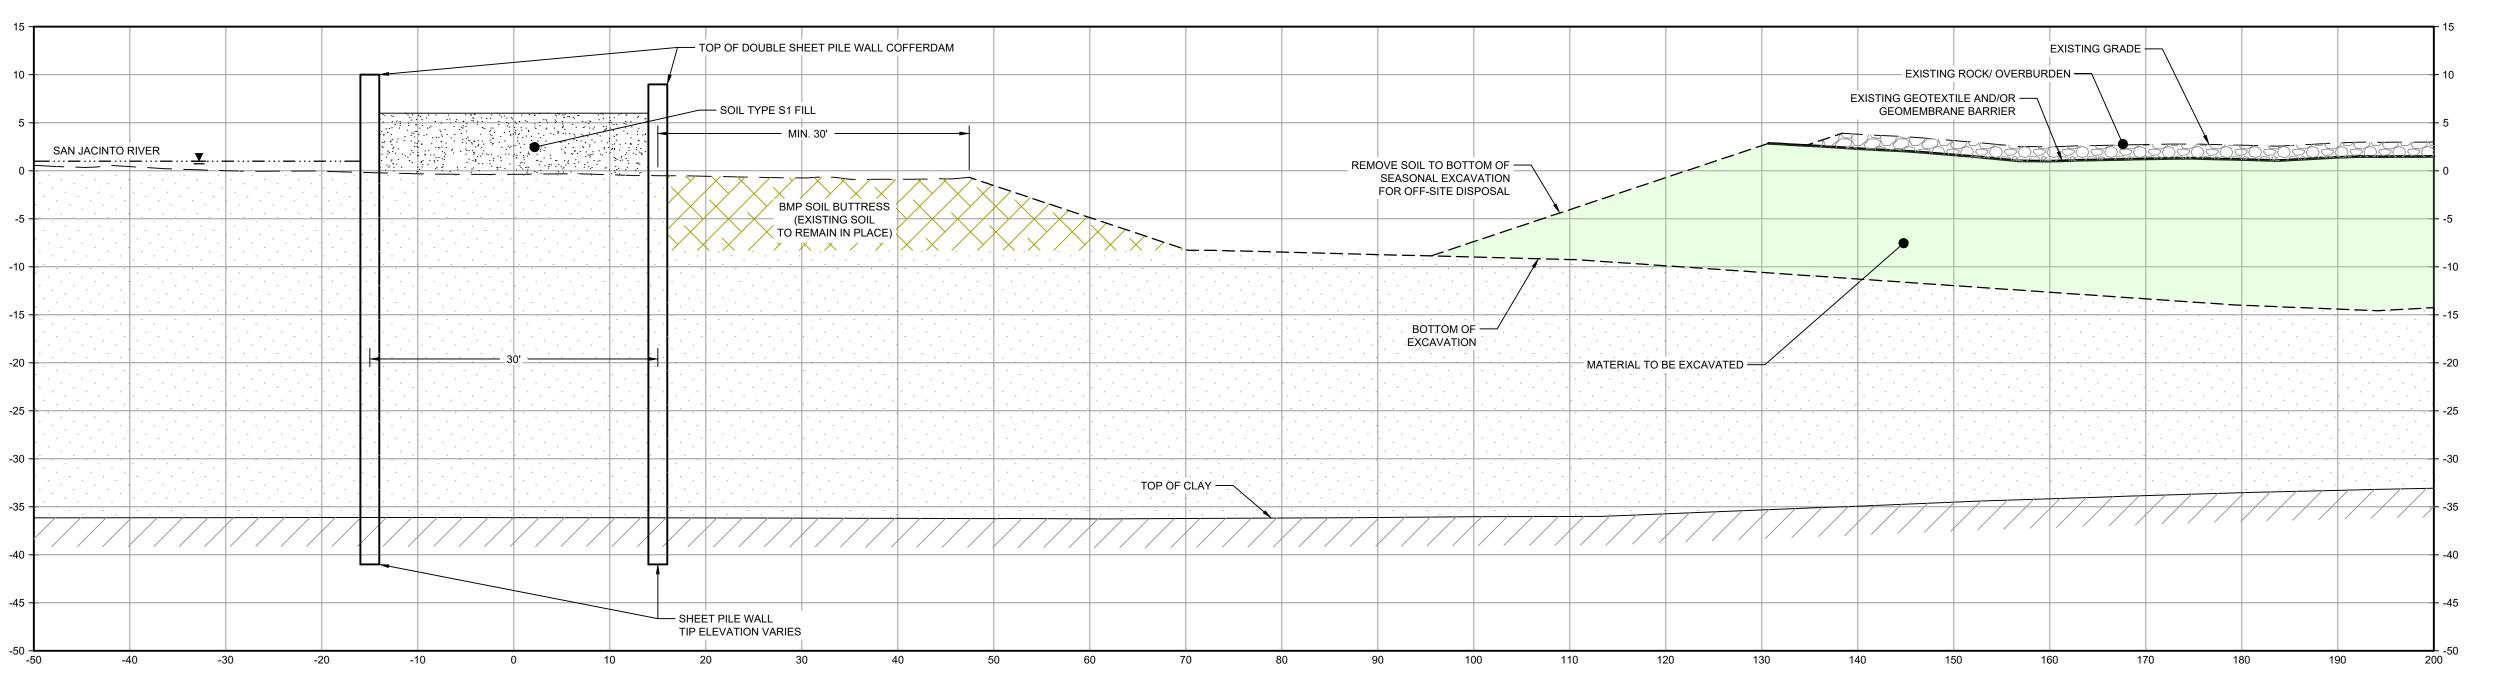

NOTES:


1. REMOVE GEOMEMBRANE, EXCAVATE MATERIAL AND DISPOSE OF OFFSITE.

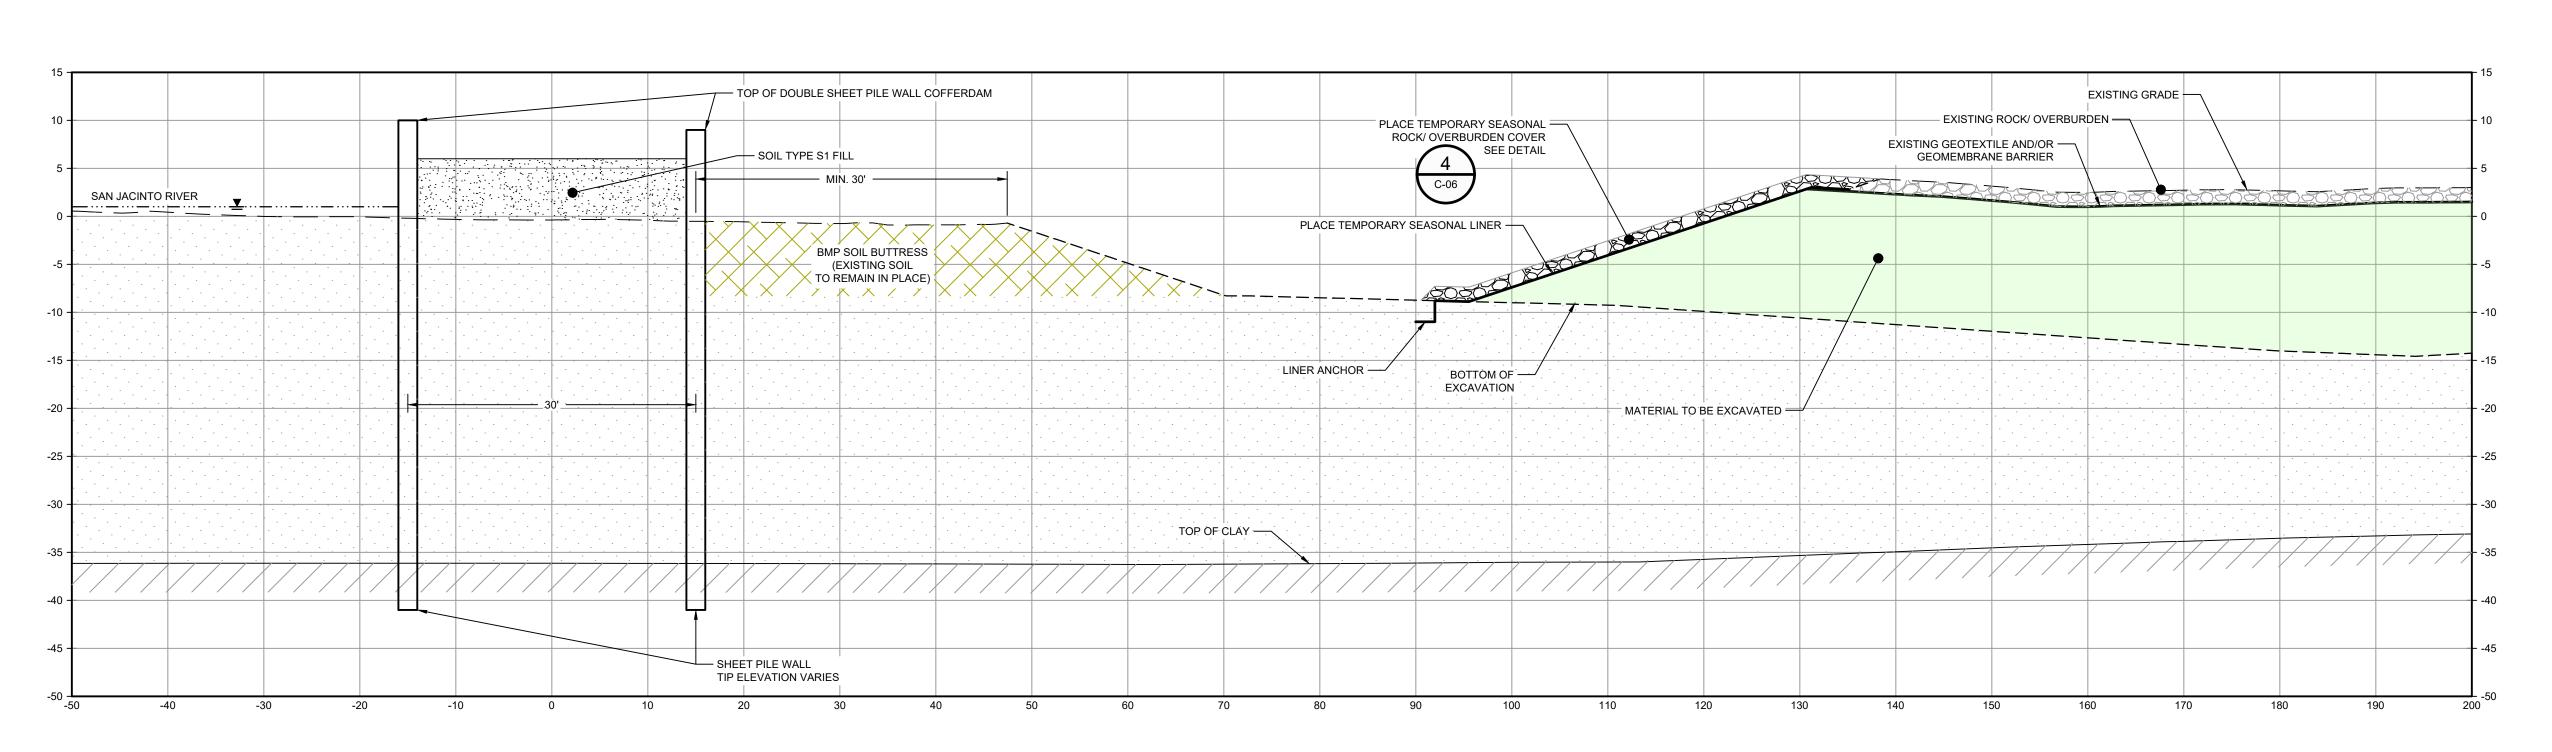

PHASE 4

- 1. BOTTOM OF EXCAVATION IS SUBJECT TO CHANGE. 2. SCOUR PROTECTION ON INTERIOR AND EXTERIOR SIDE OF COFFERDAM NOT SHOWN. SEE DRAWINGS C-28 TO C-44 FOR LIMITS OF RIPRAP.
- 3. FRP BARRIER WALL NOT SHOWN FOR CLARITY.

THIS DOCUMENT IS RELEASED FOR THE PURPOSE OF EPA REVIEW UNDER THE AUTHORITY OF CLARENCE R. HOEKSTRA, P.E. 147936 ON 11/25/2024. IT IS NOT TO BE USED FOR CONSTRUCTION, BIDDING, RECORDATION, CONVEYANCE OR SALES PURPOSES.

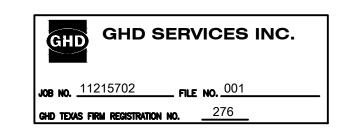

**100% EPA SUBMITTAL** 



2237 S Acadian Thruway Suite 701 Baton Rouge Louisiana 70808 USA **T** 225 292 9007



Reuse of Documents

This document and the ideas and designs incorporated herein, as an instrument of professional service, is the property of GHD and shall not be reused in whole or in part for any other project without GHD's written authorization. © 2024 GHD

<u>LEGEND</u>

MATERIAL TO BE EXCAVATED BMP SOIL BUTTRESS (EXISTING SOIL TO REMAIN IN PLACE)

SAN JACINTO RIVER **WASTE PITS** 

NORTHERN IMPOUNDMENT FINAL 100% REMEDIAL DESIGN HARRIS COUNTY, TEXAS

ı					
ı	5	100% EPA SUBMITTAL	JC	CRH	11/25/20
ı	4	FOR CLIENT REVIEW	JC	CRH	11/21/20
ı	3	100% EPA SUBMITTAL	MW	CRH	07/17/20
ı	No.	Issue	Drawn	Approved	Date
ı	Drawn <b>JC</b>		Designer	RH	
ı	Drafting BS Check		Design Check	LL	
	Project Coordinator CM		Date	Nov 25, 2024	
	This document shall not be used for construction unless signed and sealed for construction.		Scale	AS SHOW	/N

Arch D

original size drawing

Bar is one inch on

Project No. **11215702** 

Original Size

TYPICAL EXCAVATION **SEQUENCING** 2 OF 2


Sheet No.

C-21


Sheet **22** of **83** 

Plot Date: 25 November 2024 - 3:16 PM



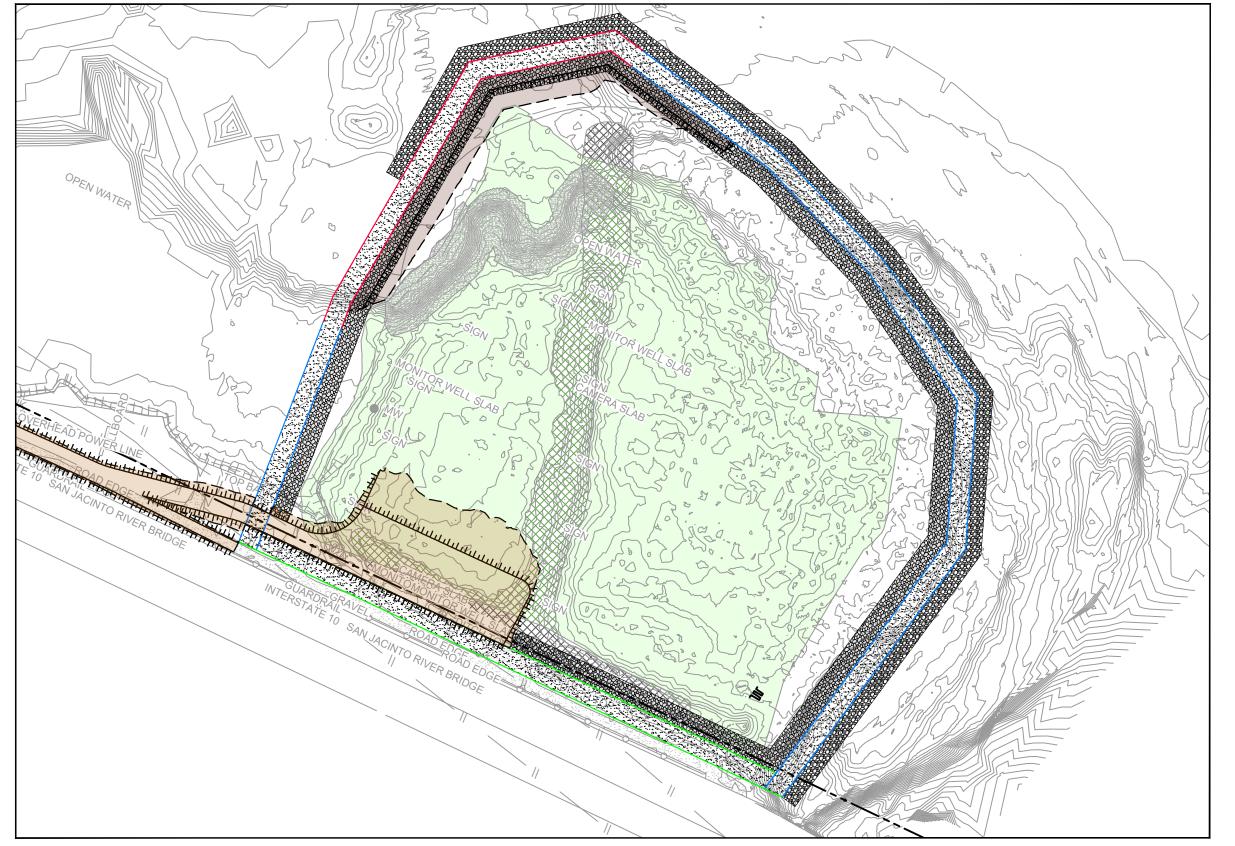



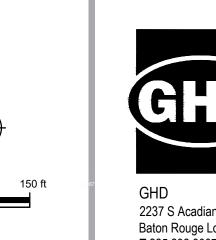





Reuse of Documents

This document and the ideas and designs incorporated herein, as an instrument of professional service, is the property of GHD and shall not be reused in whole or in part for any other project without GHD's written authorization. © 2024 GHD

— – – — TxDOT RIGHT OF WAY TCRA CAP PERIMETER EXISTING CONTOUR INTERVAL FENCELINE SHORELINE TOP OF BANK \_ \_ \_ \_ TOE OF SLOPE OVERHEAD ELECTRICAL

**GUARDRAIL** PIPELINE ■ SJSB002 BORING LOCATION MONITORING WELL POWER POLE LIGHT POLE MATERIAL TO BE EXCAVATED

EXISTING BERM TO BE EXCAVATED FOR POTENTIAL TESTING AND REUSE

EXISTING BERM TO REMAIN CONCRETE GRAVEL AZ26-700 PILE AZ36-700 PILE AZ42-700 PILE PHASE OF EXCAVATION PLANNED IMPROVEMENTS FOR 

NORTHERN IMPOUNDMENT ACCESS RAISED BENCH EXTERIOR SCOUR PROTECTION INTERIOR SCOUR PROTECTION

## **SAN JACINTO RIVER WASTE PITS**

NORTHERN IMPOUNDMENT FINAL 100% REMEDIAL DESIGN HARRIS COUNTY, TEXAS

6	100% EPA SUBMITTAL	JC	CRH	11/25/2
5	FOR CLIENT REVIEW	JC	CRH	11/21/2
4	100% EPA SUBMITTAL	MW	CRH	07/17/2
No.	Issue	Drawn	Approved	Dat
Drawn <b>JC</b>		Designer	RH	
Drafting BS Check		Design Check	LL	
Project CM Coordinator		Date	Nov 25, 20	)24
This document shall not be used for construction unless signed and sealed for construction.		Scale	1" = 150'	
Original Size			lor io ono in	ah an

Arch D

Bar is one inch on original size drawing

Project No. **11215702** 


CONSTRUCTION **SEQUENCING** 1 OF 2

Sheet No.

**C-23** 

Sheet **24** of **83** 

YEAR 1 - BMP INSTALLATION AND SITE PREPARATION

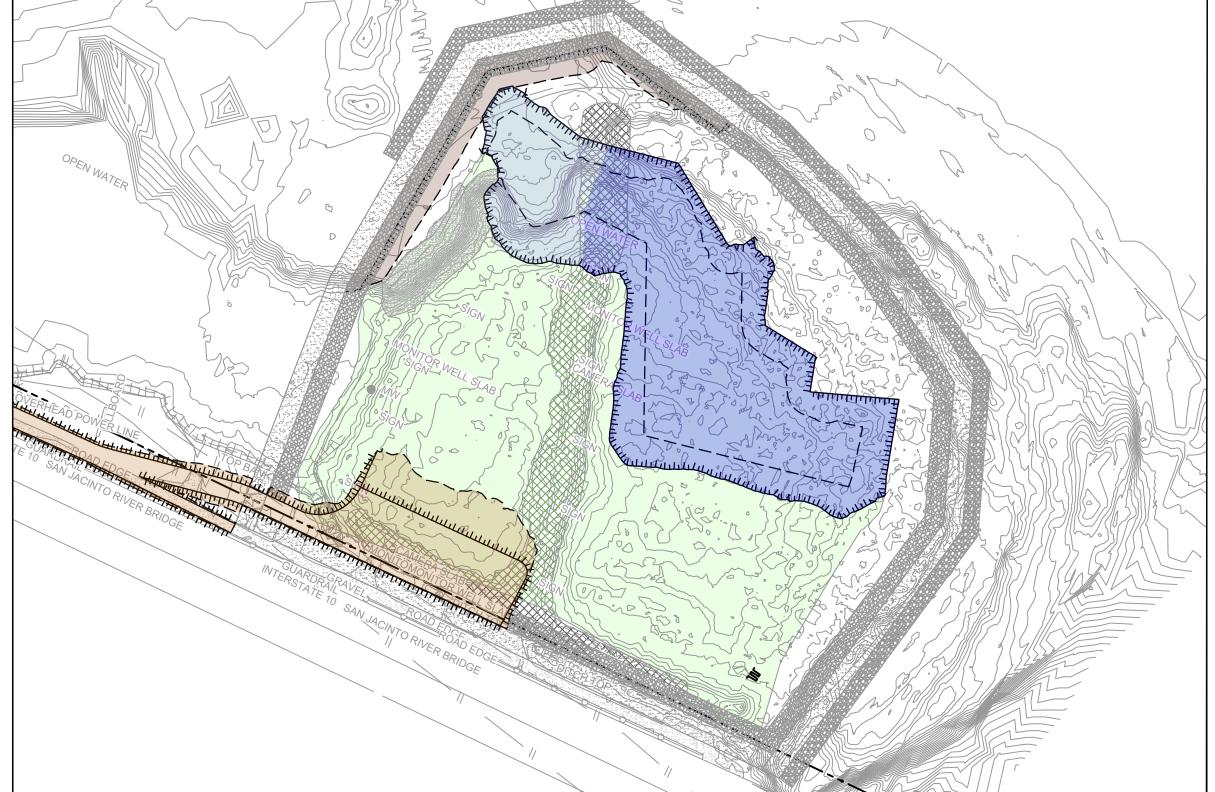

YEAR 4 - EXCAVATION SEASON 3

SOURCE:

TOPOGRAPHIC, HYDROGRAPHIC, & MAGNETOMETER SURVEY OF SAN JACINTO RIVER WASTE PITS, HARRIS COUNTY, TEXAS, MORRISON SURVEYING INC., 190608, JULY 8, 2019 TO AUGUST 2, 2019 UPDATED BATHYMETRY DATA PROVIDED BY ANCHOR QEA OCTOBER 2021
TXDOT RIGHT OF WAY FROM A BOUNDARY AND RIGHT-OF-WAY
SURVEY OF PORT OF HOUSTON AUTHORITY PROPERTY & HOUSTON
FLEETING SERVICES, LLC PROPERTY ALONG INTERSTATE HIGHWAY
10 AT THE SAN JACINTO FLEET AREA, IN THE J. T. HARRELL SURVEY,
A-330 HARRIS COUNTY, TEXAS, COBBFENDLEY, 2402-028-01, JUNE 28,

SEASONAL EXCAVATION AREAS, VOLUMES, AND SEQUENCING ARE APPROXIMATE AND SUBJECT TO CHANGE.

**100% EPA SUBMITTAL** 


THIS DOCUMENT IS RELEASED FOR THE PURPOSE OF

EPA REVIEW UNDER THE AUTHORITY OF CLARENCE R. HOEKSTRA, P.E. 147936 ON 11/25/2024. IT IS NOT TO BE USED FOR CONSTRUCTION, BIDDING, RECORDATION,

CONVEYANCE OR SALES PURPOSES.

YEAR 3 - EXCAVATION SEASON 2



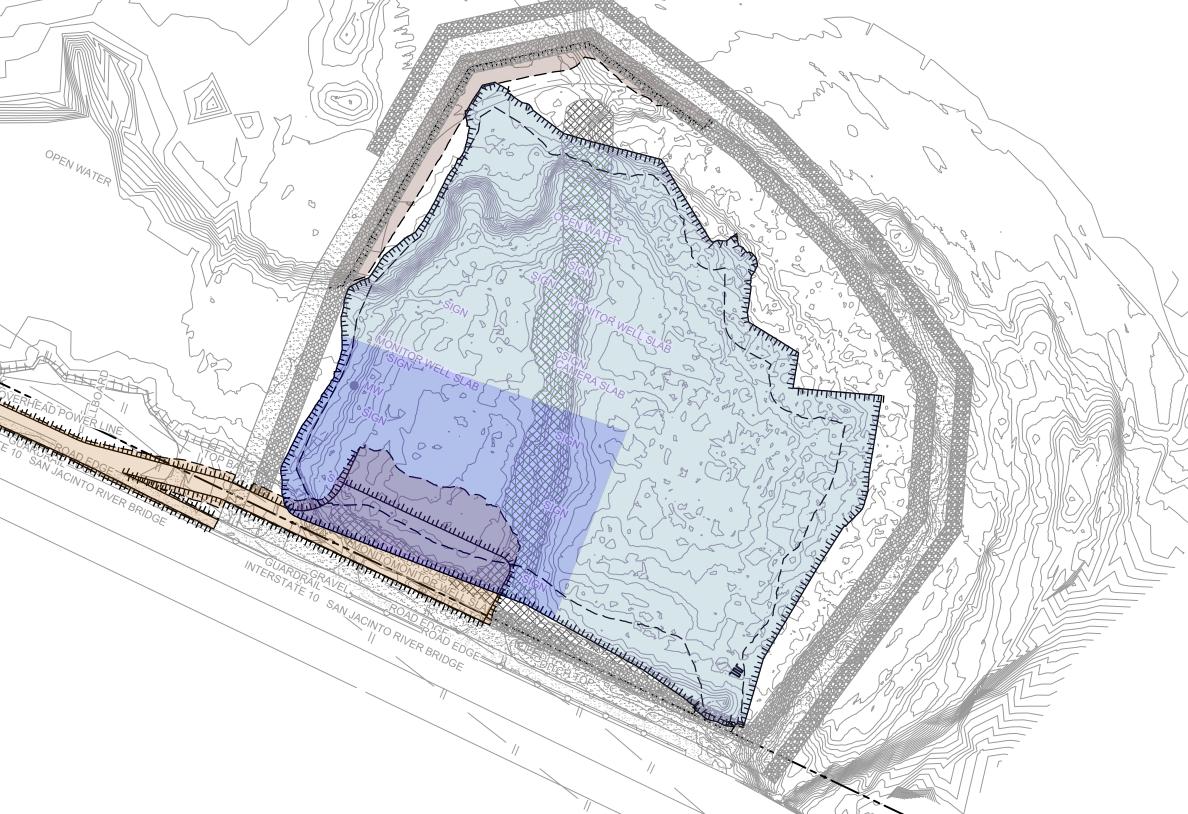



THIS DOCUMENT IS RELEASED FOR THE PURPOSE OF

EPA REVIEW UNDER THE AUTHORITY OF CLARENCE R. HOEKSTRA, P.E. 147936 ON 11/25/2024. IT IS NOT TO BE

USED FOR CONSTRUCTION, BIDDING, RECORDATION,

GHD SERVICES INC.

100% EPA SUBMITTAL

CONVEYANCE OR SALES PURPOSES.



2237 S Acadian Thruway Suite 701 Baton Rouge Louisiana 70808 USA **T** 225 292 9007



Reuse of Documents

This document and the ideas and designs incorporated herein, as an instrument of professional service, is the property of GHD and shall not be reused in whole or in part for any other project without GHD's written authorization. © 2024 GHD

— – – — TxDOT RIGHT OF WAY TCRA CAP PERIMETER EXISTING CONTOUR INTERVAL FENCELINE SHORELINE TOP OF BANK \_\_ \_ \_ \_ TOE OF SLOPE OVERHEAD ELECTRICAL **GUARDRAIL** PIPELINE ■ SJSB002 BORING LOCATION MW MONITORING WELL POWER POLE LIGHT POLE MATERIAL TO BE EXCAVATED EXISTING BERM TO BE EXCAVATED

CONCRETE GRAVEL AZ26-700 PILE AZ36-700 PILE AZ42-700 PILE PHASE OF EXCAVATION PLANNED IMPROVEMENTS FOR NORTHERN IMPOUNDMENT ACCESS RESTORED AREA INCLUDING TOPSOIL PLACEMENT

FOR POTENTIAL TESTING AND REUSE EXISTING BERM TO REMAIN

AND SEEDING TO RIVER LEVEL RAISED BENCH EXTERIOR SCOUR PROTECTION INTERIOR SCOUR PROTECTION

**SAN JACINTO RIVER WASTE PITS** 

NORTHERN IMPOUNDMENT FINAL 100% REMEDIAL DESIGN HARRIS COUNTY, TEXAS

6	100% EPA SUBMITTAL	JC	CRH	11/25/202	
5	FOR CLIENT REVIEW	JC	CRH	11/21/202	
4	100% EPA SUBMITTAL	MW	MW CRH		
No.	Issue	Drawn	Approved	Date	
Drawn <b>JC</b>		Designer RH			
)rafti Chec	· B5	Design Check	LL		
Project CM Coordinator		Date	Nov 25, 2024		
his document shall not be used for onstruction unless signed and sealed for onstruction.		Scale 1" = 150'			
Original Size		В	ar is one in	ch on	

Project No. **11215702** 

Arch D

CONSTRUCTION

**SEQUENCING** 2 OF 2

original size drawing

Sheet **25** of **83** 

Sheet No.

C-24

YEAR 6 - EXCAVATION SEASON 5

TOPOGRAPHIC, HYDROGRAPHIC, & MAGNETOMETER SURVEY OF SAN JACINTO RIVER WASTE PITS, HARRIS COUNTY, TEXAS, MORRISON SURVEYING INC., 190608, JULY 8, 2019 TO AUGUST 2, 2019 UPDATED BATHYMETRY DATA PROVIDED BY ANCHOR QEA OCTOBER


1. SEASONAL EXCAVATION AREAS, VOLUMES, AND SEQUENCING


SOURCE:


2021 TxDOT RIGHT OF WAY FROM A BOUNDARY AND RIGHT-OF-WAY SURVEY OF PORT OF HOUSTON AUTHORITY PROPERTY & HOUSTON FLEETING SERVICES, LLC PROPERTY ALONG INTERSTATE HIGHWAY 10 AT THE SAN JACINTO FLEET AREA, IN THE J. T. HARRELL SURVEY, A-330 HARRIS COUNTY, TEXAS, COBBFENDLEY, 2402-028-01, JUNE 28,

ARE APPROXIMATE AND SUBJECT TO CHANGE.

YEAR 7 - BMP REMOVAL AND SITE RESTORATION

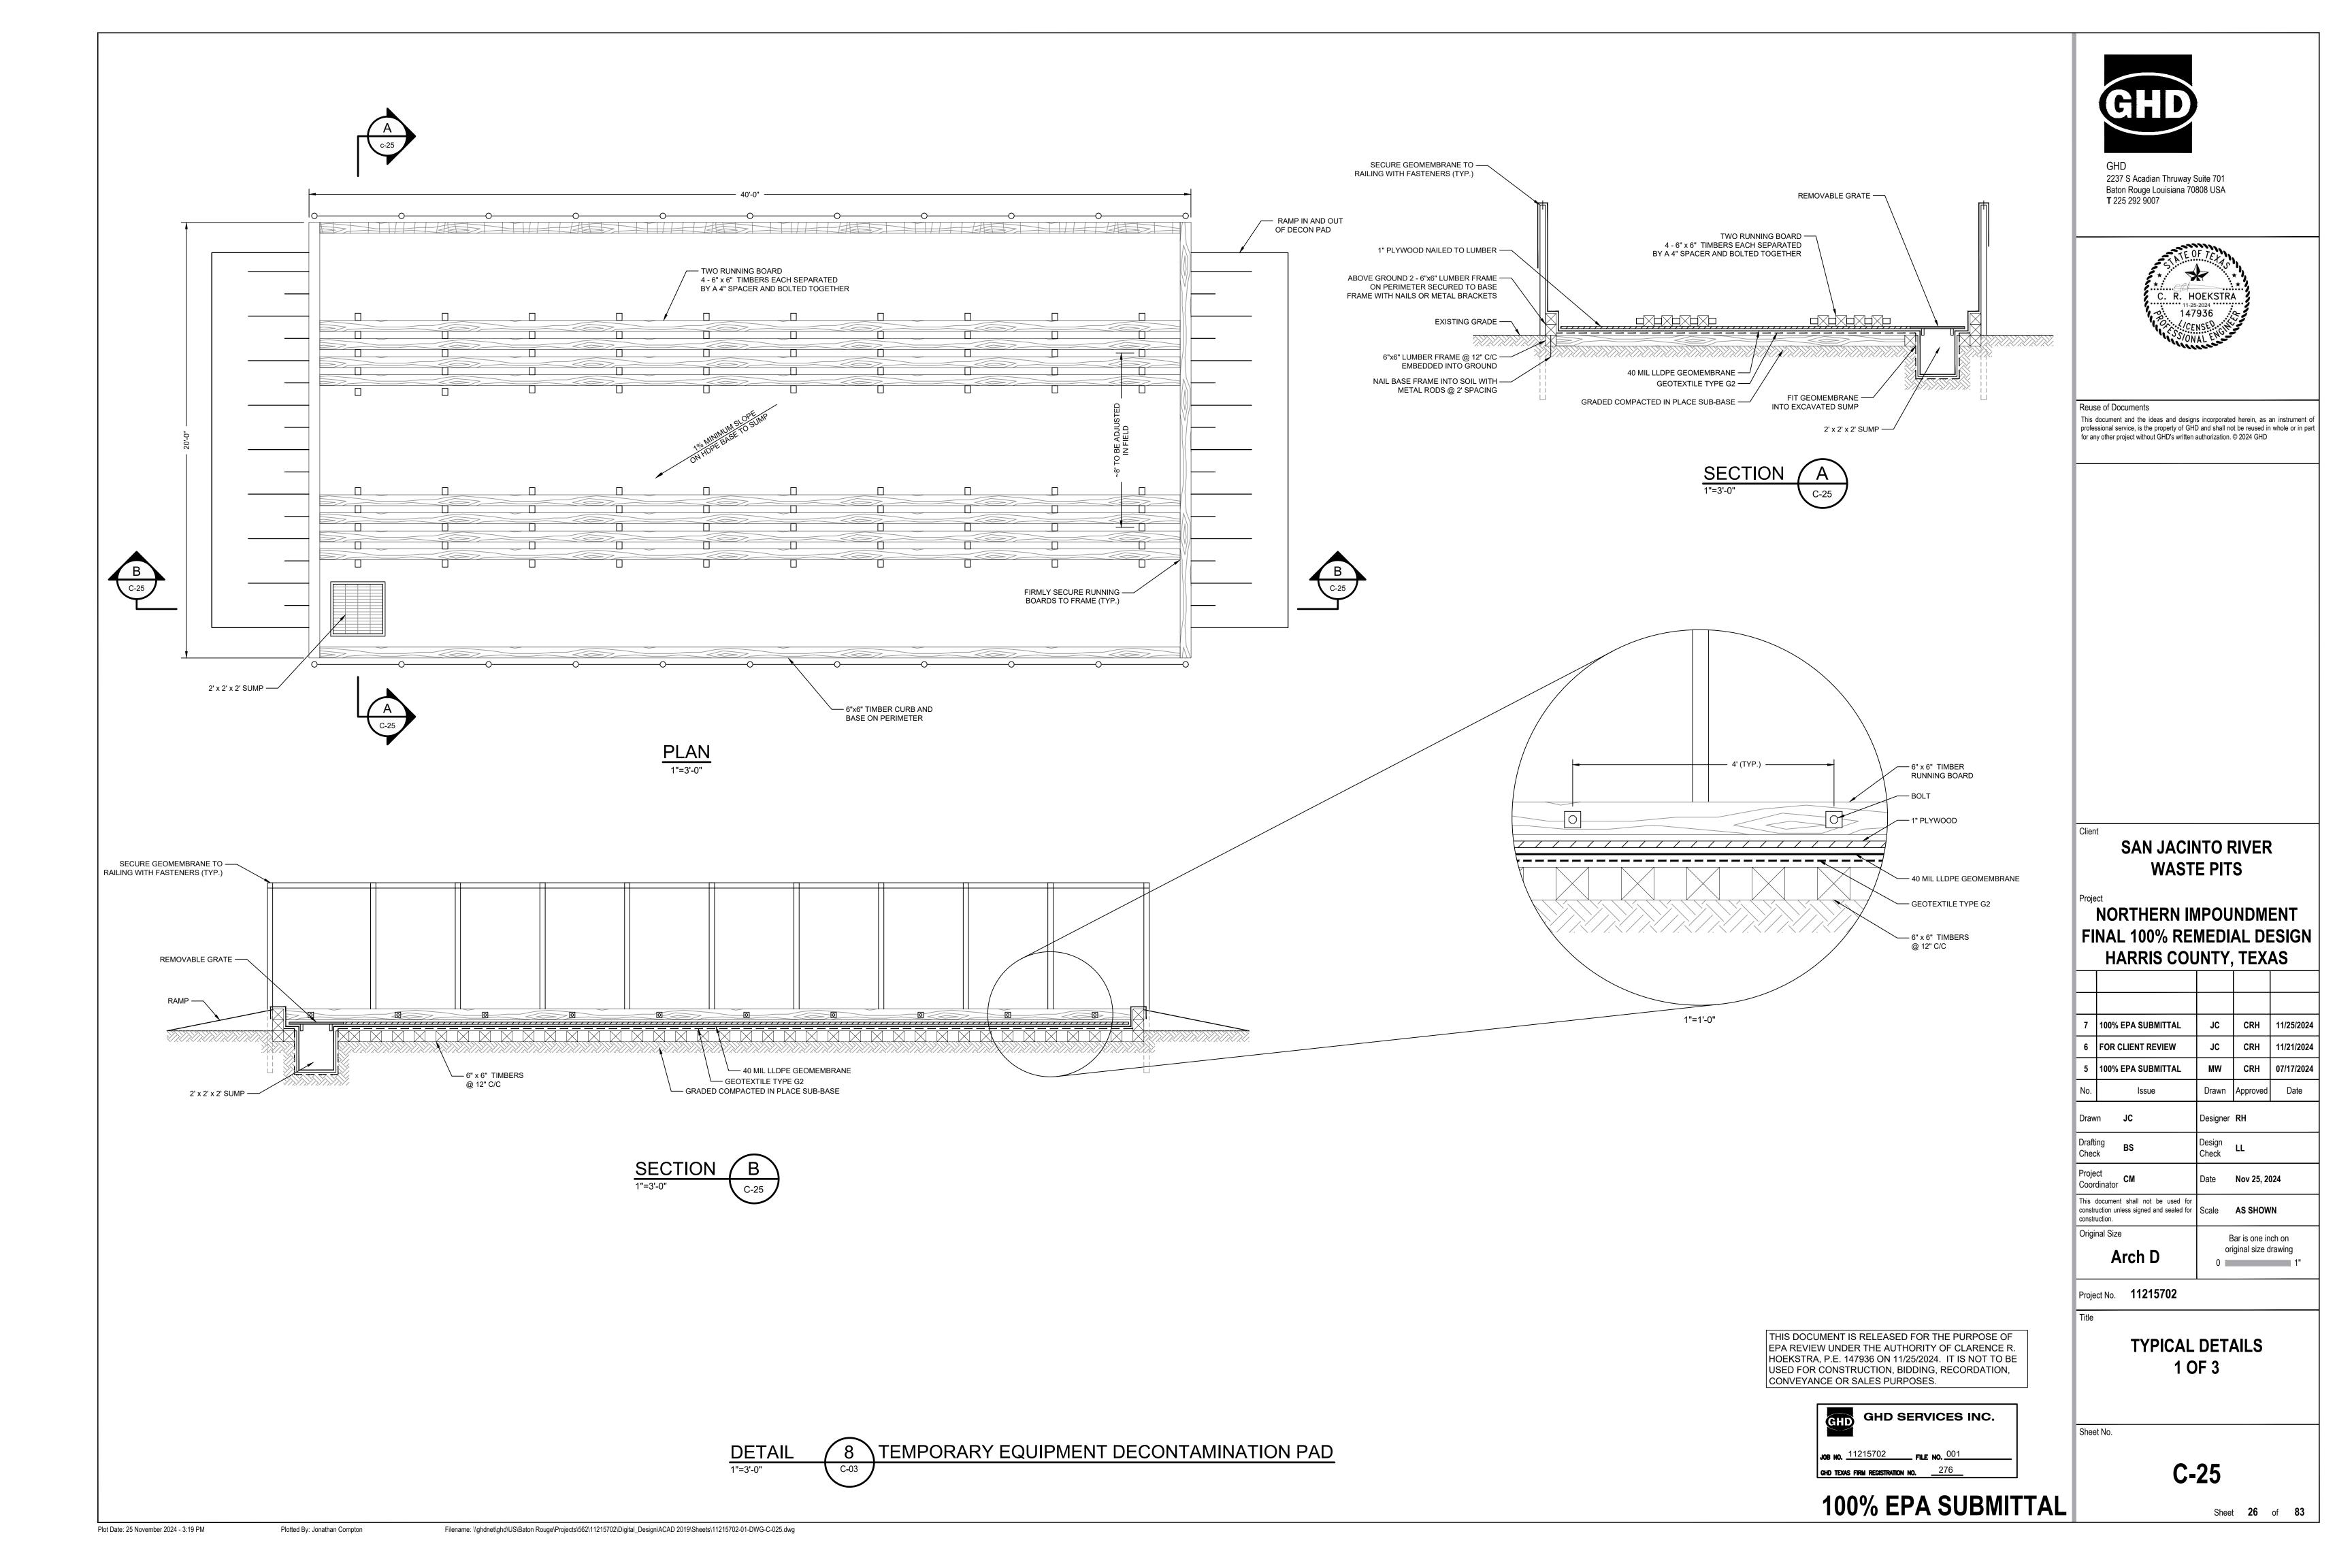

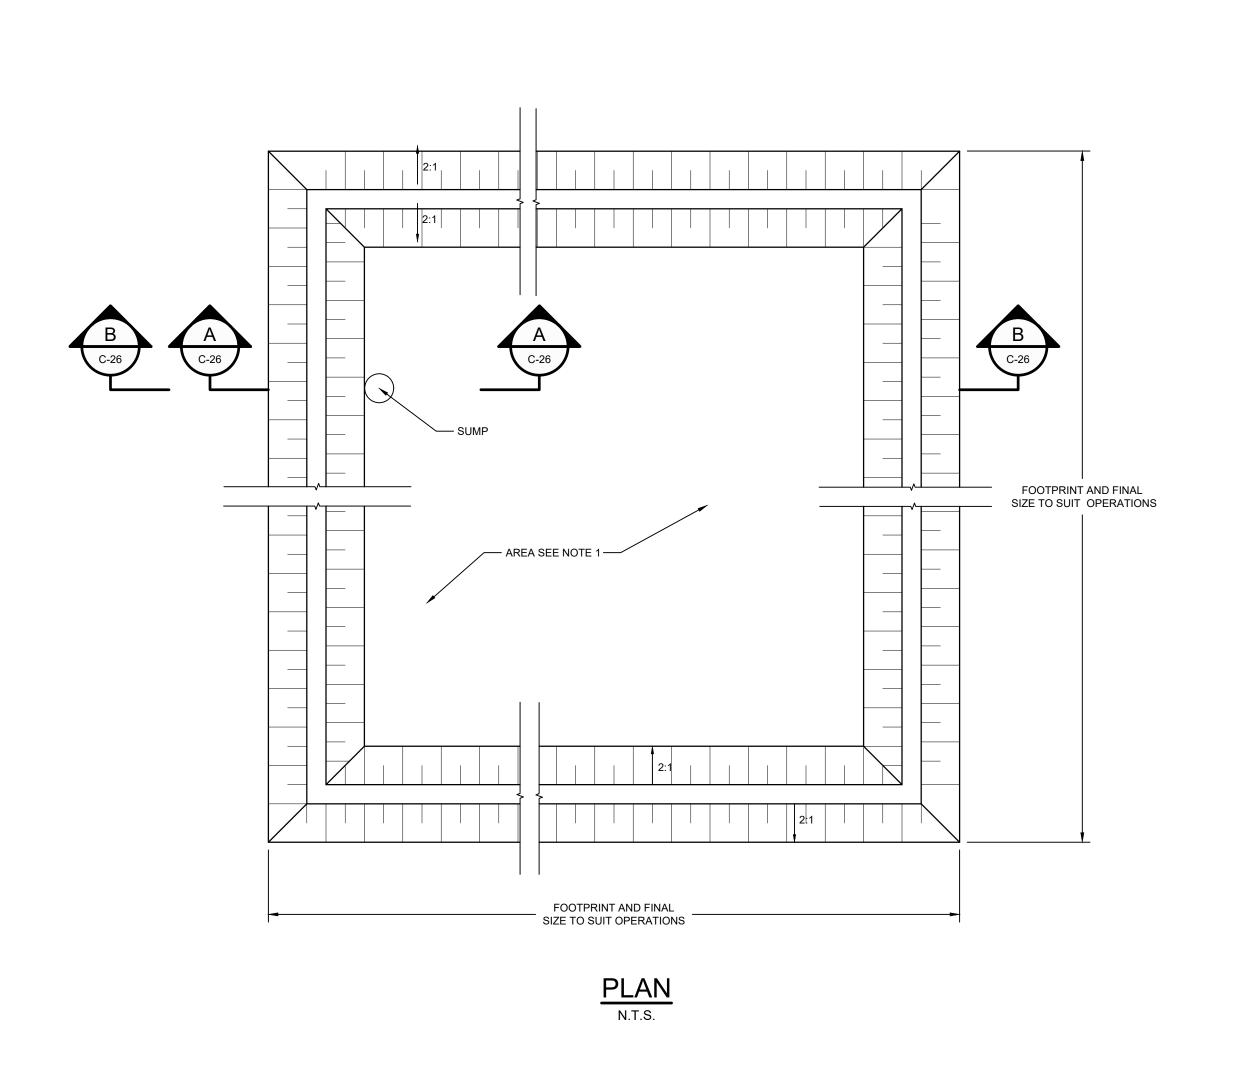


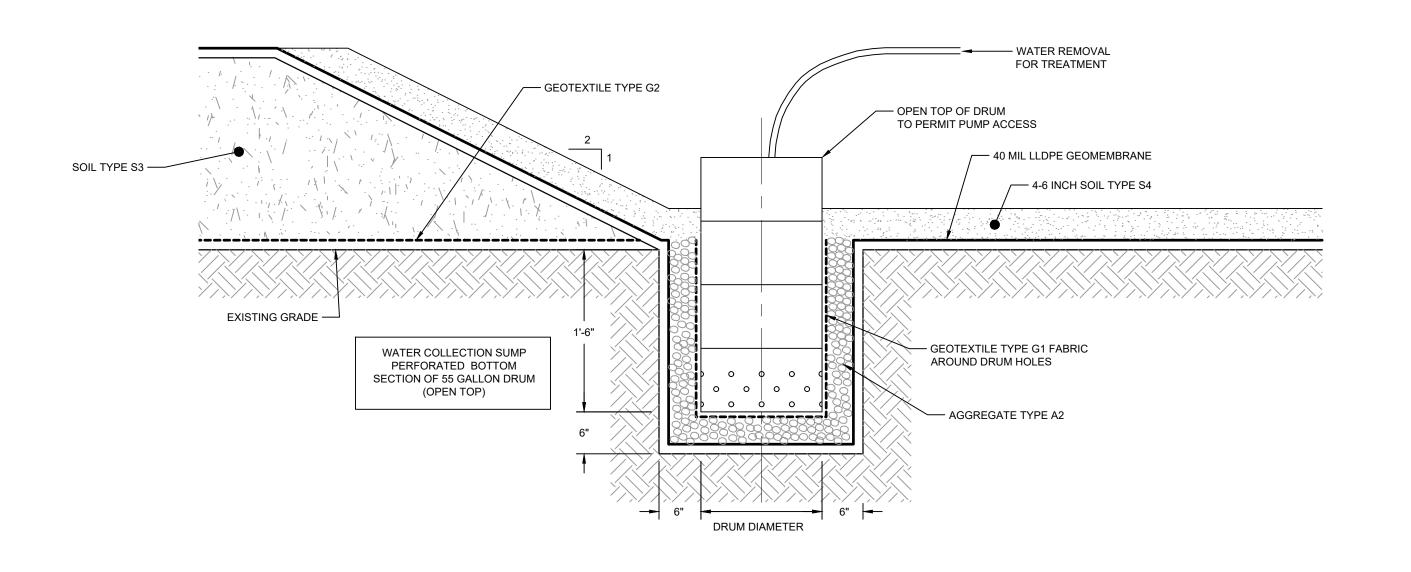

SECTION A SUMP

NOTES:

1. TYPICAL DETAILS SHOWN AT DEWATERING AND SOLIDIFICATION AREA MAY BE REVISED BY THE CONTRACTOR. CONTRACTOR'S REVISED DETAILS SHALL BE SUBMITTED FOR REVIEW PRIOR TO CONSTRUCTION.

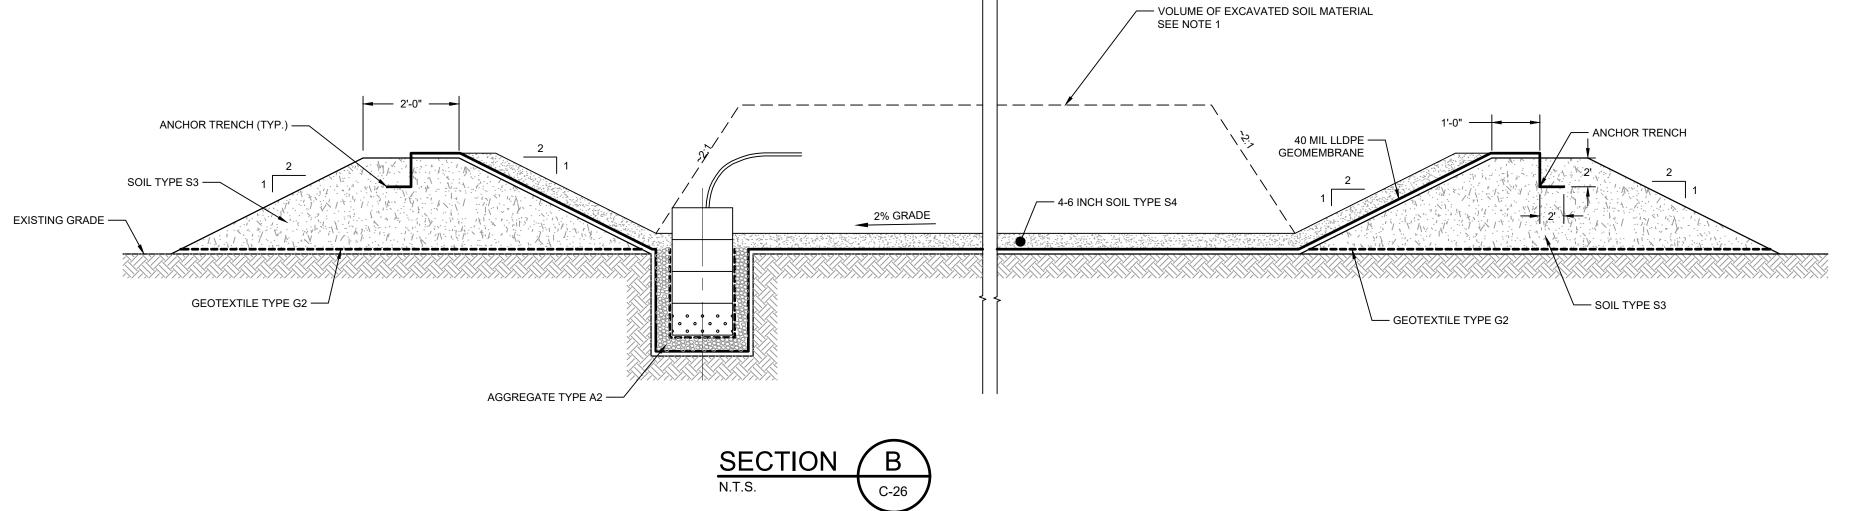

DETAIL 9 TEMPORARY DEWATERING FACILITY

N.T.S. C-03

THIS DOCUMENT IS RELEASED FOR THE PURPOSE OF EPA REVIEW UNDER THE AUTHORITY OF CLARENCE R. HOEKSTRA, P.E. 147936 ON 11/25/2024. IT IS NOT TO BE USED FOR CONSTRUCTION, BIDDING, RECORDATION, CONVEYANCE OR SALES PURPOSES.



100% EPA SUBMITTAL



GHD 2237 S Acadian Thruway Suite 701 Baton Rouge Louisiana 70808 USA **T** 225 292 9007



Reuse of Documents

This document and the ideas and designs incorporated herein, as an instrument of professional service, is the property of GHD and shall not be reused in whole or in part for any other project without GHD's written authorization. © 2024 GHD

SAN JACINTO RIVER
WASTE PITS

NORTHERN IMPOUNDMENT FINAL 100% REMEDIAL DESIGN HARRIS COUNTY, TEXAS

7	100% EPA SUBMITTAL	JC	CRH	11/25/2024
6	FOR CLIENT REVIEW	JC	CRH	11/21/2024
5	100% EPA SUBMITTAL	MW	CRH	07/17/2024
No.	Issue	Drawn	Approved	Date
Draw	Drawn <b>JC</b>		RH	
Drafti Chec	· 65	Design Check	LL	
Project CM Coordinator		Date	Nov 25, 20	)24
This document shall not be used for construction unless signed and sealed for construction.		Scale	N.T.S.	
Original Size  Arch D		Bar is one inch on original size drawing		
	AICHD	0 🔳		1"

Project No. **11215702** 


Title

TYPICAL DETAILS 2 OF 3

Sheet No.

C-26

Sheet **27** of **83** 

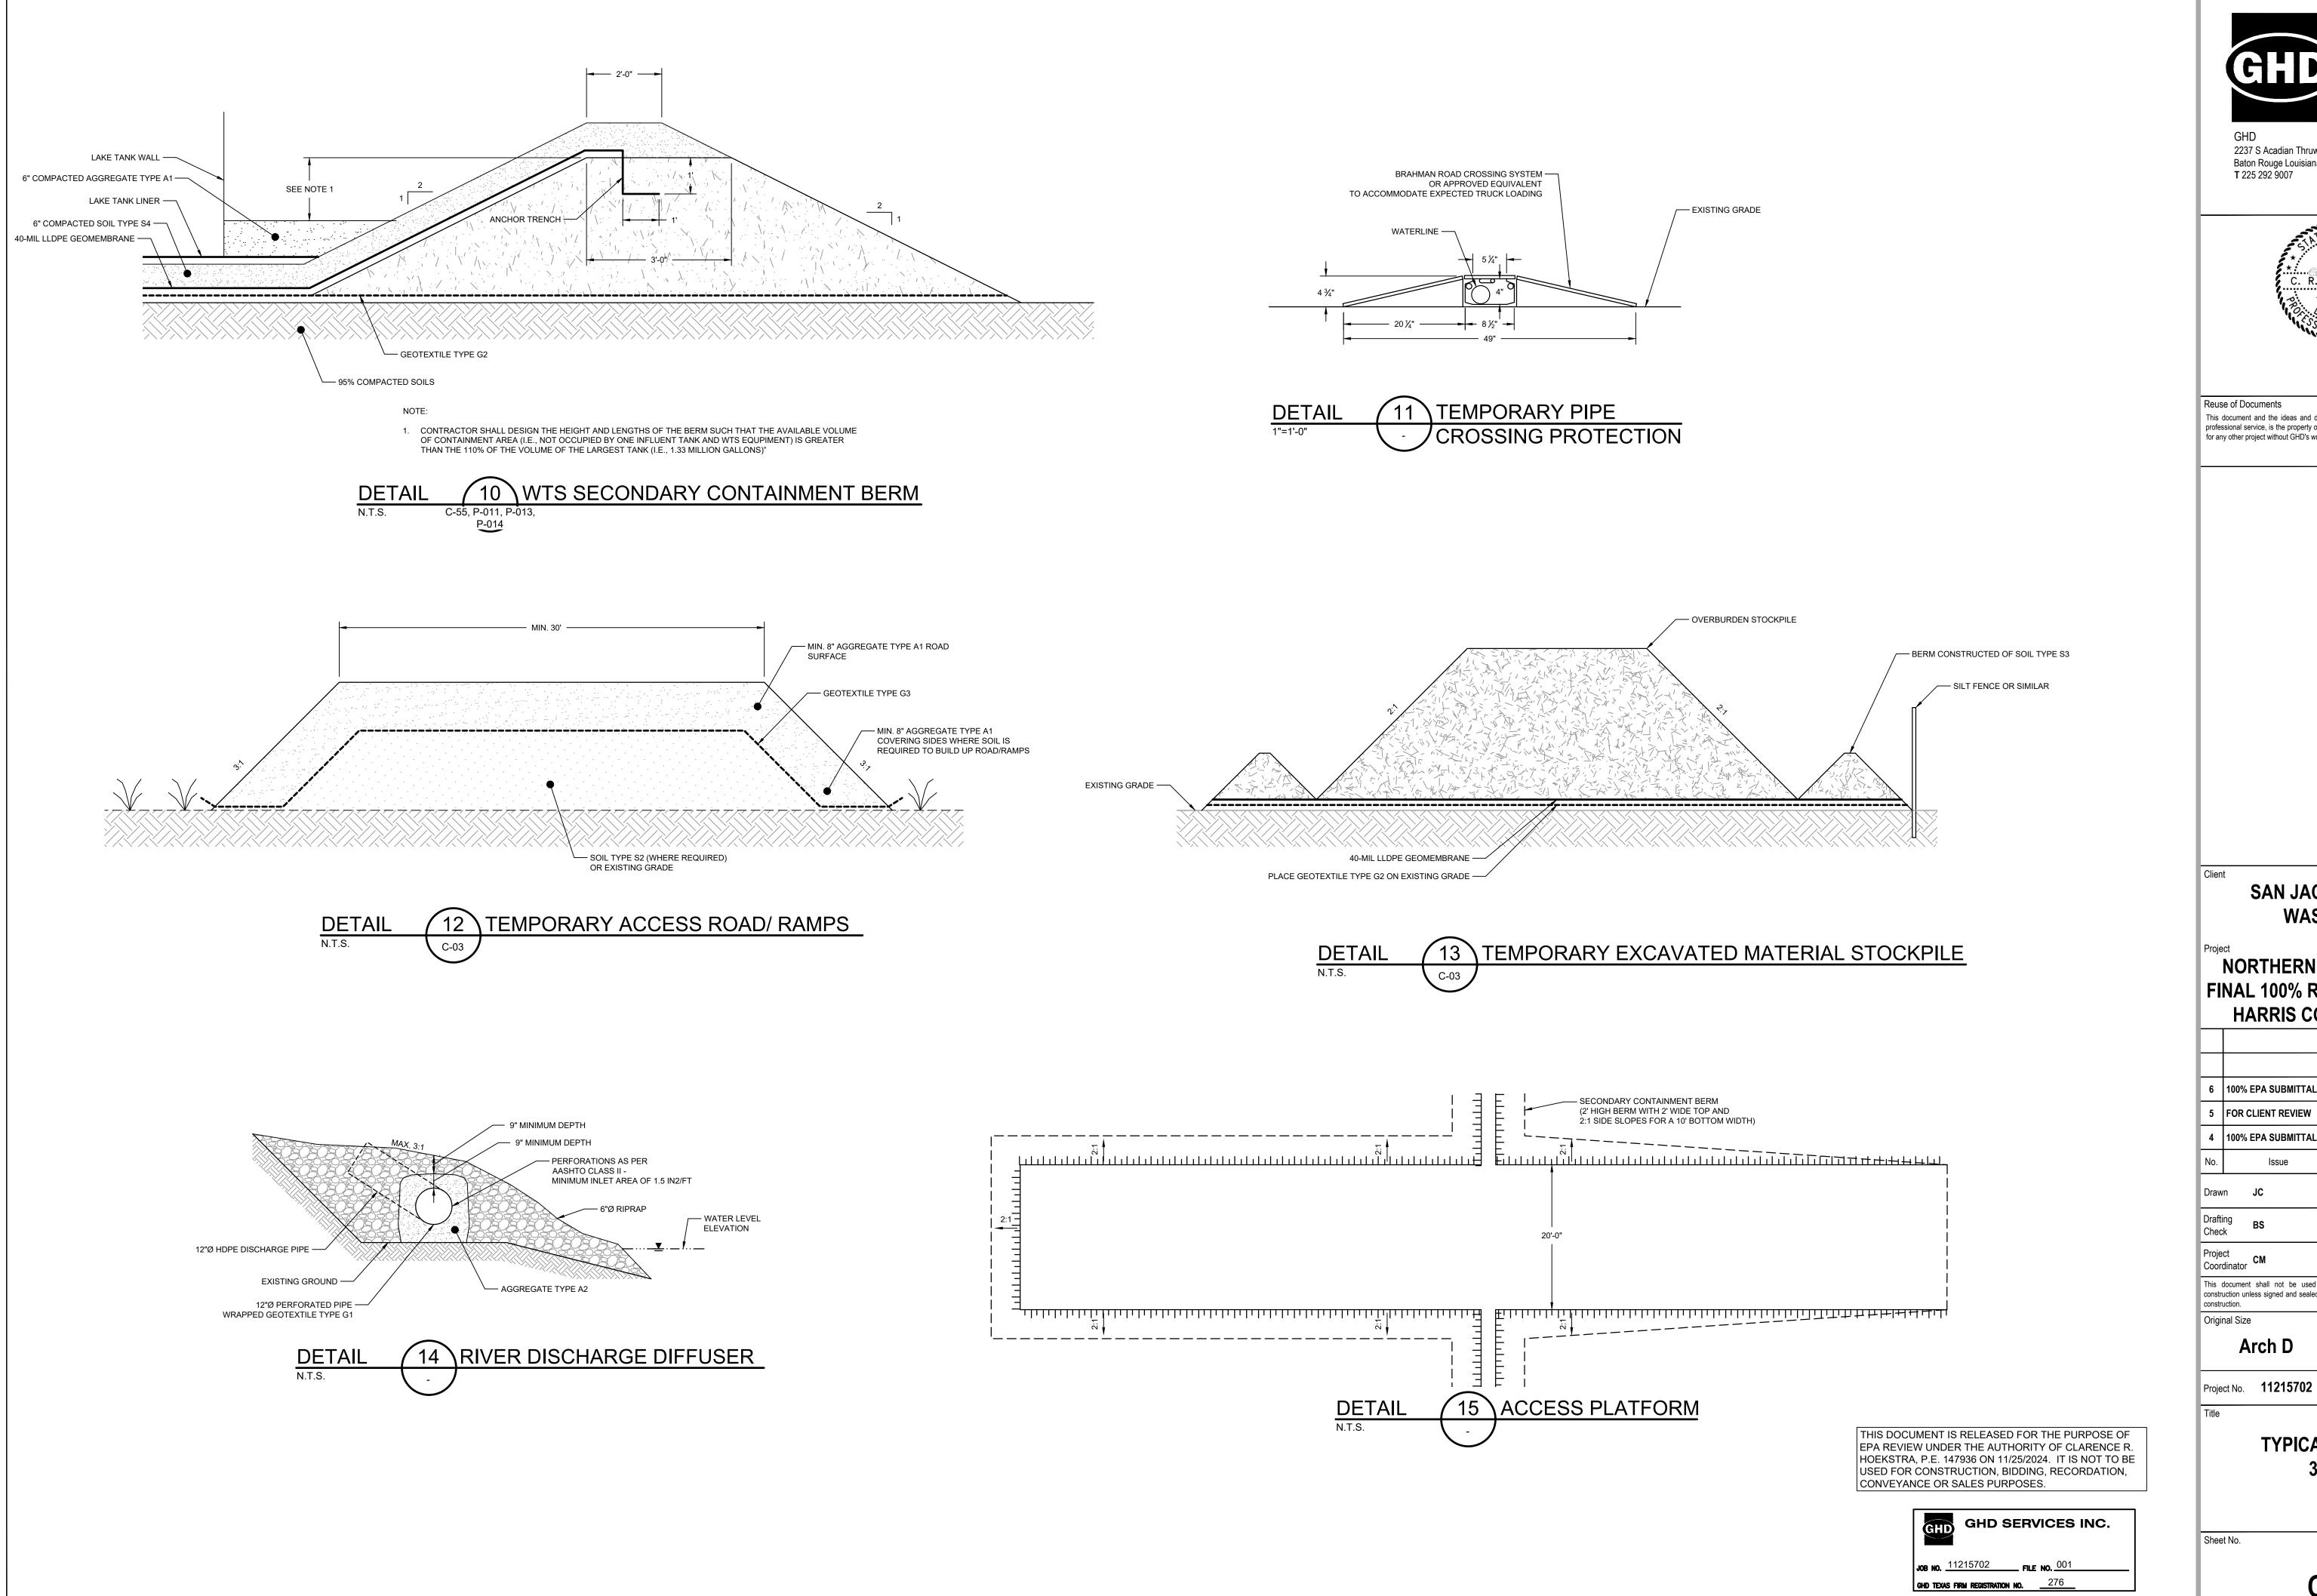



This document and the ideas and designs incorporated herein, as an instrument of professional service, is the property of GHD and shall not be reused in whole or in part for any other project without GHD's written authorization. © 2024 GHD

## **SAN JACINTO RIVER WASTE PITS**

## NORTHERN IMPOUNDMENT FINAL 100% REMEDIAL DESIGN HARRIS COUNTY, TEXAS

6	100% EPA SUBMITTAL	J	CRH	11/25/202
5	FOR CLIENT REVIEW	JC	CRH	11/21/202
4	100% EPA SUBMITTAL	MW	CRH	07/17/202
No.	Issue	Drawn	Approved	Date
Draw	n <b>JC</b>	Designer	RH	
Drafting BS Check		Design Check	LL	
Project CM Coordinator		Date	Nov 25, 2024	
This document shall not be used for construction unless signed and sealed for construction.		Scale	AS SHOW	'N


**100% EPA SUBMITTAL** 


TYPICAL DETAILS 3 OF 3


Bar is one inch on original size drawing

**C-27** 

Sheet **28** of **83** 

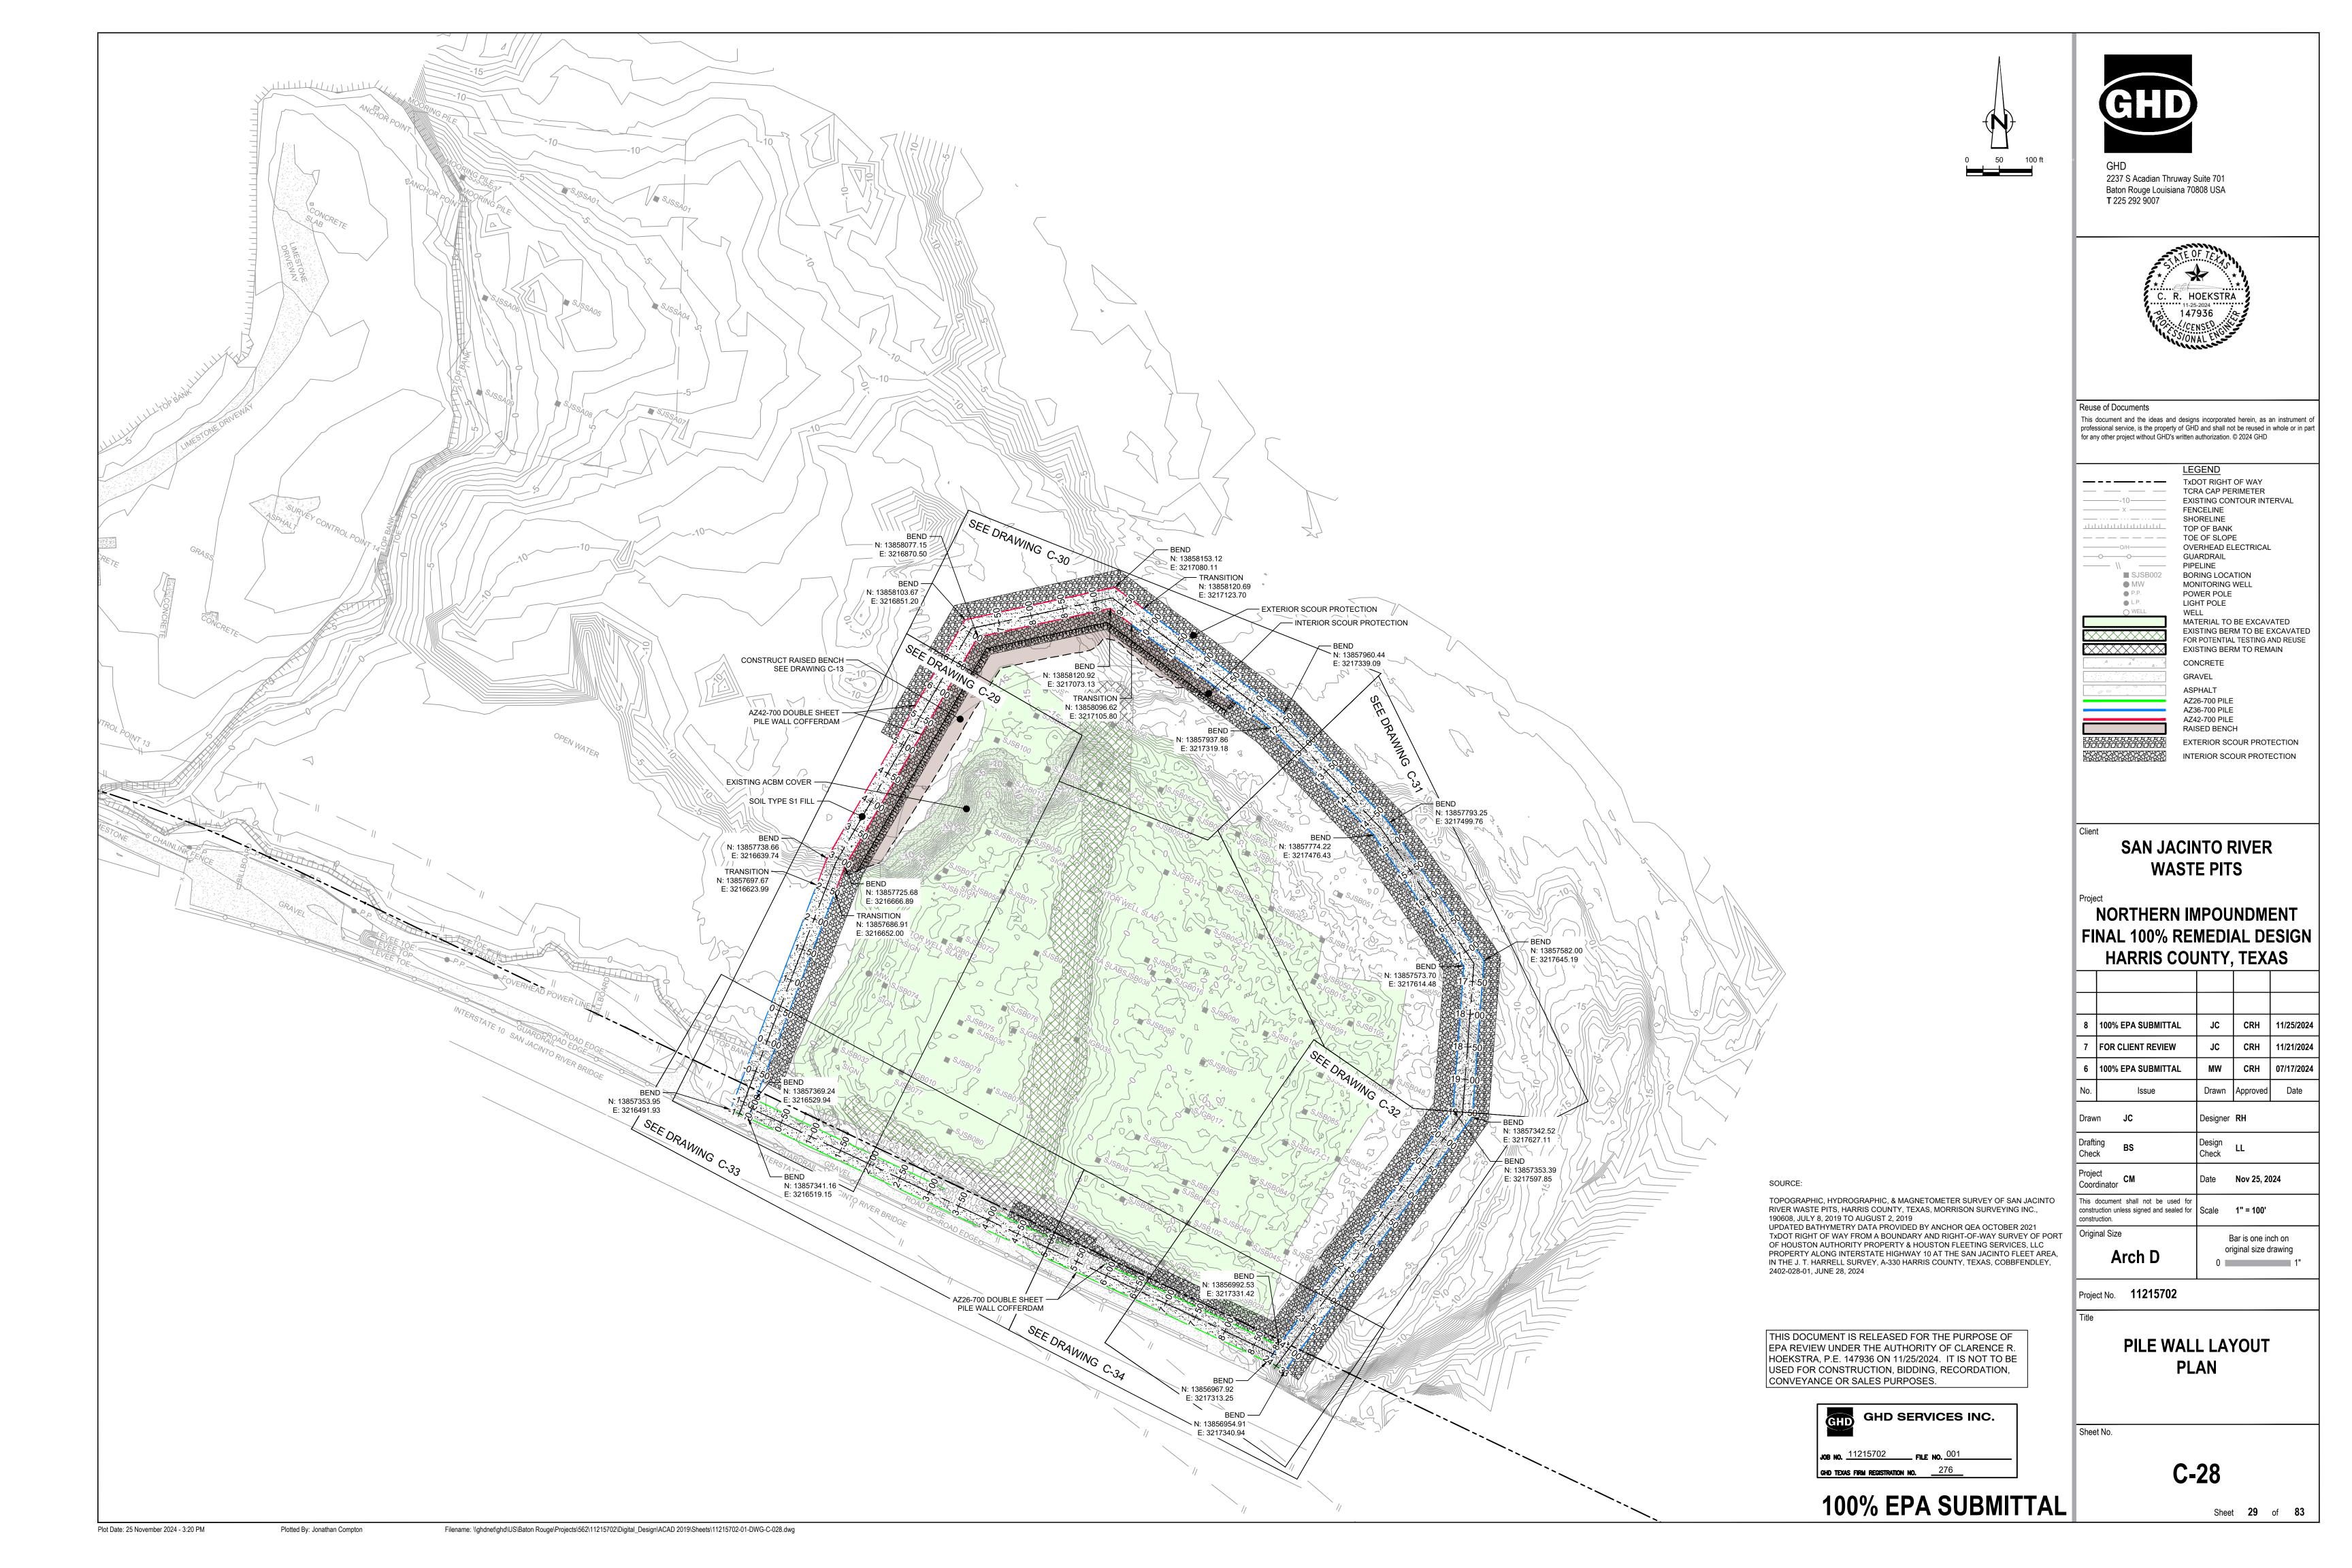

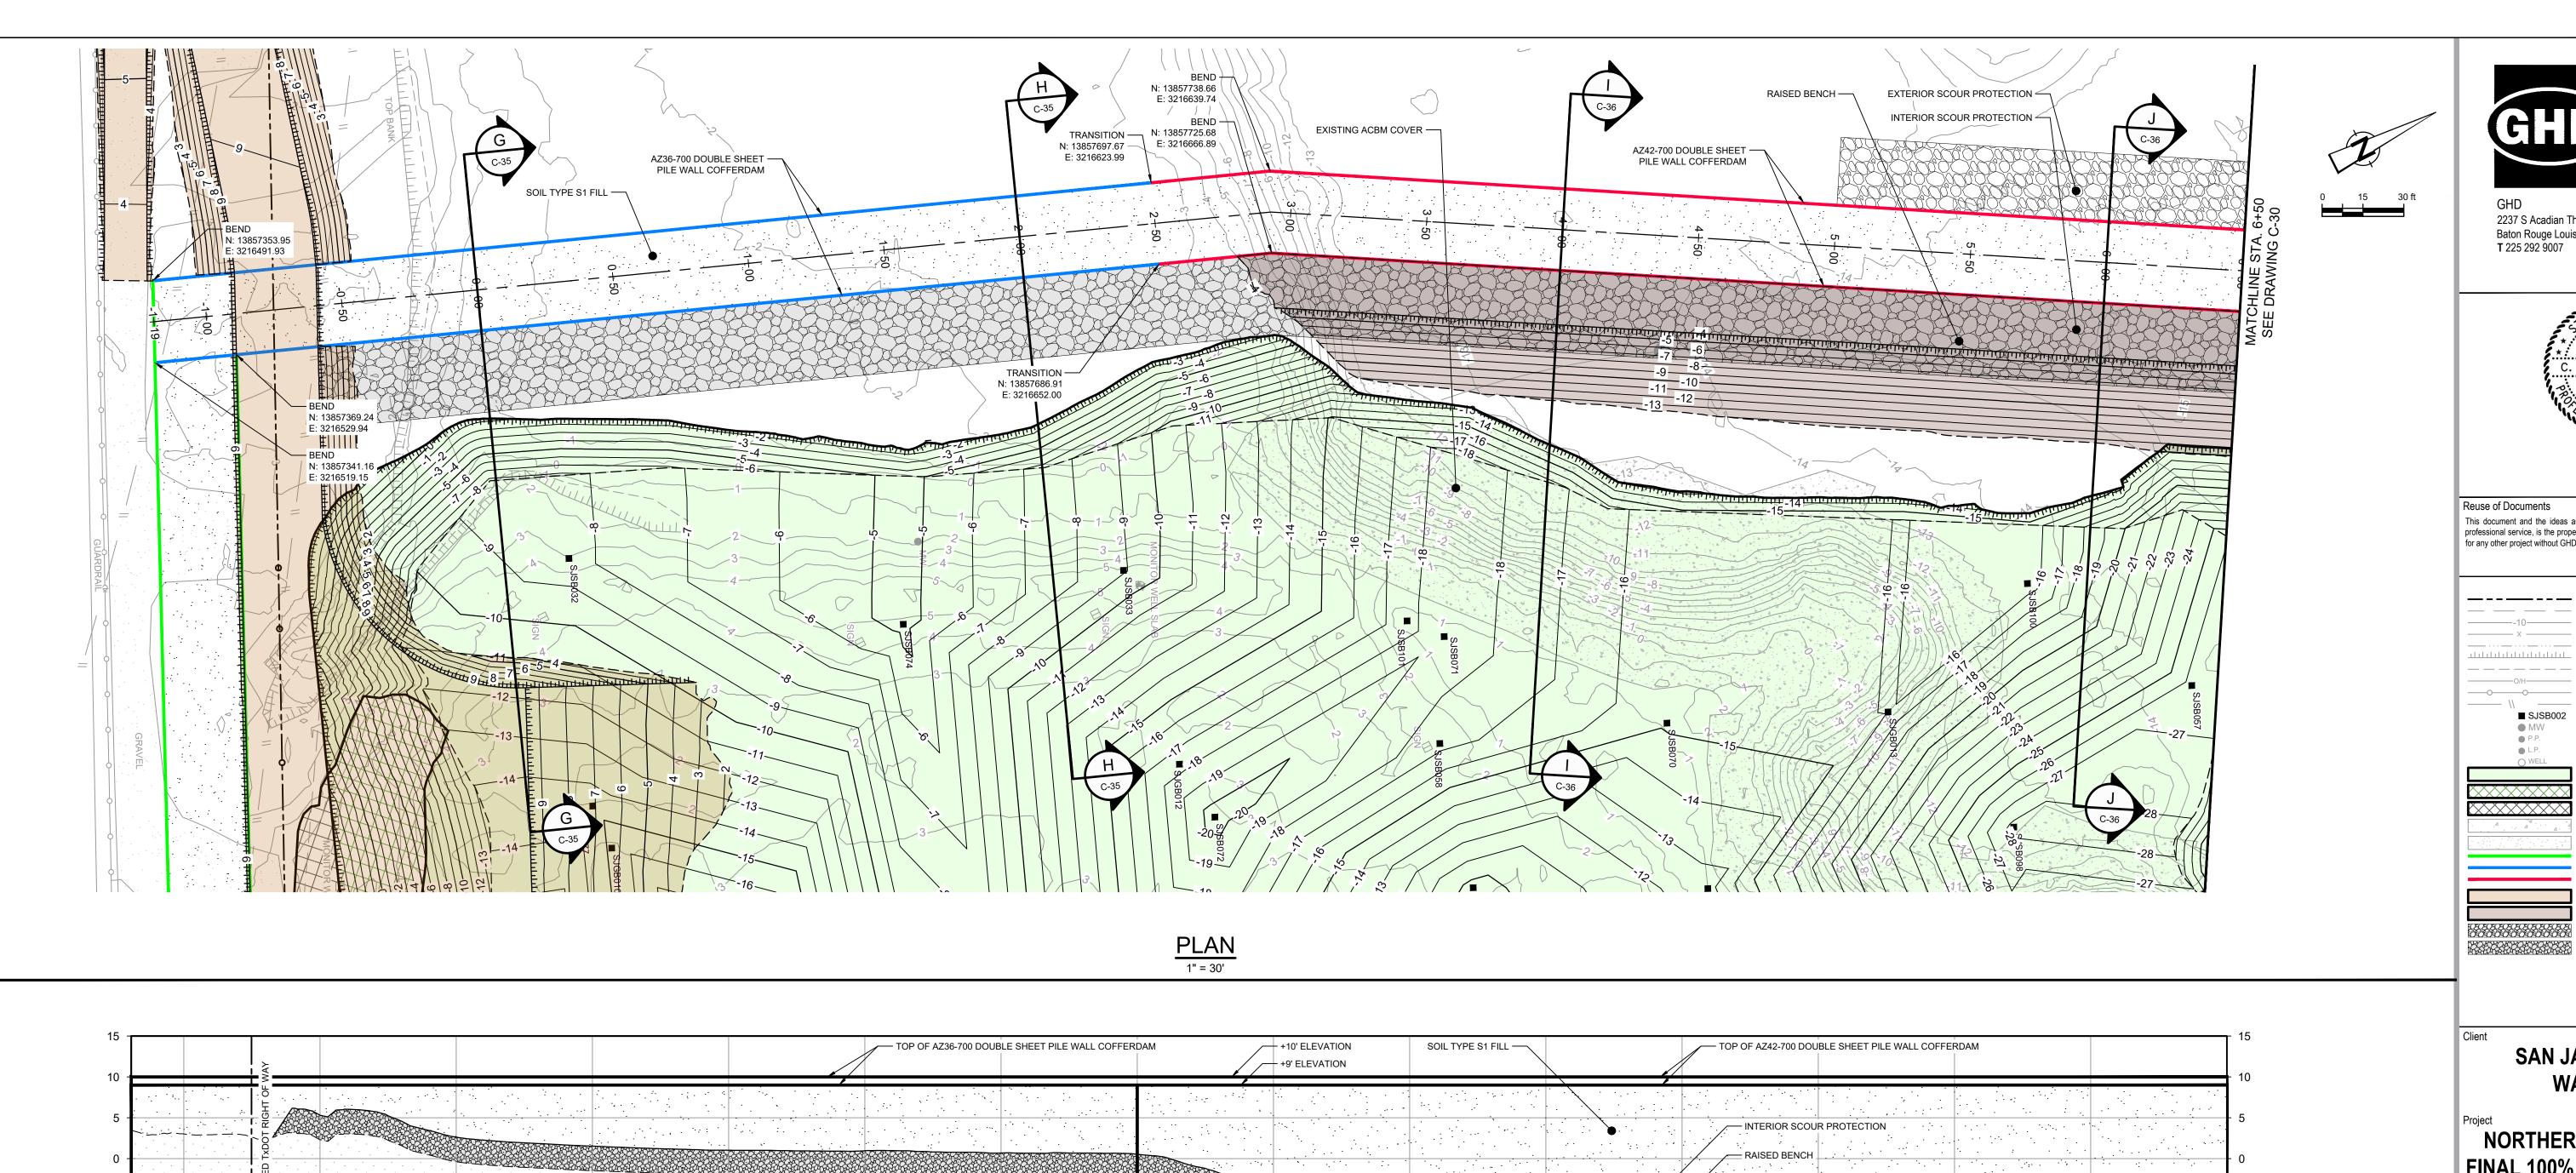

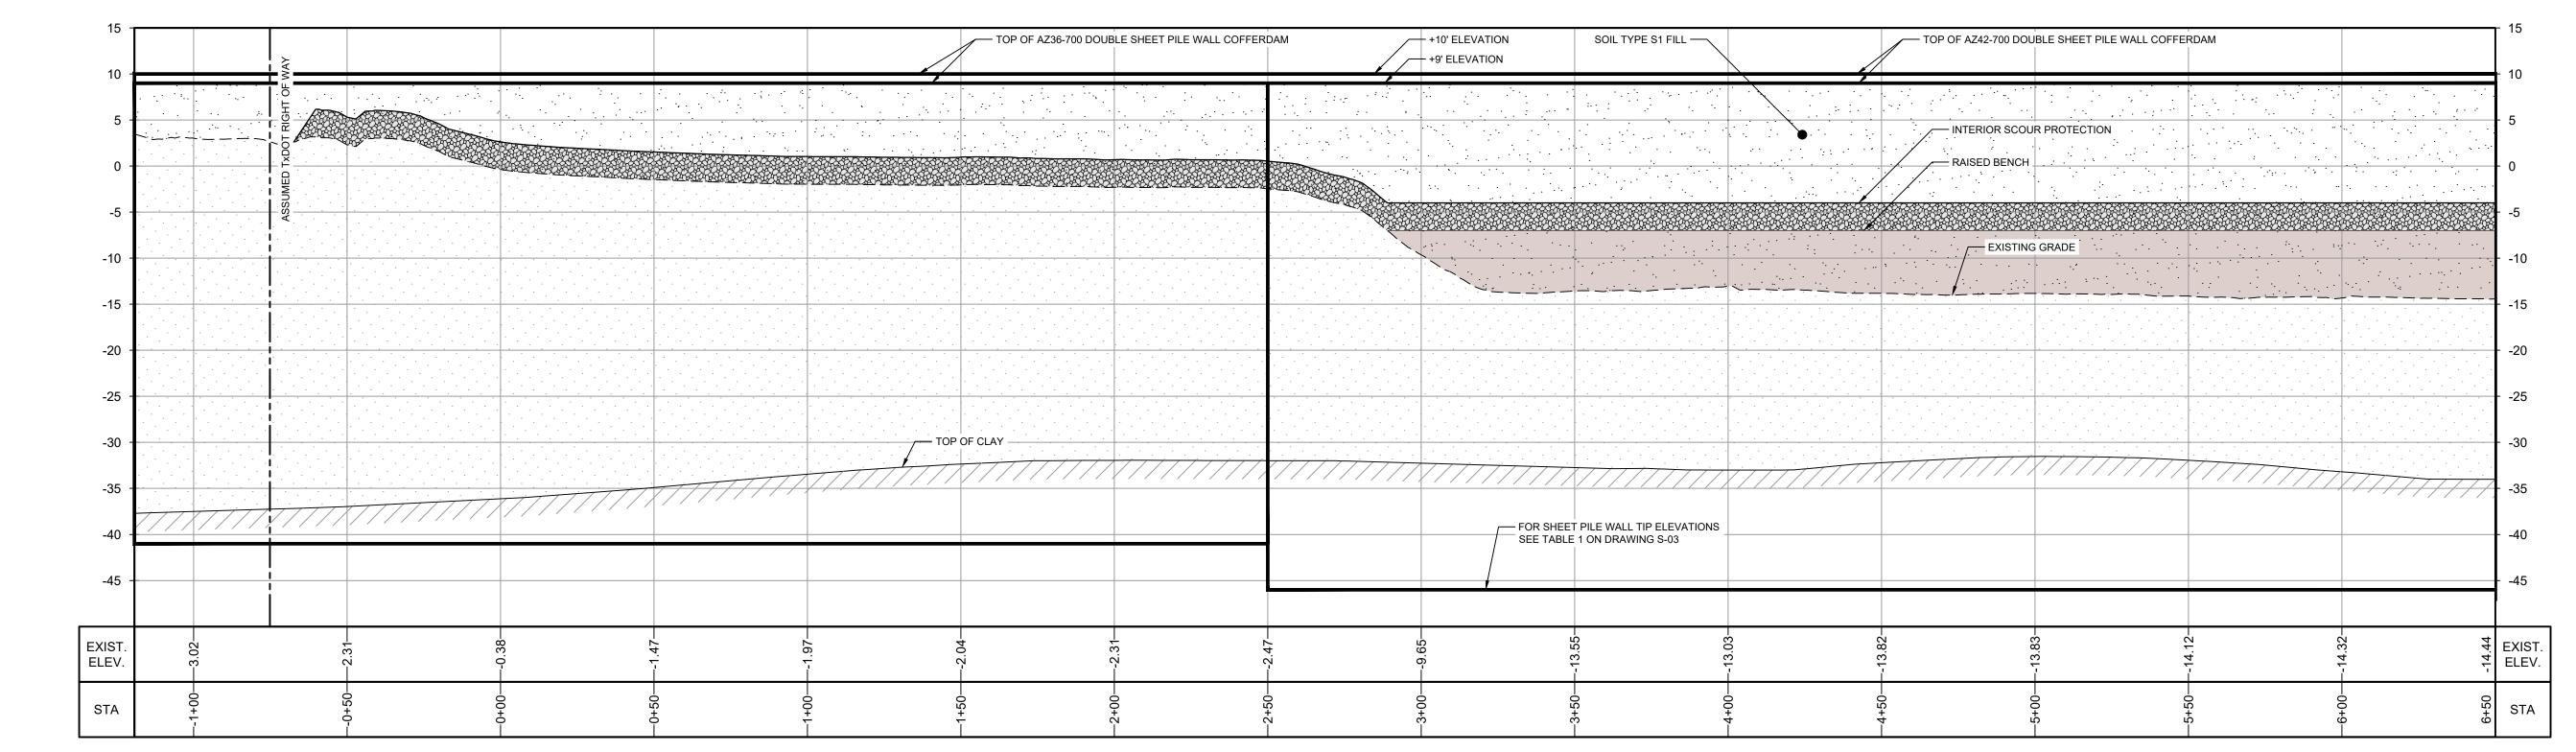

**PROFILE** 

HORIZ: 1" = 30'

VERT: 1" = 10'

2402-028-01, JUNE 28, 2024

TOPOGRAPHIC, HYDROGRAPHIC, & MAGNETOMETER SURVEY OF SAN JACINTO RIVER WASTE PITS, HARRIS COUNTY, TEXAS, MORRISON SURVEYING INC., 190608, JULY 8, 2019 TO AUGUST 2, 2019 UPDATED BATHYMETRY DATA PROVIDED BY ANCHOR QEA OCTOBER 2021 TXDOT RIGHT OF WAY FROM A BOUNDARY AND RIGHT-OF-WAY SURVEY OF PORT OF HOUSTON AUTHORITY PROPERTY & HOUSTON FLEETING SERVICES, LLC PROPERTY ALONG INTERSTATE HIGHWAY 10 AT THE SAN JACINTO FLEET AREA. IN THE J. T. HARRELL SURVEY, A-330 HARRIS COUNTY, TEXAS, COBBFENDLEY,

1. FINAL EXCAVATION CONTOURS ARE SUBJECT TO CHANGE.

3. FRP BARRIER WALL NOT SHOWN FOR CLARITY.

THIS DOCUMENT IS RELEASED FOR THE PURPOSE OF EPA REVIEW UNDER THE AUTHORITY OF CLARENCE R. HOEKSTRA, P.E. 147936 ON 11/25/2024. IT IS NOT TO BE USED FOR CONSTRUCTION, BIDDING, RECORDATION, CONVEYANCE OR SALES PURPOSES.



**100% EPA SUBMITTAL** 



2237 S Acadian Thruway Suite 701 Baton Rouge Louisiana 70808 USA **T** 225 292 9007



Reuse of Documents

This document and the ideas and designs incorporated herein, as an instrument of professional service, is the property of GHD and shall not be reused in whole or in part for any other project without GHD's written authorization. © 2024 GHD

> — – – — TxDOT RIGHT OF WAY TCRA CAP PERIMETER EXISTING CONTOUR INTERVAL FENCELINE SHORELINE \_\_\_\_\_ TOP OF BANK — — — — — TOE OF SLOPE OVERHEAD ELECTRICAL **GUARDRAIL** PIPELINE ■ SJSB002 **BORING LOCATION** MW MONITORING WELL

MATERIAL TO BE EXCAVATED EXISTING BERM TO BE EXCAVATED FOR POTENTIAL TESTING AND REUSE EXISTING BERM TO REMAIN CONCRETE GRAVEL AZ26-700 PILE AZ36-700 PILE AZ42-700 PILE PLANNED IMPROVEMENTS FOR

POWER POLE LIGHT POLE

NORTHERN IMPOUNDMENT ACCESS RAISED BENCH EXTERIOR SCOUR PROTECTION INTERIOR SCOUR PROTECTION

**SAN JACINTO RIVER WASTE PITS** 

NORTHERN IMPOUNDMENT FINAL 100% REMEDIAL DESIGN HARRIS COUNTY, TEXAS

8	100% EPA SUBMITTAL	JC	CRH	11/25/2
7	FOR CLIENT REVIEW	JC	CRH	11/21/2
6	100% EPA SUBMITTAL	MW	CRH	07/17/2
No.	Issue	Drawn	Approved	Dat
Drawn <b>JC</b>		Designer	RH	
Drafting BS Check		Design Check	LL	
Project CM Coordinator		Date	Nov 25, 2024	
This document shall not be used for construction unless signed and sealed for construction.		Scale	AS SHOW	/N

Arch D

Original Size Bar is one inch on original size drawing

Project No. **11215702** 


**DOUBLE PILE WALL** PLAN AND PROFILE 1 OF 4


Sheet No.


**C-29** 

Sheet **30** of **83** 


Plot Date: 25 November 2024 - 3:22 PM

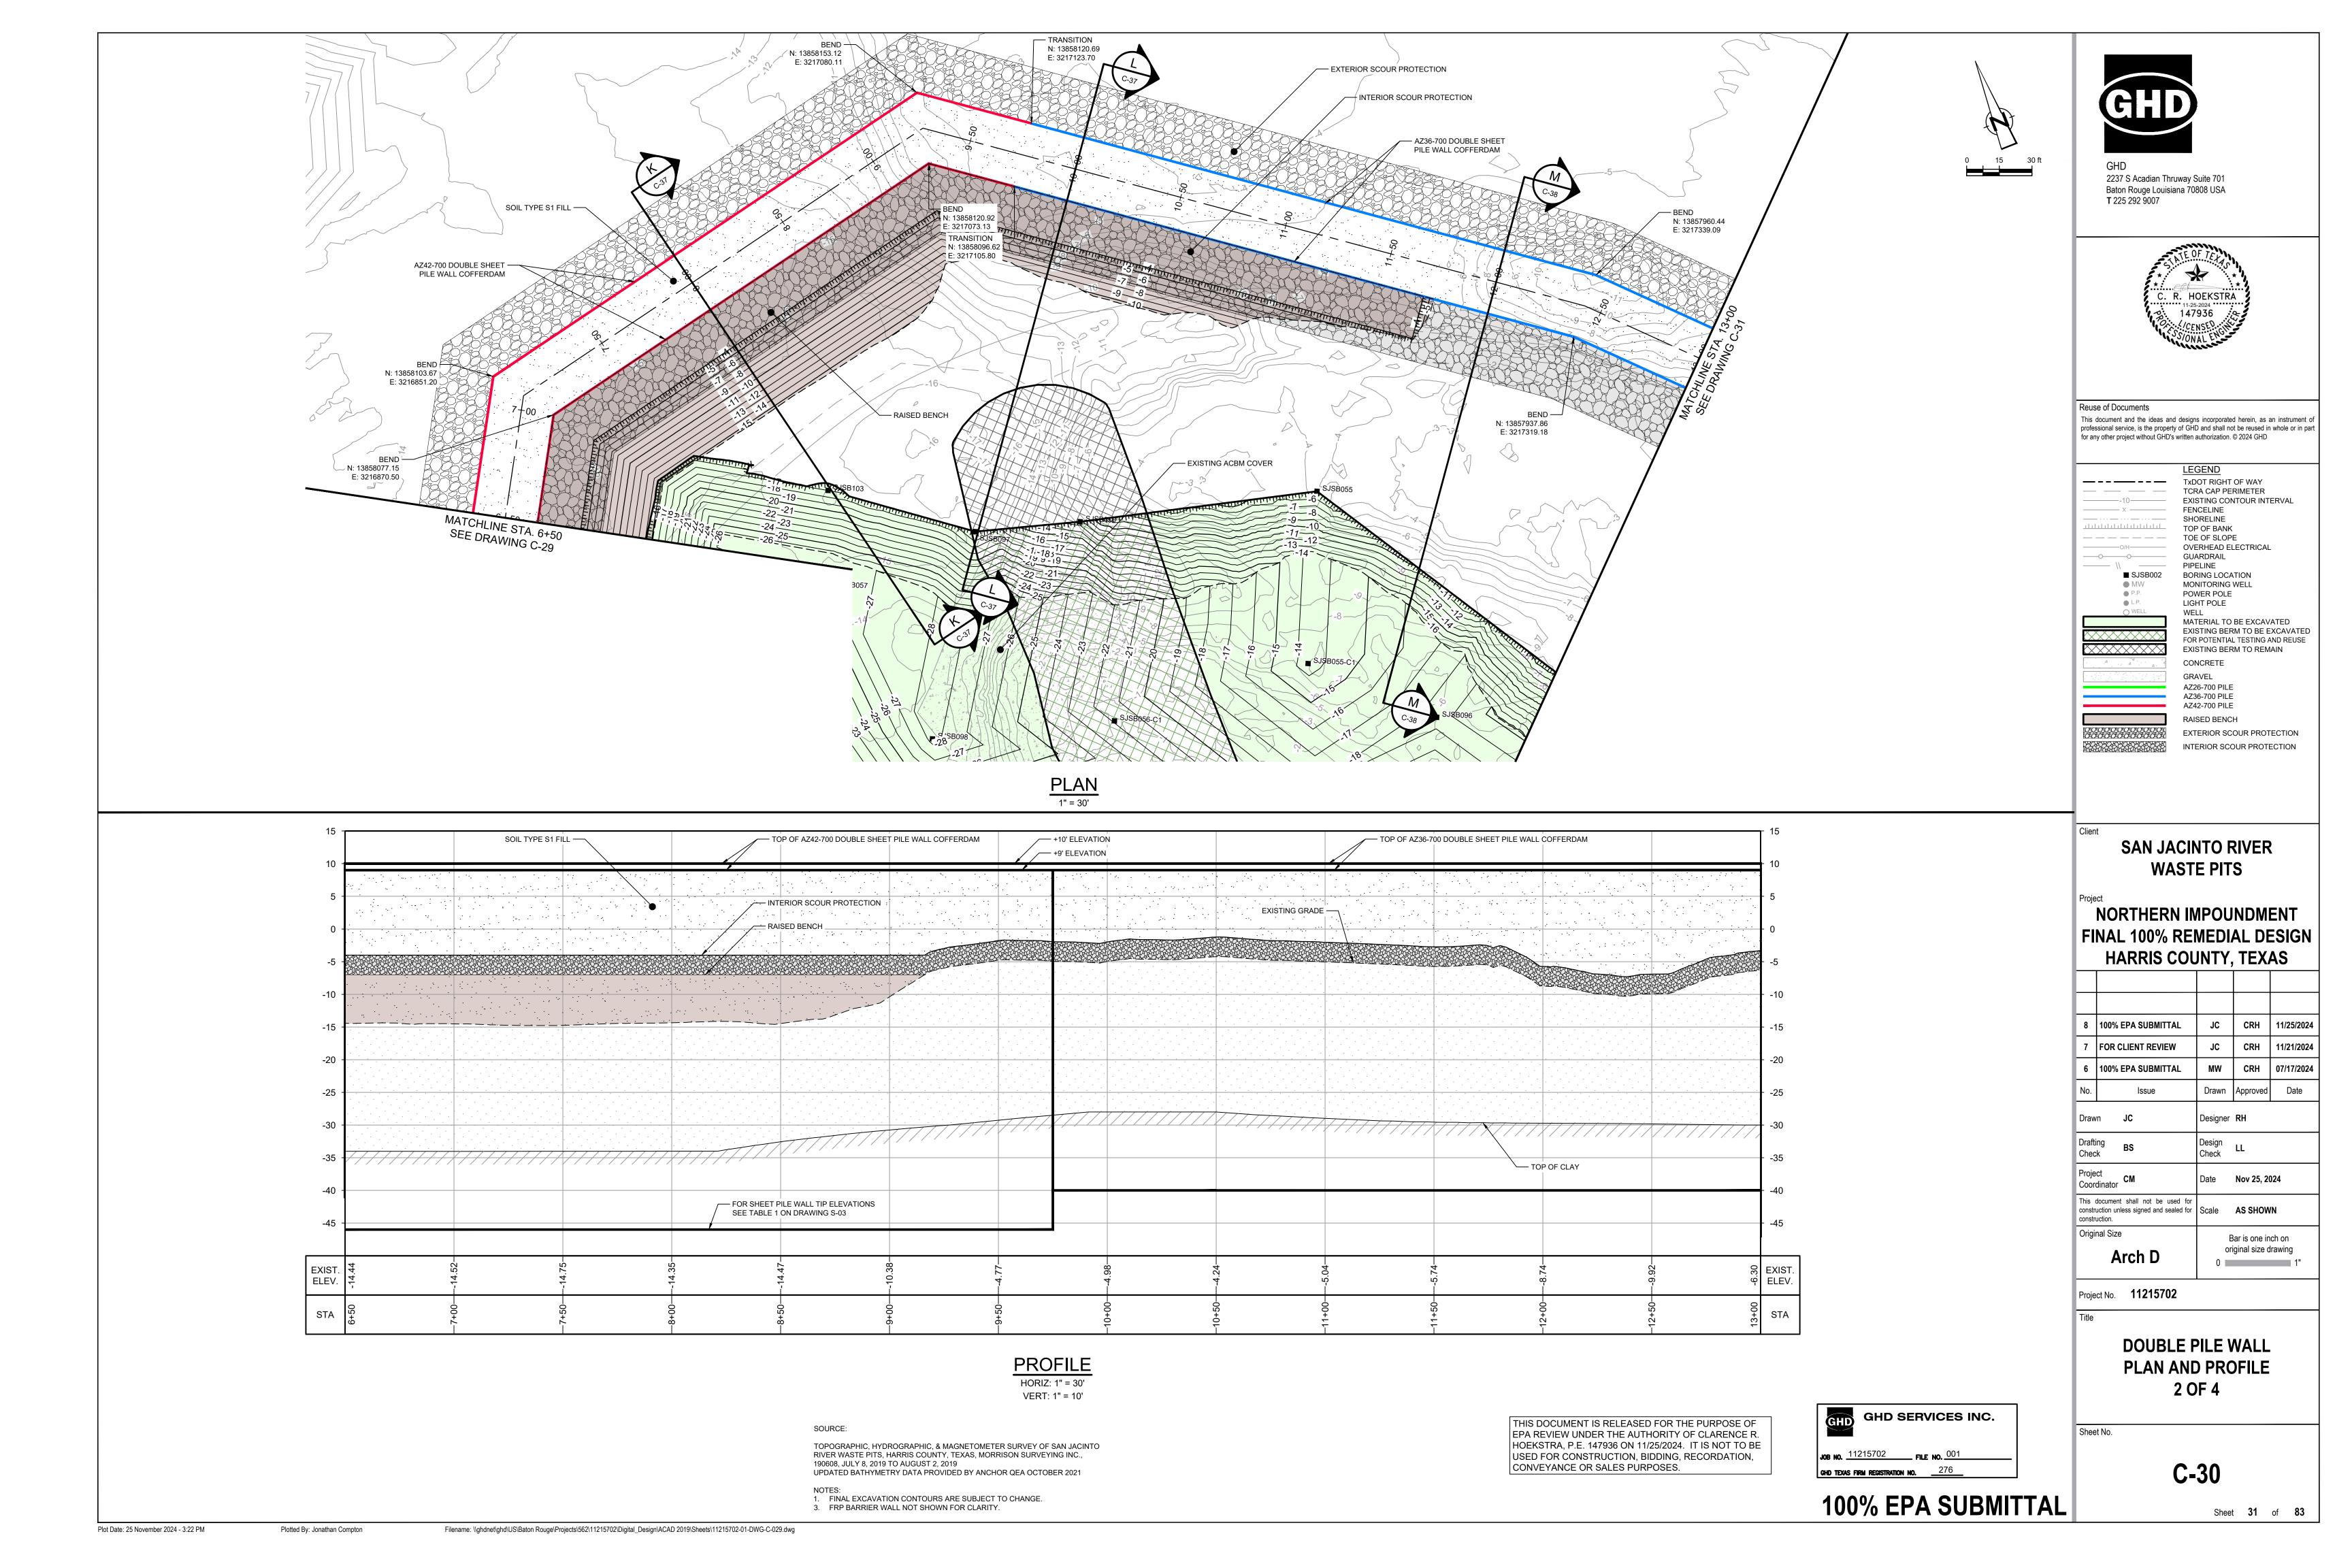


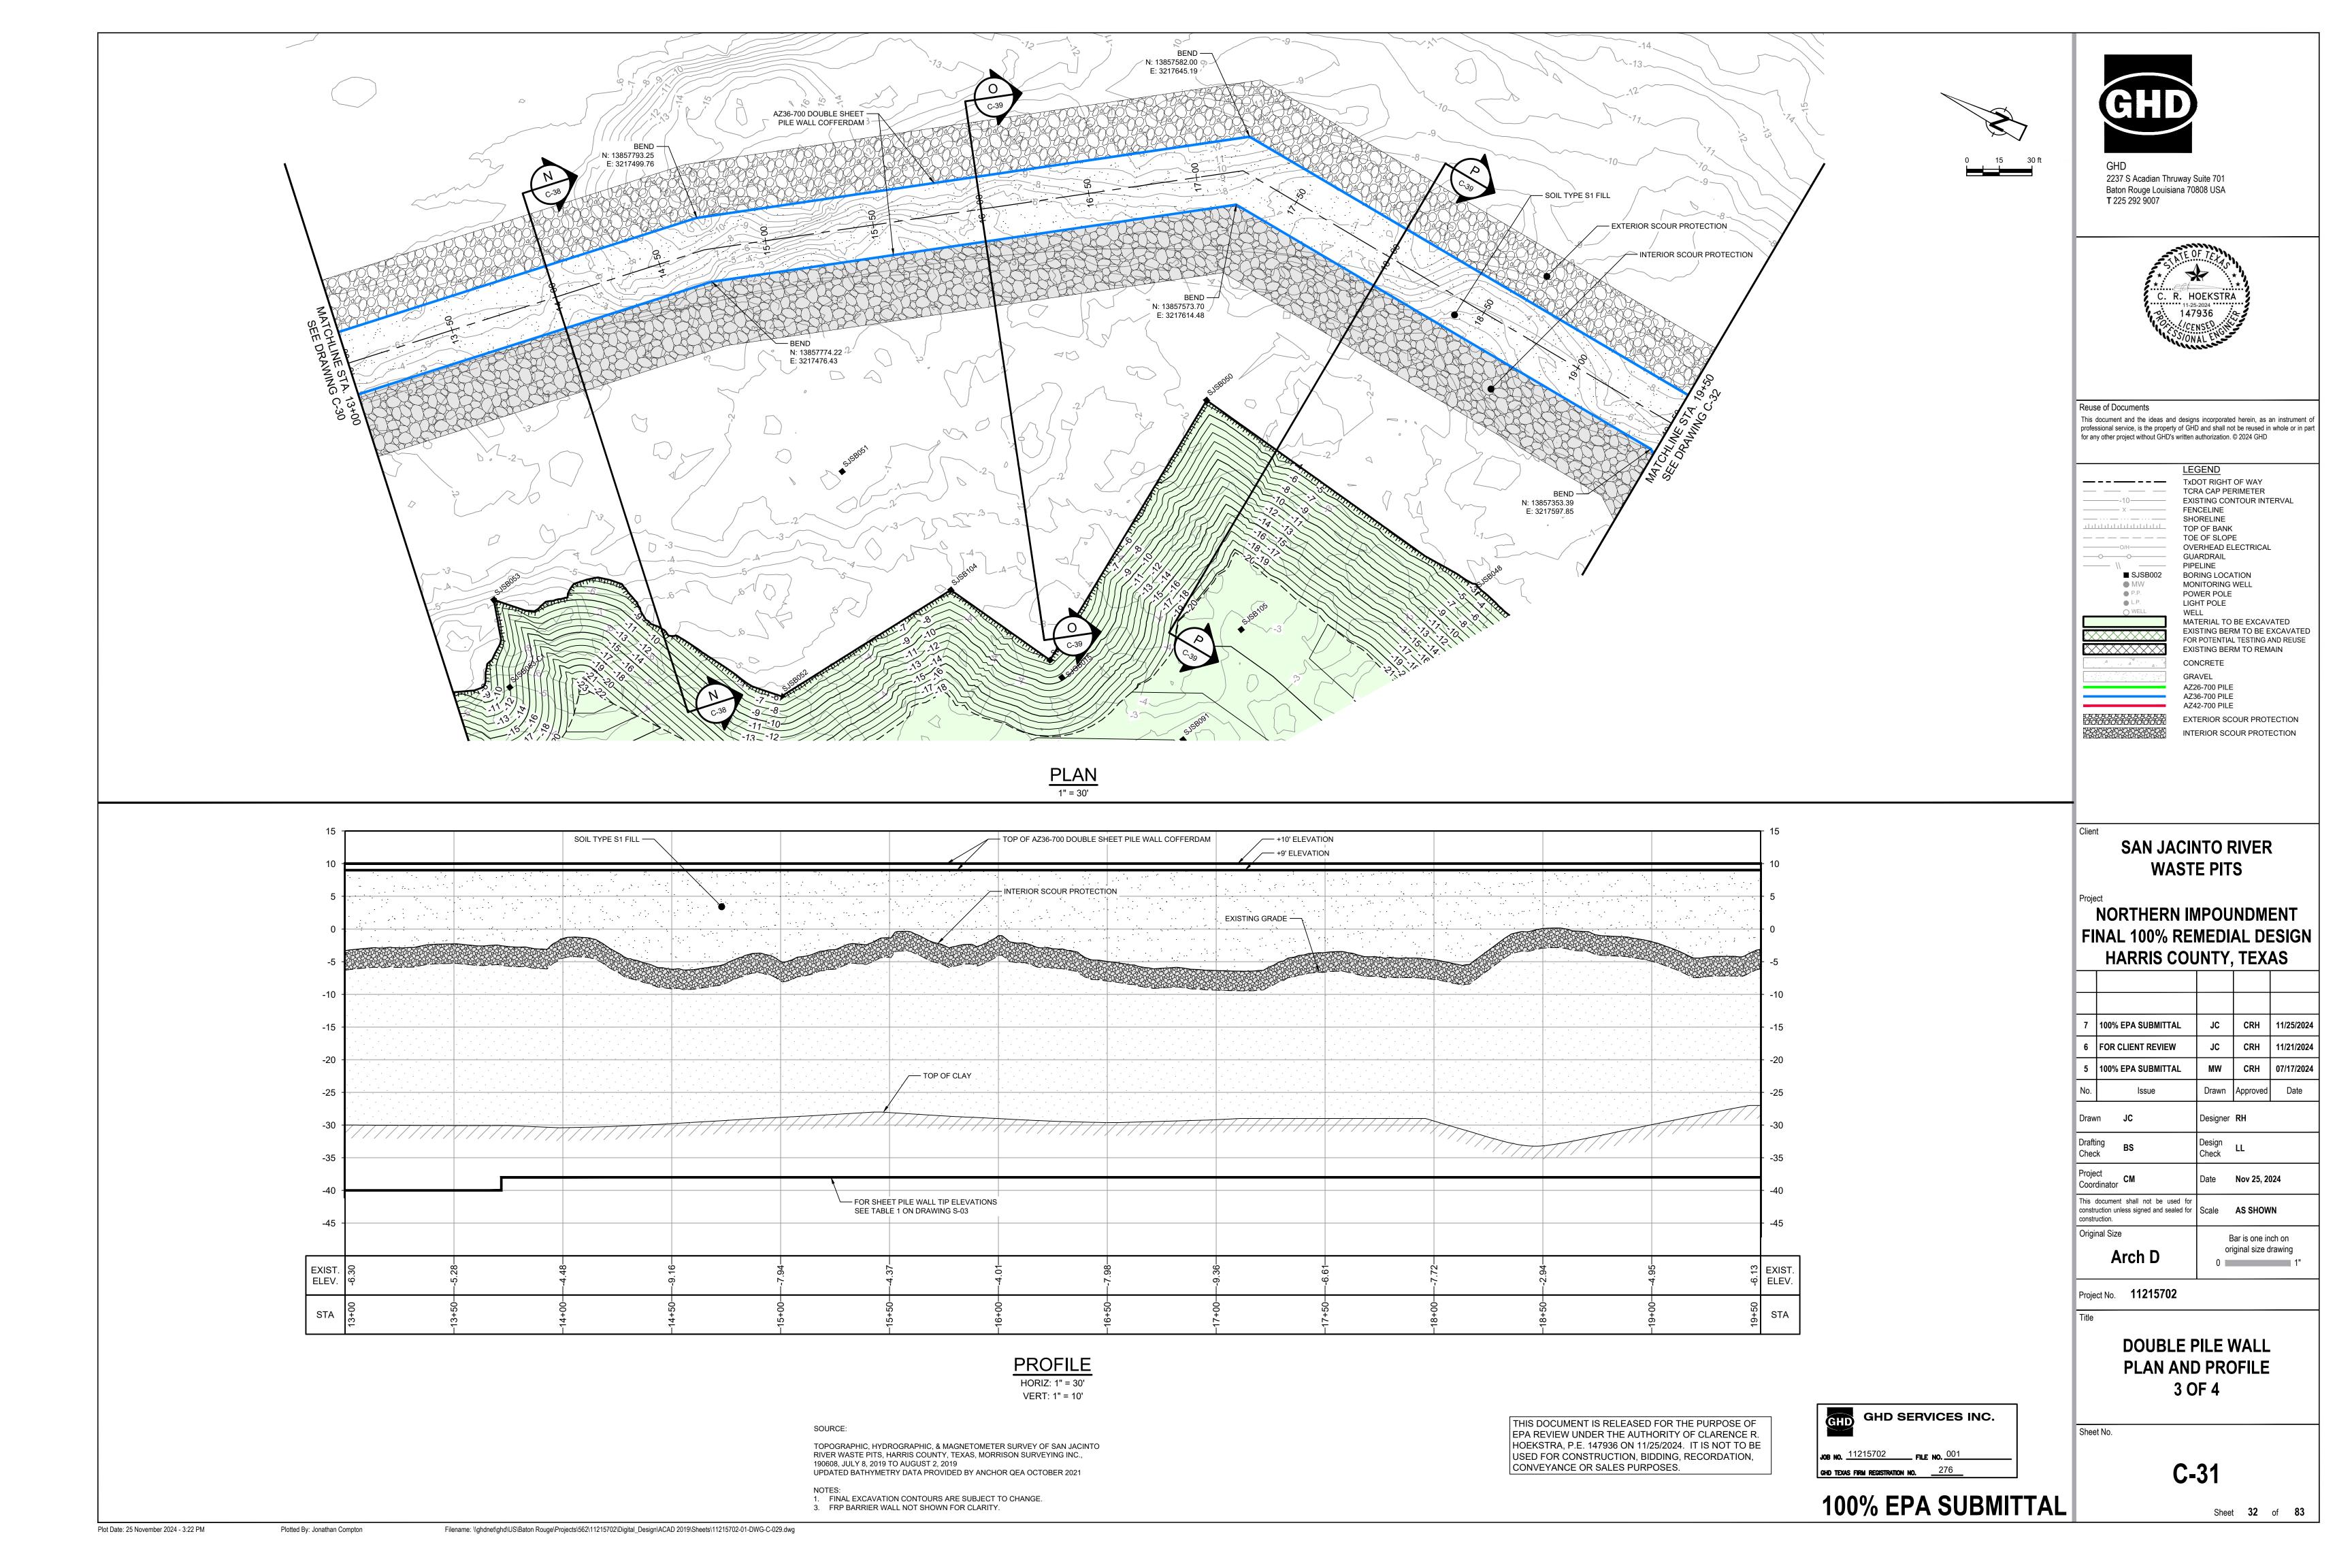

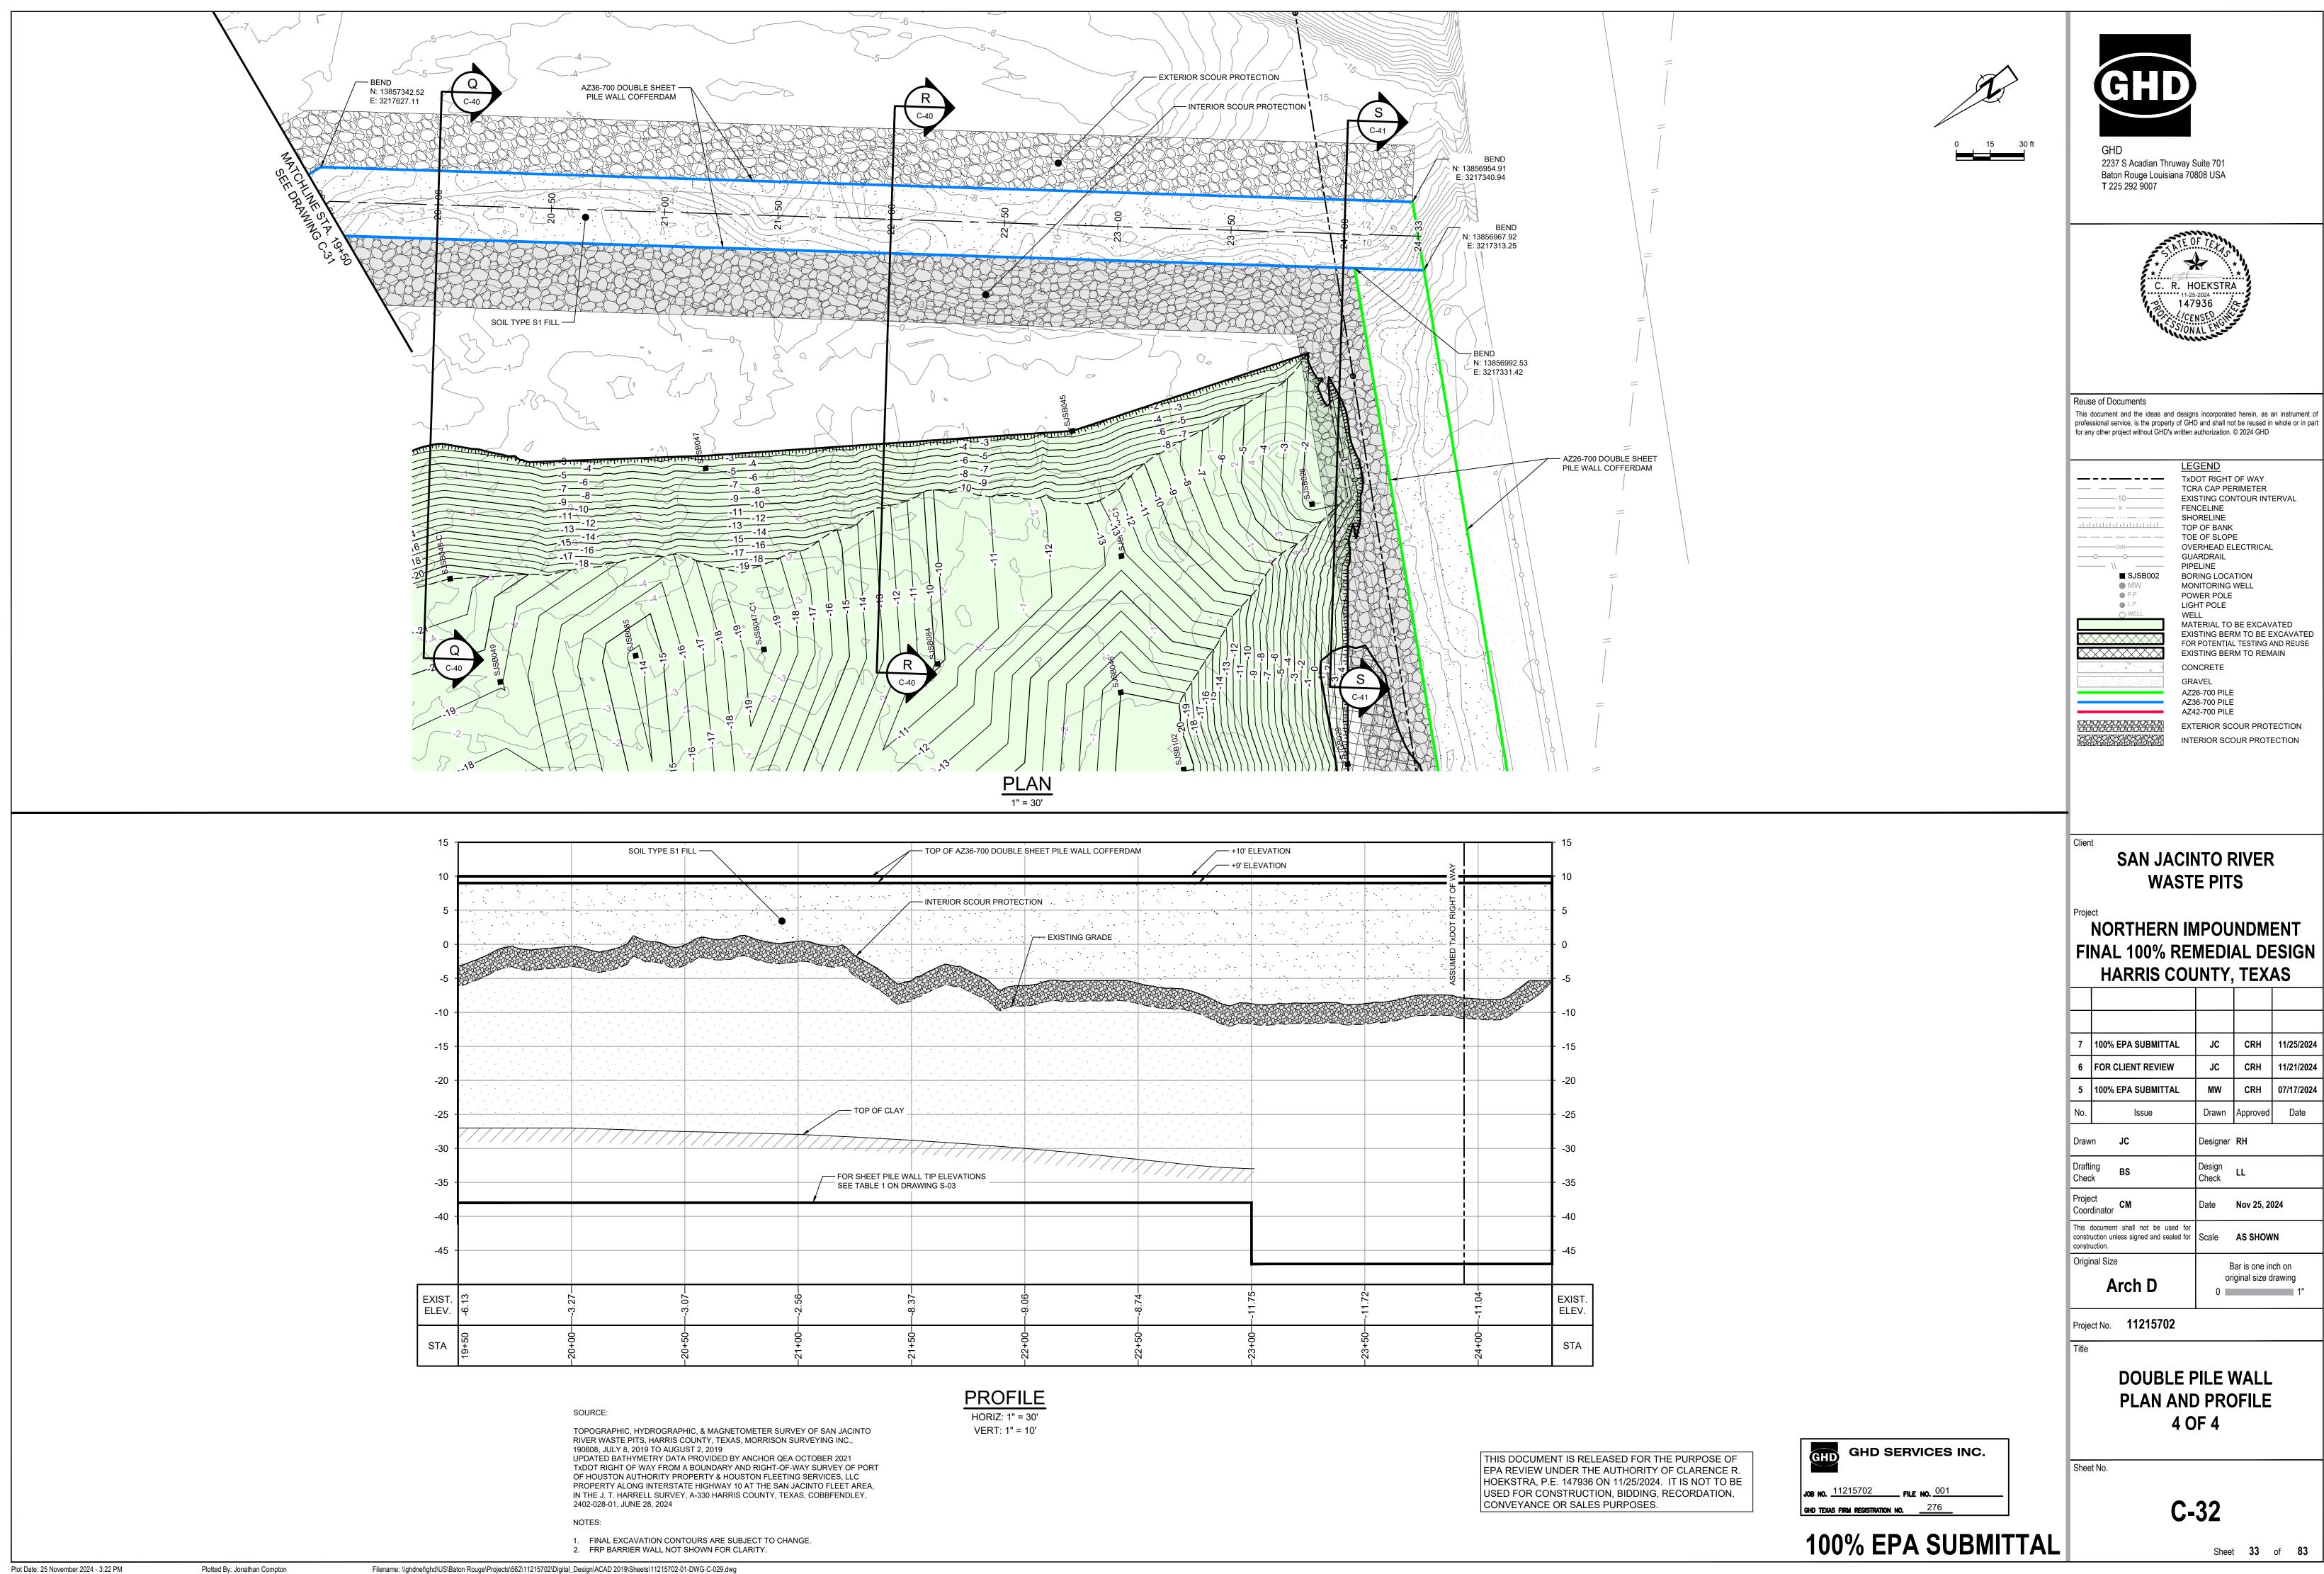

Sheet **33** of **83** 

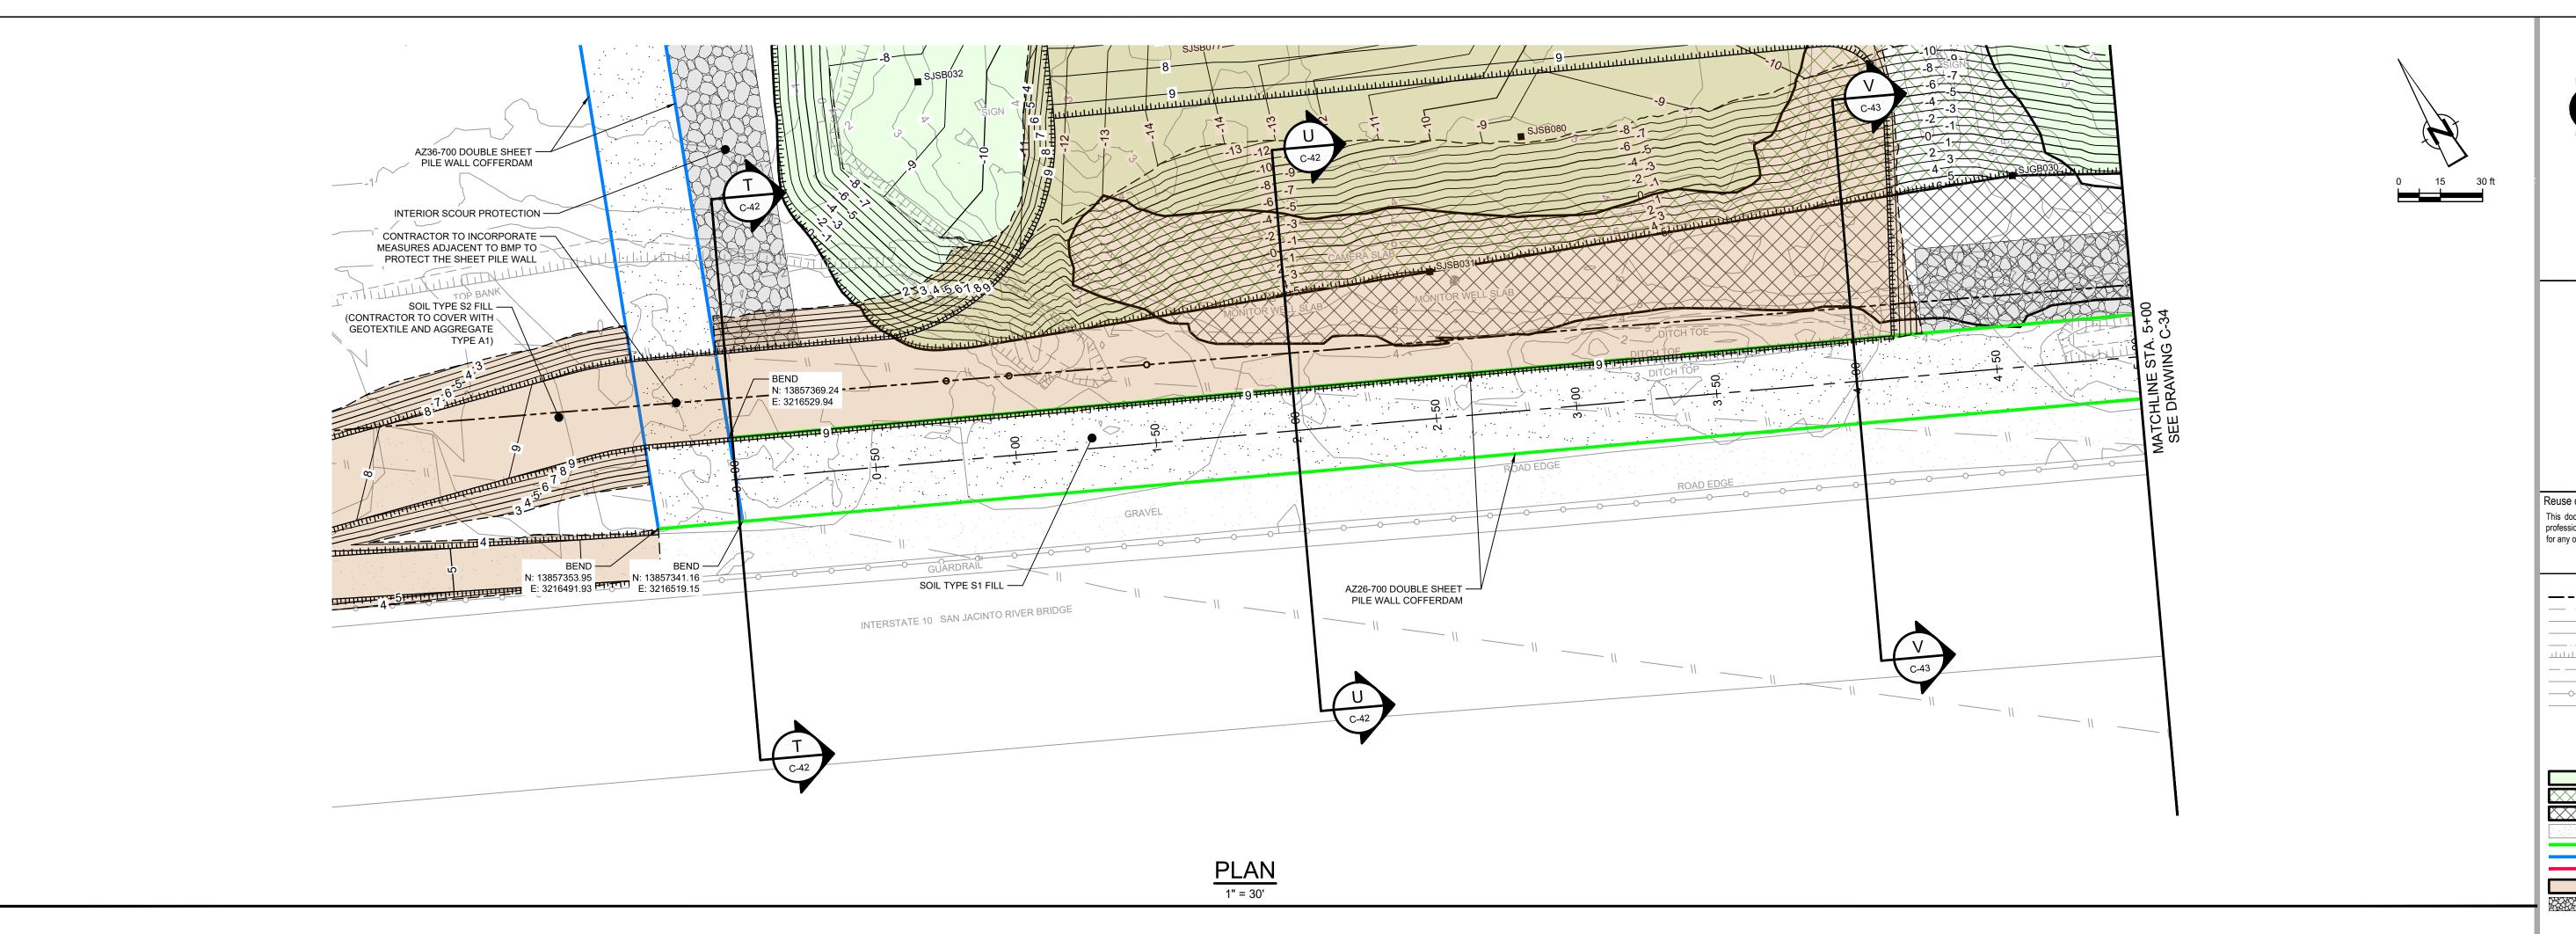

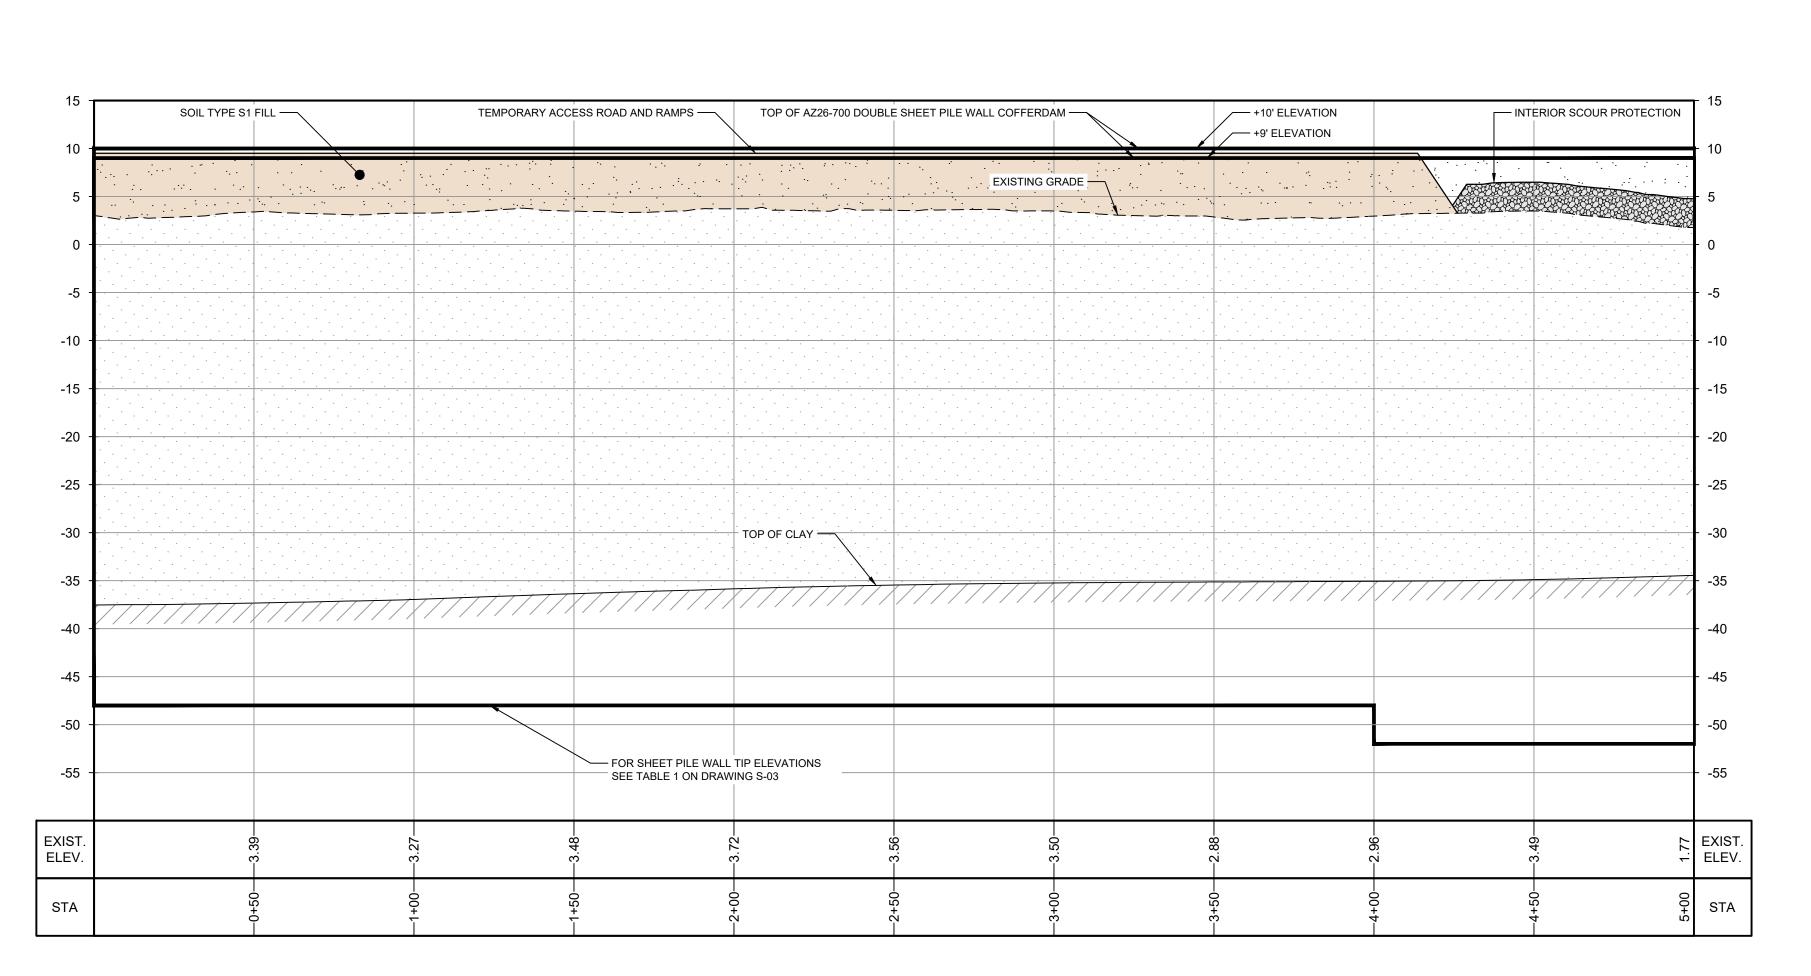

GHD SERVICES INC.

1. FINAL EXCAVATION CONTOURS ARE SUBJECT TO CHANGE.

THIS DOCUMENT IS RELEASED FOR THE PURPOSE OF

EPA REVIEW UNDER THE AUTHORITY OF CLARENCE R. HOEKSTRA, P.E. 147936 ON 11/25/2024. IT IS NOT TO BE

USED FOR CONSTRUCTION, BIDDING, RECORDATION,

CONVEYANCE OR SALES PURPOSES.

TOPOGRAPHIC, HYDROGRAPHIC, & MAGNETOMETER SURVEY OF SAN JACINTO RIVER WASTE PITS, HARRIS COUNTY, TEXAS, MORRISON SURVEYING INC.,

UPDATED BATHYMETRY DATA PROVIDED BY ANCHOR QEA OCTOBER 2021 TXDOT RIGHT OF WAY FROM A BOUNDARY AND RIGHT-OF-WAY SURVEY OF PORT

OF HOUSTON AUTHORITY PROPERTY & HOUSTON FLEETING SERVICES, LLC

PROPERTY ALONG INTERSTATE HIGHWAY 10 AT THE SAN JACINTO FLEET AREA, IN THE J. T. HARRELL SURVEY, A-330 HARRIS COUNTY, TEXAS, COBBFENDLEY,

SOURCE:

190608, JULY 8, 2019 TO AUGUST 2, 2019

2402-028-01, JUNE 28, 2024

100% EPA SUBMITTAL



2237 S Acadian Thruway Suite 701 Baton Rouge Louisiana 70808 USA **T** 225 292 9007



Reuse of Documents

This document and the ideas and designs incorporated herein, as an instrument of professional service, is the property of GHD and shall not be reused in whole or in part for any other project without GHD's written authorization. © 2024 GHD

> <u>LEGEND</u> **— – – — T**XDOT RIGHT OF WAY — — TCRA CAP PERIMETER EXISTING CONTOUR INTERVAL FENCELINE TOP OF BANK \_\_ \_ \_ \_ TOE OF SLOPE OVERHEAD ELECTRICAL **GUARDRAIL** PIPELINE ■ SJSB002 BORING LOCATION MW MONITORING WELL POWER POLE

LIGHT POLE MATERIAL TO BE EXCAVATED EXISTING BERM TO BE EXCAVATED

FOR POTENTIAL TESTING AND REUSE EXISTING BERM TO REMAIN GRAVEL AZ26-700 PILE AZ36-700 PILE AZ42-700 PILE PLANNED IMPROVEMENTS FOR NORTHERN IMPOUNDMENT ACCESS

INTERIOR SCOUR PROTECTION

## SAN JACINTO RIVER **WASTE PITS**

NORTHERN IMPOUNDMENT FINAL 100% REMEDIAL DESIGN HARRIS COUNTY, TEXAS

ı						
	7	100% EPA SUBMITTAL	JC	CRH	11/25/20	
	6	FOR CLIENT REVIEW	JC	CRH	11/21/20	
	5	100% EPA SUBMITTAL	MW	CRH	07/17/20	
	No.	Issue	Drawn	Approved	Date	
	Drawn <b>JC</b>		Designer RH			
	Drafting Check BS		Design Check	LL		
	Project CM Coordinator		Date	Nov 25, 2024		
	This document shall not be used for construction unless signed and sealed for construction.		Scale	AS SHOWN		
	Original Size		Bar is one inch on			

Project No. **11215702** 

Arch D

**PILE WALL** PLAN AND PROFILE 1 OF 2

Sheet No.


**C-33** 


Sheet **34** of **83** 

original size drawing

PROFILE HORIZ: 1" = 30' VERT: 1" = 10'

Plot Date: 25 November 2024 - 3:23 PM

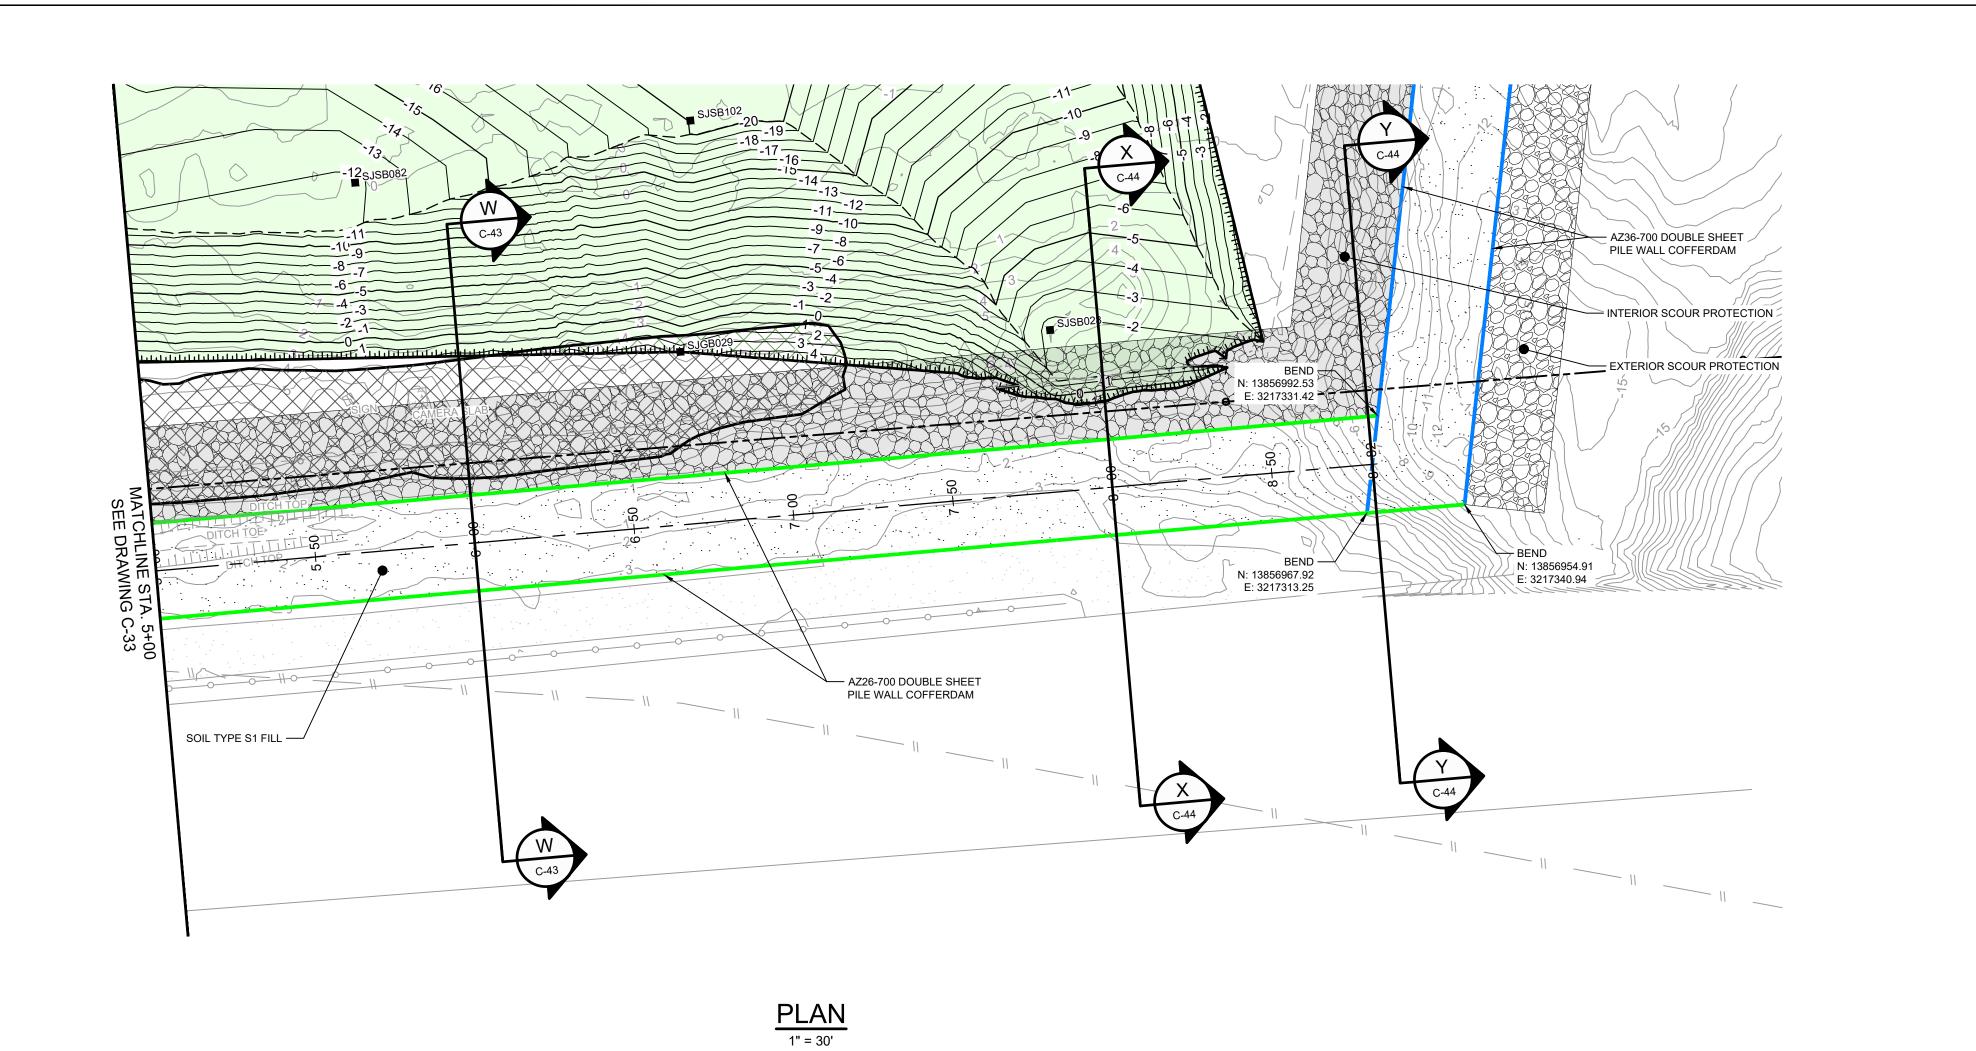

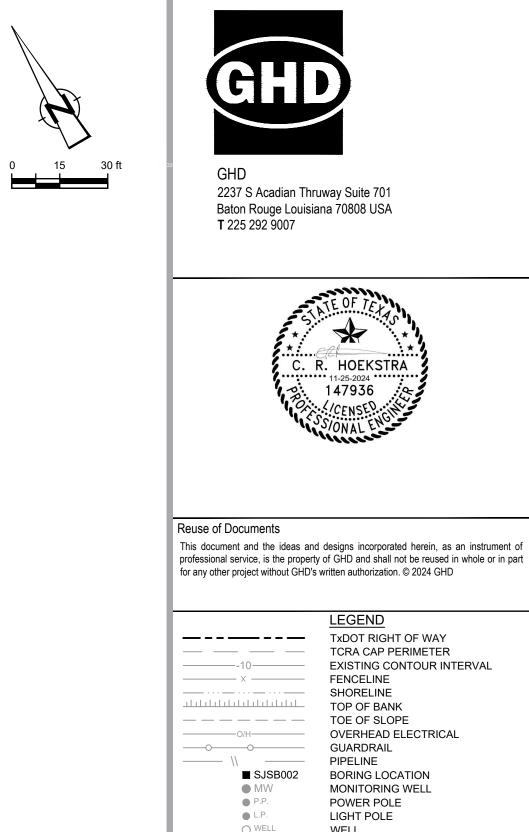

## **SAN JACINTO RIVER WASTE PITS**

<u>LEGEND</u>


GRAVEL AZ26-700 PILE AZ36-700 PILE AZ42-700 PILE

MATERIAL TO BE EXCAVATED EXISTING BERM TO BE EXCAVATED FOR POTENTIAL TESTING AND REUSE EXISTING BERM TO REMAIN

PLANNED IMPROVEMENTS FOR NORTHERN IMPOUNDMENT ACCESS

EXTERIOR SCOUR PROTECTION INTERIOR SCOUR PROTECTION

NORTHERN IMPOUNDMENT FINAL 100% REMEDIAL DESIGN HARRIS COUNTY, TEXAS

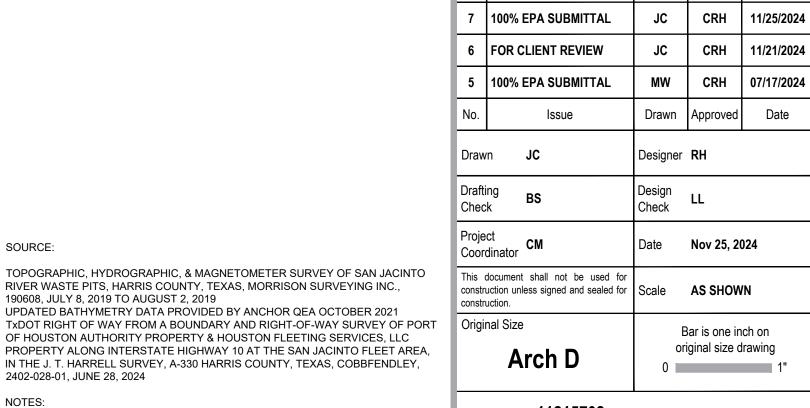

Project No. **11215702** 

**PILE WALL** 

**PLAN AND PROFILE** 2 OF 2

Sheet No.

C-34

Sheet **35** of **83** 

100% EPA SUBMITTAL

SOURCE:

NOTES:

2402-028-01, JUNE 28, 2024

TOPOGRAPHIC, HYDROGRAPHIC, & MAGNETOMETER SURVEY OF SAN JACINTO

RIVER WASTE PITS, HARRIS COUNTY, TEXAS, MORRISON SURVEYING INC., 190608, JULY 8, 2019 TO AUGUST 2, 2019

UPDATED BATHYMETRY DATA PROVIDED BY ANCHOR QEA OCTOBER 2021

1. FINAL EXCAVATION CONTOURS ARE SUBJECT TO CHANGE.

THIS DOCUMENT IS RELEASED FOR THE PURPOSE OF

EPA REVIEW UNDER THE AUTHORITY OF CLARENCE R. HOEKSTRA, P.E. 147936 ON 11/25/2024. IT IS NOT TO BE


USED FOR CONSTRUCTION, BIDDING, RECORDATION,

GHD SERVICES INC.

2. FRP BARRIER WALL NOT SHOWN FOR CLARITY.


CONVEYANCE OR SALES PURPOSES.

OF HOUSTON AUTHORITY PROPERTY & HOUSTON FLEETING SERVICES, LLC PROPERTY ALONG INTERSTATE HIGHWAY 10 AT THE SAN JACINTO FLEET AREA, IN THE J. T. HARRELL SURVEY, A-330 HARRIS COUNTY, TEXAS, COBBFENDLEY,

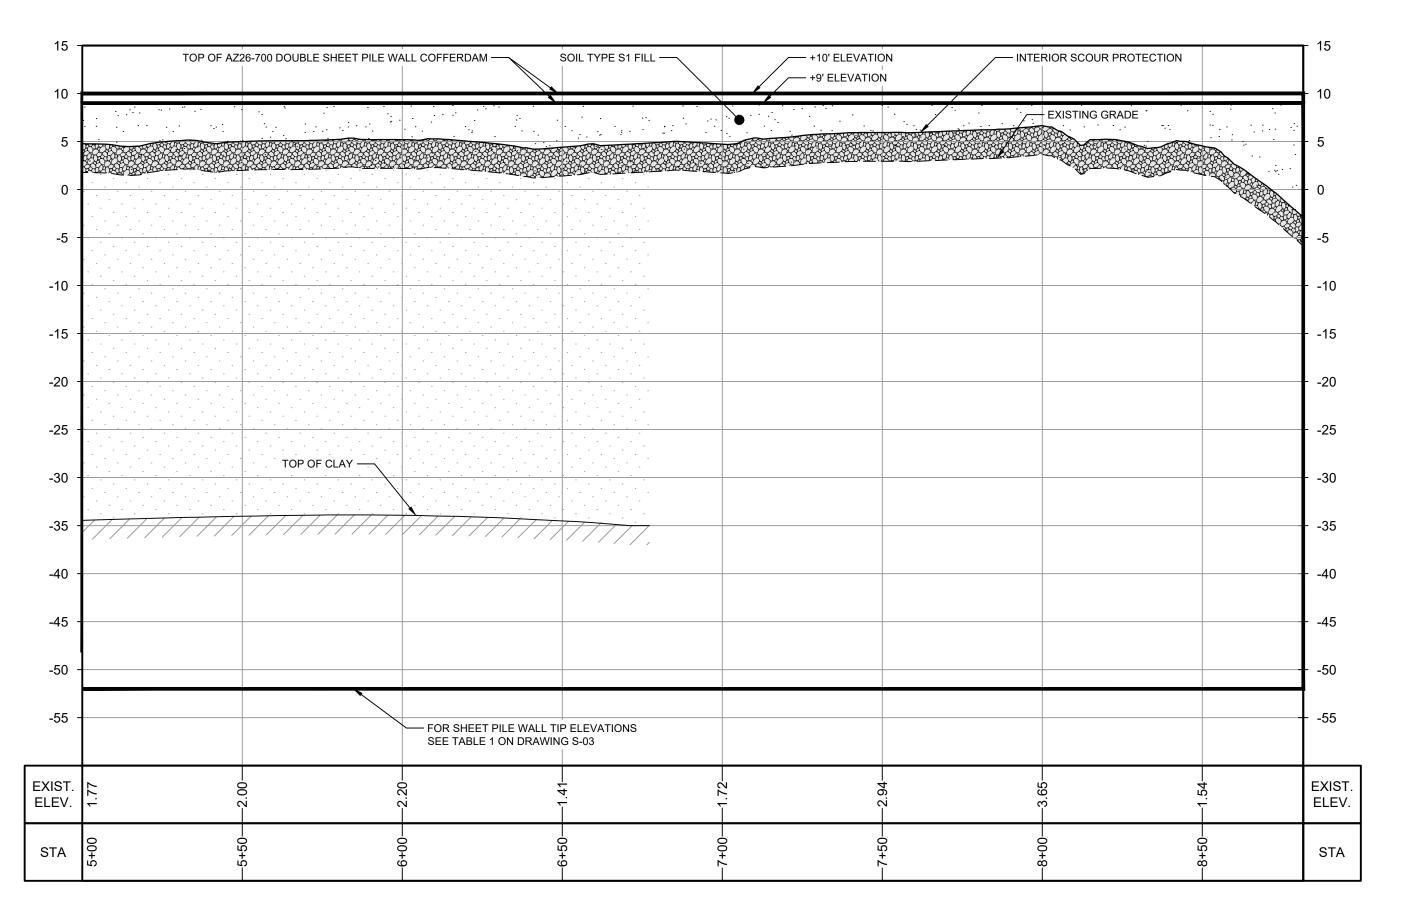


**PROFILE** HORIZ: 1" = 30' VERT: 1" = 10'

Plot Date: 25 November 2024 - 3:23 PM

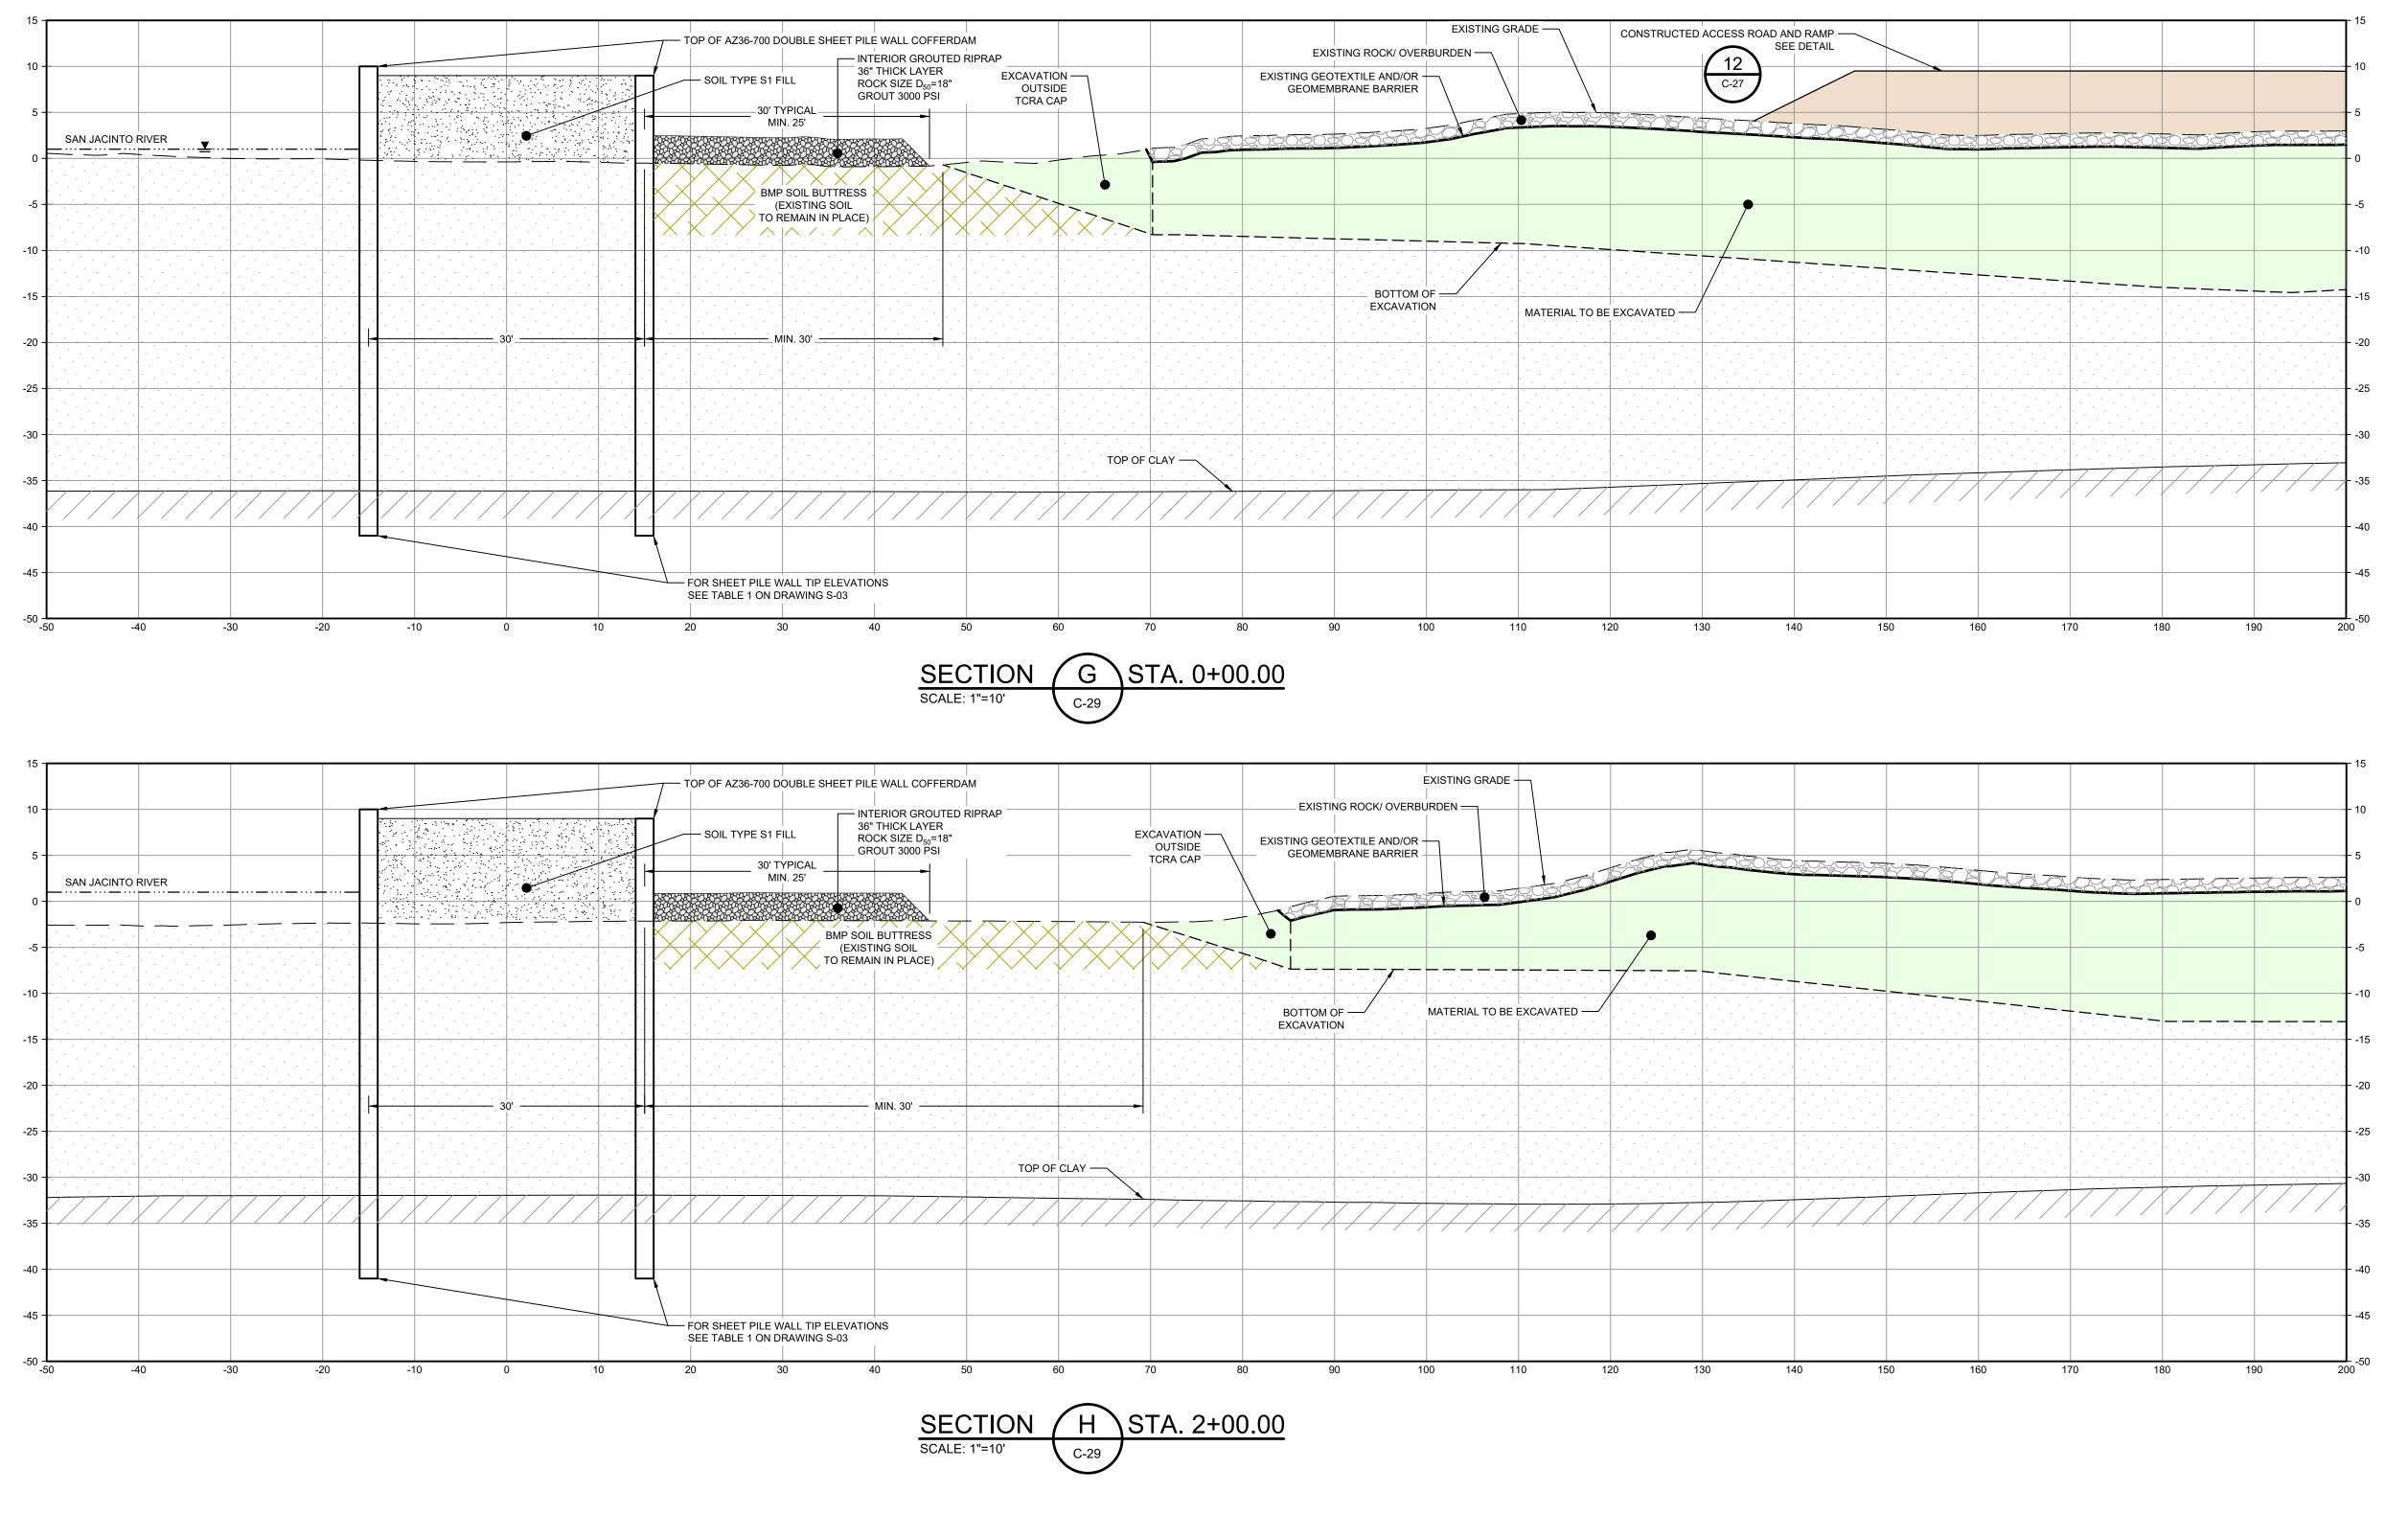

NOTES: 1. BOTTOM OF EXCAVATION IS SUBJECT TO CHANGE.

THIS DOCUMENT IS RELEASED FOR THE PURPOSE OF EPA REVIEW UNDER THE AUTHORITY OF CLARENCE R. HOEKSTRA, P.E. 147936 ON 11/25/2024. IT IS NOT TO BE USED FOR CONSTRUCTION, BIDDING, RECORDATION, CONVEYANCE OR SALES PURPOSES.

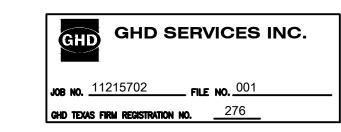

**100% EPA SUBMITTAL** 




2237 S Acadian Thruway Suite 701 Baton Rouge Louisiana 70808 USA **T** 225 292 9007



Reuse of Documents

This document and the ideas and designs incorporated herein, as an instrument of professional service, is the property of GHD and shall not be reused in whole or in part for any other project without GHD's written authorization. © 2024 GHD

<u>LEGEND</u>

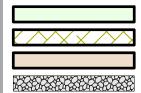

MATERIAL TO BE EXCAVATED BMP SOIL BUTTRESS (EXISTING SOIL TO REMAIN IN PLACE) PLANNED IMPROVEMENTS FOR NORTHERN IMPOUNDMENT ACCESS INTERIOR SCOUR PROTECTION

## **SAN JACINTO RIVER WASTE PITS**

NORTHERN IMPOUNDMENT FINAL 100% REMEDIAL DESIGN HARRIS COUNTY, TEXAS

	5	100% EPA SUBMITTAL	JC	CRH	11/25
	4	FOR CLIENT REVIEW	JC	CRH	11/21
	3	100% EPA SUBMITTAL	MW	CRH	07/17
	No.	Issue	Drawn	Approved	Da
ı	Draw	n <b>JC</b>	Designer	RH	
	Drafting BS Check		Design Check	LL	
	Proje Coor	ct dinator	Date	Nov 25, 20	024
		document shall not be used for uction unless signed and sealed for	Scale	1" = 10'	

Original Size Arch D

construction.

Bar is one inch on original size drawing


Project No. **11215702** 

DOUBLE PILE WALL SECTIONS 1 OF 7

Sheet No.

C-35

Sheet **36** of **83** 

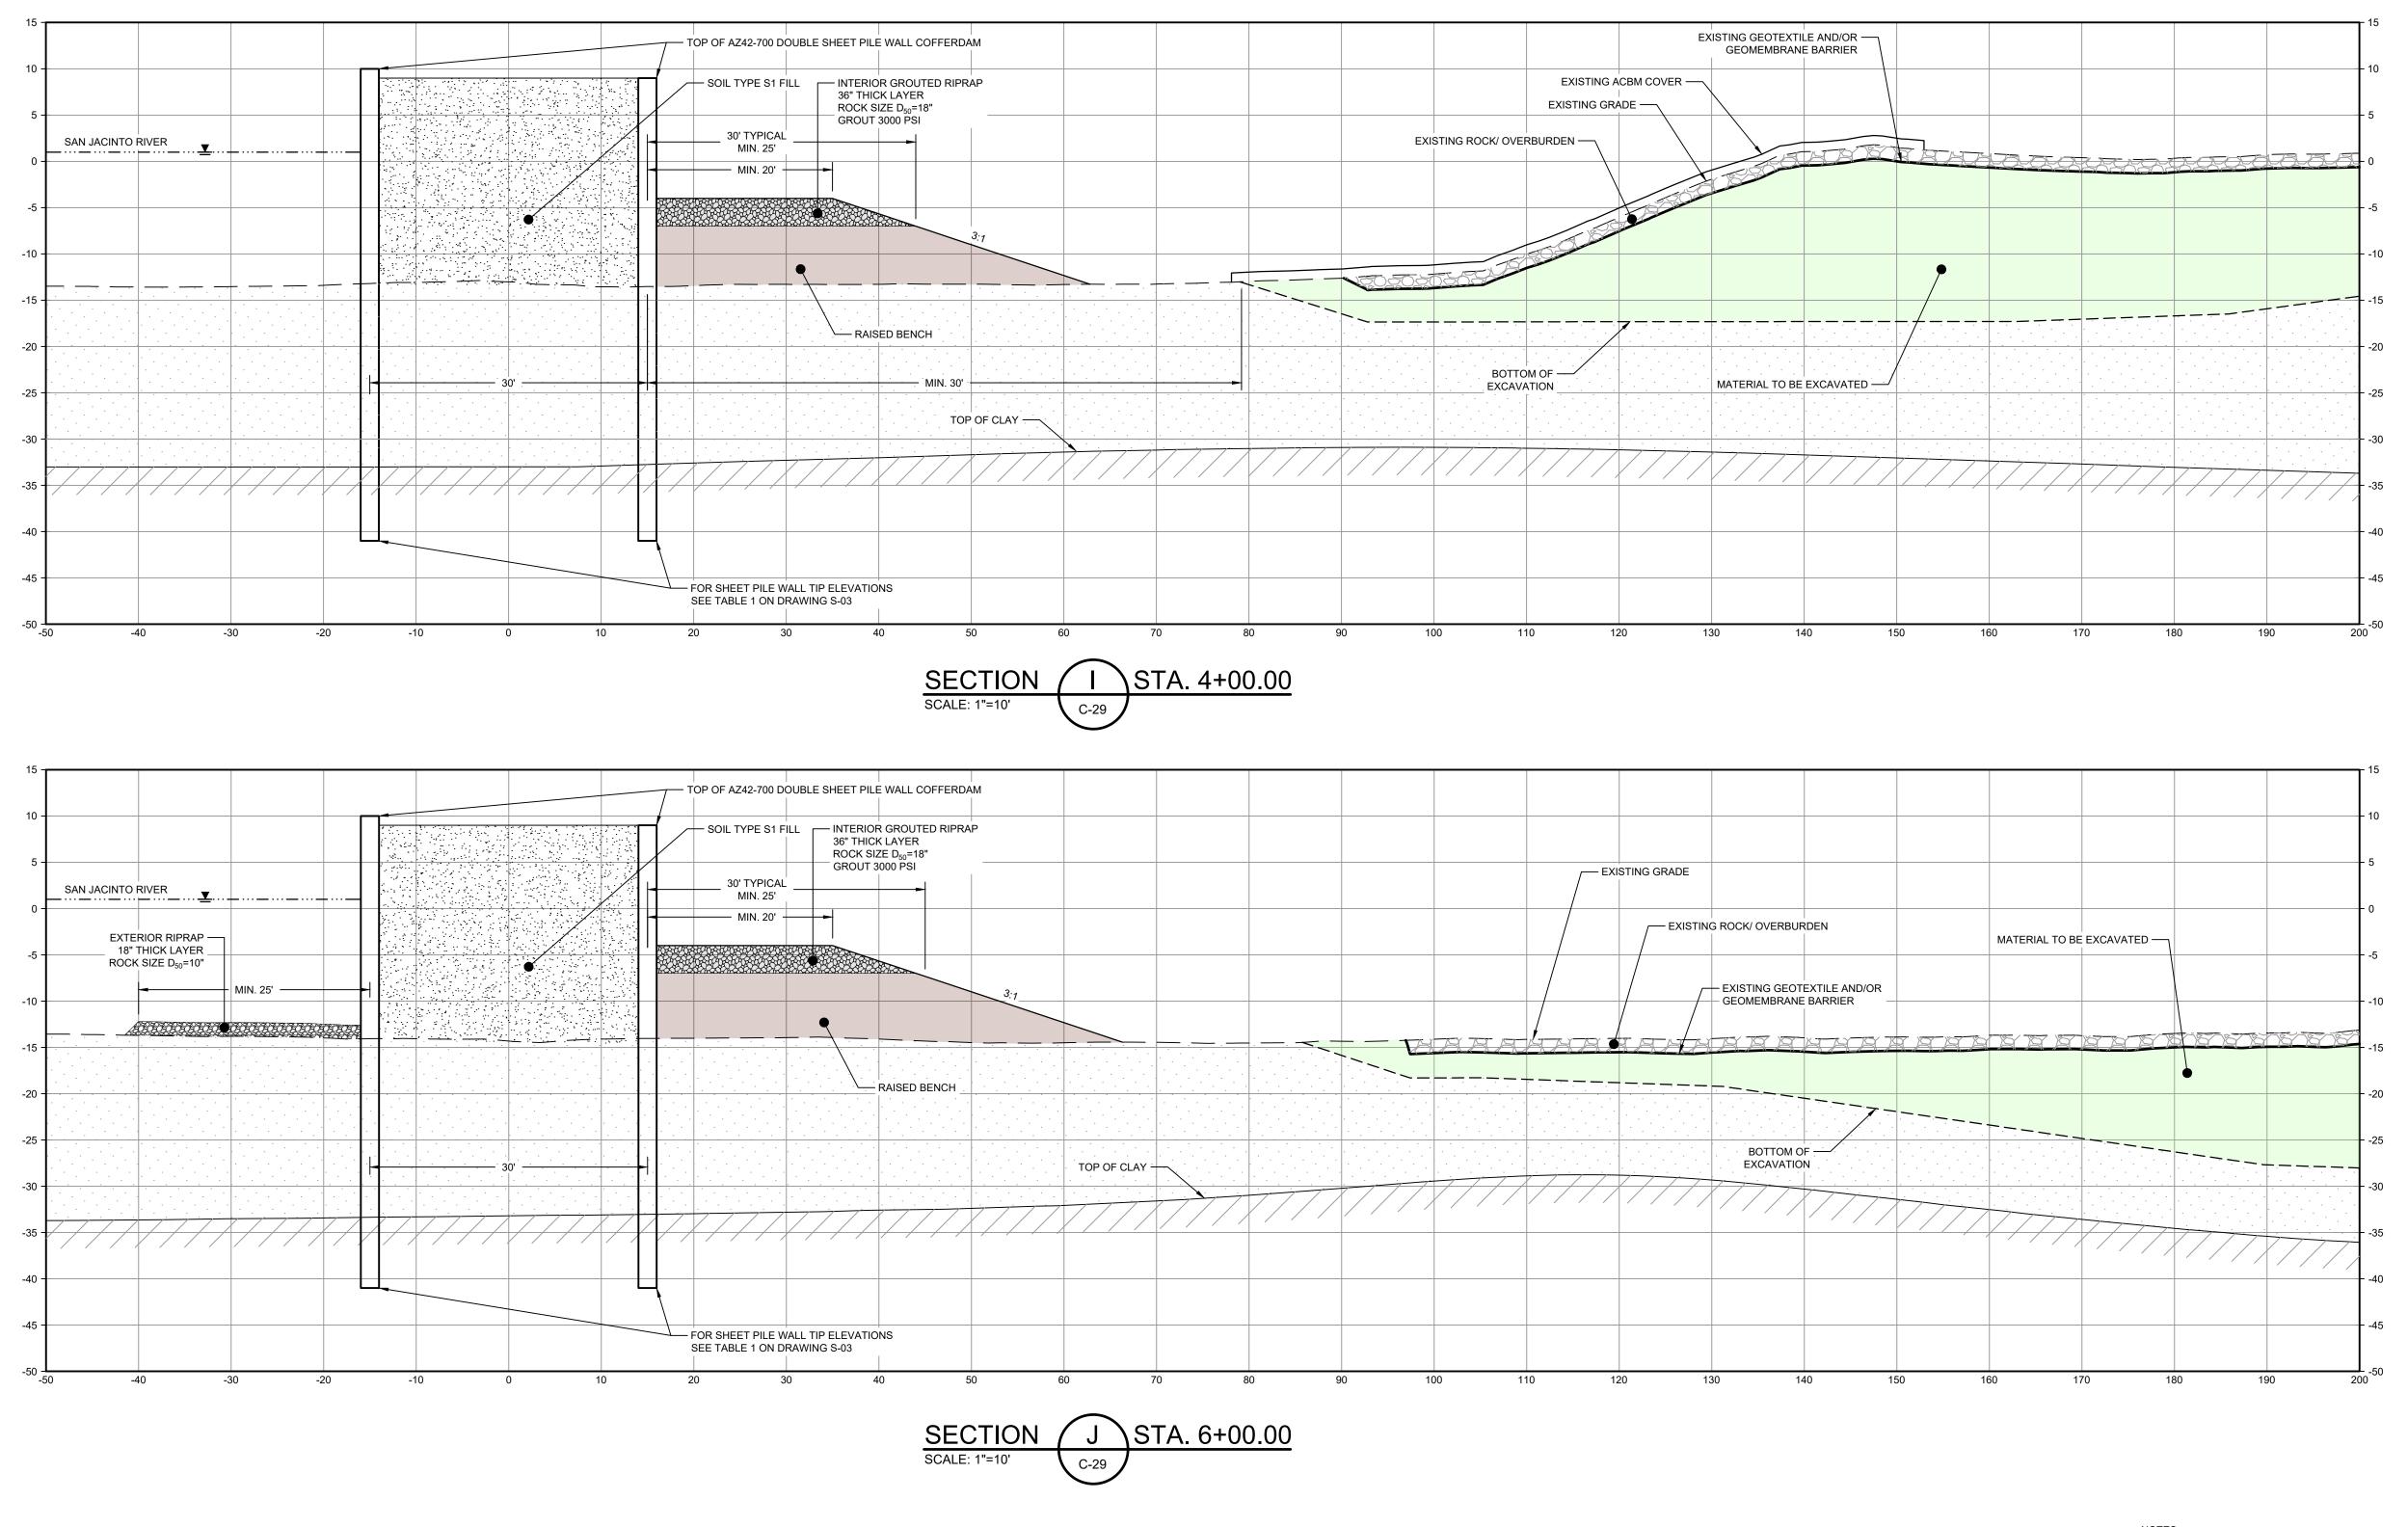

1. BOTTOM OF EXCAVATION IS SUBJECT TO CHANGE. 2. FRP BARRIER WALL NOT SHOWN FOR CLARITY.

THIS DOCUMENT IS RELEASED FOR THE PURPOSE OF EPA REVIEW UNDER THE AUTHORITY OF CLARENCE R. HOEKSTRA, P.E. 147936 ON 11/25/2024. IT IS NOT TO BE USED FOR CONSTRUCTION, BIDDING, RECORDATION, CONVEYANCE OR SALES PURPOSES.



**100% EPA SUBMITTAL** 




2237 S Acadian Thruway Suite 701 Baton Rouge Louisiana 70808 USA **T** 225 292 9007



Reuse of Documents

This document and the ideas and designs incorporated herein, as an instrument of professional service, is the property of GHD and shall not be reused in whole or in part for any other project without GHD's written authorization. © 2024 GHD

<u>LEGEND</u>

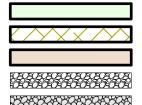

MATERIAL TO BE EXCAVATED BMP SOIL BUTTRESS (EXISTING SOIL TO REMAIN IN PLACE) PLANNED IMPROVEMENTS FOR NORTHERN IMPOUNDMENT ACCESS EXTERIOR SCOUR PROTECTION INTERIOR SCOUR PROTECTION

**SAN JACINTO RIVER WASTE PITS** 

NORTHERN IMPOUNDMENT FINAL 100% REMEDIAL DESIGN HARRIS COUNTY, TEXAS

6	100%	EPA SUBMITTAL	JC	CRH	11/25/
5	FOR C	LIENT REVIEW	JC	CRH	11/21/
4	100%	EPA SUBMITTAL	MW	CRH	07/17/
No.		Issue	Drawn	Approved	Da
Draw	Drawn <b>JC</b>		Designer	RH	
Drafting BS Check		BS	Design Check	LL	
Proje Coore	ct dinator	СМ	Date	Nov 25, 20	024

Original Size

Bar is one inch on original size drawing Arch D

This document shall not be used for construction unless signed and sealed for Scale 1" = 10'

Project No. **11215702** 


DOUBLE PILE WALL SECTIONS 2 OF 7

Sheet No.

**C-36** 

Sheet **37** of **83** 

Plot Date: 25 November 2024 - 3:24 PM

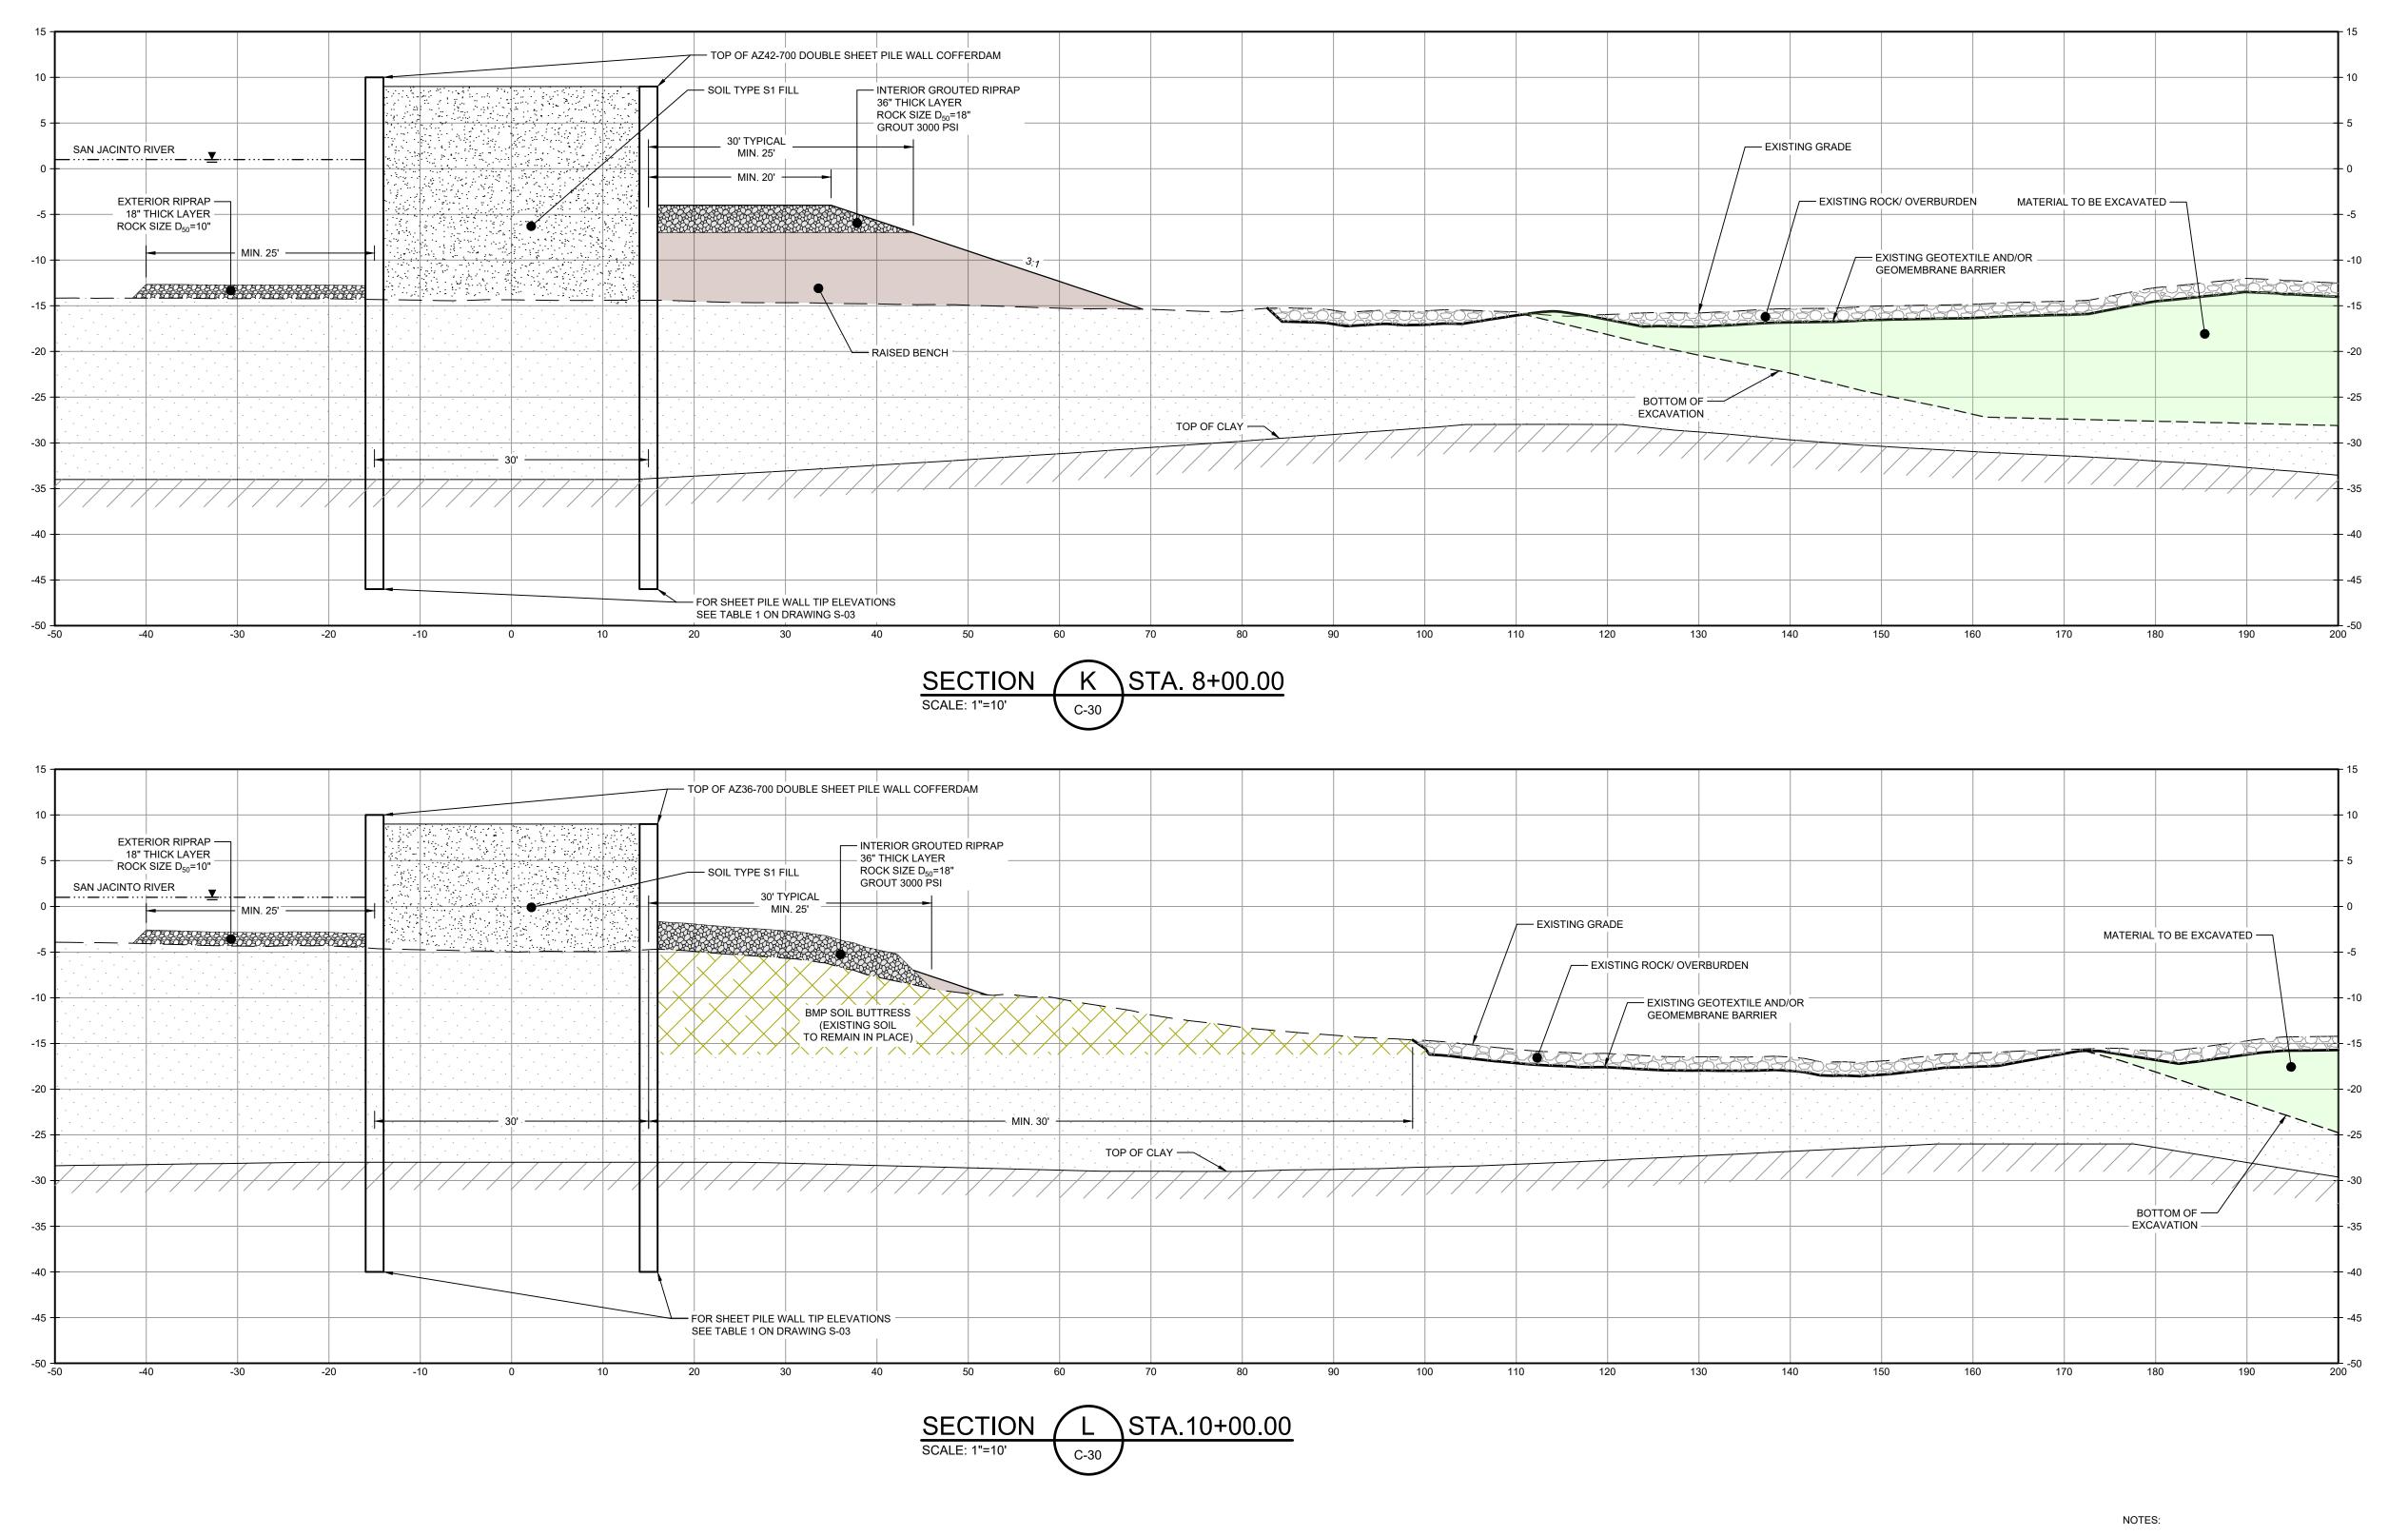

1. BOTTOM OF EXCAVATION IS SUBJECT TO CHANGE. 2. FRP BARRIER WALL NOT SHOWN FOR CLARITY.

THIS DOCUMENT IS RELEASED FOR THE PURPOSE OF EPA REVIEW UNDER THE AUTHORITY OF CLARENCE R. HOEKSTRA, P.E. 147936 ON 11/25/2024. IT IS NOT TO BE USED FOR CONSTRUCTION, BIDDING, RECORDATION, CONVEYANCE OR SALES PURPOSES.



**100% EPA SUBMITTAL** 




2237 S Acadian Thruway Suite 701 Baton Rouge Louisiana 70808 USA **T** 225 292 9007



Reuse of Documents

This document and the ideas and designs incorporated herein, as an instrument of professional service, is the property of GHD and shall not be reused in whole or in part for any other project without GHD's written authorization. © 2024 GHD

<u>LEGEND</u>

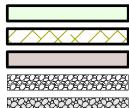

MATERIAL TO BE EXCAVATED BMP SOIL BUTTRESS (EXISTING SOIL TO REMAIN IN PLACE) RAISED BENCH

EXTERIOR SCOUR PROTECTION INTERIOR SCOUR PROTECTION

Client

## **SAN JACINTO RIVER WASTE PITS**

## NORTHERN IMPOUNDMENT FINAL 100% REMEDIAL DESIGN HARRIS COUNTY, TEXAS

6	100%	EPA SUBMITTAL		JC	CRH	11/25/2
5	FOR C	LIENT REVIEW		JC	CRH	11/21/2
4	100%	EPA SUBMITTAL		MW	CRH	07/17/2
No.		Issue		Drawn	Approved	Dat
Draw	Drawn <b>JC</b>		Designer	RH		
Drafting Check		BS		Design Check	LL	
Proje Coor	ct dinator	CM		Date	Nov 25, 20	024

This document shall not be used for construction unless signed and sealed for Scale 1" = 10'

Original Size

Bar is one inch on original size drawing Arch D

Project No. **11215702** 


DOUBLE PILE WALL SECTIONS 3 OF 7

Sheet No.

C-37


Sheet **38** of **83** 

Plot Date: 25 November 2024 - 3:24 PM

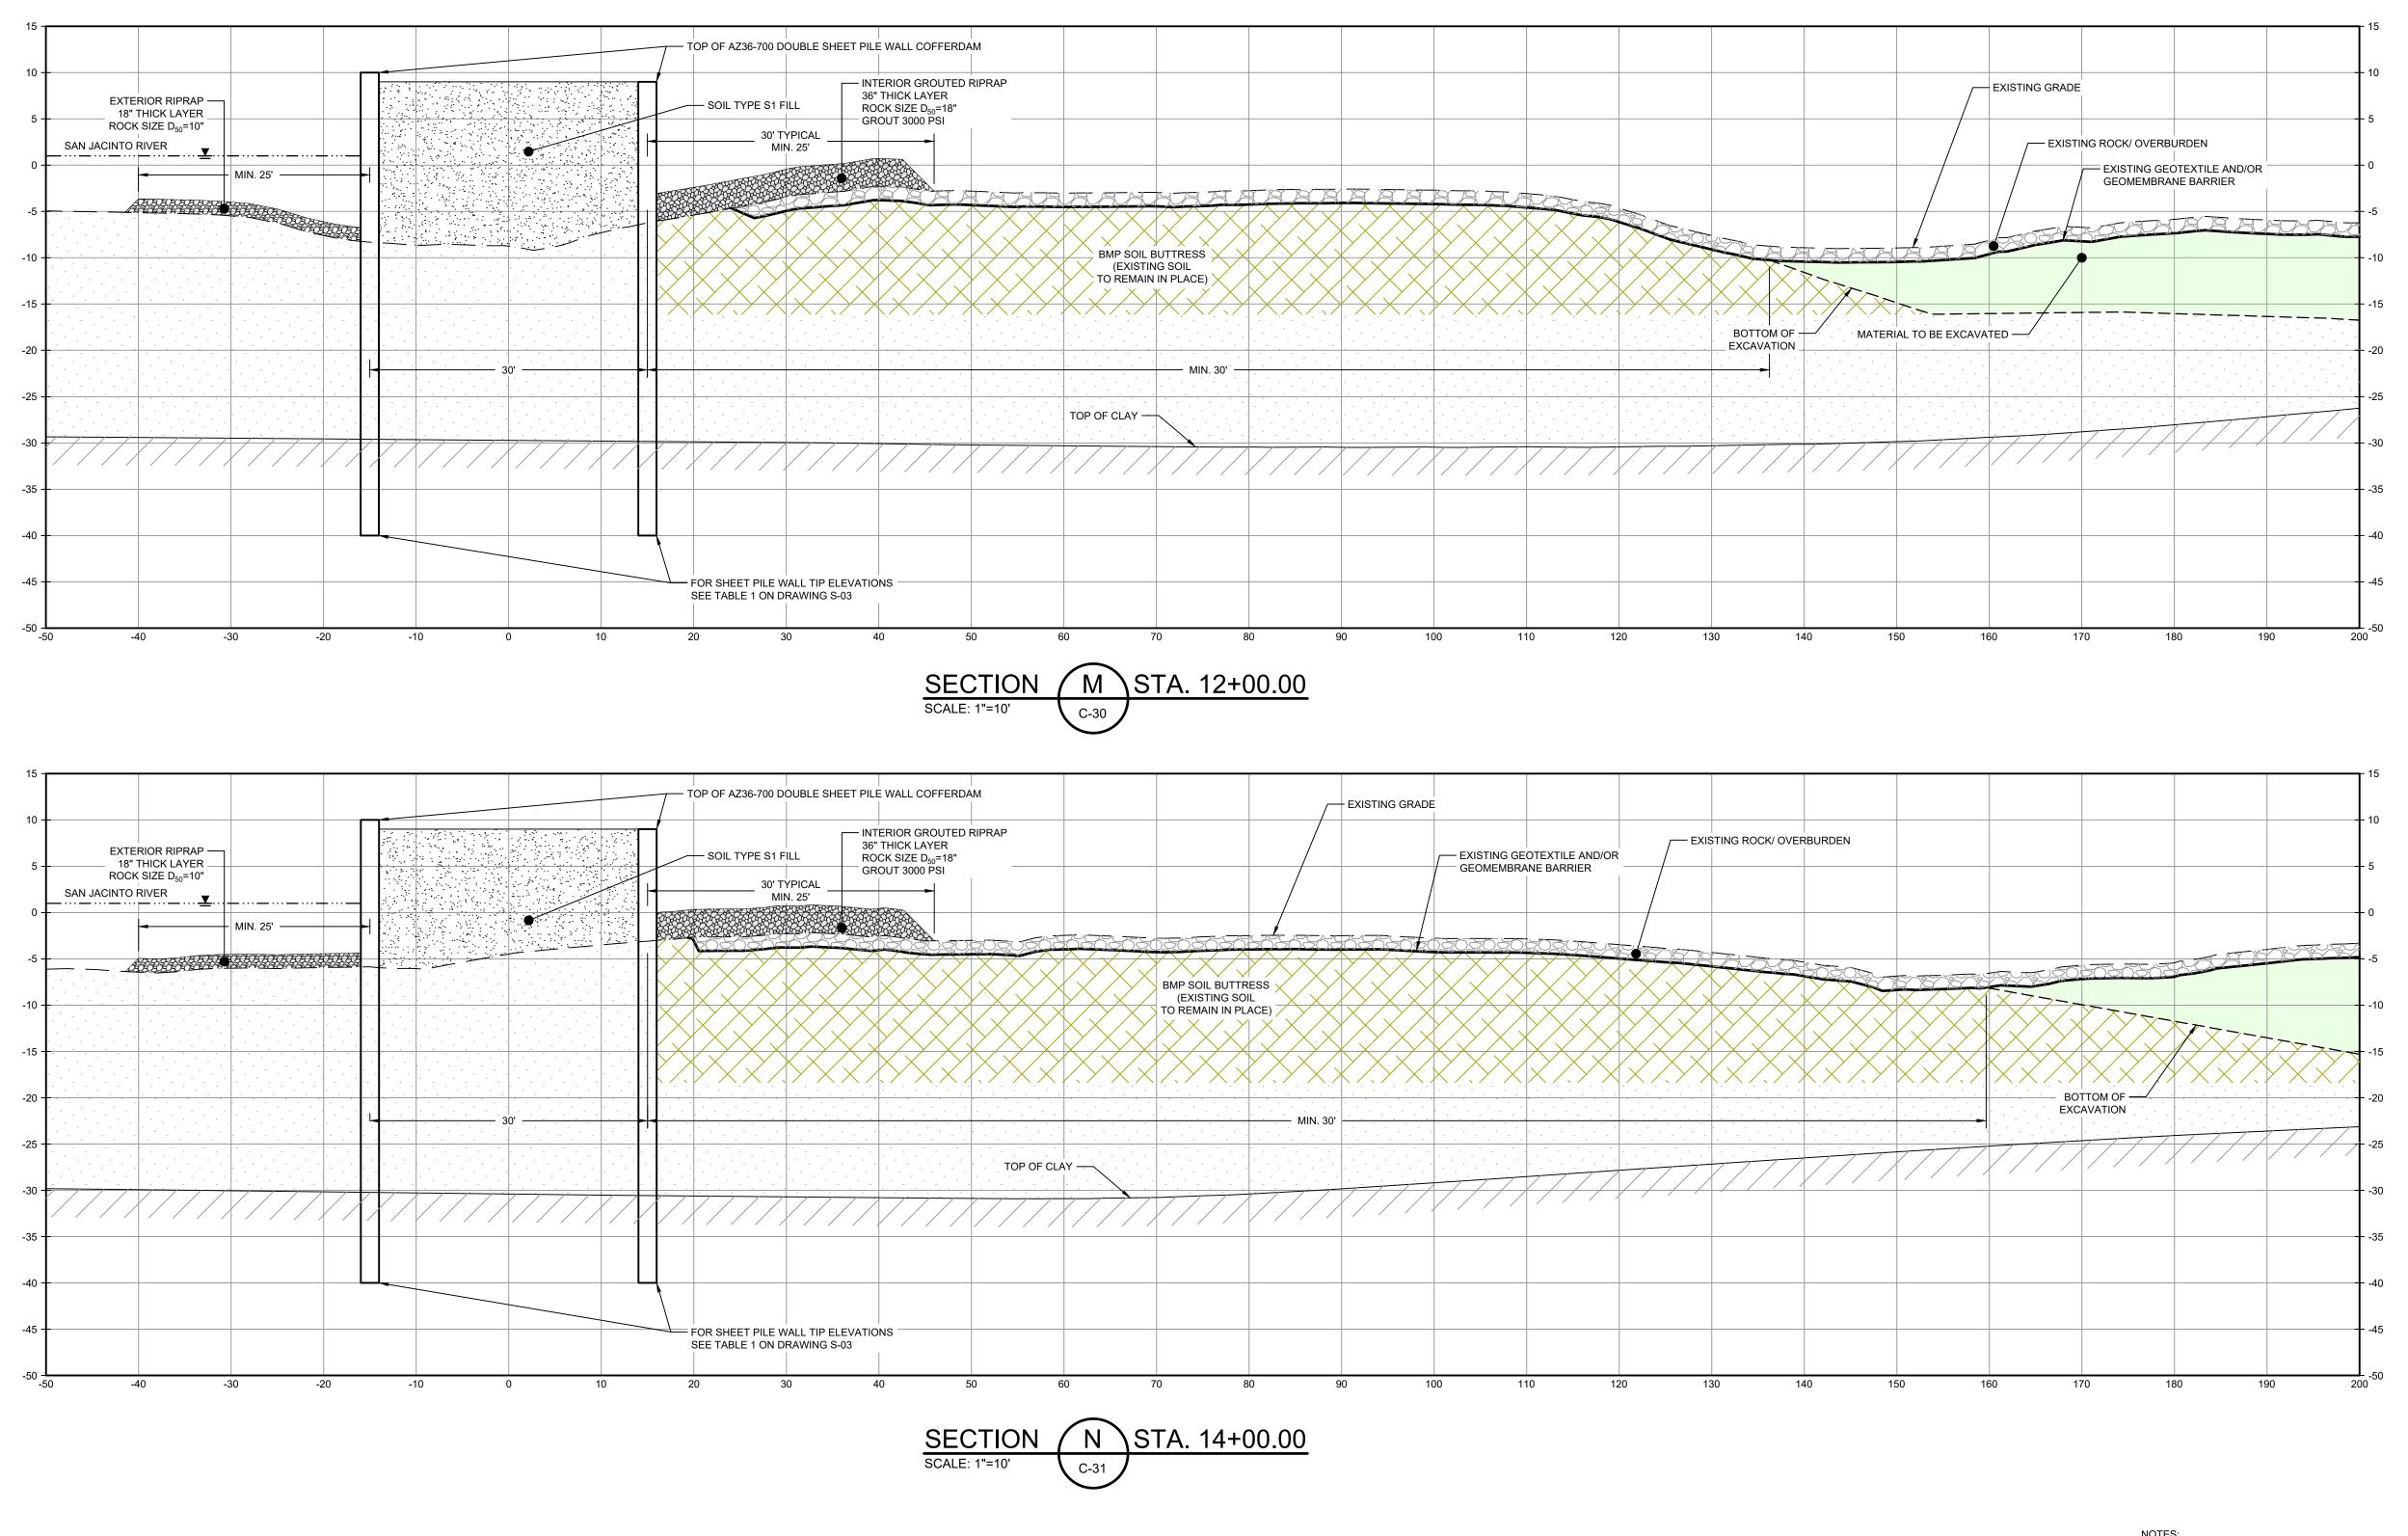

1. BOTTOM OF EXCAVATION IS SUBJECT TO CHANGE. 2. FRP BARRIER WALL NOT SHOWN FOR CLARITY.

THIS DOCUMENT IS RELEASED FOR THE PURPOSE OF EPA REVIEW UNDER THE AUTHORITY OF CLARENCE R. HOEKSTRA, P.E. 147936 ON 11/25/2024. IT IS NOT TO BE USED FOR CONSTRUCTION, BIDDING, RECORDATION, CONVEYANCE OR SALES PURPOSES.

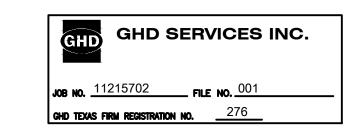

100% EPA SUBMITTAL



2237 S Acadian Thruway Suite 701 Baton Rouge Louisiana 70808 USA **T** 225 292 9007



Reuse of Documents

This document and the ideas and designs incorporated herein, as an instrument of professional service, is the property of GHD and shall not be reused in whole or in part for any other project without GHD's written authorization. © 2024 GHD

<u>LEGEND</u>

MATERIAL TO BE EXCAVATED BMP SOIL BUTTRESS (EXISTING SOIL TO REMAIN IN PLACE) EXTERIOR SCOUR PROTECTION INTERIOR SCOUR PROTECTION

## **SAN JACINTO RIVER WASTE PITS**

## NORTHERN IMPOUNDMENT FINAL 100% REMEDIAL DESIGN HARRIS COUNTY, TEXAS

5	100% EPA SUBMITTAL	JC	CRH	11/25/202	
4	FOR CLIENT REVIEW	JC	CRH	11/21/202	
3	100% EPA SUBMITTAL	MW	CRH	07/17/202	
No.	Issue	Drawn	Approved	Date	
Draw	n <b>JC</b>	Designer	RH		
	Drafting BS Check		LL		
Proje Coor	ct dinator	Date	Nov 25, 20	)24	

This document shall not be used for construction unless signed and sealed for Scale 1" = 10'

Original Size

Bar is one inch on original size drawing Arch D


Project No. **11215702** 

DOUBLE PILE WALL SECTIONS 4 OF 7

Sheet No.

**C-38** 

Sheet **39** of **83** 

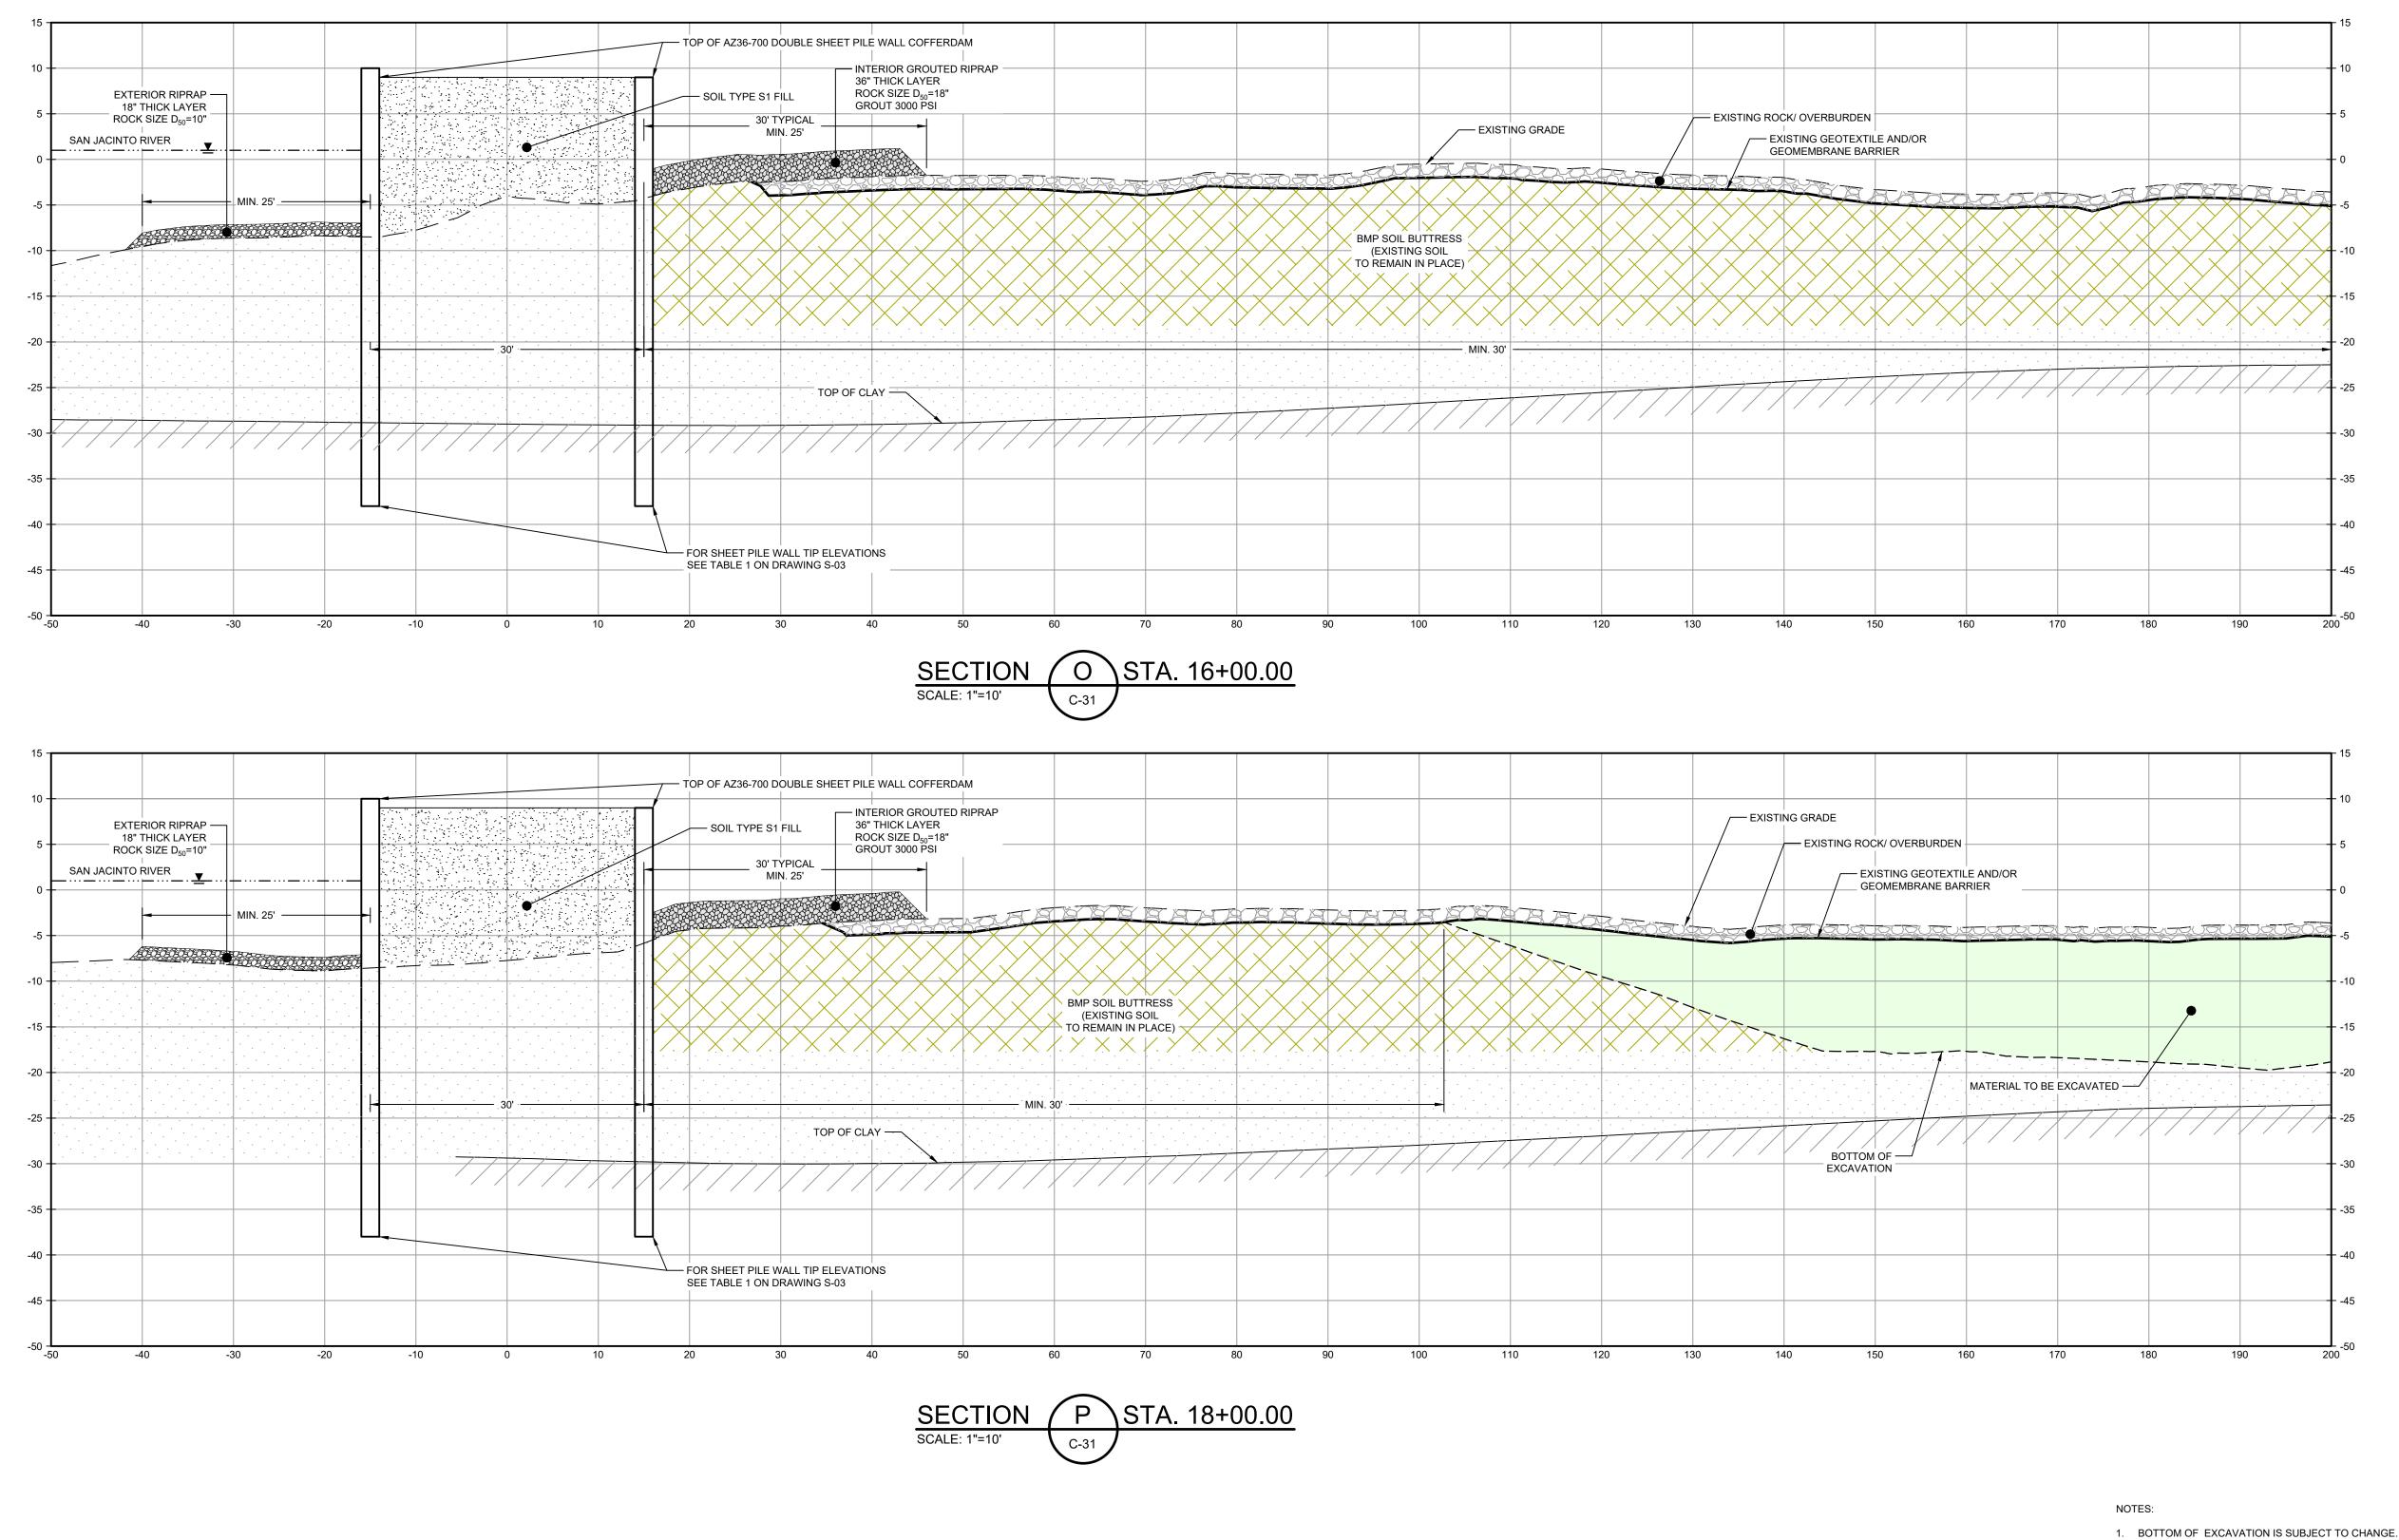

GHD

2237 S Acadian Thruway Suite 701 Baton Rouge Louisiana 70808 USA T 225 292 9007



Reuse of Documents

This document and the ideas and designs incorporated herein, as an instrument of professional service, is the property of GHD and shall not be reused in whole or in part for any other project without GHD's written authorization. © 2024 GHD

<u>LEGEND</u>

MATERIAL TO BE EXCAVATED
BMP SOIL BUTTRESS (EXISTING SOIL
TO REMAIN IN PLACE)
EXTERIOR SCOUR PROTECTION
INTERIOR SCOUR PROTECTION

Cilei

## SAN JACINTO RIVER WASTE PITS

NORTHERN IMPOUNDMENT FINAL 100% REMEDIAL DESIGN HARRIS COUNTY, TEXAS

1						
	5	100% EPA SUBMITTAL	JC	CRH	11/25/202	
	4	FOR CLIENT REVIEW	JC	CRH	11/21/202	
	3	100% EPA SUBMITTAL	MW	CRH	07/17/202	
	No.	Issue	Drawn	Approved	Date	
	Draw	rn <b>JC</b>	Designer	RH		
	Drafting BS Check		Design Check	LL		
	Proje Coor	ct dinator	Date	Nov 25, 20	024	

Original Size

Arch D

Bar is one inch on original size drawing

0

This document shall not be used for construction unless signed and sealed for Scale 1" = 10'

Project No. **11215702** 

Title

DOUBLE PILE WALL SECTIONS 5 OF 7


Sheet No.

C-39

Sheet **40** of **83** 


2. FRP BARRIER WALL NOT SHOWN FOR CLARITY.

THIS DOCUMENT IS RELEASED FOR THE PURPOSE OF EPA REVIEW UNDER THE AUTHORITY OF CLARENCE R. HOEKSTRA, P.E. 147936 ON 11/25/2024. IT IS NOT TO BE USED FOR CONSTRUCTION, BIDDING, RECORDATION, CONVEYANCE OR SALES PURPOSES.

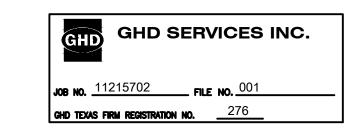


**100% EPA SUBMITTAL** 

Plot Date: 25 November 2024 - 3:24 PM

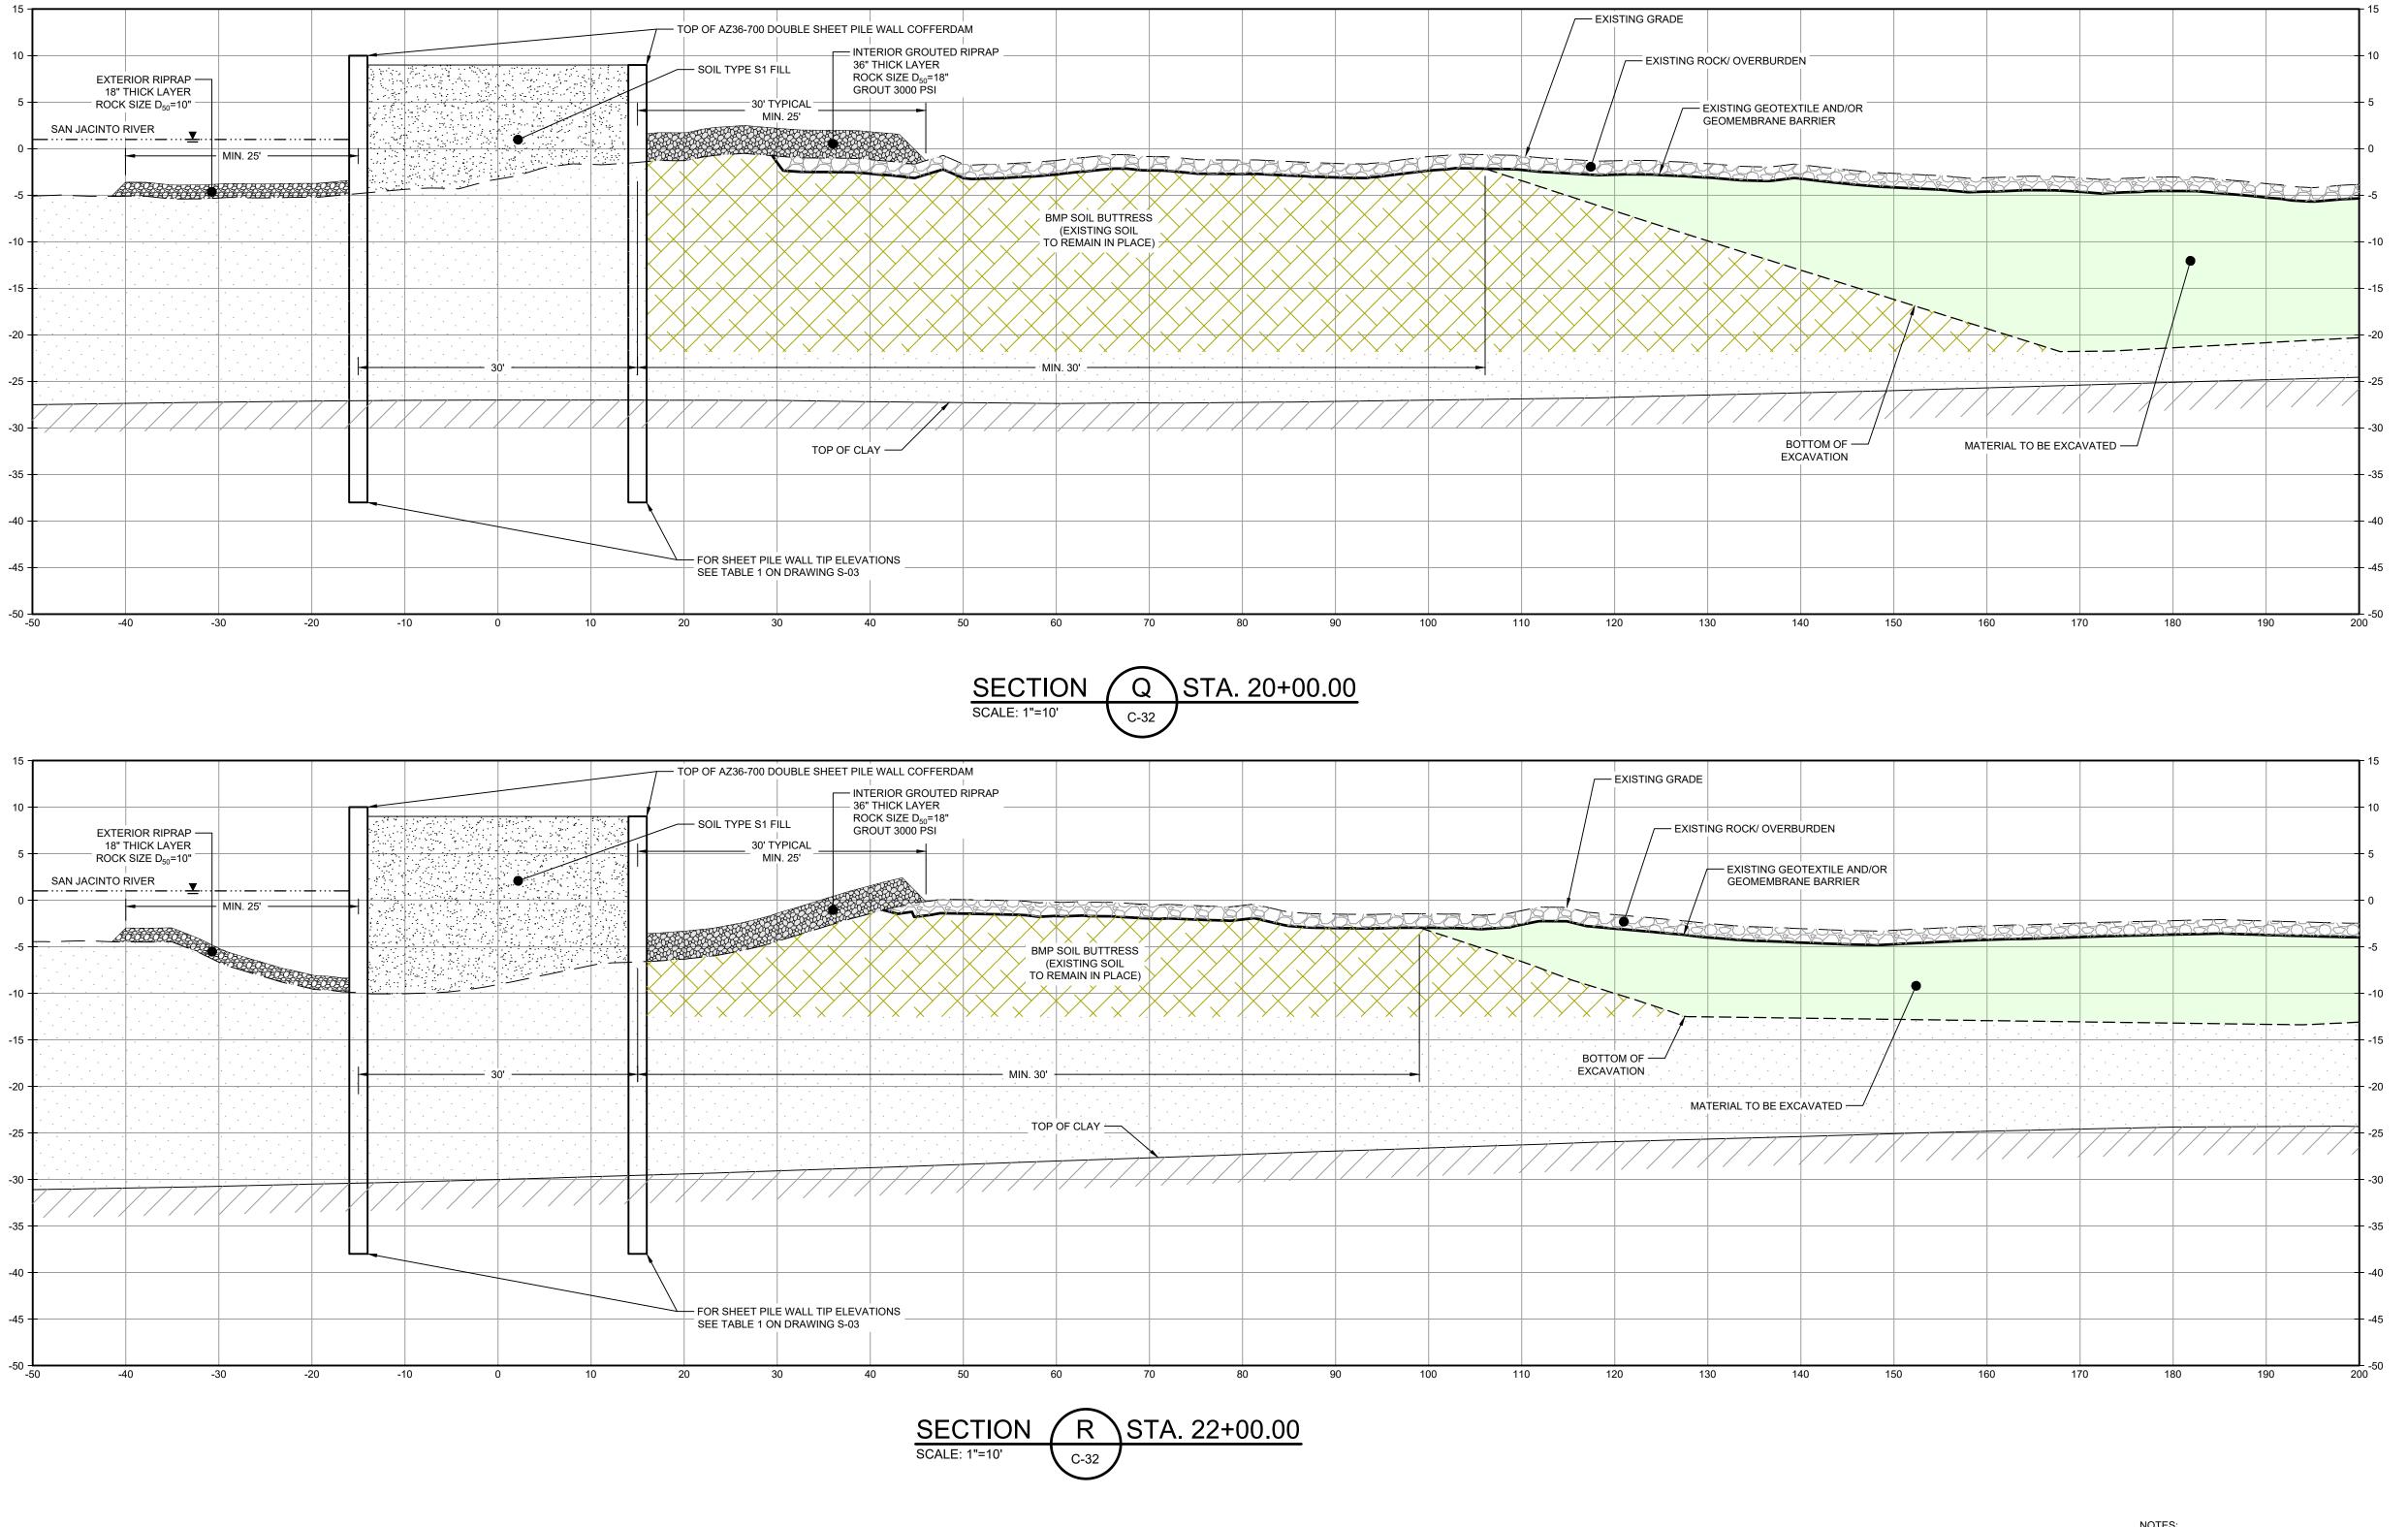

1. BOTTOM OF EXCAVATION IS SUBJECT TO CHANGE. 2. FRP BARRIER WALL NOT SHOWN FOR CLARITY.

THIS DOCUMENT IS RELEASED FOR THE PURPOSE OF EPA REVIEW UNDER THE AUTHORITY OF CLARENCE R. HOEKSTRA, P.E. 147936 ON 11/25/2024. IT IS NOT TO BE USED FOR CONSTRUCTION, BIDDING, RECORDATION, CONVEYANCE OR SALES PURPOSES.

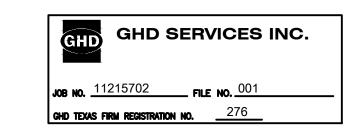

**100% EPA SUBMITTAL** 



2237 S Acadian Thruway Suite 701 Baton Rouge Louisiana 70808 USA **T** 225 292 9007



Reuse of Documents

This document and the ideas and designs incorporated herein, as an instrument of professional service, is the property of GHD and shall not be reused in whole or in part for any other project without GHD's written authorization. © 2024 GHD

<u>LEGEND</u>

MATERIAL TO BE EXCAVATED BMP SOIL BUTTRESS (EXISTING SOIL TO REMAIN IN PLACE) EXTERIOR SCOUR PROTECTION INTERIOR SCOUR PROTECTION

## **SAN JACINTO RIVER WASTE PITS**

NORTHERN IMPOUNDMENT FINAL 100% REMEDIAL DESIGN HARRIS COUNTY, TEXAS

5	100% EPA SUBMITTAL	JC	CRH	11/25
4	FOR CLIENT REVIEW	JC	CRH	11/21
3	100% EPA SUBMITTAL	MW	CRH	07/17
No.	Issue	Drawn	Approved	Da
Draw	rn <b>JC</b>	Designer	RH	
Drafti Chec	° В5	Design Check	LL	
Proje Coor	ct dinator	Date	Nov 25, 20	024
	document shall not be used for uction unless signed and sealed for	Scale	1" = 10'	

Original Size

construction.

original size drawing Arch D

Project No. **11215702** 


DOUBLE PILE WALL SECTIONS 6 OF 7

Sheet No.

C-40


Sheet **41** of **83** 

Bar is one inch on

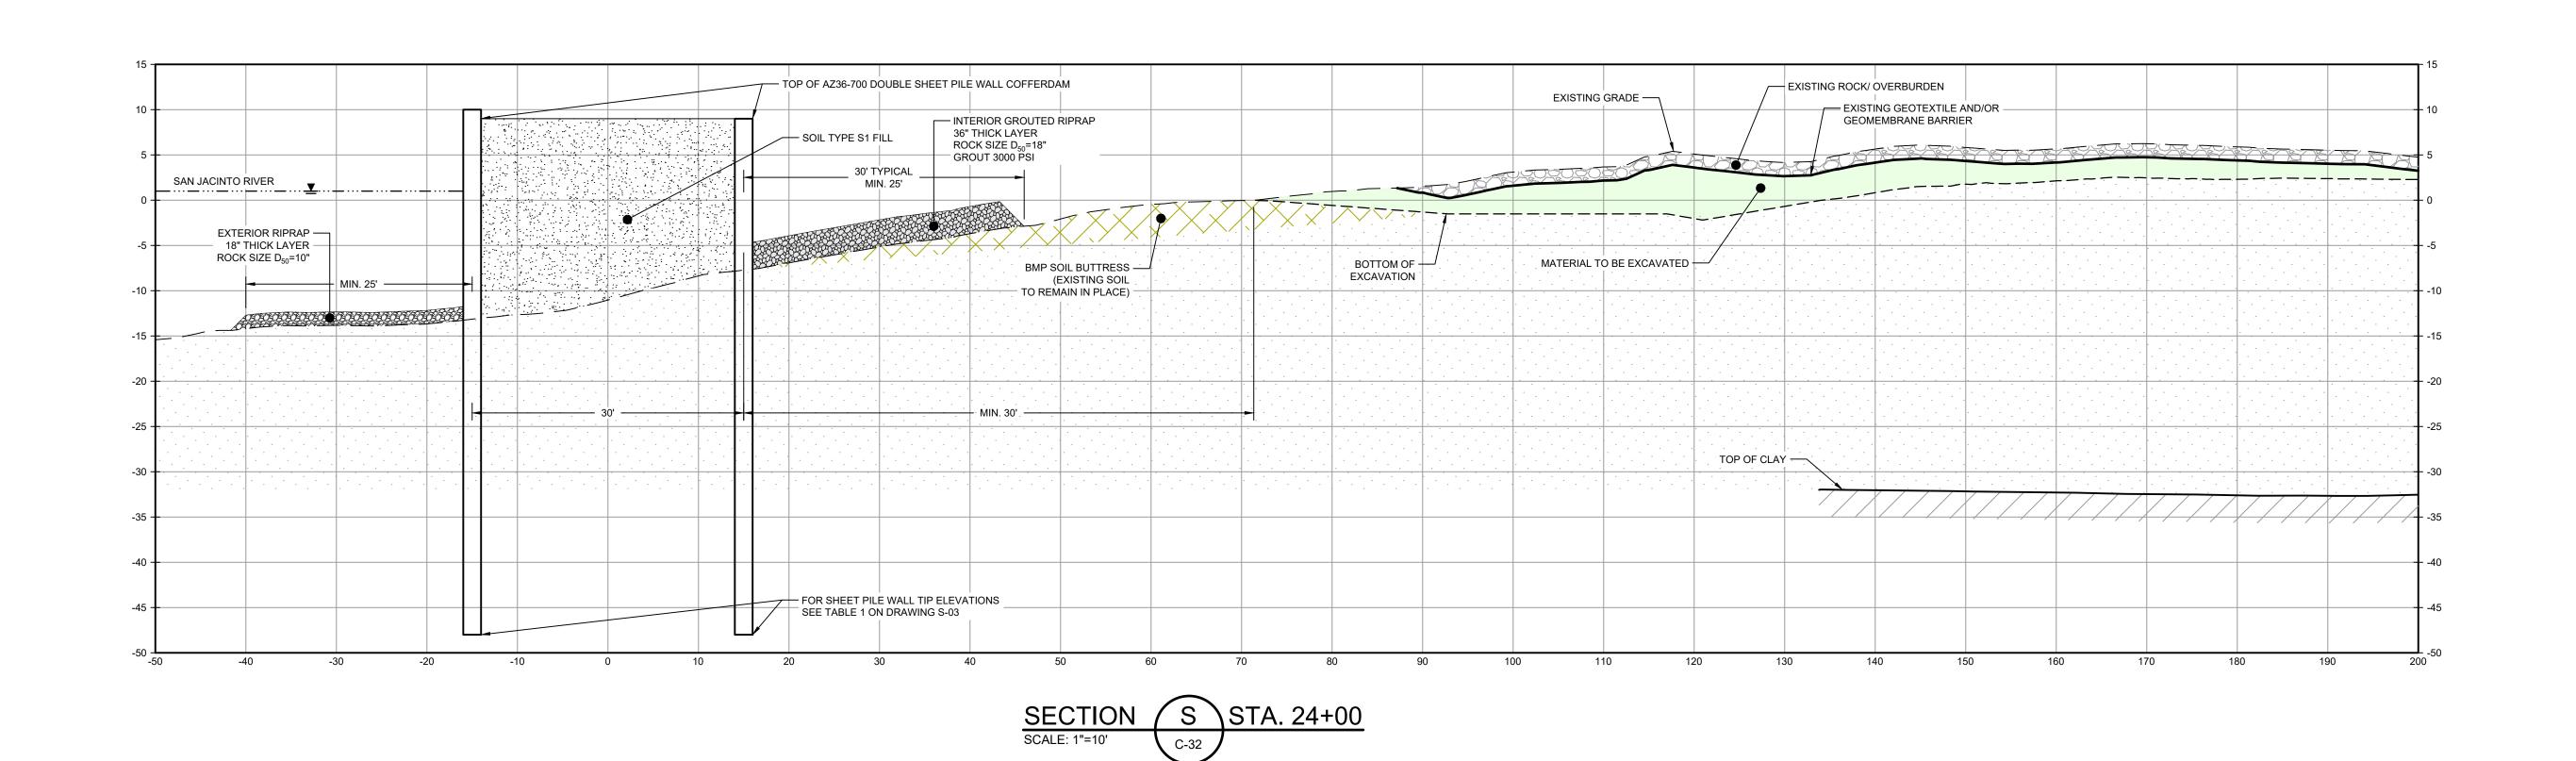

BOTTOM OF EXCAVATION IS SUBJECT TO CHANGE.
 FRP BARRIER WALL NOT SHOWN FOR CLARITY.

THIS DOCUMENT IS RELEASED FOR THE PURPOSE OF EPA REVIEW UNDER THE AUTHORITY OF CLARENCE R. HOEKSTRA, P.E. 147936 ON 11/25/2024. IT IS NOT TO BE USED FOR CONSTRUCTION, BIDDING, RECORDATION, CONVEYANCE OR SALES PURPOSES.

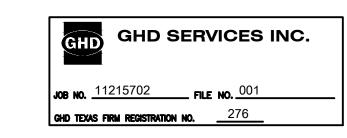

100% EPA SUBMITTAL



GHD
2237 S Acadian Thruway Suite 701
Baton Rouge Louisiana 70808 USA
T 225 292 9007



Reuse of Documents

This document and the ideas and designs incorporated herein, as an instrument of professional service, is the property of GHD and shall not be reused in whole or in part for any other project without GHD's written authorization. © 2024 GHD

<u>LEGEND</u>

MATERIAL TO BE EXCAVATED
BMP SOIL BUTTRESS (EXISTING SOIL
TO REMAIN IN PLACE)
EXTERIOR SCOUR PROTECTION
INTERIOR SCOUR PROTECTION

Clie

## SAN JACINTO RIVER WASTE PITS

NORTHERN IMPOUNDMENT
FINAL 100% REMEDIAL DESIGN
HARRIS COUNTY, TEXAS

5	100% EPA SUBMITTAL	JC	CRH	11/25/
4	FOR CLIENT REVIEW	JC	CRH	11/21/
3	100% EPA SUBMITTAL	MW	CRH	07/17/
No.	Issue	Drawn	Approved	Da
Draw	n <b>JC</b>	Designer	RH	
Drafti Chec	* B5	Design Check	LL	
Proje Coor	ct dinator	Date	Nov 25, 20	)24
	document shall not be used for uction unless signed and sealed for	Scale	1" = 10'	

Original Size

Arch D

Bar is one inch on original size drawing

0 1'

Project No. **11215702** 


Title


DOUBLE PILE WALL SECTIONS
7 OF 7


Sheet No.

C-41

Sheet **42** of **83** 

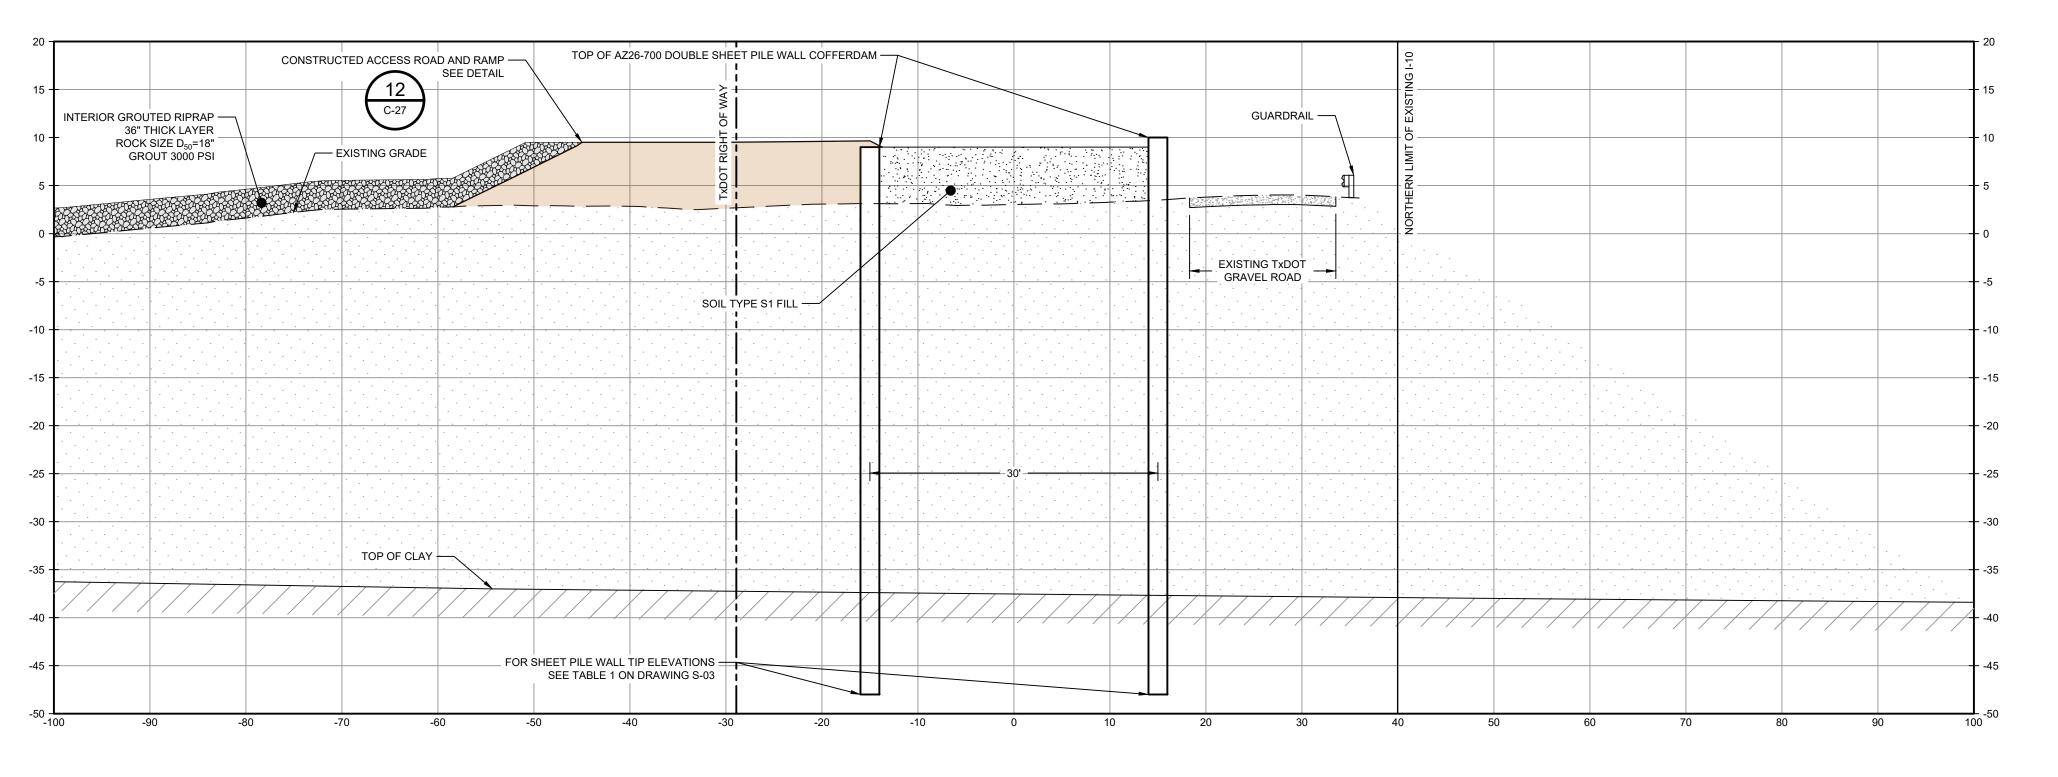

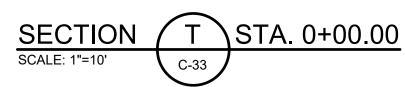

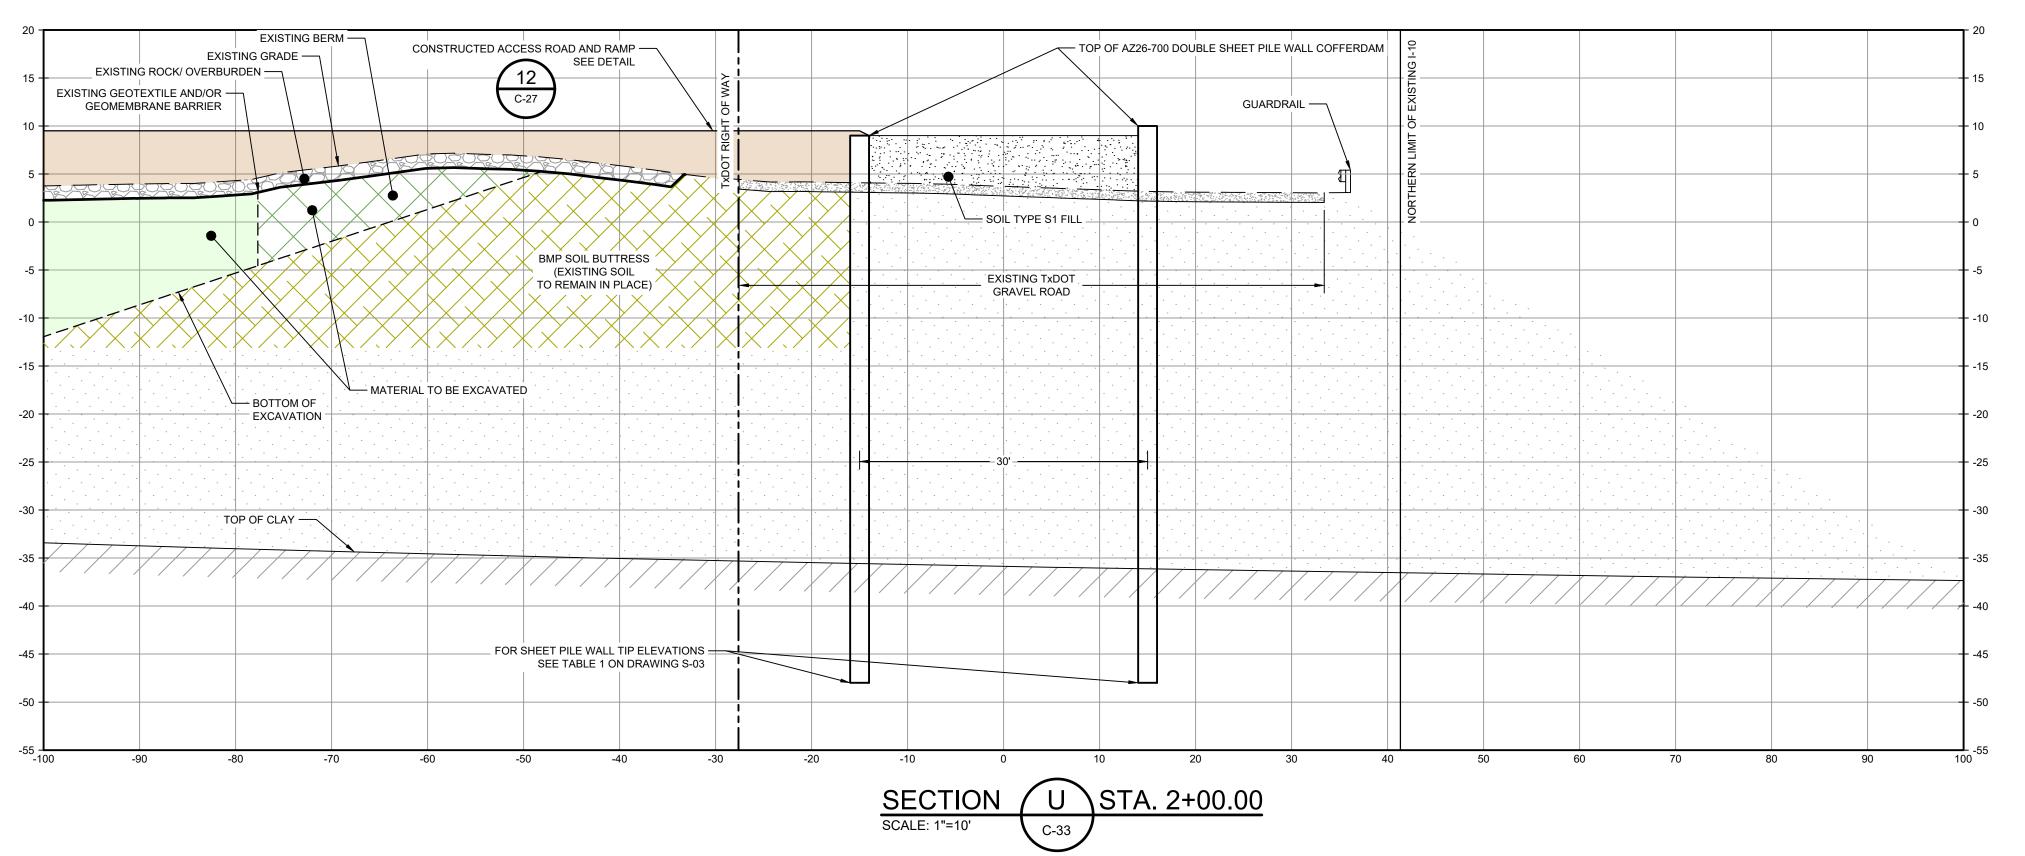


TXDOT RIGHT OF WAY FROM A BOUNDARY AND RIGHT-OF-WAY SURVEY OF PORT OF HOUSTON AUTHORITY PROPERTY & HOUSTON FLEETING SERVICES, LLC PROPERTY ALONG INTERSTATE HIGHWAY 10 AT THE SAN JACINTO FLEET AREA, IN THE J. T. HARRELL SURVEY, A-330 HARRIS COUNTY, TEXAS, COBBFENDLEY, 2402-028-01, JUNE 28, 2024

#### NOTES:

1. BOTTOM OF EXCAVATION IS SUBJECT TO CHANGE.

THIS DOCUMENT IS RELEASED FOR THE PURPOSE OF EPA REVIEW UNDER THE AUTHORITY OF CLARENCE R. HOEKSTRA, P.E. 147936 ON 11/25/2024. IT IS NOT TO BE USED FOR CONSTRUCTION, BIDDING, RECORDATION, CONVEYANCE OR SALES PURPOSES.

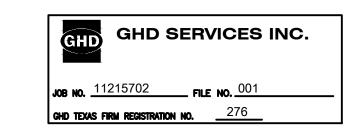

**100% EPA SUBMITTAL** 




2237 S Acadian Thruway Suite 701 Baton Rouge Louisiana 70808 USA **T** 225 292 9007



Reuse of Documents

This document and the ideas and designs incorporated herein, as an instrument of professional service, is the property of GHD and shall not be reused in whole or in part for any other project without GHD's written authorization. © 2024 GHD

<u>LEGEND</u>

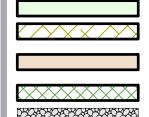

MATERIAL TO BE EXCAVATED BMP SOIL BUTTRESS (EXISTING SOIL TO REMAIN IN PLACE) PLANNED IMPROVEMENTS FOR NORTHERN IMPOUNDMENT ACCESS EXISTING BERM TO BE EXCAVATED FOR POTENTIAL TESTING AND REUSE INTERIOR SCOUR PROTECTION

## **SAN JACINTO RIVER WASTE PITS**

NORTHERN IMPOUNDMENT FINAL 100% REMEDIAL DESIGN HARRIS COUNTY, TEXAS

5	100% EPA SUBMITTAL	JC	CRH	11/25/2
4	FOR CLIENT REVIEW	JC	CRH	11/21/2
3	100% EPA SUBMITTAL	MW	CRH	07/17/2
No.	Issue	Drawn	Approved	Date
Drawn <b>JC</b>		Designer	RH	
Drafti Chec	° къ	Design Check	LL	
Project CM Coordinator		Date	Nov 25, 2024	
constr	document shall not be used for uction unless signed and sealed for	Scale	1" = 10'	

original size drawing Arch D

Project No. **11215702** 

Original Size

SOUTH WALL SECTIONS 1 OF 3

Sheet No.

C-42


Sheet **43** of **83** 


Bar is one inch on


Plot Date: 25 November 2024 - 3:24 PM

Plotted By: Jonathan Compton

Filename: \\ghdnet\ghd\US\Baton Rouge\Projects\562\11215702\Digital\_Design\ACAD 2019\Sheets\11215702-01-DWG-C-035.dwg

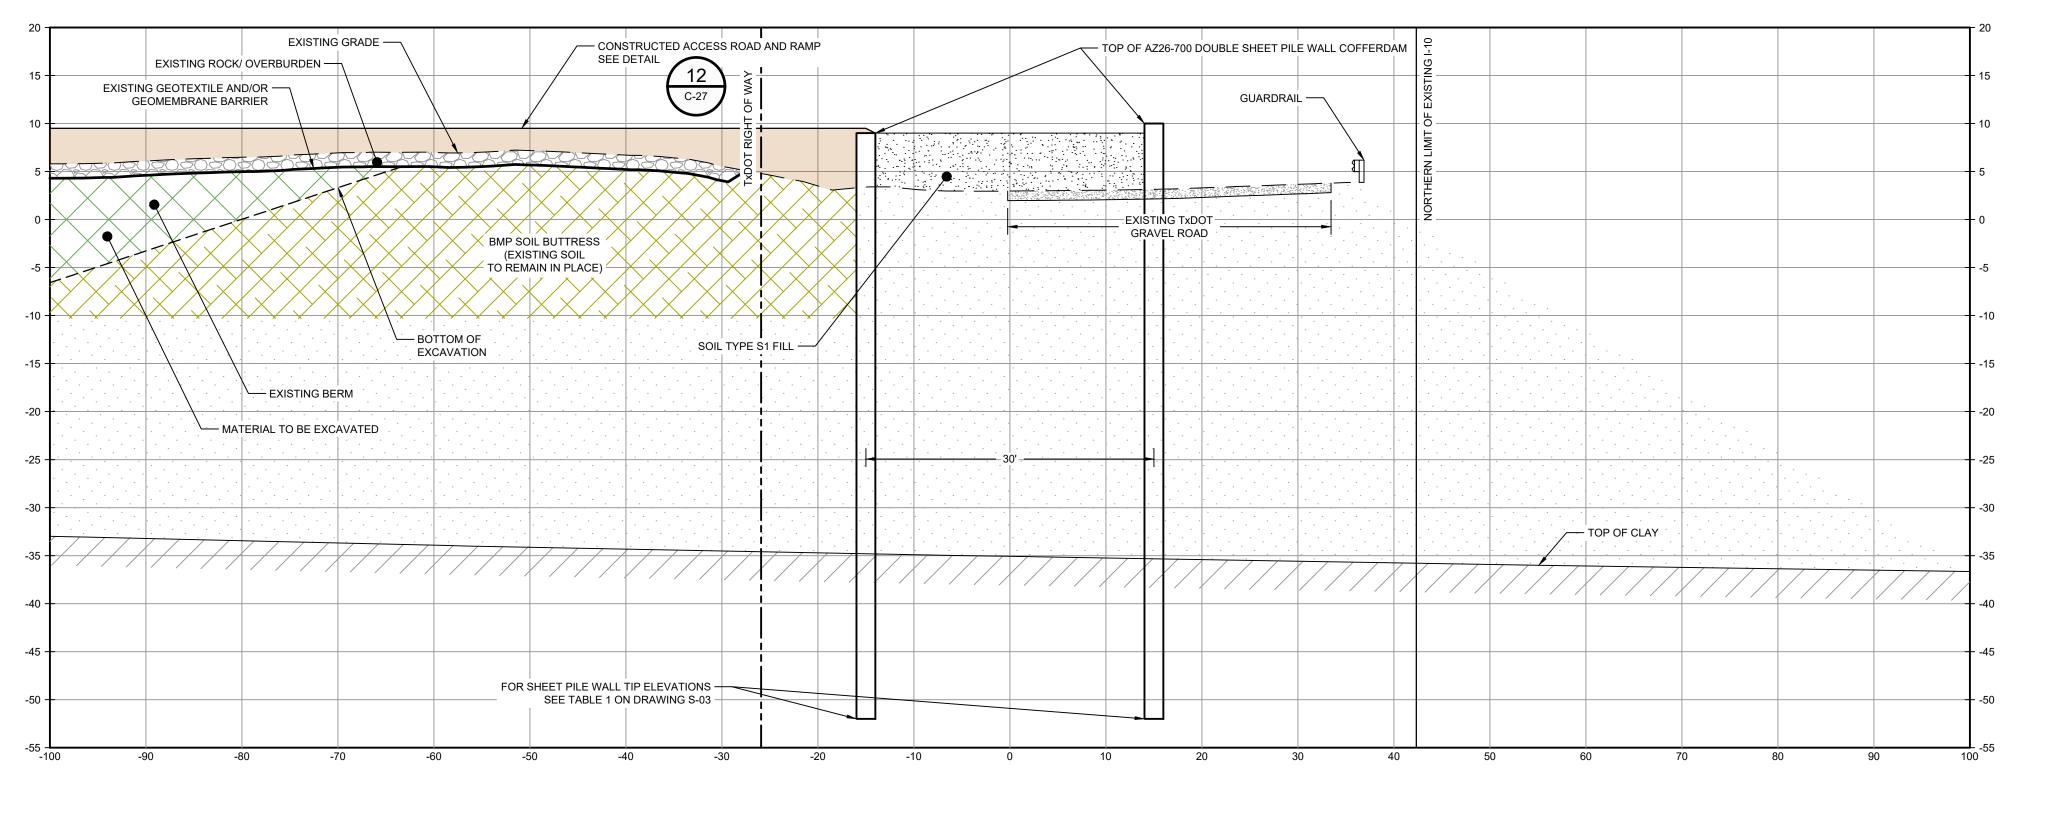

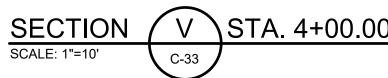

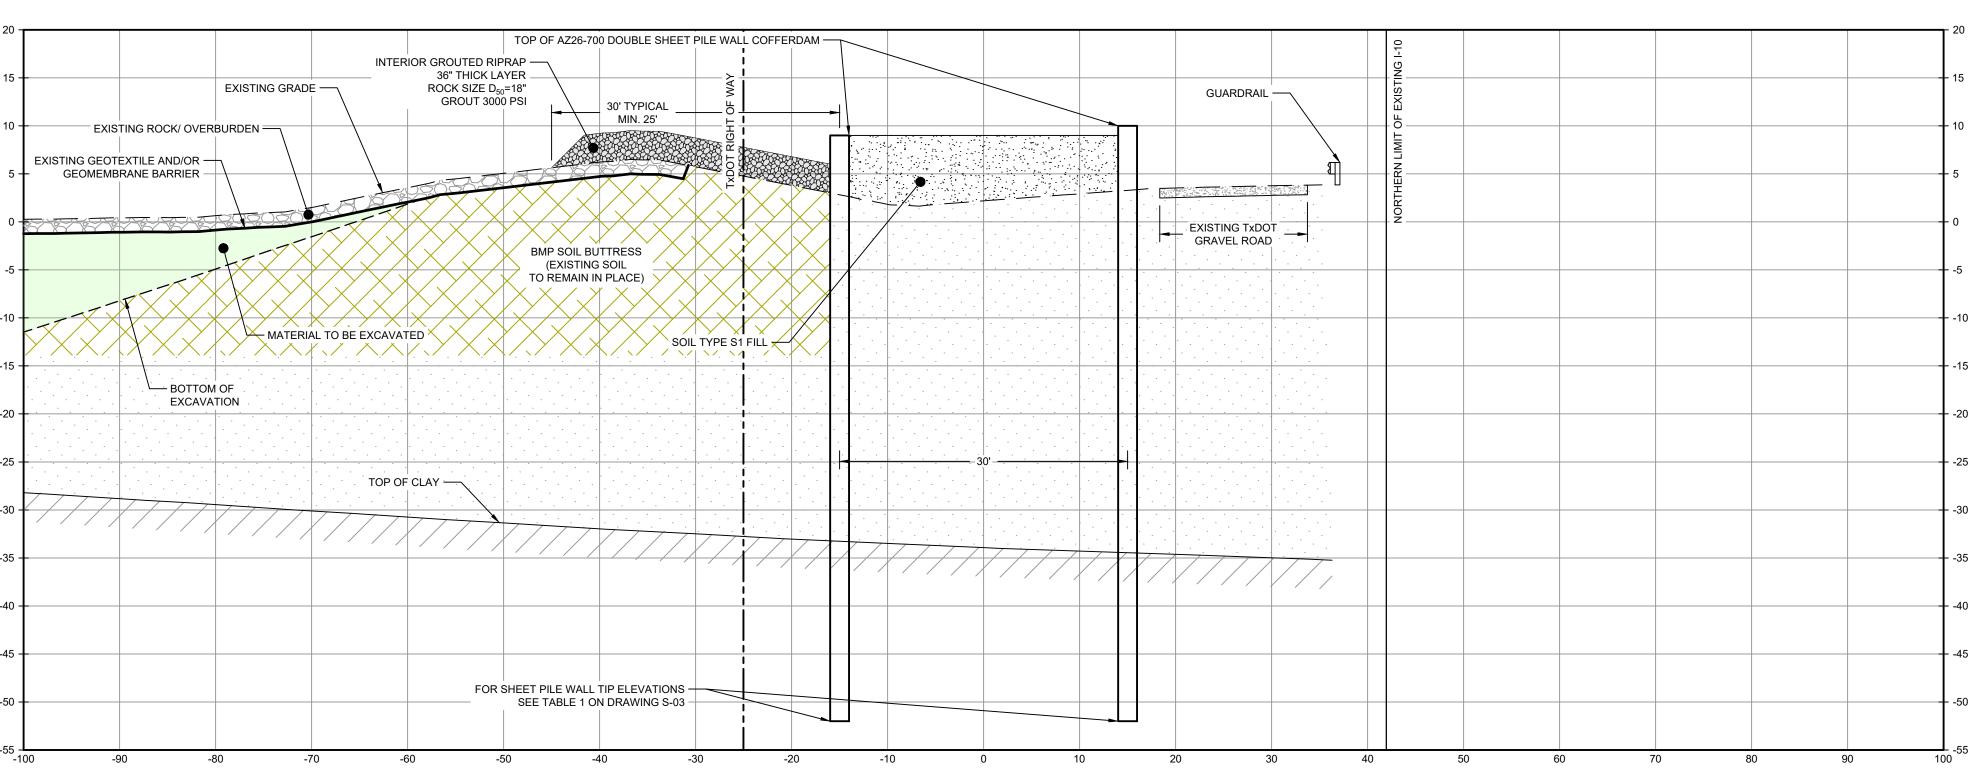



TXDOT RIGHT OF WAY FROM A BOUNDARY AND RIGHT-OF-WAY SURVEY OF PORT OF HOUSTON AUTHORITY PROPERTY & HOUSTON FLEETING SERVICES, LLC PROPERTY ALONG INTERSTATE HIGHWAY 10 AT THE SAN JACINTO FLEET AREA, IN THE J. T. HARRELL SURVEY, A-330 HARRIS COUNTY, TEXAS, COBBFENDLEY, 2402-028-01, JUNE 28, 2024

#### NOTES:

1. BOTTOM OF EXCAVATION IS SUBJECT TO CHANGE.

THIS DOCUMENT IS RELEASED FOR THE PURPOSE OF EPA REVIEW UNDER THE AUTHORITY OF CLARENCE R. HOEKSTRA, P.E. 147936 ON 11/25/2024. IT IS NOT TO BE USED FOR CONSTRUCTION, BIDDING, RECORDATION, CONVEYANCE OR SALES PURPOSES.



**100% EPA SUBMITTAL** 



2237 S Acadian Thruway Suite 701 Baton Rouge Louisiana 70808 USA **T** 225 292 9007



Reuse of Documents

This document and the ideas and designs incorporated herein, as an instrument of professional service, is the property of GHD and shall not be reused in whole or in part for any other project without GHD's written authorization. © 2024 GHD

<u>LEGEND</u>

MATERIAL TO BE EXCAVATED BMP SOIL BUTTRESS (EXISTING SOIL TO REMAIN IN PLACE) PLANNED IMPROVEMENTS FOR NORTHERN IMPOUNDMENT ACCESS EXISTING BERM TO BE EXCAVATED FOR POTENTIAL TESTING AND REUSE INTERIOR SCOUR PROTECTION

Client

## **SAN JACINTO RIVER WASTE PITS**

NORTHERN IMPOUNDMENT FINAL 100% REMEDIAL DESIGN HARRIS COUNTY, TEXAS

5	100% EPA SUBMITTAL	JC	CRH	11/25
4	FOR CLIENT REVIEW	JC	CRH	11/21
3	100% EPA SUBMITTAL	MW	CRH	07/17
No.	Issue	Drawn	Approved	Da
Draw	n <b>JC</b>	Designer	RH	
Drafti Chec	° 85	Design Check	LL	
Proje Coor	ct dinator <b>CM</b>	Date	Nov 25, 20	024
	document shall not be used for uction unless signed and sealed for	Scale	1" = 10'	

Arch D

Bar is one inch on original size drawing

Project No. **11215702** 

construction.

Original Size

SOUTH WALL SECTIONS 2 OF 3

Sheet No.


C-43


Sheet **44** of **83** 

Plot Date: 25 November 2024 - 3:24 PM

Plotted By: Jonathan Compton

Filename: \\ghdnet\ghd\US\Baton Rouge\Projects\562\11215702\Digital\_Design\ACAD 2019\Sheets\11215702-01-DWG-C-035.dwg

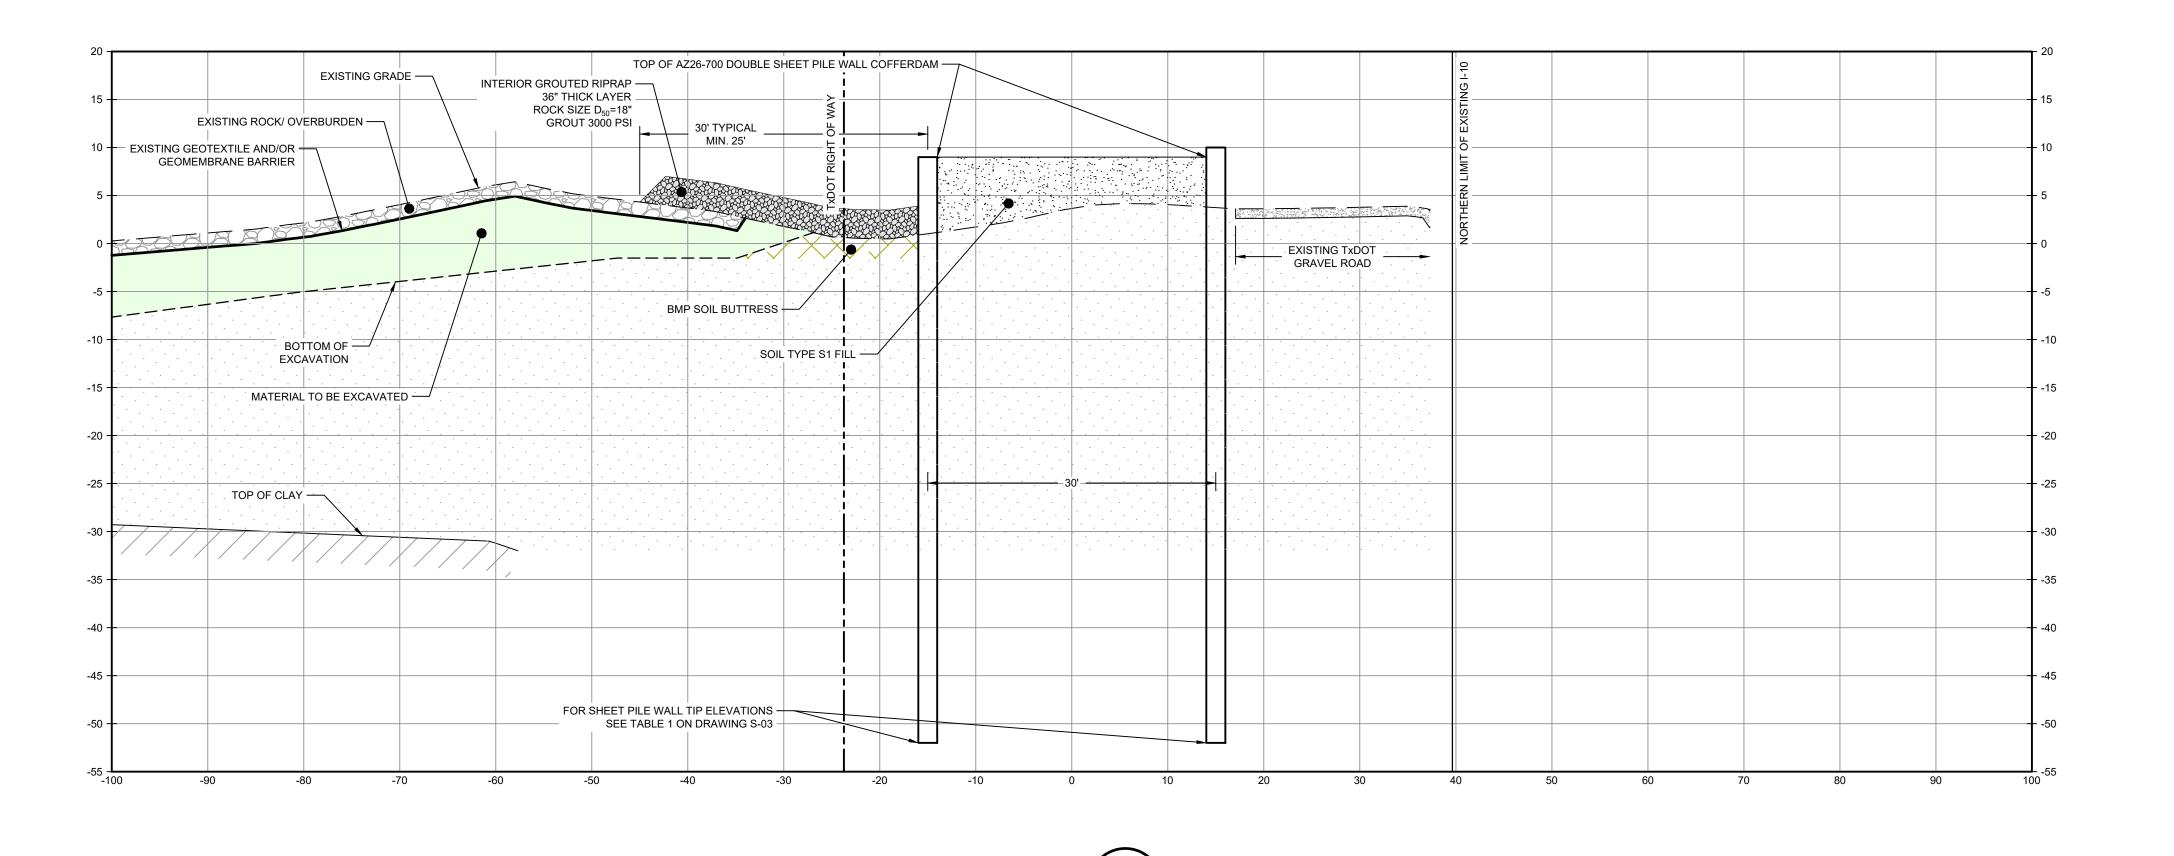

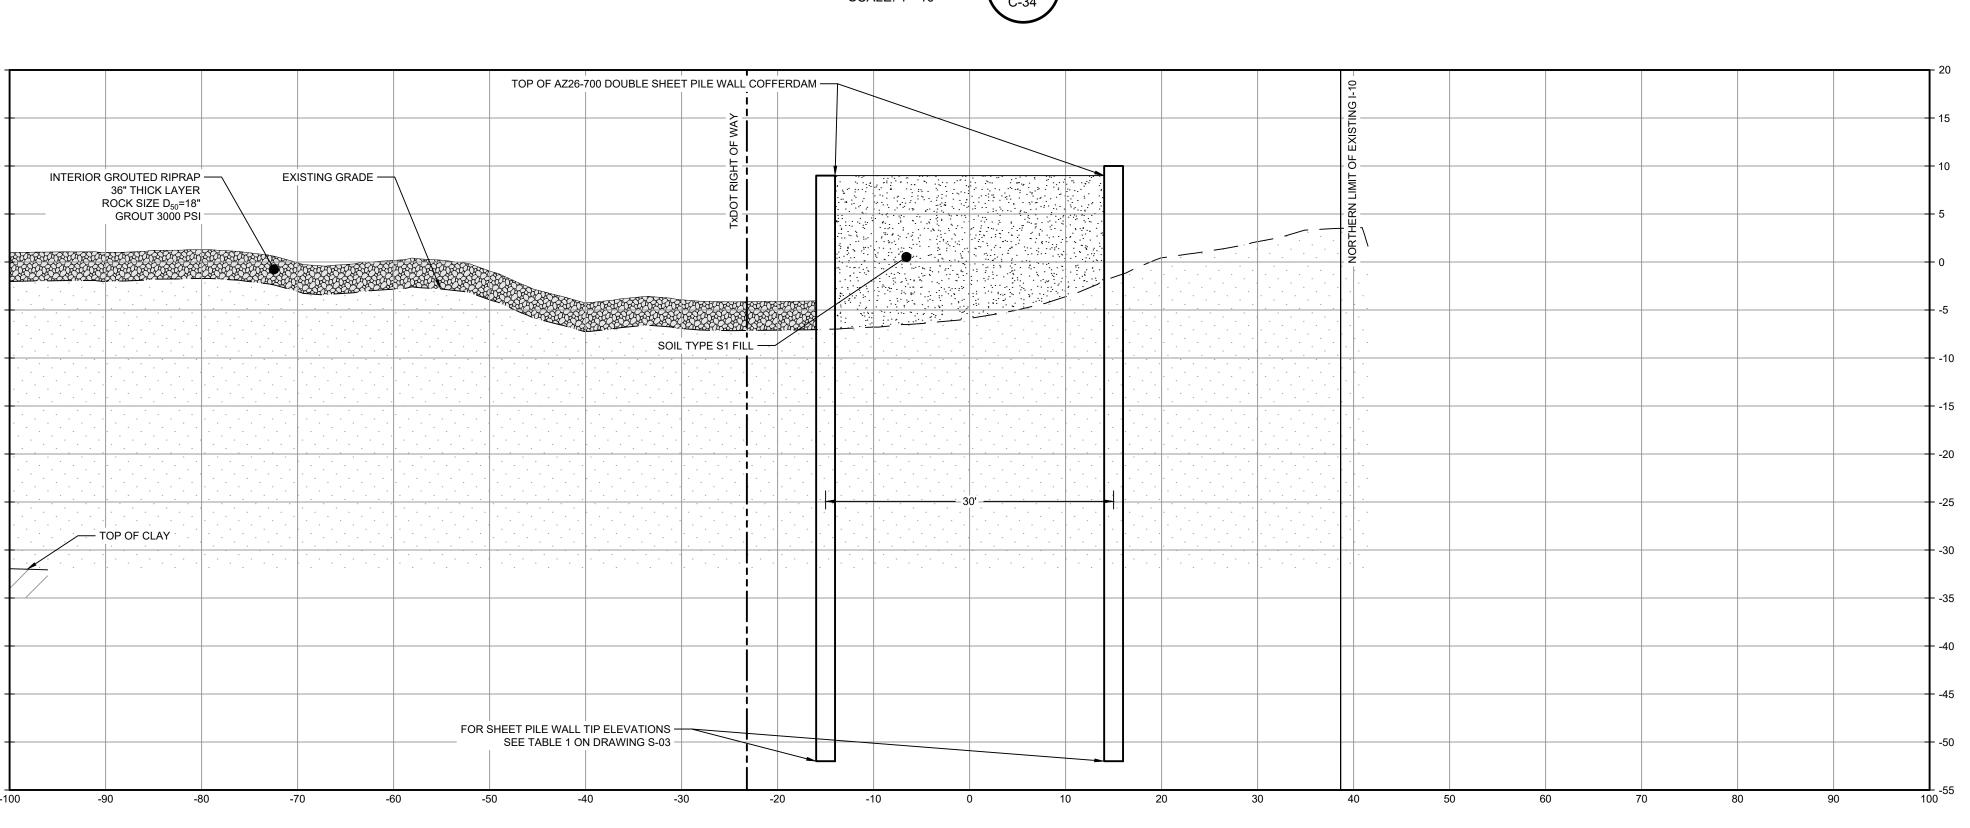




2237 S Acadian Thruway Suite 701 Baton Rouge Louisiana 70808 USA **T** 225 292 9007



Reuse of Documents

This document and the ideas and designs incorporated herein, as an instrument of professional service, is the property of GHD and shall not be reused in whole or in part for any other project without GHD's written authorization. © 2024 GHD

<u>LEGEND</u>

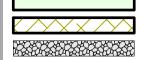

MATERIAL TO BE EXCAVATED BMP SOIL BUTTRESS (EXISTING SOIL TO REMAIN IN PLACE) INTERIOR SCOUR PROTECTION

## **SAN JACINTO RIVER WASTE PITS**

NORTHERN IMPOUNDMENT FINAL 100% REMEDIAL DESIGN HARRIS COUNTY, TEXAS

5	100% EPA SUBMITTAL	JC	CRH	11/25
4	FOR CLIENT REVIEW	JC	CRH	11/21
3	100% EPA SUBMITTAL	MW	CRH	07/17
No.	Issue	Drawn	Approved	Da
Draw	n <b>JC</b>	Designer	RH	
Draft Chec	· BS	Design Check	LL	
Proje Coor	ct dinator <b>CM</b>	Date	Nov 25, 20	024
constr	document shall not be used for uction unless signed and sealed for uction.	Scale	1" = 10'	

original size drawing Arch D

Project No. **11215702** 

Original Size

SOUTH WALL SECTIONS 3 OF 3

Sheet No.

C-44

Sheet **45** of **83** 

Bar is one inch on

SOURCE:


TXDOT RIGHT OF WAY FROM A BOUNDARY AND RIGHT-OF-WAY SURVEY OF PORT OF HOUSTON AUTHORITY PROPERTY & HOUSTON FLEETING SERVICES, LLC PROPERTY ALONG INTERSTATE HIGHWAY 10 AT THE SAN JACINTO FLEET AREA, IN THE J. T. HARRELL SURVEY, A-330 HARRIS COUNTY, TEXAS, COBBFENDLEY, 2402-028-01, JUNE 28, 2024


NOTES:


1. BOTTOM OF EXCAVATION IS SUBJECT TO CHANGE.


THIS DOCUMENT IS RELEASED FOR THE PURPOSE OF EPA REVIEW UNDER THE AUTHORITY OF CLARENCE R. HOEKSTRA, P.E. 147936 ON 11/25/2024. IT IS NOT TO BE USED FOR CONSTRUCTION, BIDDING, RECORDATION, CONVEYANCE OR SALES PURPOSES.




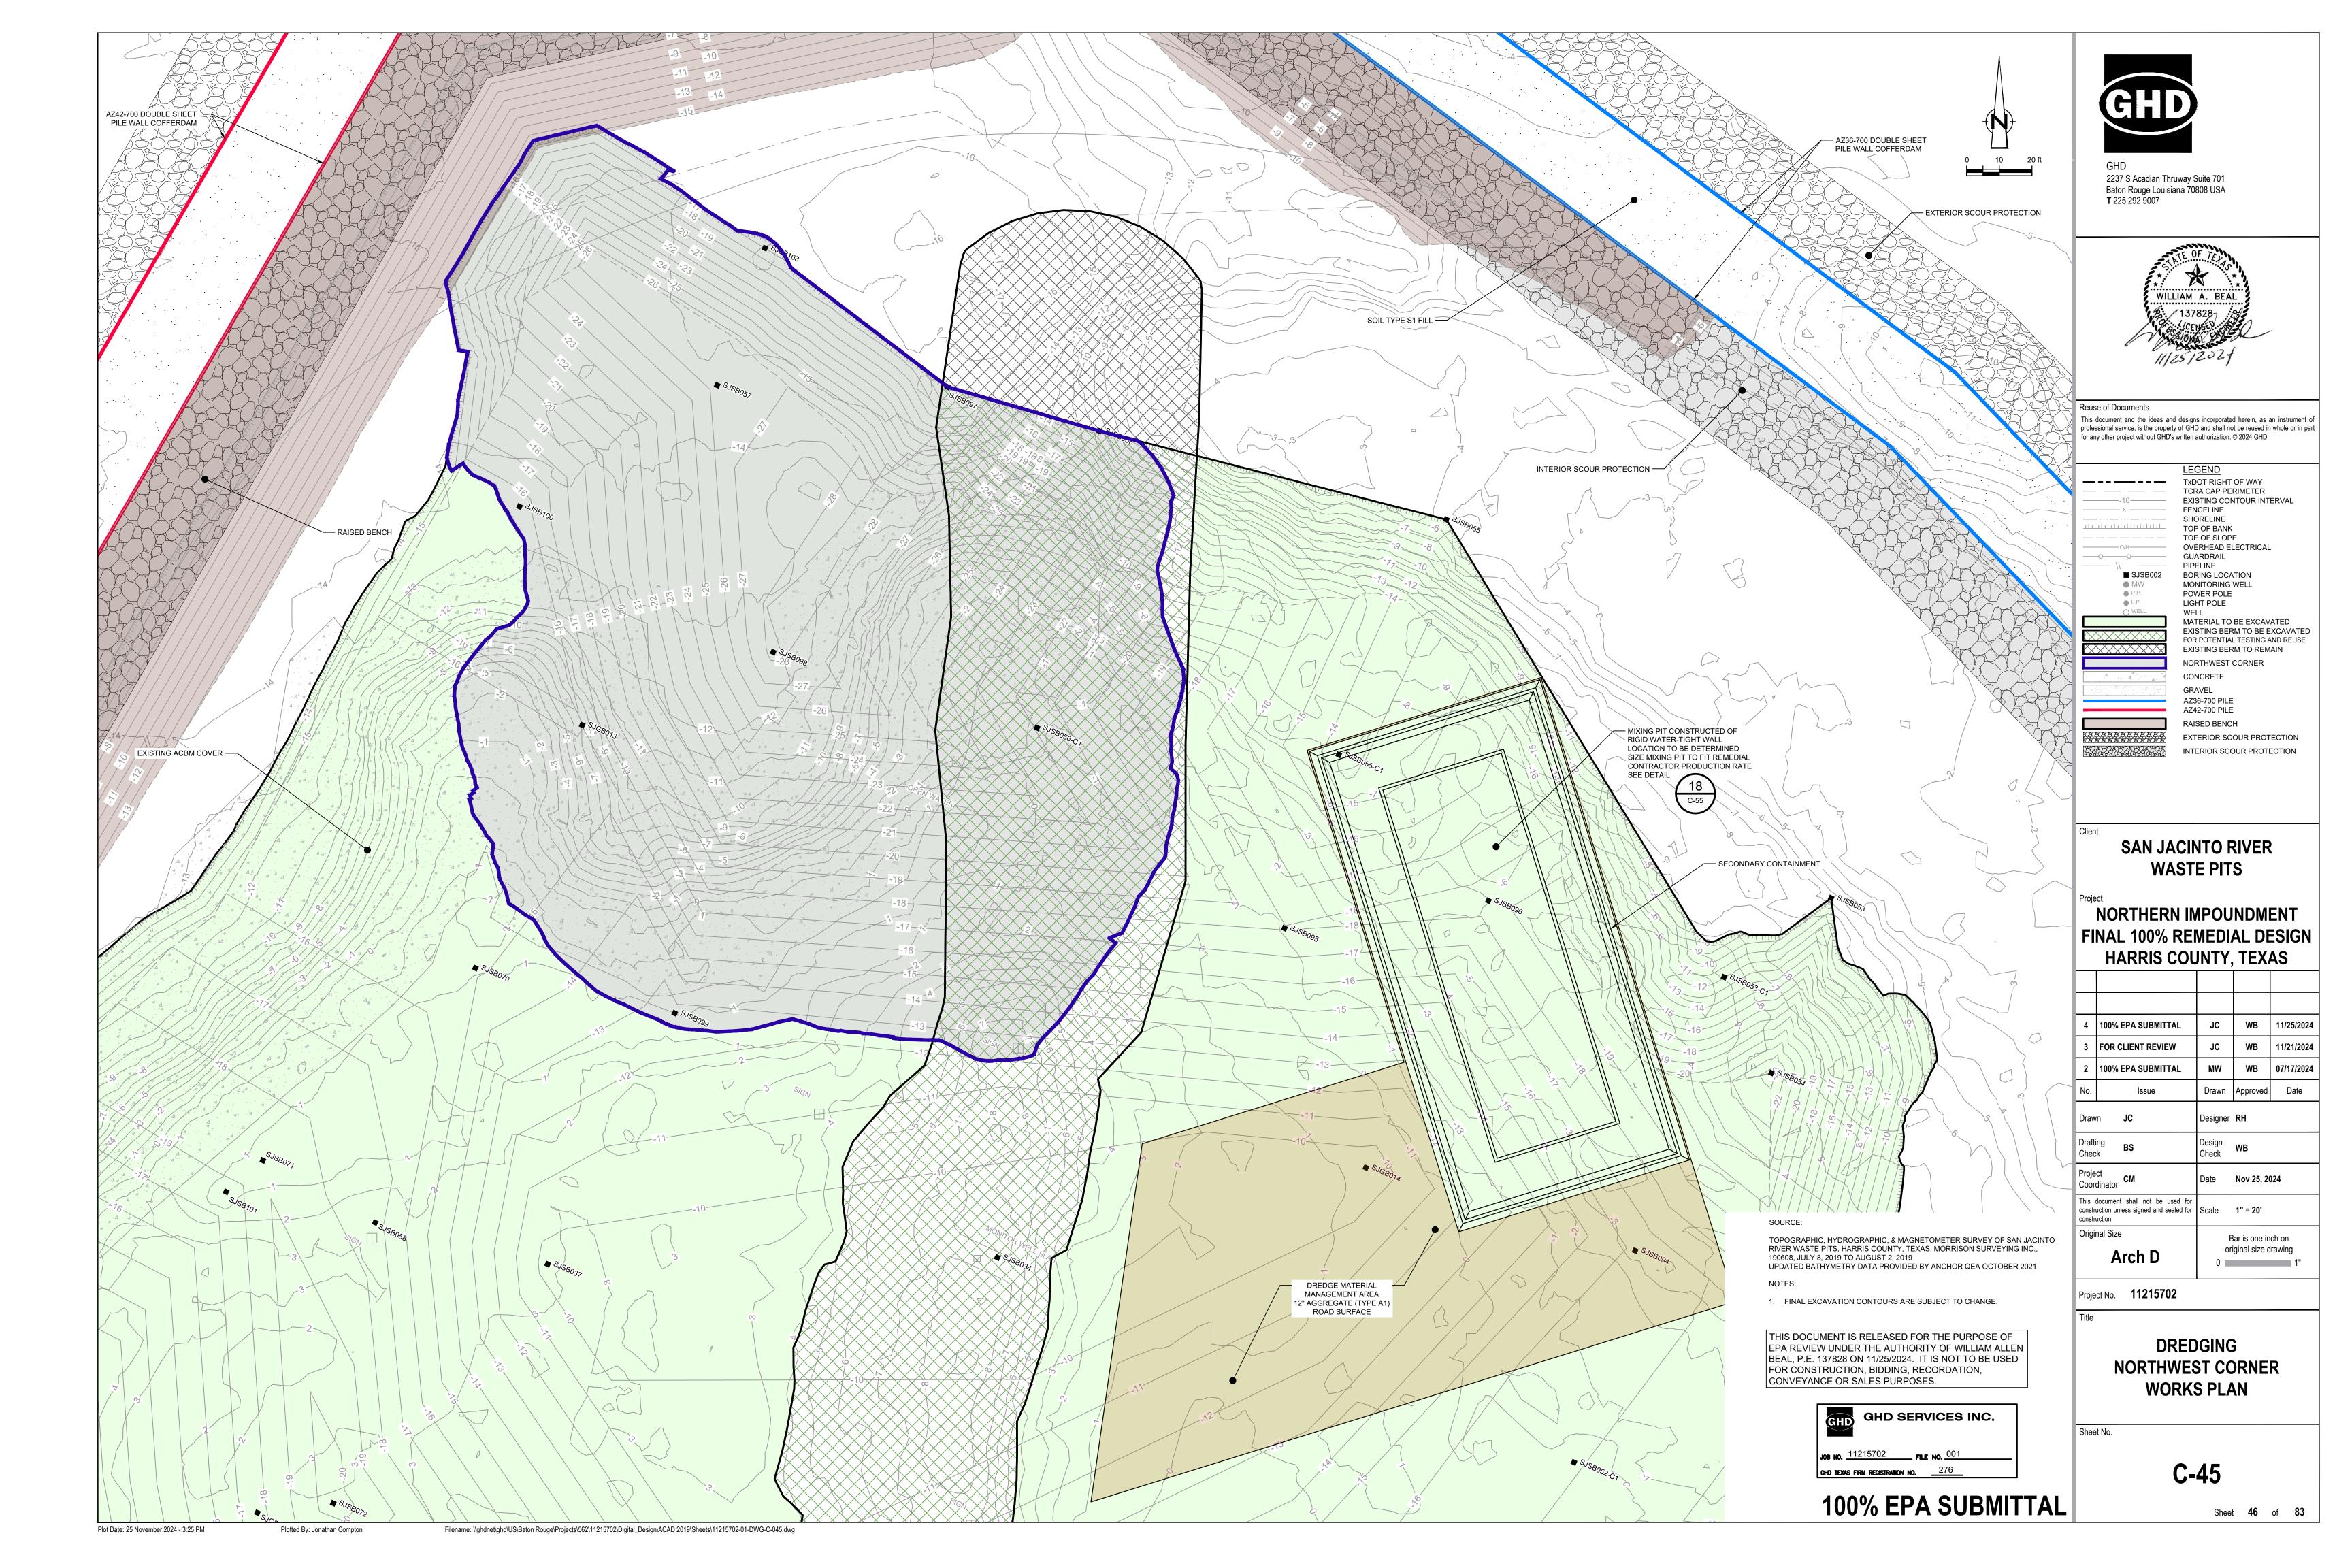

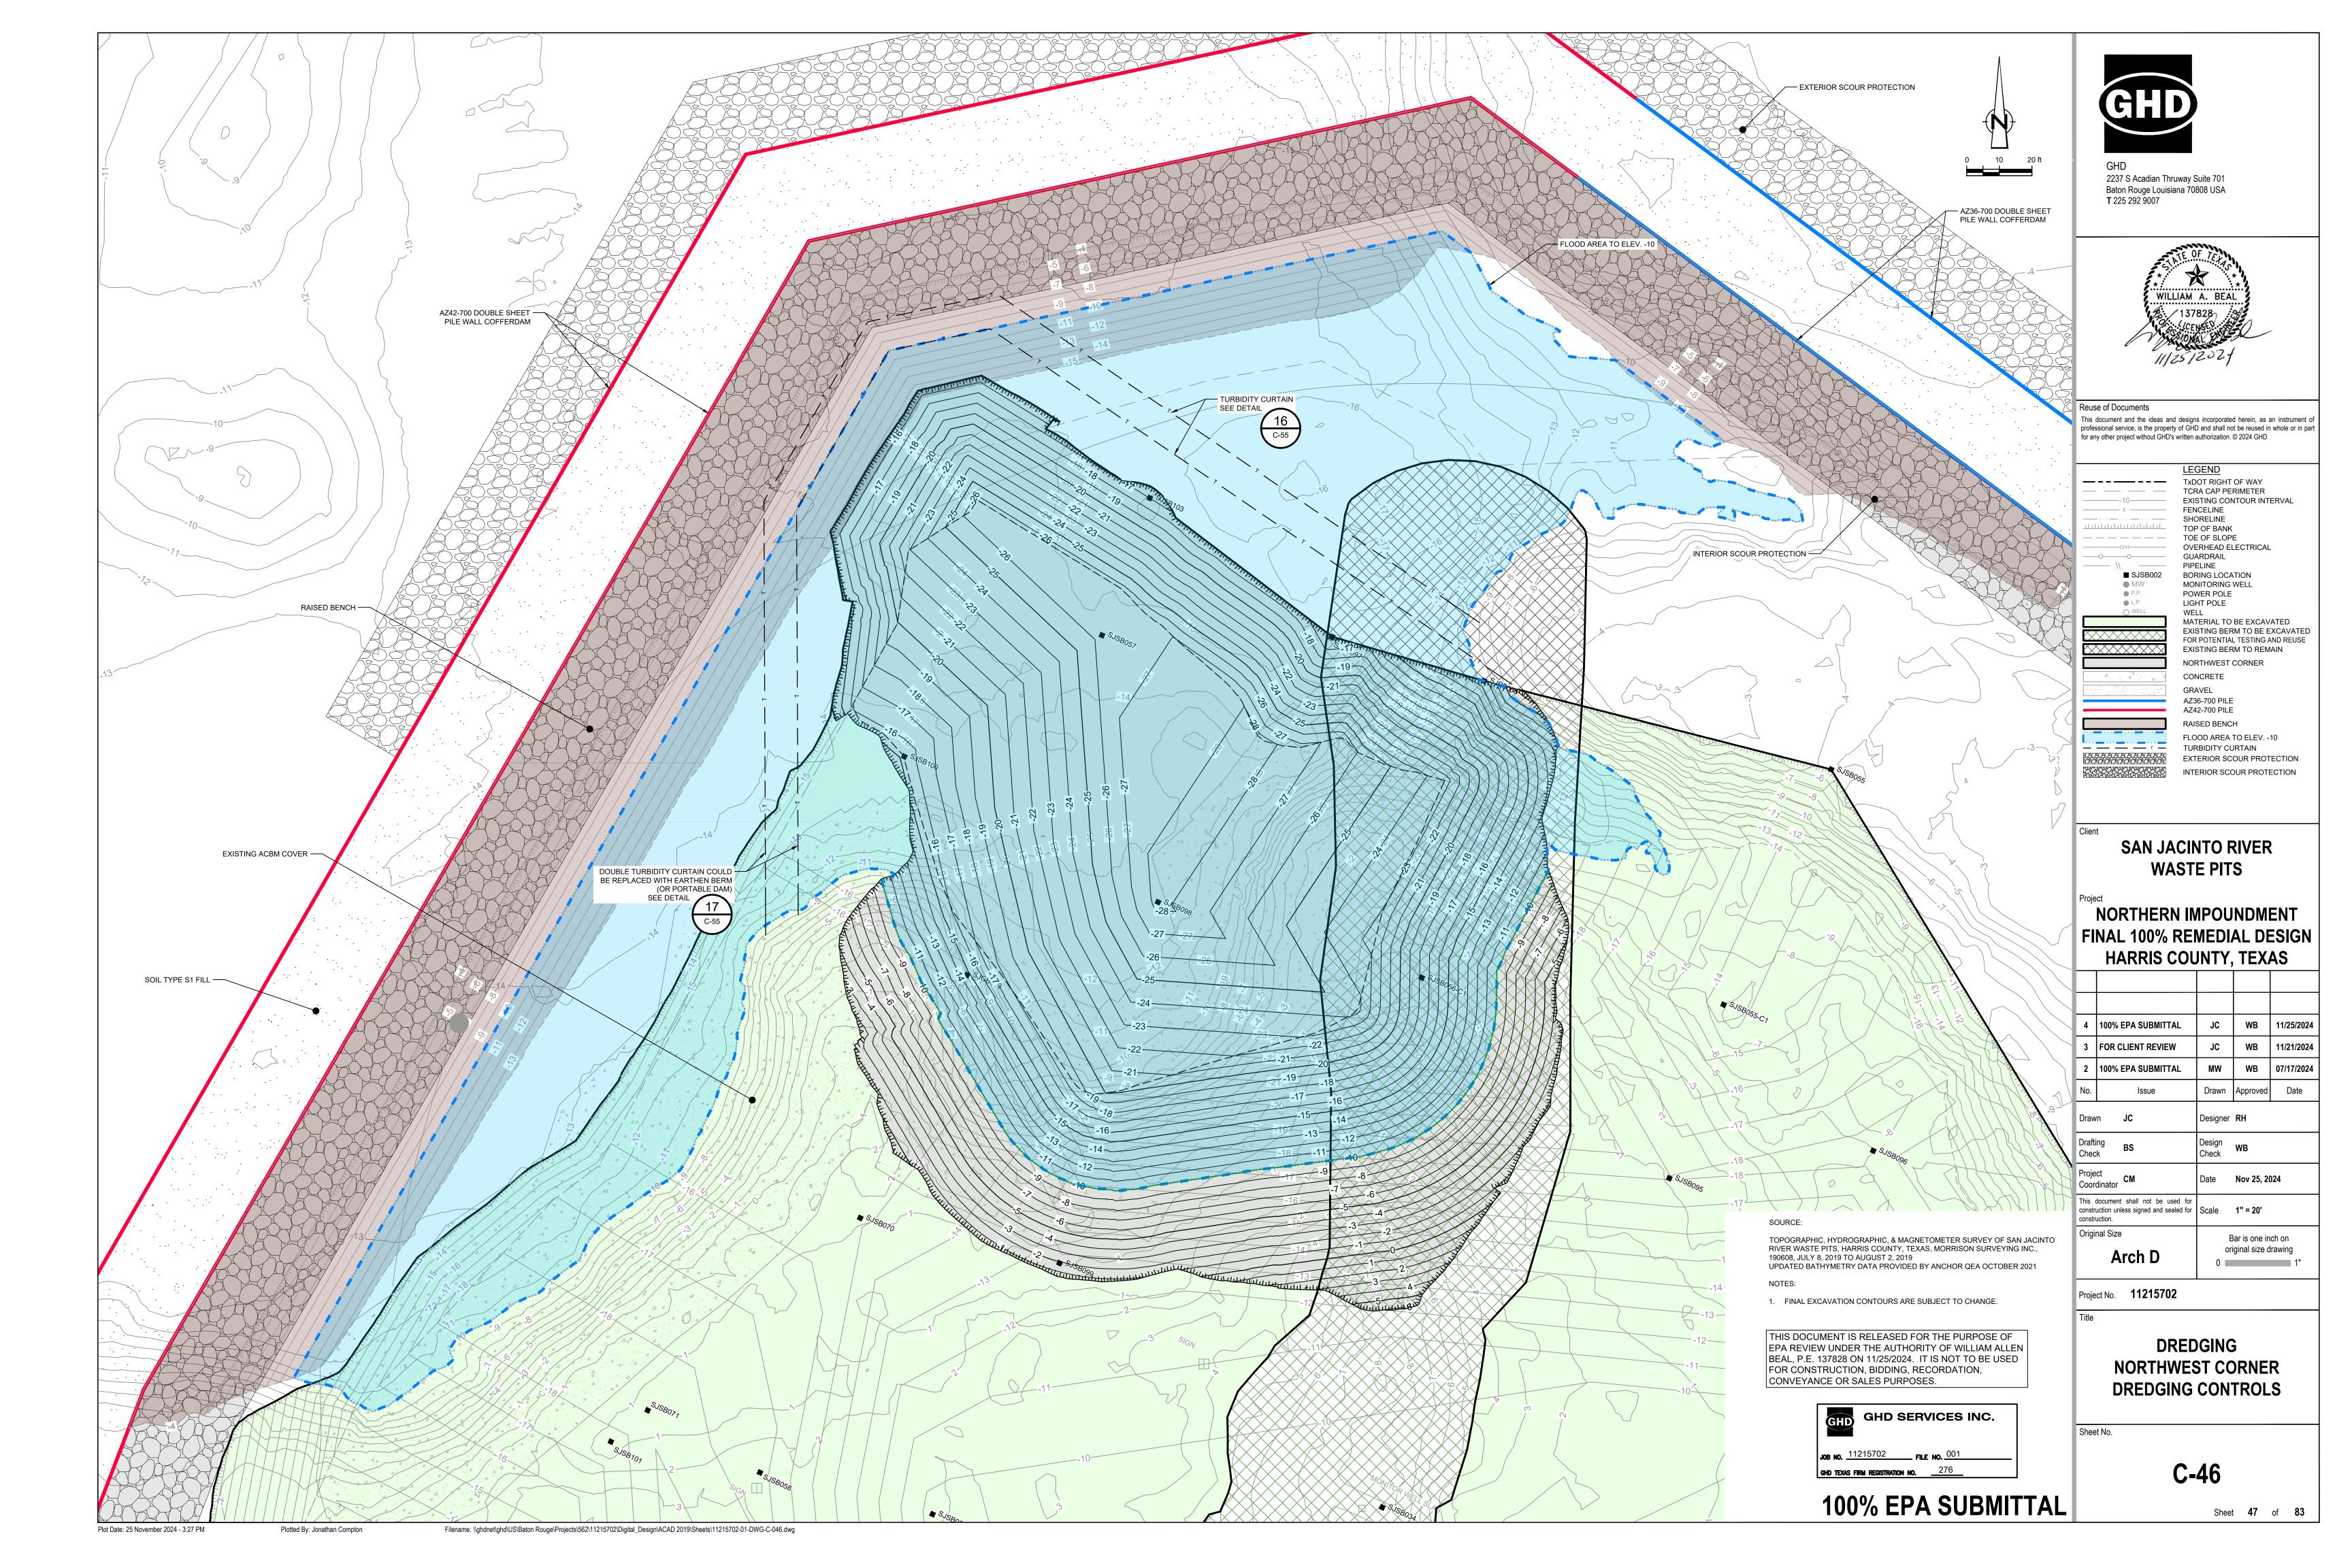


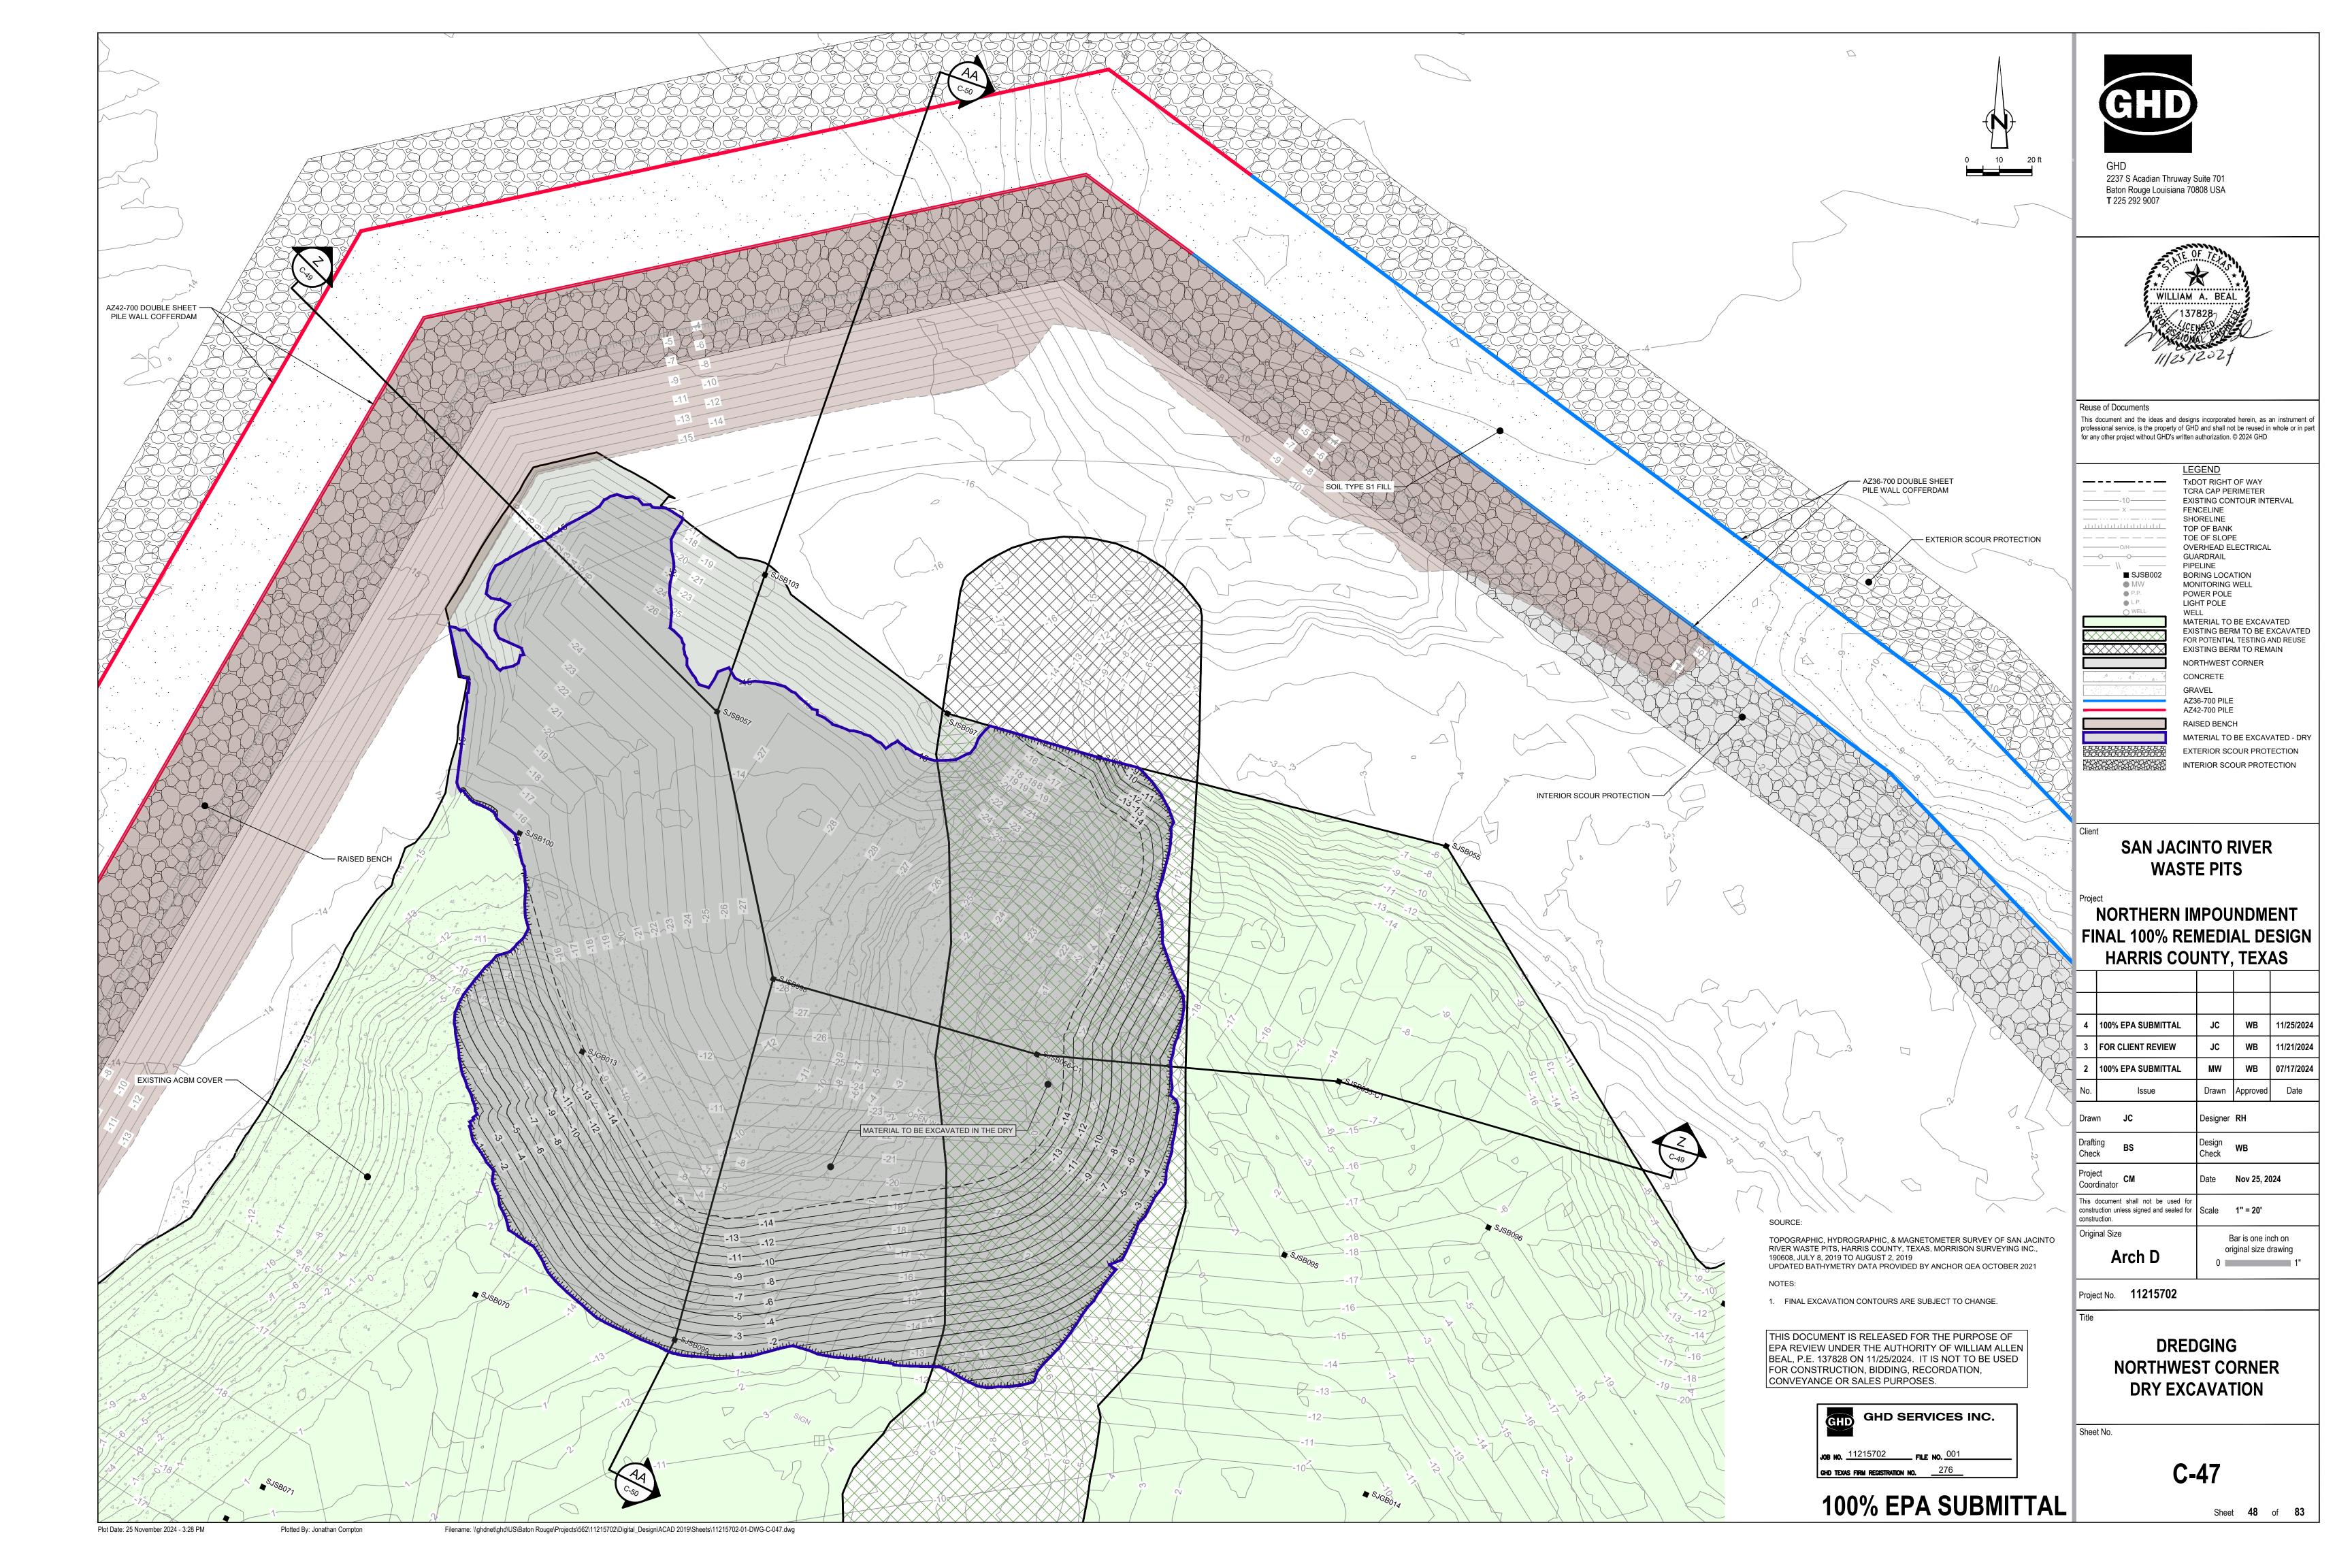

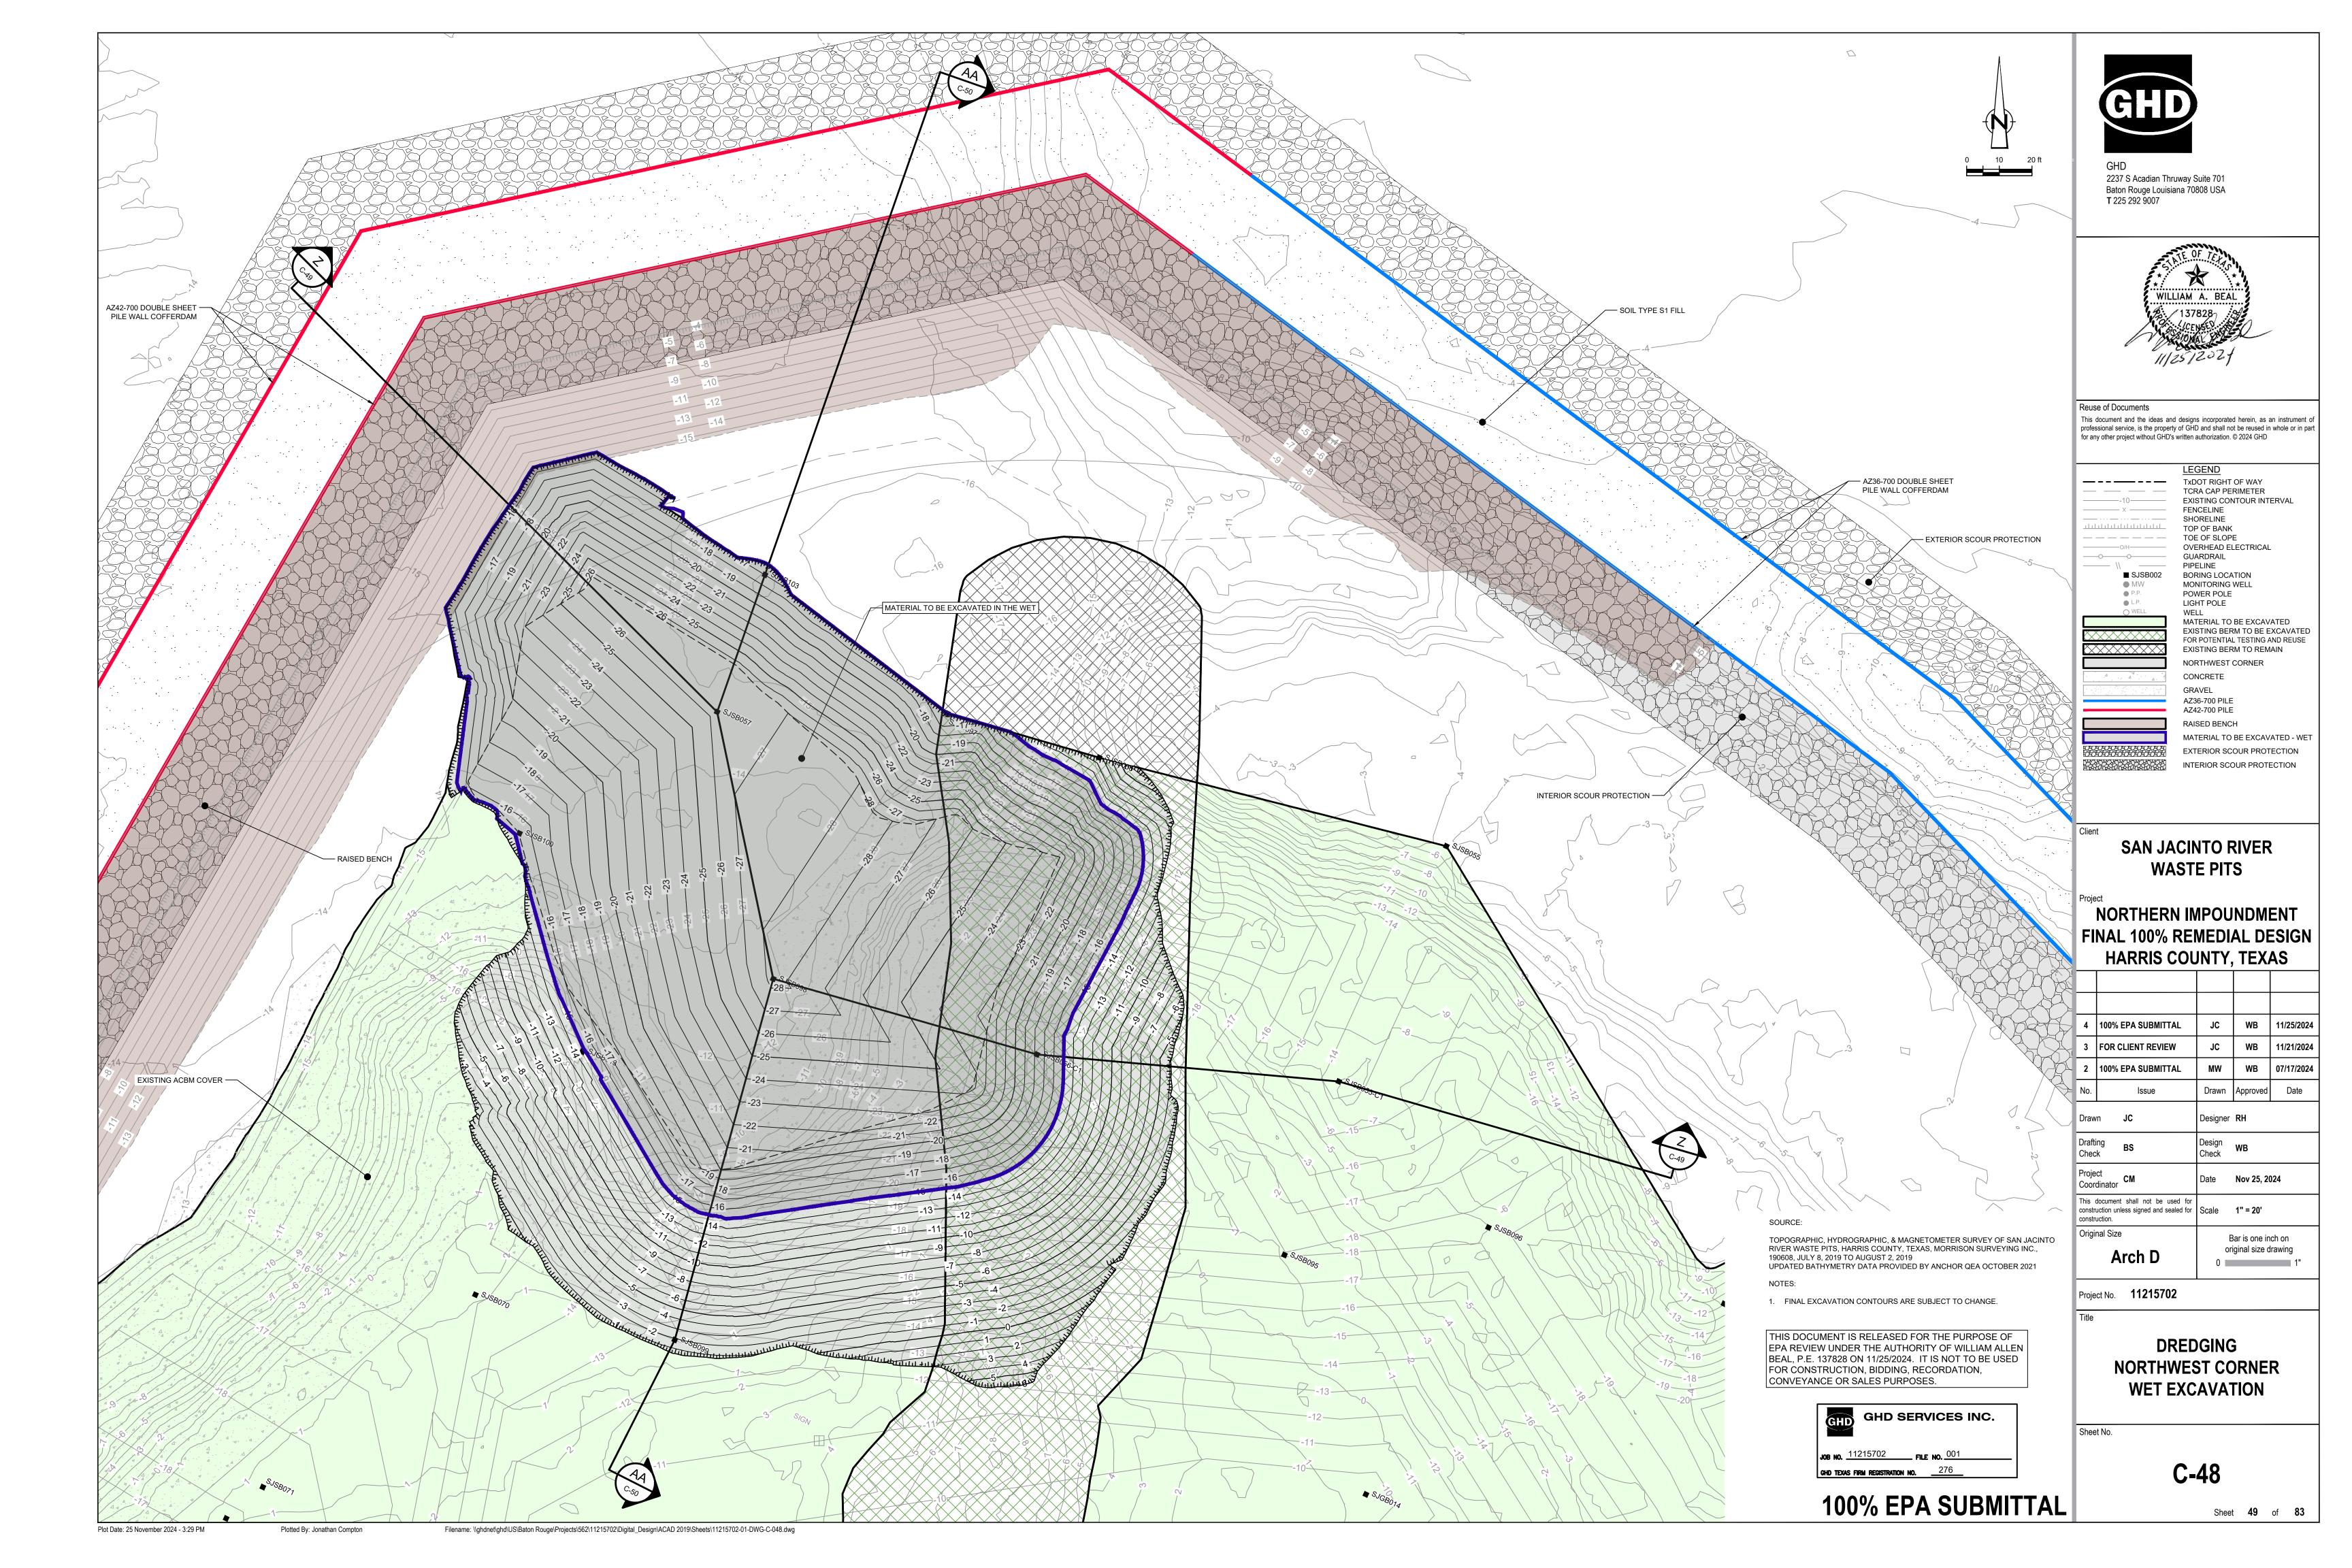

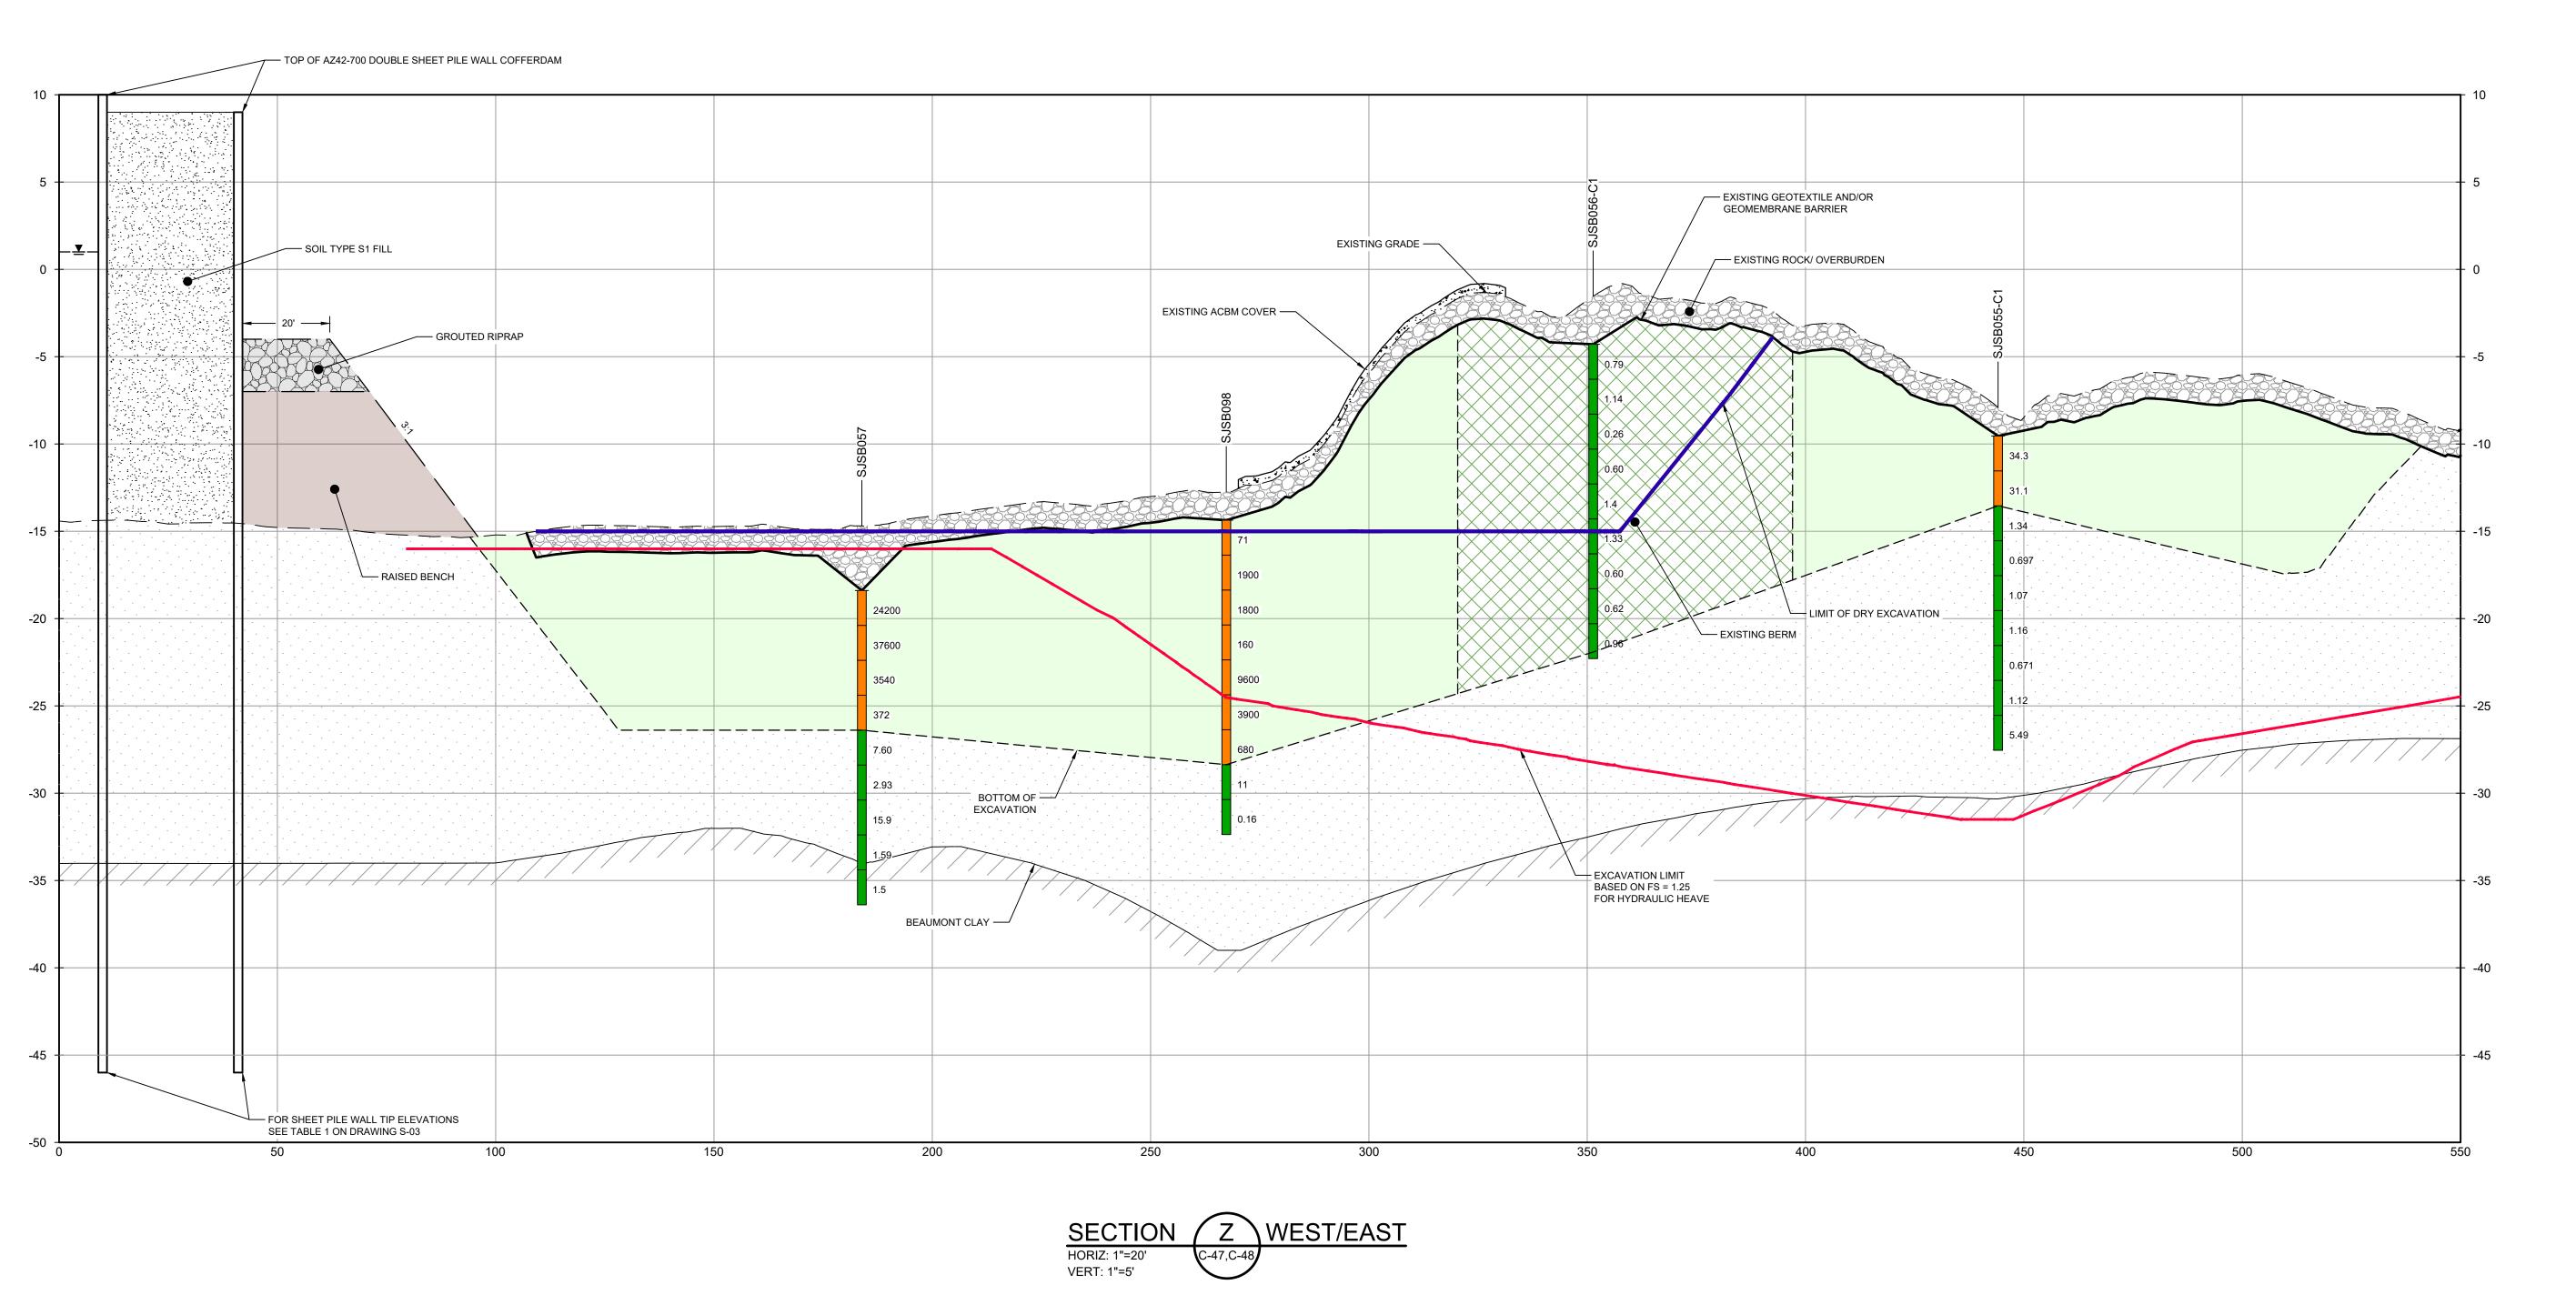


THIS DOCUMENT IS RELEASED FOR THE PURPOSE OF EPA REVIEW UNDER THE AUTHORITY OF WILLIAM ALLEN BEAL, P.E. 137828 ON 11/25/2024. IT IS NOT TO BE USED FOR CONSTRUCTION, BIDDING, RECORDATION,

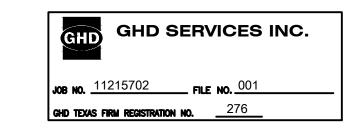



2237 S Acadian Thruway Suite 701 Baton Rouge Louisiana 70808 USA **T** 225 292 9007

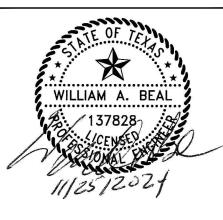

Reuse of Documents

This document and the ideas and designs incorporated herein, as an instrument of professional service, is the property of GHD and shall not be reused in whole or in part for any other project without GHD's written authorization. © 2024 GHD

SOILS WITH CONCENTRATIONS <30 ng/kg  $TEQ_{DF,M}$  TCDD SOILS WITH CONCENTRATIONS >30 ng/kg TEQ<sub>DF,M</sub> TCDD EXCAVATION LIMIT BASED ON FS = 1.25 FOR HYDRAULIC HEAVE MATERIAL TO BE EXCAVATED

EXISTING BERM TO BE EXCAVATED FOR POTENTIAL TESTING AND REUSE

**SAN JACINTO RIVER WASTE PITS** 

NORTHERN IMPOUNDMENT FINAL 100% REMEDIAL DESIGN HARRIS COUNTY, TEXAS

4	100% EPA SUBMITTAL	JC	WB	11/25/20	
3	FOR CLIENT REVIEW	JC	WB	11/21/20	
2	100% EPA SUBMITTAL	MW	WB	07/17/20	
No.	Issue	Drawn	Approved	Date	
Draw	n <b>JC</b>	Designer <b>RH</b>			
Drafti Chec	· B5	Design Check	WB		
Proje Coor	ct dinator <b>CM</b>	Date <b>Nov 25, 2024</b>			
	document shall not be used for uction unless signed and sealed for uction.	Scale	AS SHOW	/N	
Origii	nal Size	Bar is one inch on original size drawing			

Project No. **11215702** 

Arch D

**DREDGING** 

NORTHWEST CORNER SECTIONS 1 OF 2

Sheet No.


C-49

Sheet **50** of **83** 

BOTTOM OF EXCAVATION IS SUBJECT TO CHANGE.
 SCOUR PROTECTION ON INTERIOR AND EXTERIOR SIDE OF COFFERDAM NOT SHOWN. SEE DRAWINGS C-28 TO C-44 FOR LIMITS OF RIPRAP.


CONVEYANCE OR SALES PURPOSES.



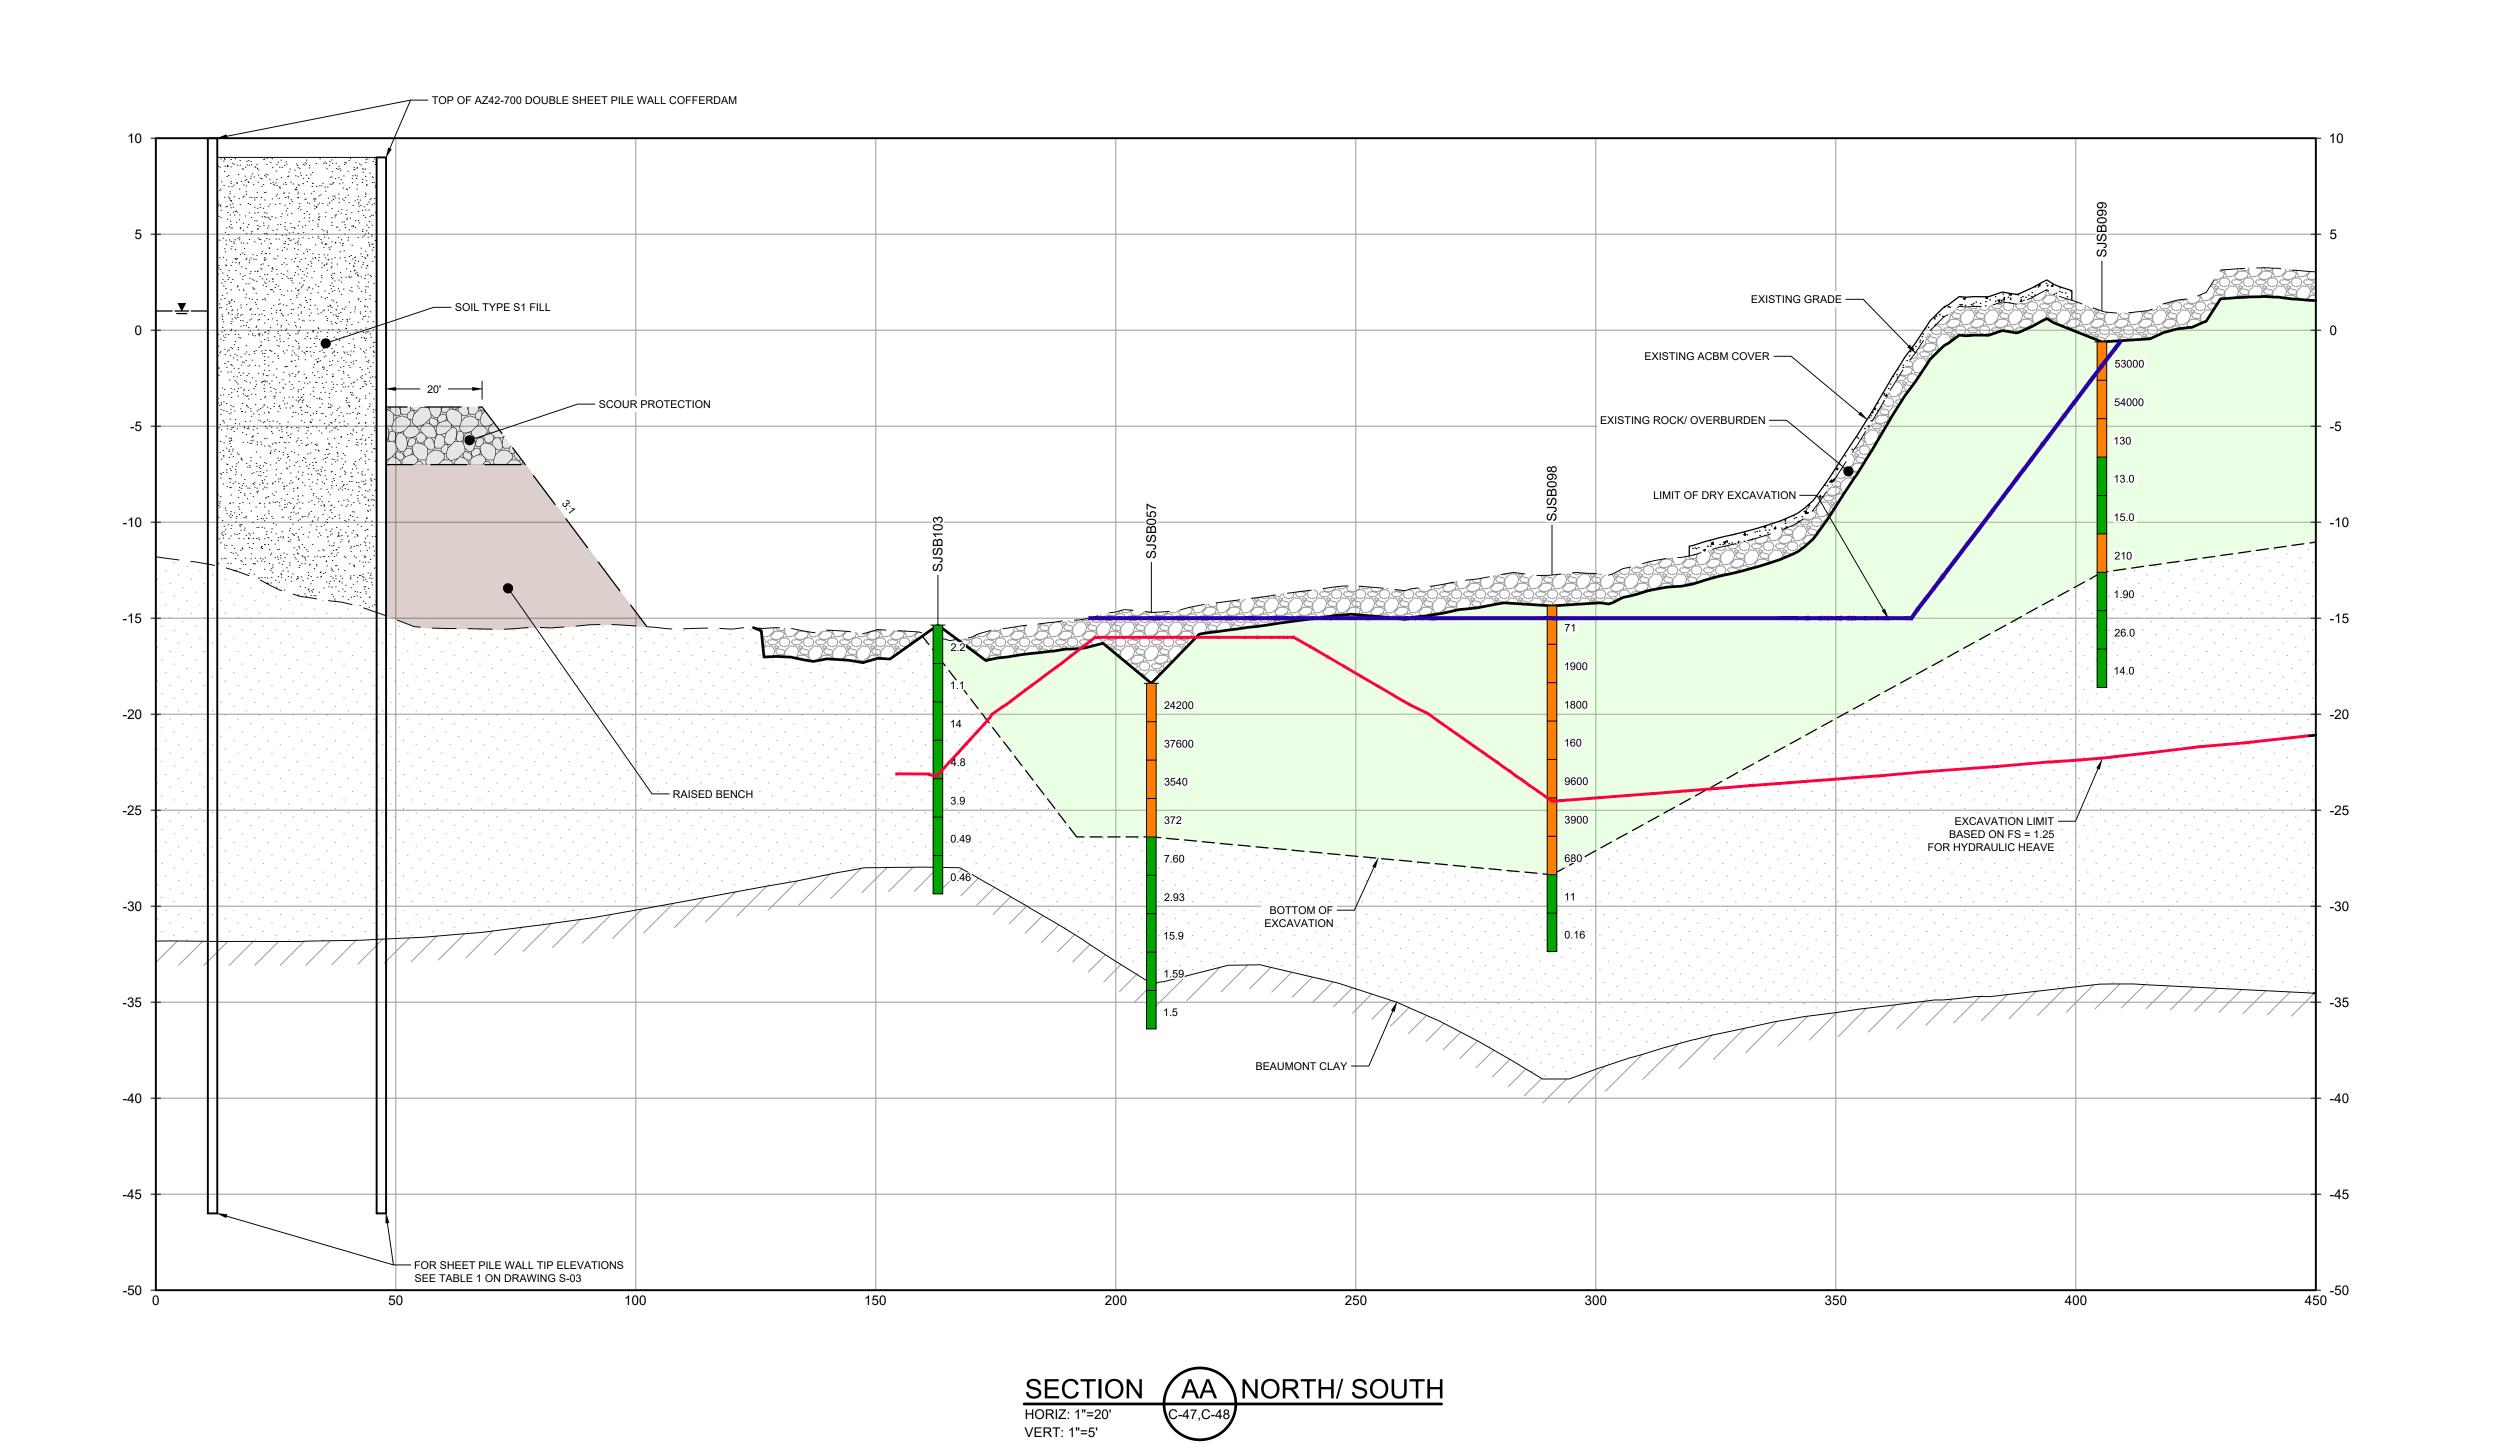

BOTTOM OF EXCAVATION IS SUBJECT TO CHANGE.
 SCOUR PROTECTION ON INTERIOR AND EXTERIOR SIDE OF COFFERDAM NOT SHOWN. SEE DRAWINGS C-28 TO C-44 FOR LIMITS OF RIPRAP.


THIS DOCUMENT IS RELEASED FOR THE PURPOSE OF EPA REVIEW UNDER THE AUTHORITY OF WILLIAM ALLEN BEAL, P.E. 137828 ON 11/25/2024. IT IS NOT TO BE USED FOR CONSTRUCTION, BIDDING, RECORDATION, CONVEYANCE OR SALES PURPOSES.

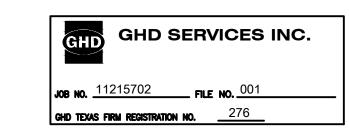

100% EPA SUBMITTAL



2237 S Acadian Thruway Suite 701 Baton Rouge Louisiana 70808 USA **T** 225 292 9007

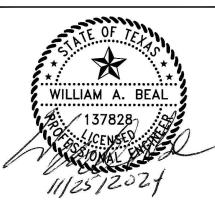

Reuse of Documents

This document and the ideas and designs incorporated herein, as an instrument of professional service, is the property of GHD and shall not be reused in whole or in part for any other project without GHD's written authorization. © 2024 GHD

SOILS WITH CONCENTRATIONS <30 ng/kg  $TEQ_{DF,M}$  TCDD SOILS WITH CONCENTRATIONS >30 ng/kg TEQ<sub>DF,M</sub> TCDD EXCAVATION LIMIT BASED ON FS = 1.25 FOR HYDRAULIC HEAVE MATERIAL TO BE EXCAVATED EXISTING BERM TO BE EXCAVATED

FOR POTENTIAL TESTING AND REUSE

**SAN JACINTO RIVER WASTE PITS** 

NORTHERN IMPOUNDMENT FINAL 100% REMEDIAL DESIGN HARRIS COUNTY, TEXAS

	4	100% EPA SUBMITTAL	JC	WB	11/25
	3	FOR CLIENT REVIEW	JC	WB	11/21
	2	100% EPA SUBMITTAL	MW	WB	07/17
	No.	Issue	Drawn	Approved	Da
	Drafting Check BS		Designer	RH	
			Design Check	WB	
			Date	Nov 25, 20	024
		document shall not be used for uction unless signed and sealed for uction.	Scale	AS SHOW	/N

Project No. **11215702** 

Arch D

Original Size


**DREDGING** NORTHWEST CORNER SECTIONS 2 OF 2


Sheet No.

C-50

Sheet **51** of **83** 


Bar is one inch on original size drawing

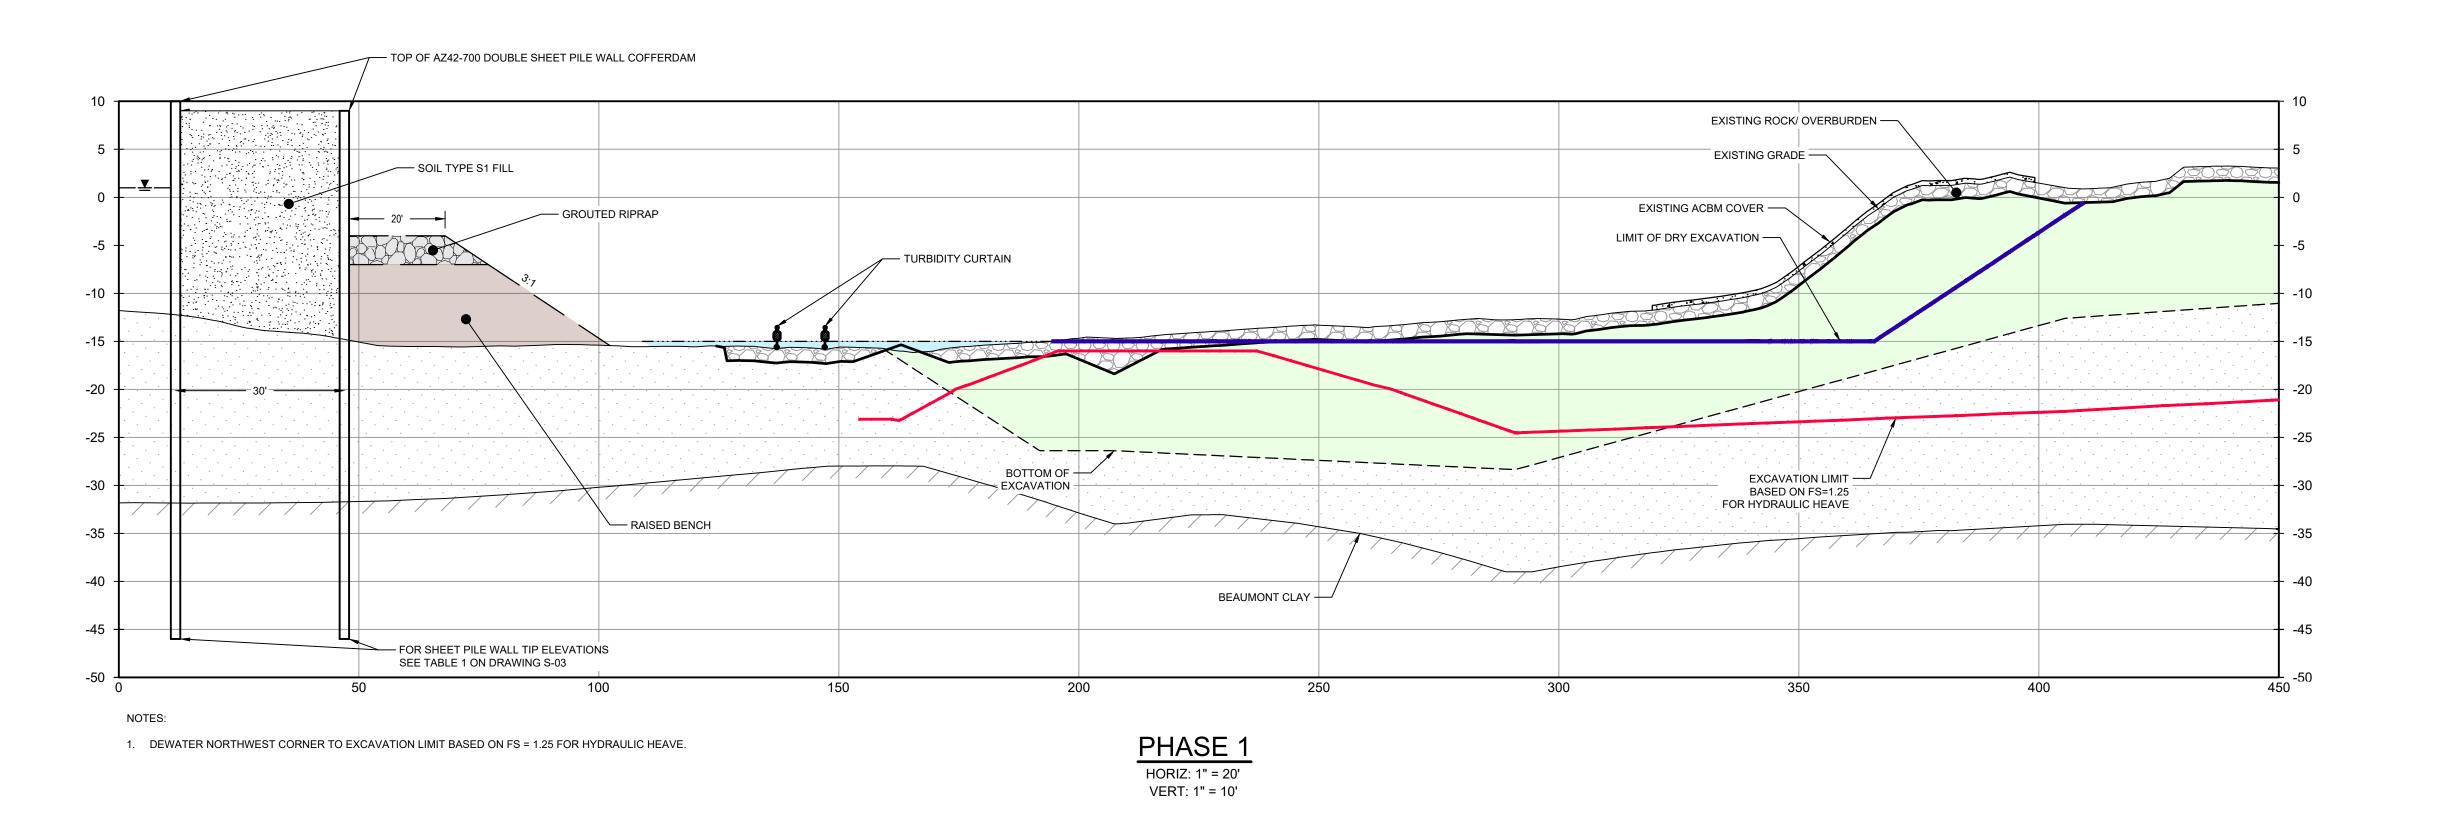

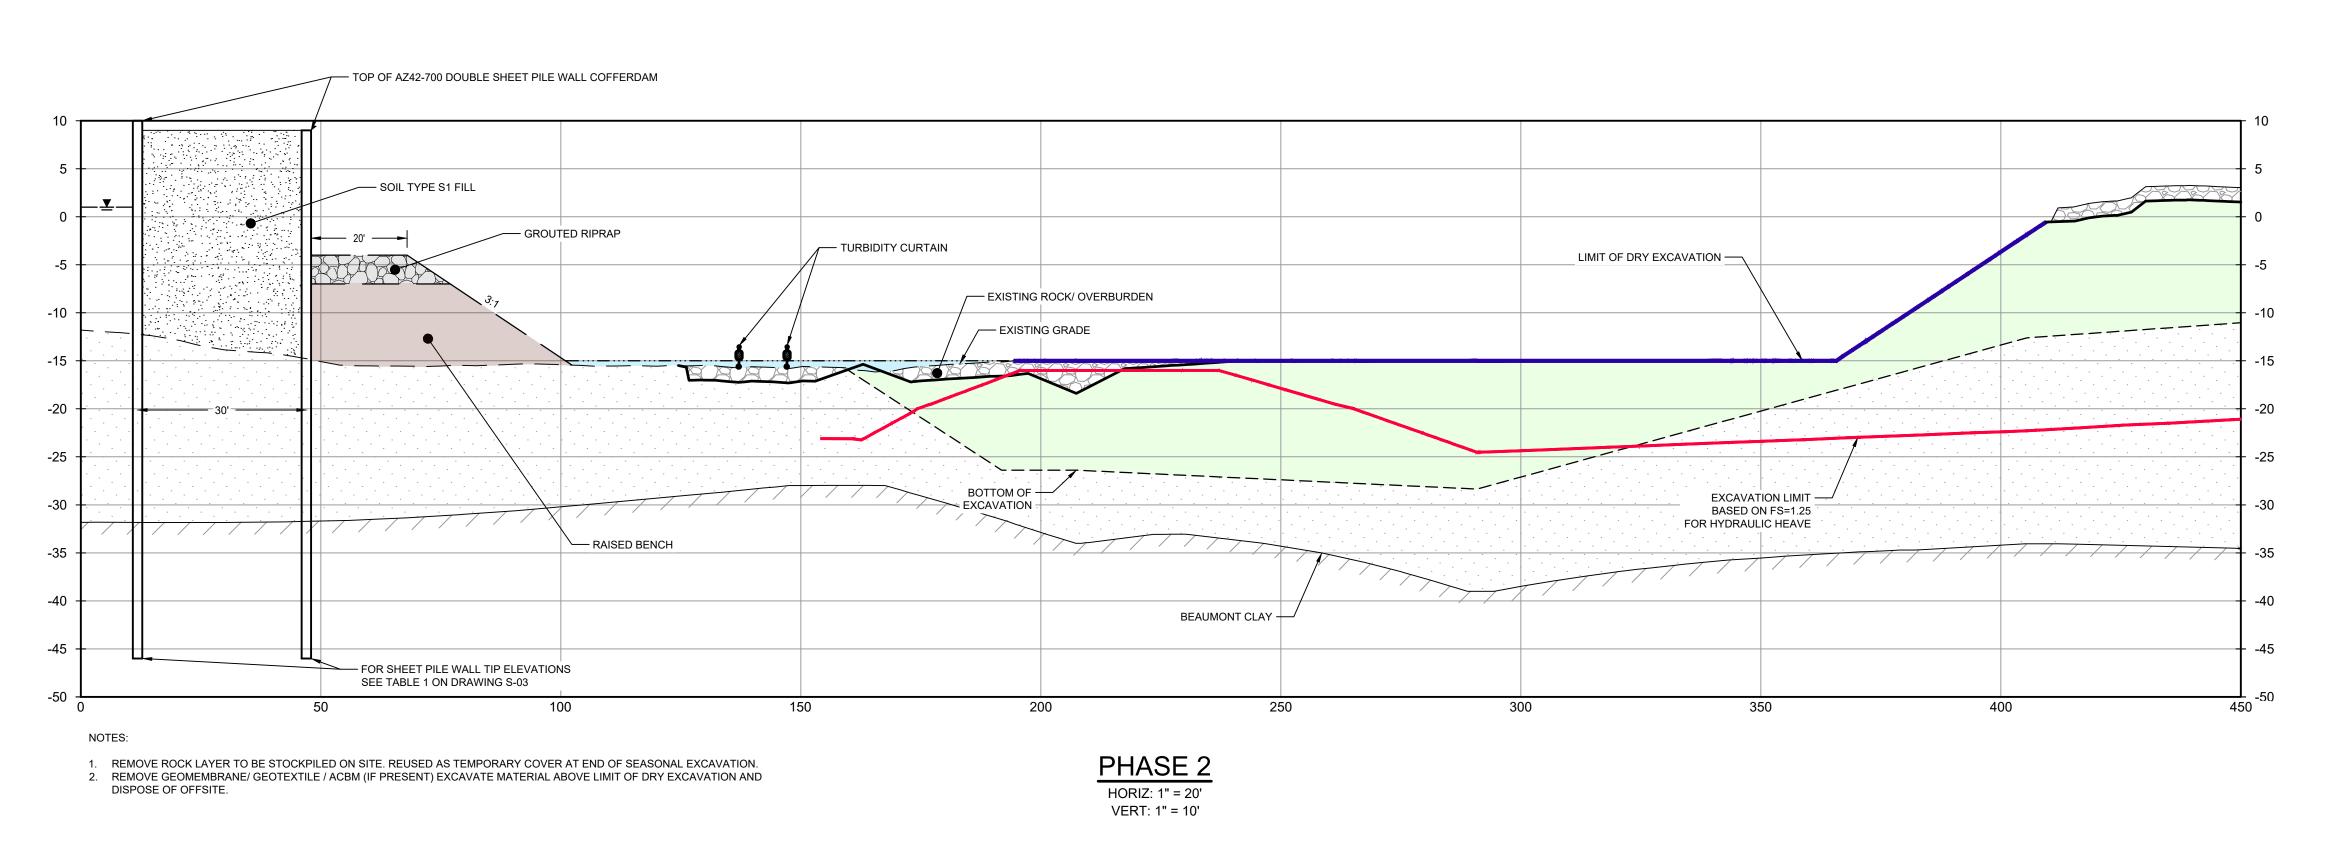

 BOTTOM OF EXCAVATION IS SUBJECT TO CHANGE.
 SCOUR PROTECTION ON INTERIOR AND EXTERIOR SIDE OF COFFERDAM NOT SHOWN. SEE DRAWINGS C-28 TO C-44 FOR LIMITS OF RIPRAP.


THIS DOCUMENT IS RELEASED FOR THE PURPOSE OF EPA REVIEW UNDER THE AUTHORITY OF WILLIAM ALLEN BEAL, P.E. 137828 ON 11/25/2024. IT IS NOT TO BE USED FOR CONSTRUCTION, BIDDING, RECORDATION, CONVEYANCE OR SALES PURPOSES.

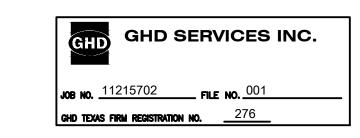

100% EPA SUBMITTAL



2237 S Acadian Thruway Suite 701
Baton Rouge Louisiana 70808 USA
T 225 292 9007

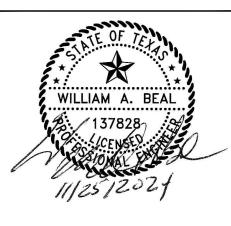

Reuse of Documents

This document and the ideas and designs incorporated herein, as an instrument of professional service, is the property of GHD and shall not be reused in whole or in part for any other project without GHD's written authorization. © 2024 GHD

<u>LEGEND</u>

EXCAVATION LIMIT BASED ON FS = 1.25 FOR HYDRAULIC HEAVE MATERIAL TO BE EXCAVATED

SAN JACINTO RIVER
WASTE PITS

NORTHERN IMPOUNDMENT FINAL 100% REMEDIAL DESIGN HARRIS COUNTY, TEXAS

4	100% EPA SUBMITTAL	JC	WB	11/25/
3	FOR CLIENT REVIEW	JC	WB	11/21/
2	100% EPA SUBMITTAL	MW	WB	07/17/
No.	Issue	Drawn	Approved	Da
Draw	n <b>JC</b>	Designer	RH	
Drafti Chec	° В5	Design Check	WB	
Proje Coor	ct dinator <b>CM</b>	Date	Nov 25, 20	024
	document shall not be used for uction unless signed and sealed for	Scale	AS SHOW	/N

Arch D

Project No. 11215702

construction.

Original Size


DREDGING NORTHWEST CORNER SEQUENCING 1 OF 3


Sheet No.

C-51

Sheet **52** of **83** 

Bar is one inch on original size drawing

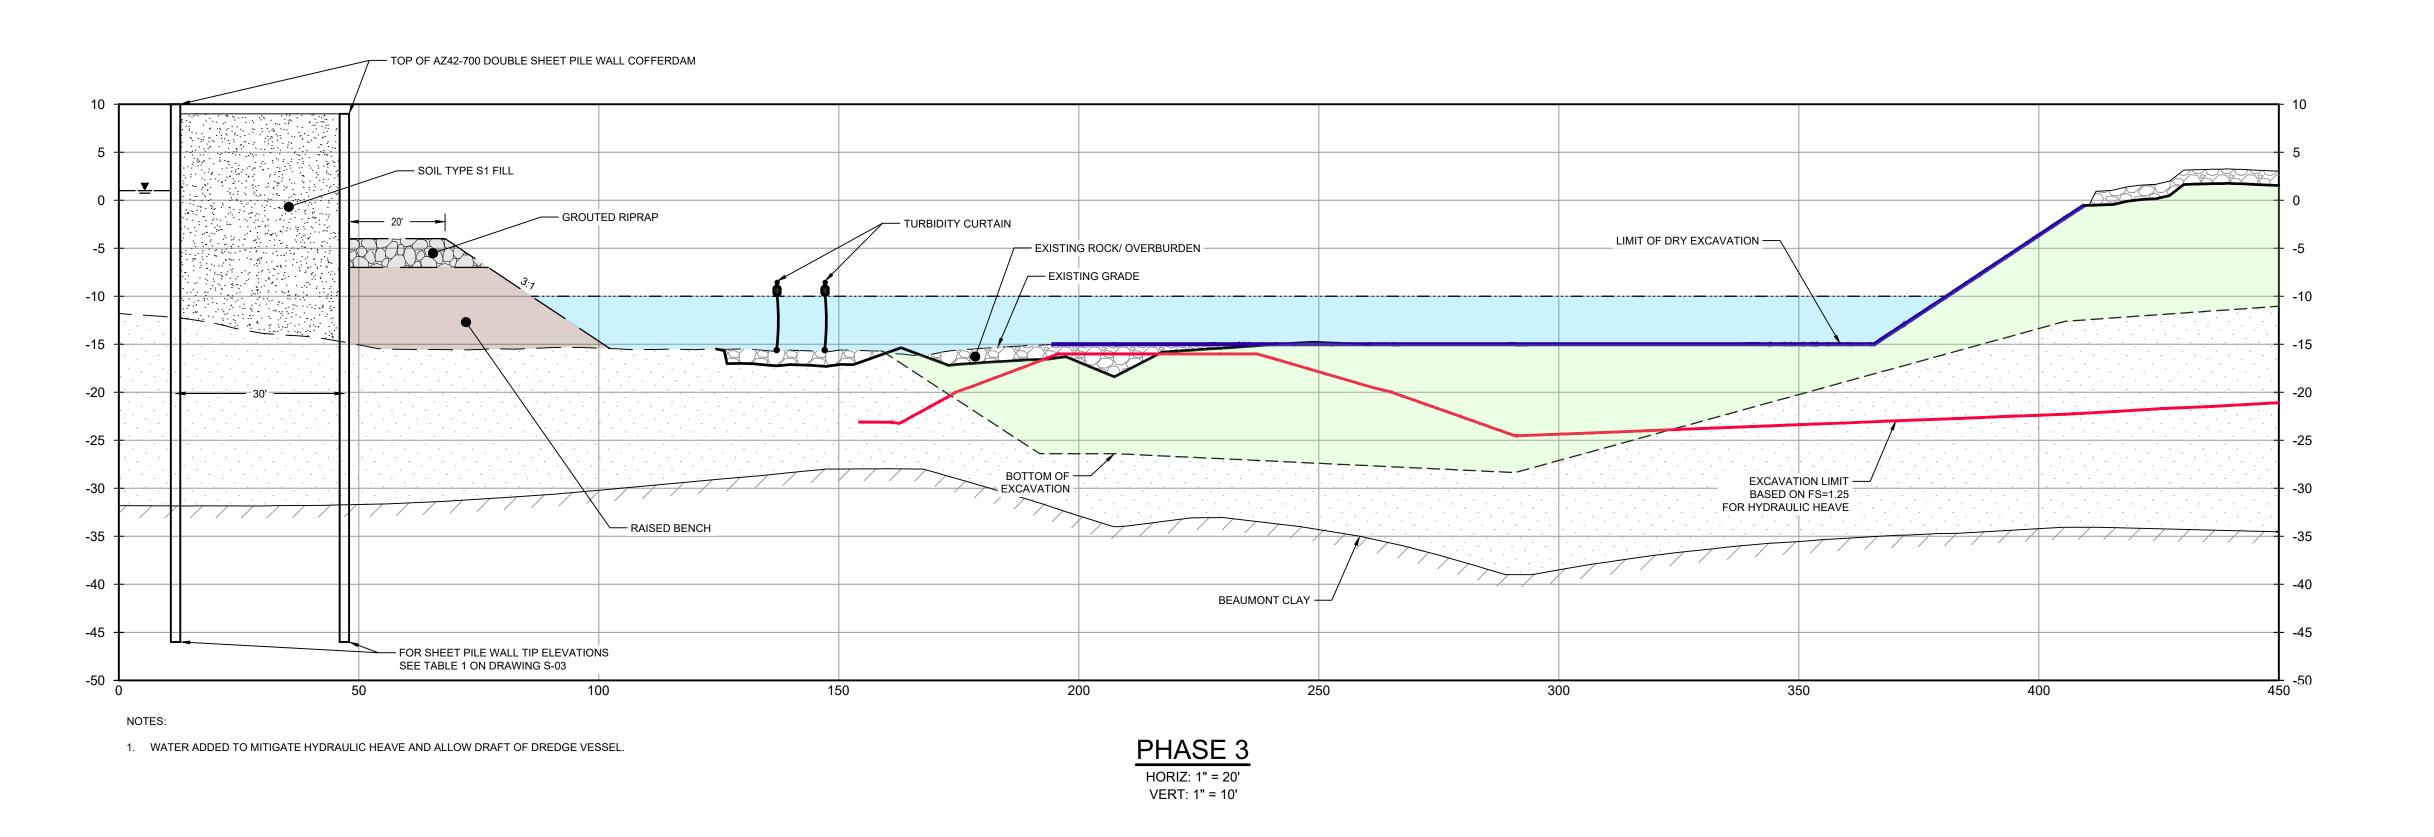

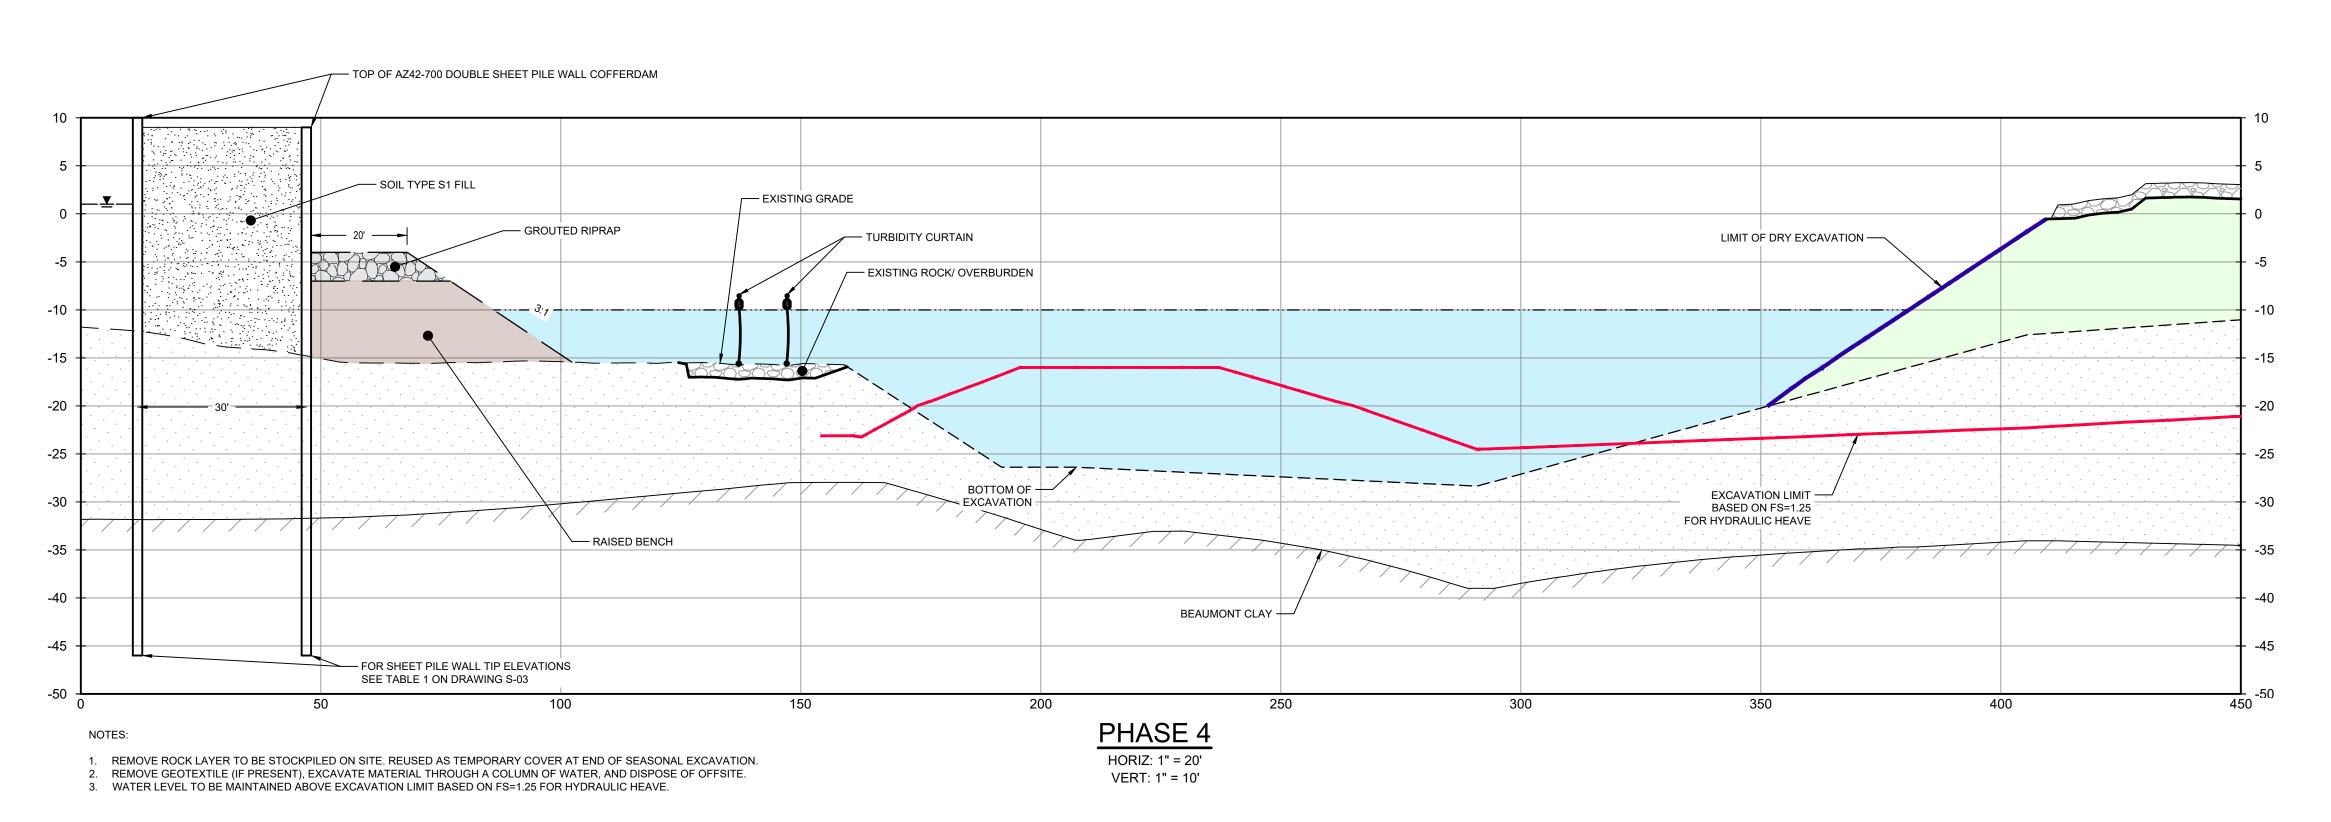

 BOTTOM OF EXCAVATION IS SUBJECT TO CHANGE.
 SCOUR PROTECTION ON INTERIOR AND EXTERIOR SIDE OF COFFERDAM NOT SHOWN. SEE DRAWINGS C-28 TO C-44 FOR LIMITS OF RIPRAP.


THIS DOCUMENT IS RELEASED FOR THE PURPOSE OF EPA REVIEW UNDER THE AUTHORITY OF WILLIAM ALLEN BEAL, P.E. 137828 ON 11/25/2024. IT IS NOT TO BE USED FOR CONSTRUCTION, BIDDING, RECORDATION, CONVEYANCE OR SALES PURPOSES.



100% EPA SUBMITTAL



2237 S Acadian Thruway Suite 701 Baton Rouge Louisiana 70808 USA **T** 225 292 9007

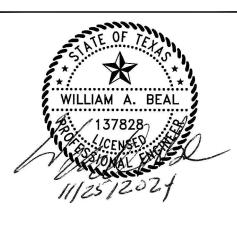

Reuse of Documents

This document and the ideas and designs incorporated herein, as an instrument of professional service, is the property of GHD and shall not be reused in whole or in part for any other project without GHD's written authorization. © 2024 GHD

<u>LEGEND</u>

EXCAVATION LIMIT BASED ON FS = 1.25 FOR HYDRAULIC HEAVE MATERIAL TO BE EXCAVATED

**SAN JACINTO RIVER WASTE PITS** 

NORTHERN IMPOUNDMENT FINAL 100% REMEDIAL DESIGN HARRIS COUNTY, TEXAS

п						
ı						
ı	4	100% EPA SUBMITTAL	JC	WB	11/25/20	
ı	3	FOR CLIENT REVIEW	JC	WB	11/21/20	
ı	2	100% EPA SUBMITTAL	MW	WB 07/17		
ı	No.	Issue	Drawn	Approved	Date	
ı	Draw	n <b>JC</b>	Designer	RH		
ı	Drafting BS Check		Design Check	WB		
	Project CM Coordinator		Date	Nov 25, 2024		
	This document shall not be used for construction unless signed and sealed for construction		Scale	AS SHOW	'N	

Bar is one inch on original size drawing Arch D

Project No. **11215702** 


Original Size


**DREDGING** NORTHWEST CORNER **SEQUENCING 2 OF 3** 

Sheet No.

C-52

Sheet **53** of **83** 

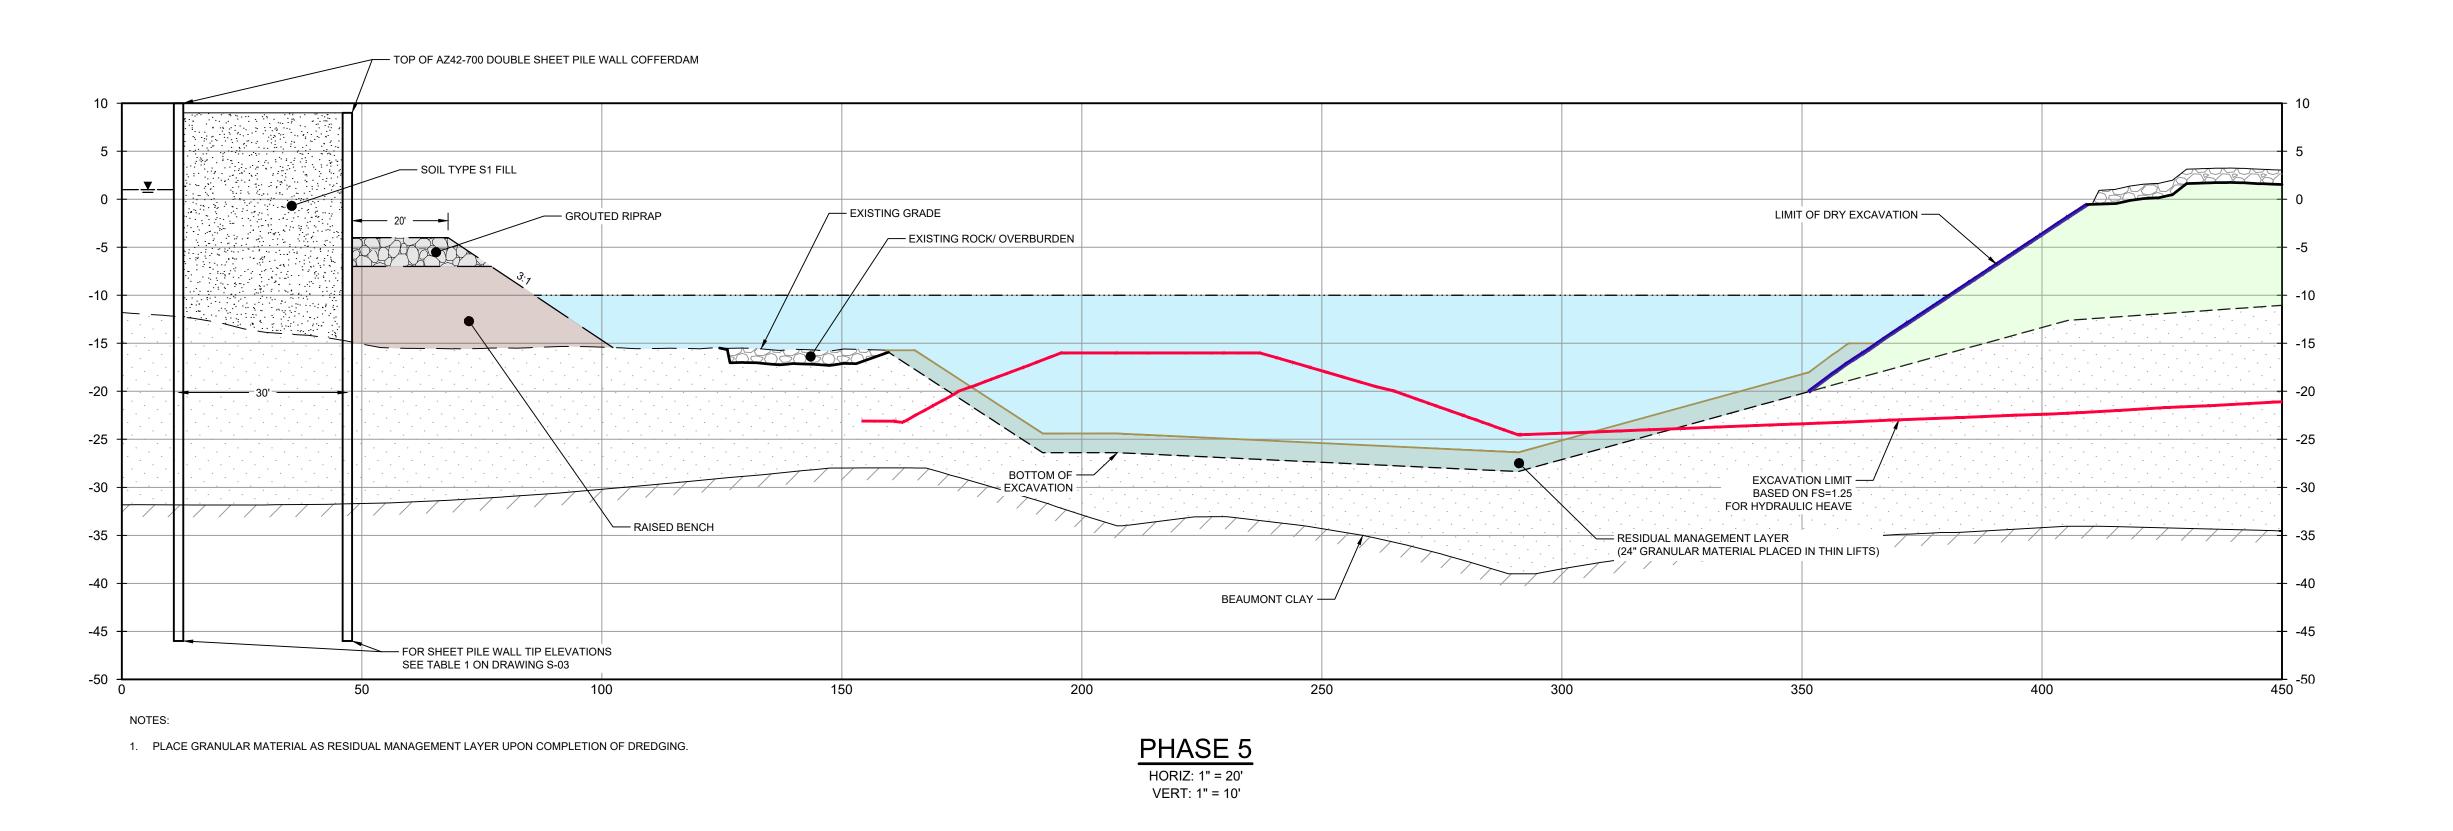


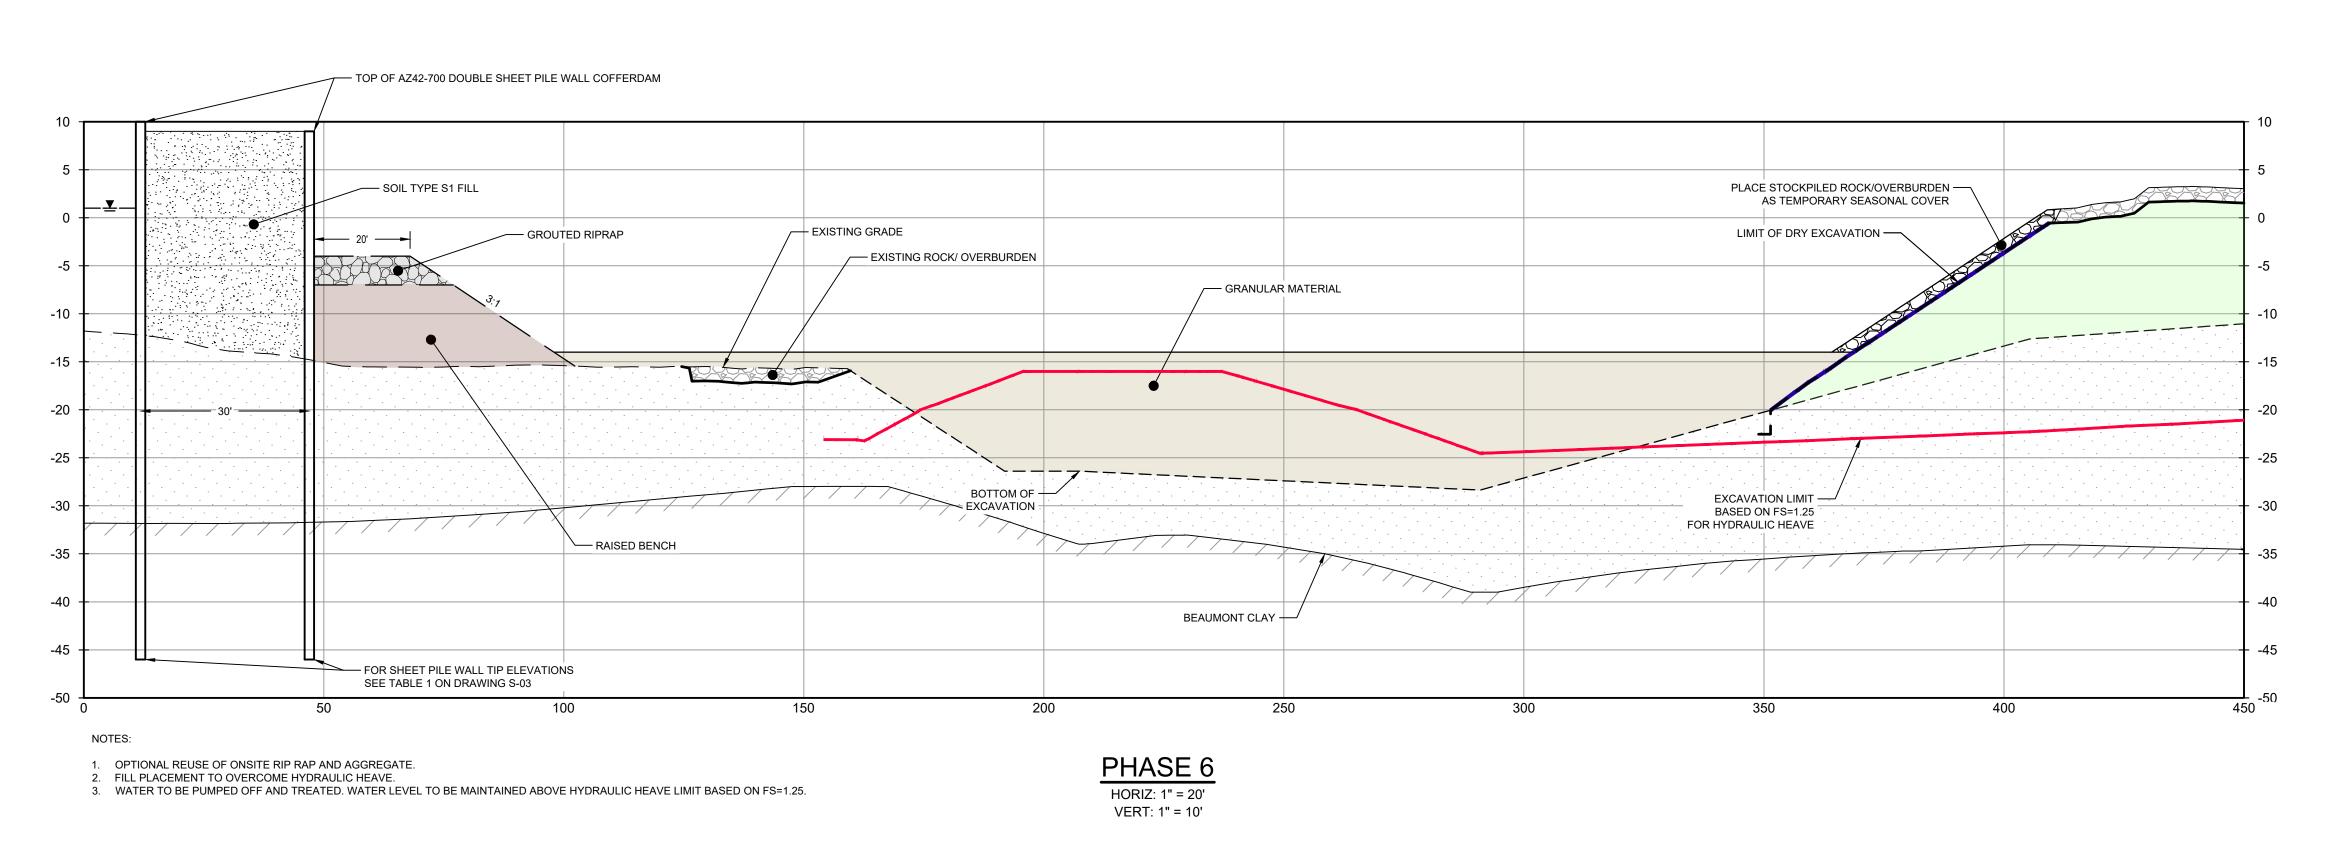

 BOTTOM OF EXCAVATION IS SUBJECT TO CHANGE.
 SCOUR PROTECTION ON INTERIOR AND EXTERIOR SIDE OF COFFERDAM NOT SHOWN. SEE DRAWINGS C-28 TO C-44 FOR LIMITS OF RIPRAP.

THIS DOCUMENT IS RELEASED FOR THE PURPOSE OF EPA REVIEW UNDER THE AUTHORITY OF WILLIAM ALLEN BEAL, P.E. 137828 ON 11/25/2024. IT IS NOT TO BE USED FOR CONSTRUCTION, BIDDING, RECORDATION,


CONVEYANCE OR SALES PURPOSES.

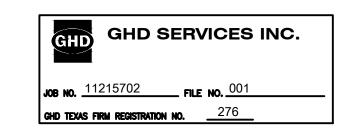

100% EPA SUBMITTAL




2237 S Acadian Thruway Suite 701 Baton Rouge Louisiana 70808 USA **T** 225 292 9007

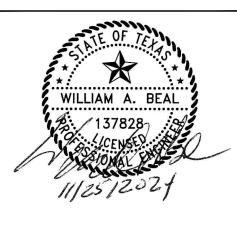

Reuse of Documents

This document and the ideas and designs incorporated herein, as an instrument of professional service, is the property of GHD and shall not be reused in whole or in part for any other project without GHD's written authorization. © 2024 GHD

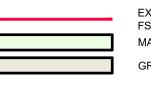

<u>LEGEND</u> EXCAVATION LIMIT BASED ON FS = 1.25 FOR HYDRAULIC HEAVE MATERIAL TO BE EXCAVATED GRANULAR MATERIAL

## **SAN JACINTO RIVER WASTE PITS**

NORTHERN IMPOUNDMENT FINAL 100% REMEDIAL DESIGN HARRIS COUNTY, TEXAS

4	100% EPA SUBMITTAL	JC	WB	11/25/20
3	FOR CLIENT REVIEW	JC	WB	11/21/20
2	100% EPA SUBMITTAL	MW	WB	07/17/20
No.	Issue	Drawn	Date	
Draw	n <b>JC</b>	Designer	RH	
Drafti Chec	o BS	Design Check	WB	
Project CM Coordinator		Date	Nov 25, 20	024
This document shall not be used for construction unless signed and sealed for construction		Scale	AS SHOW	/N

Original Size

Bar is one inch on original size drawing Arch D


Project No. **11215702** 


**DREDGING** NORTHWEST CORNER **SEQUENCING 3 OF 3** 


Sheet No.

**C-53** 


Sheet **54** of **83** 

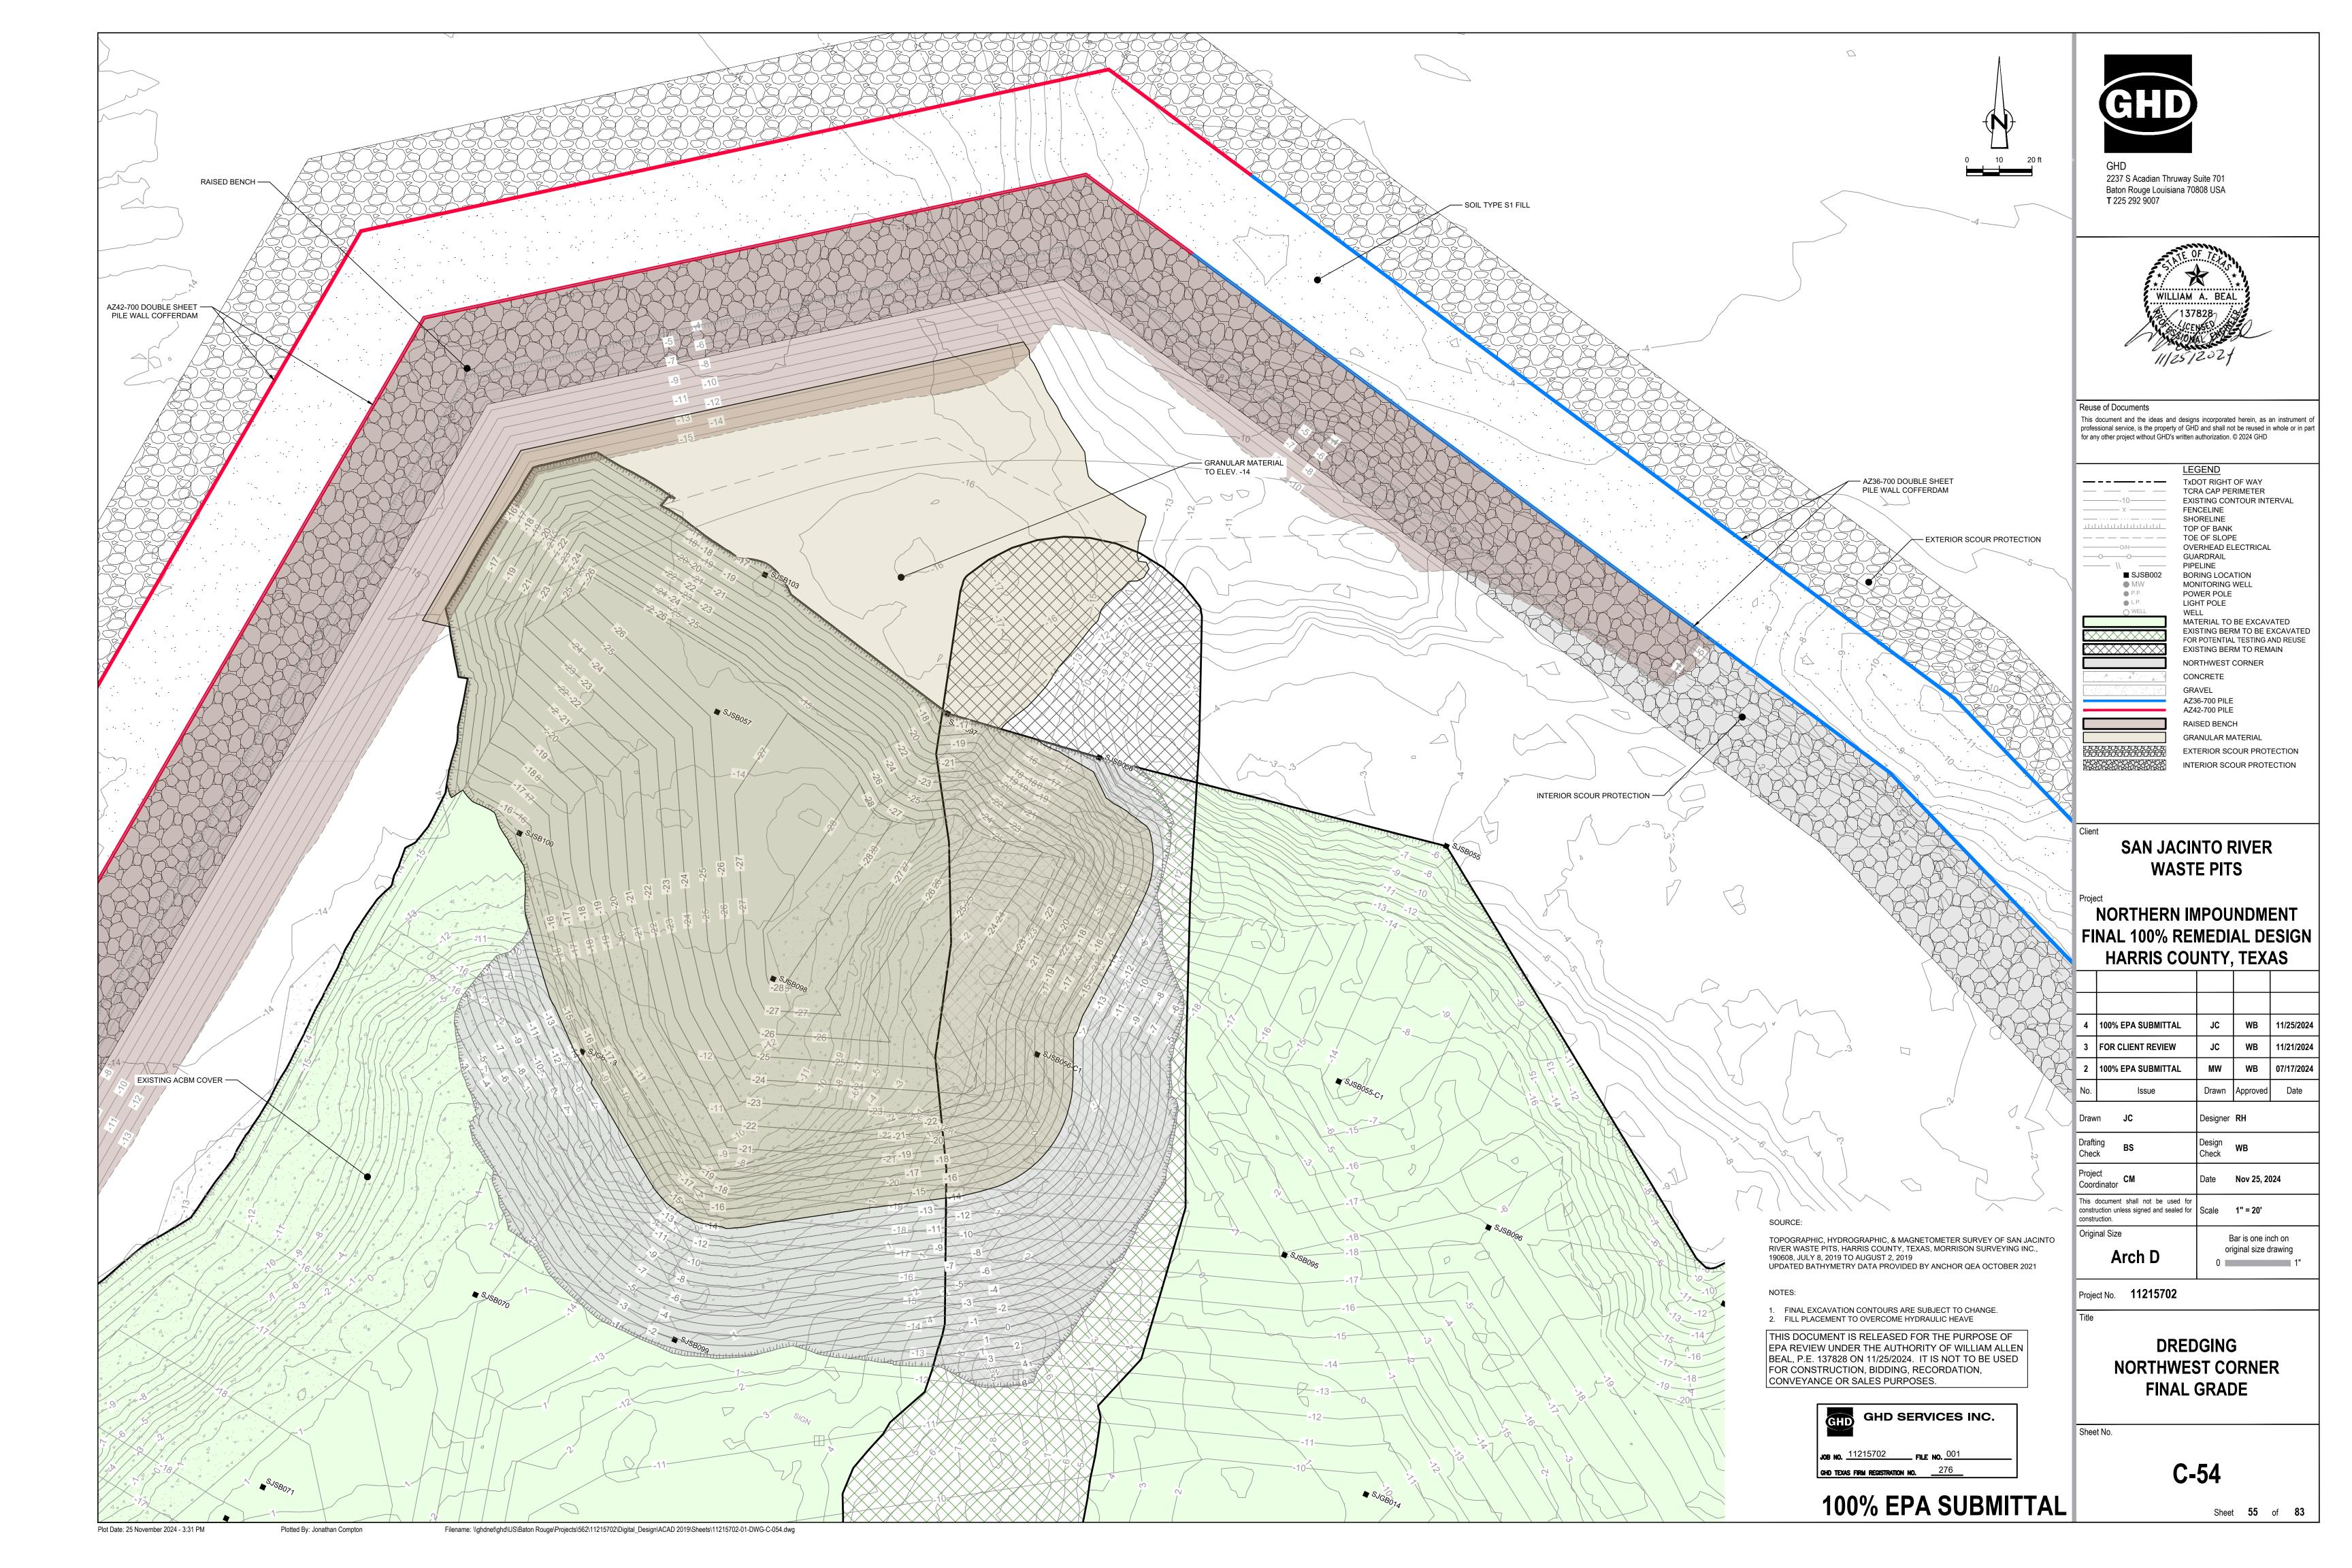

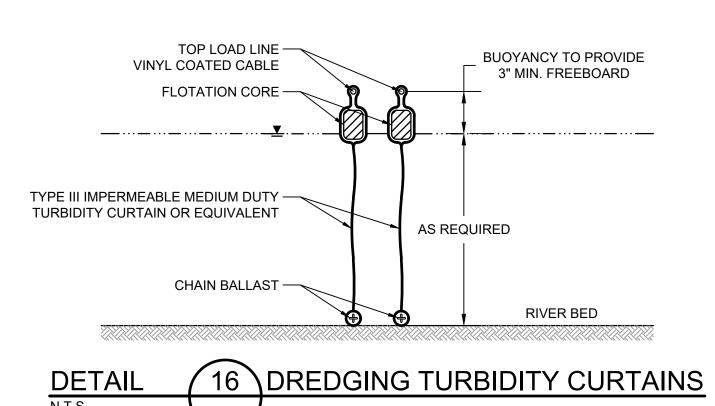


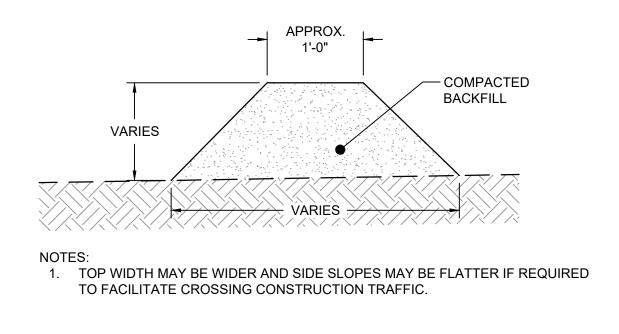



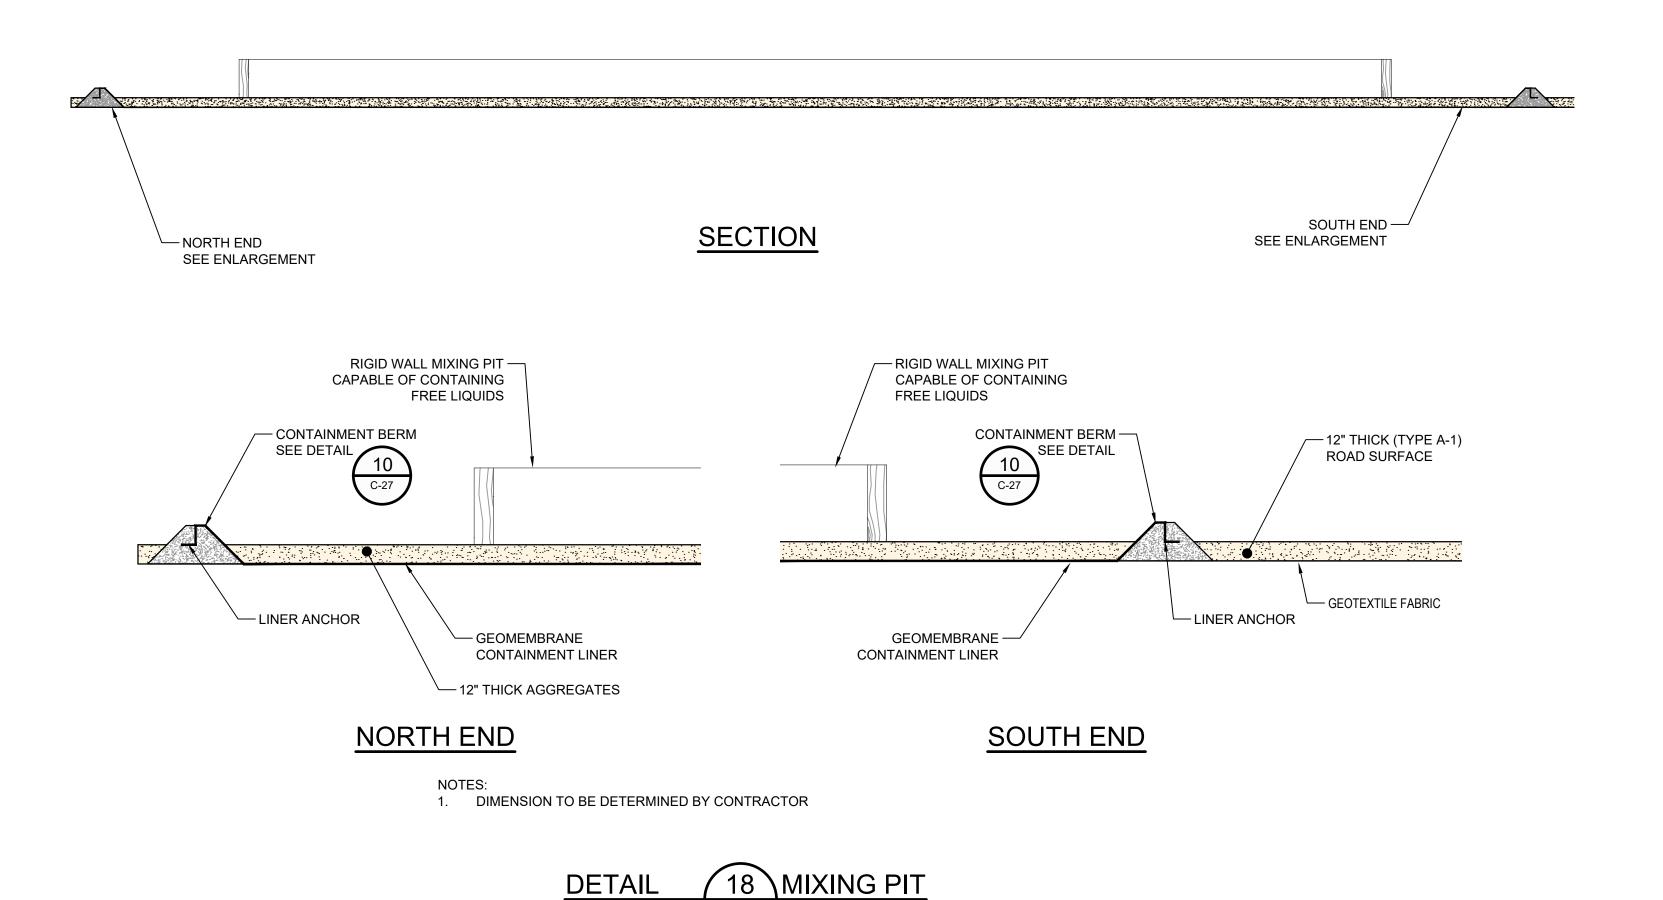

THIS DOCUMENT IS RELEASED FOR THE PURPOSE OF

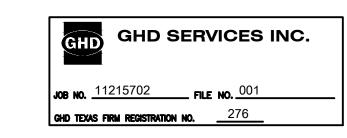


EPA REVIEW UNDER THE AUTHORITY OF WILLIAM ALLEN BEAL, P.E. 137828 ON 11/25/2024. IT IS NOT TO BE USED

FOR CONSTRUCTION, BIDDING, RECORDATION,

CONVEYANCE OR SALES PURPOSES.

100% EPA SUBMITTAL



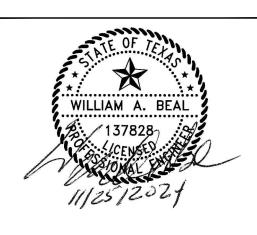

Reuse of Documents

This document and the ideas and designs incorporated herein, as an instrument of professional service, is the property of GHD and shall not be reused in whole or in part for any other project without GHD's written authorization. © 2024 GHD

SAN JACINTO RIVER
WASTE PITS

NORTHERN IMPOUNDMENT FINAL 100% REMEDIAL DESIGN HARRIS COUNTY, TEXAS

4	100% EPA SUBMITTAL	JC	WB	11/25/20
3	FOR CLIENT REVIEW	JC	WB	11/21/20
2	100% EPA SUBMITTAL	MW	WB	07/17/20
No.	Issue	Drawn	Approved	Date
Draw	n <b>JC</b>	Designer	RH	
Drafti Chec	° В5	Design Check	WB	
Project CM Coordinator		Date	Nov 25, 20	)24
This document shall not be used for construction unless signed and sealed for construction.		Scale	AS SHOW	/N
Original Size		В	ar is one in	ch on

Project No. 11215702

Arch D

Title


DREDGING NORTHWEST CORNER DREDGING DETAILS


Sheet No.

C-55

Sheet **56** of **83** 

original size drawing

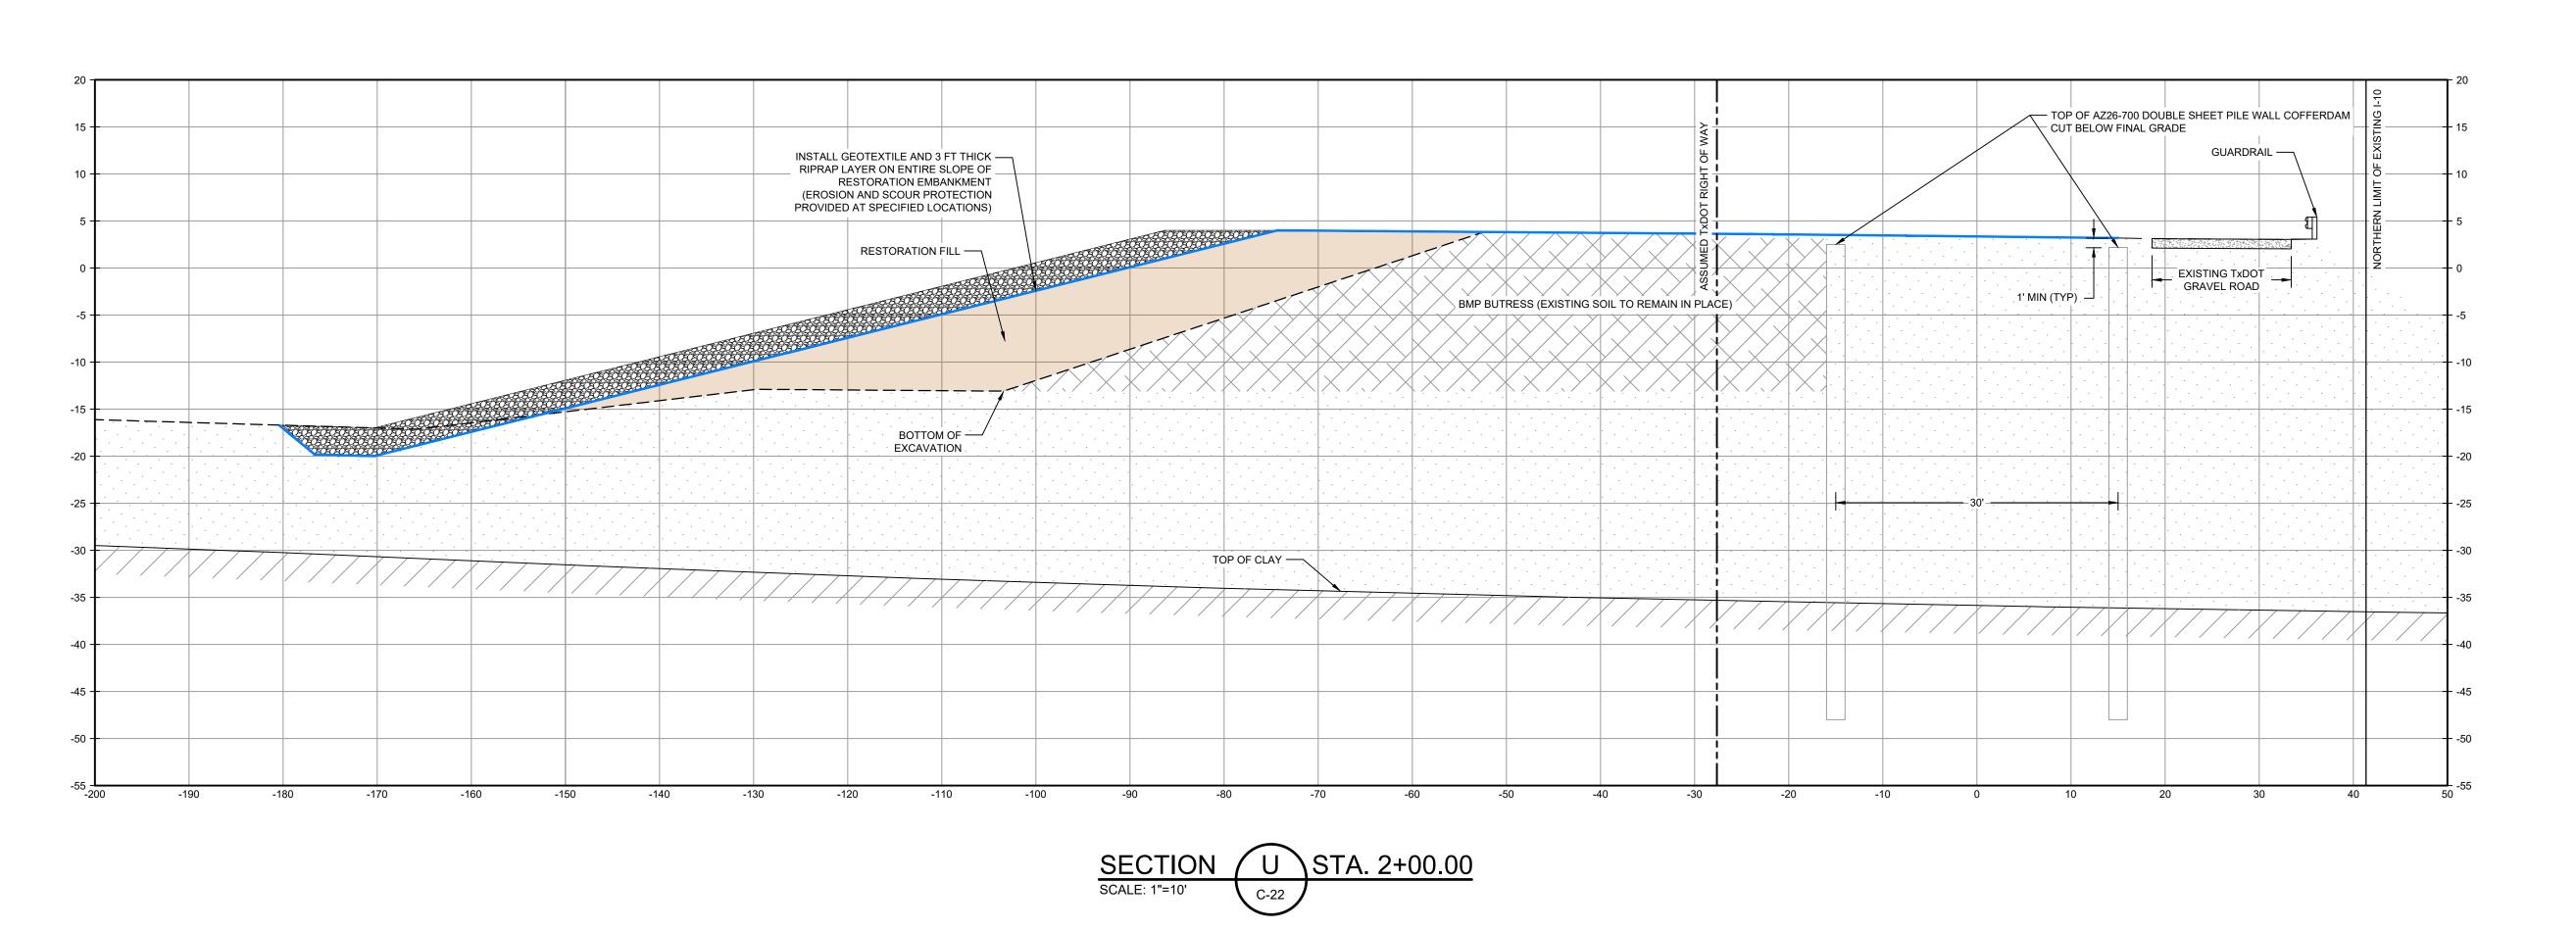

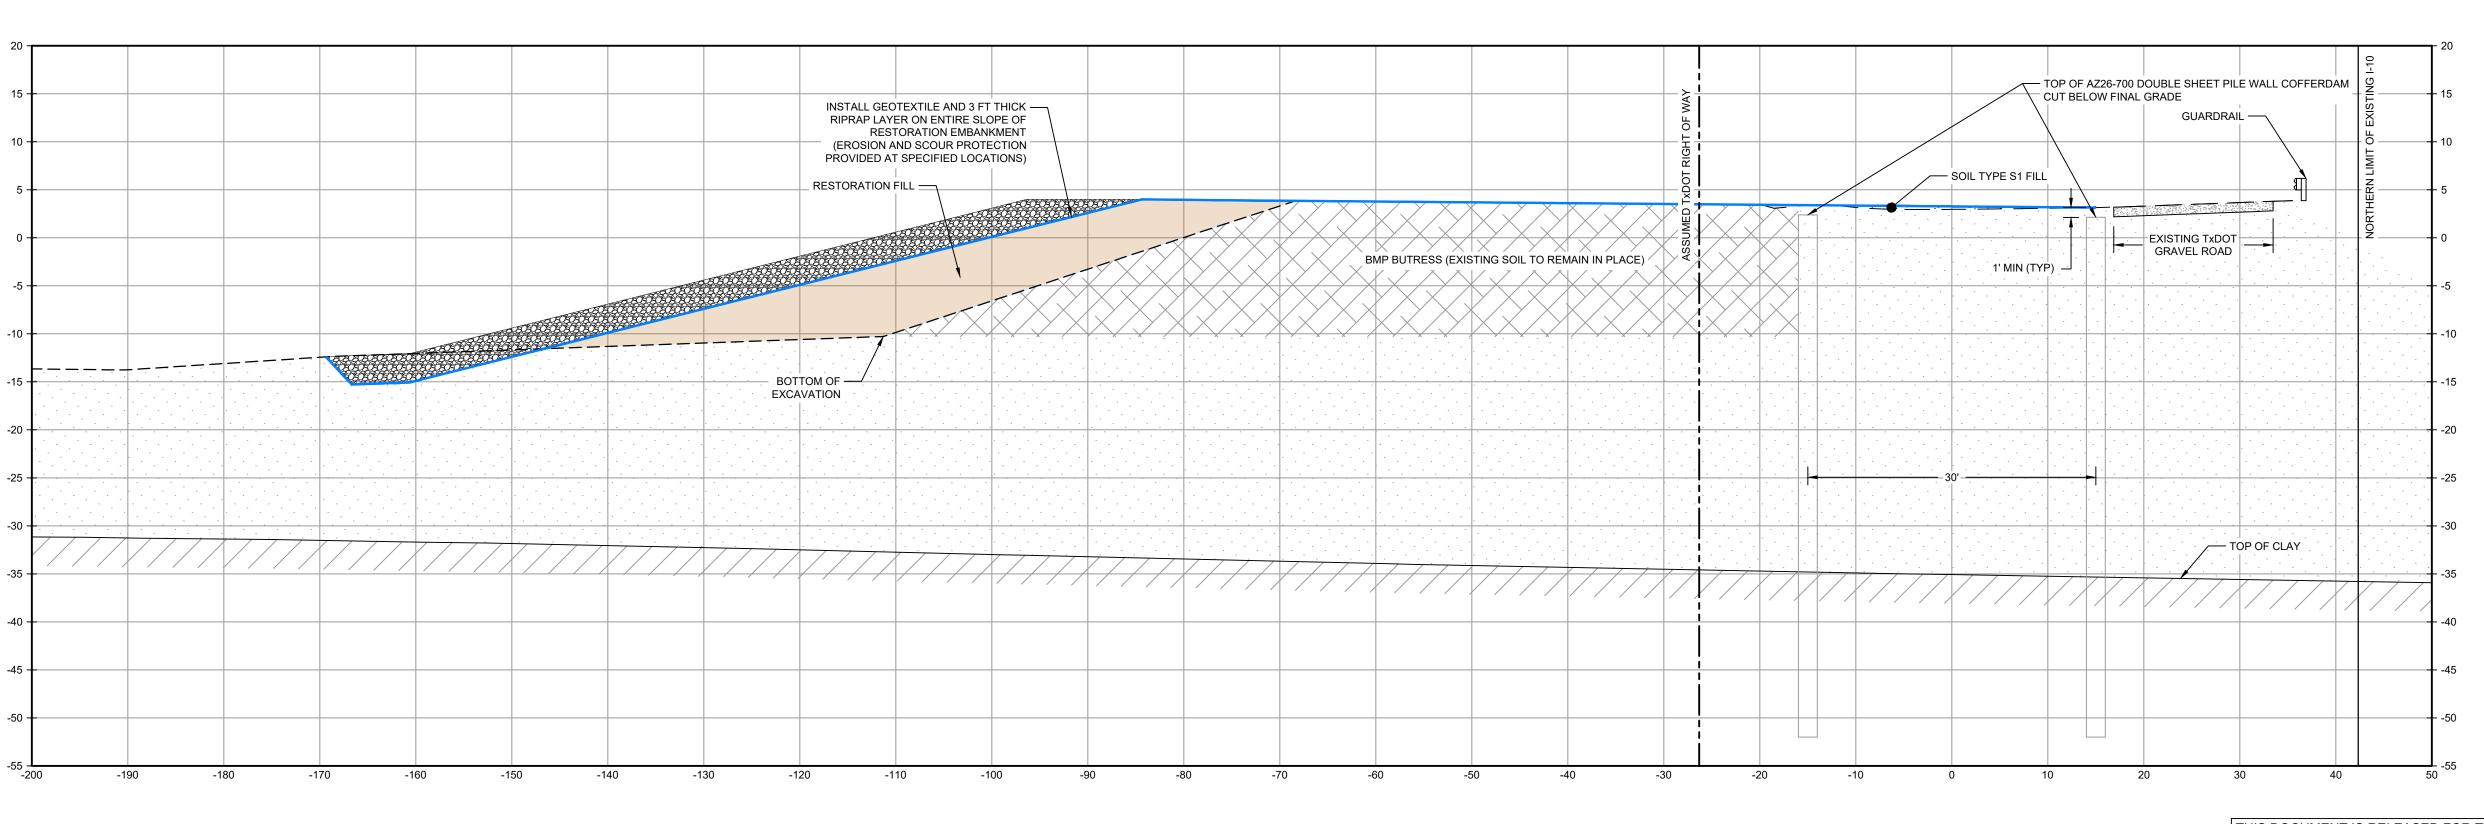


SECTION V STA. 4+00.00

THIS DOCUMENT IS RELEASED FOR THE PURPOSE OF EPA REVIEW UNDER THE AUTHORITY OF CLARENCE R. HOEKSTRA, P.E. 147396 ON 11/25/2024. IT IS NOT TO BE USED FOR CONSTRUCTION, BIDDING, RECORDATION, CONVEYANCE OR SALES PURPOSES.

TXDOT RIGHT OF WAY FROM A BOUNDARY AND RIGHT-OF-WAY SURVEY OF PORT OF HOUSTON AUTHORITY PROPERTY & HOUSTON FLEETING SERVICES, LLC PROPERTY ALONG INTERSTATE HIGHWAY 10 AT THE SAN JACINTO FLEET AREA, IN THE J. T. HARRELL SURVEY, A-330 HARRIS COUNTY, TEXAS, COBBFENDLEY, 2402-028-01, JUNE 28, 2024

NOTES:

1. BOTTOM OF EXCAVATION IS SUBJECT TO CHANGE.

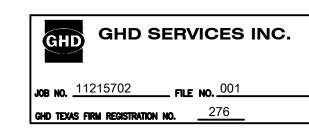

100% EPA SUBMITTAL



2237 S Acadian Thruway Suite 701 Baton Rouge Louisiana 70808 USA **T** 225 292 9007



Reuse of Documents

This document and the ideas and designs incorporated herein, as an instrument of professional service, is the property of GHD and shall not be reused in whole or in part for any other project without GHD's written authorization. © 2024 GHD

<u>LEGEND</u>

RESTORED AREA INCLUDING SOIL BACKFILL AND EROSION CONTROL (NOT SHOWN) RESTORATION EMBANKMENT 

SAN JACINTO RIVER **WASTE PITS** 

NORTHERN IMPOUNDMENT FINAL 100% REMEDIAL DESIGN HARRIS COUNTY, TEXAS

ı					
ı					
ı	3	100% EPA SUBMITTAL	JC	CRH	11/25/20
ı	2	FOR CLIENT REVIEW	JC	CRH	11/21/20
ı	1	100% EPA SUBMITTAL	MW	CRH	07/17/20
ı	No.	Issue	Drawn	Approved	Date
ı	Draw	n <b>JC</b>	Designer	RH	
ı	Drafting BS Check		Design Check	WB	
	Project CM Coordinator		Date	Nov 25, 2024	
		document shall not be used for uction unless signed and sealed for	Scale	AS SHOW	/N

Original Size Arch D

Bar is one inch on original size drawing


Project No. **11215702** 


**RESTORATION SECTIONS** 1 OF 2

Sheet No.

C-56

Sheet **57** of **83** 

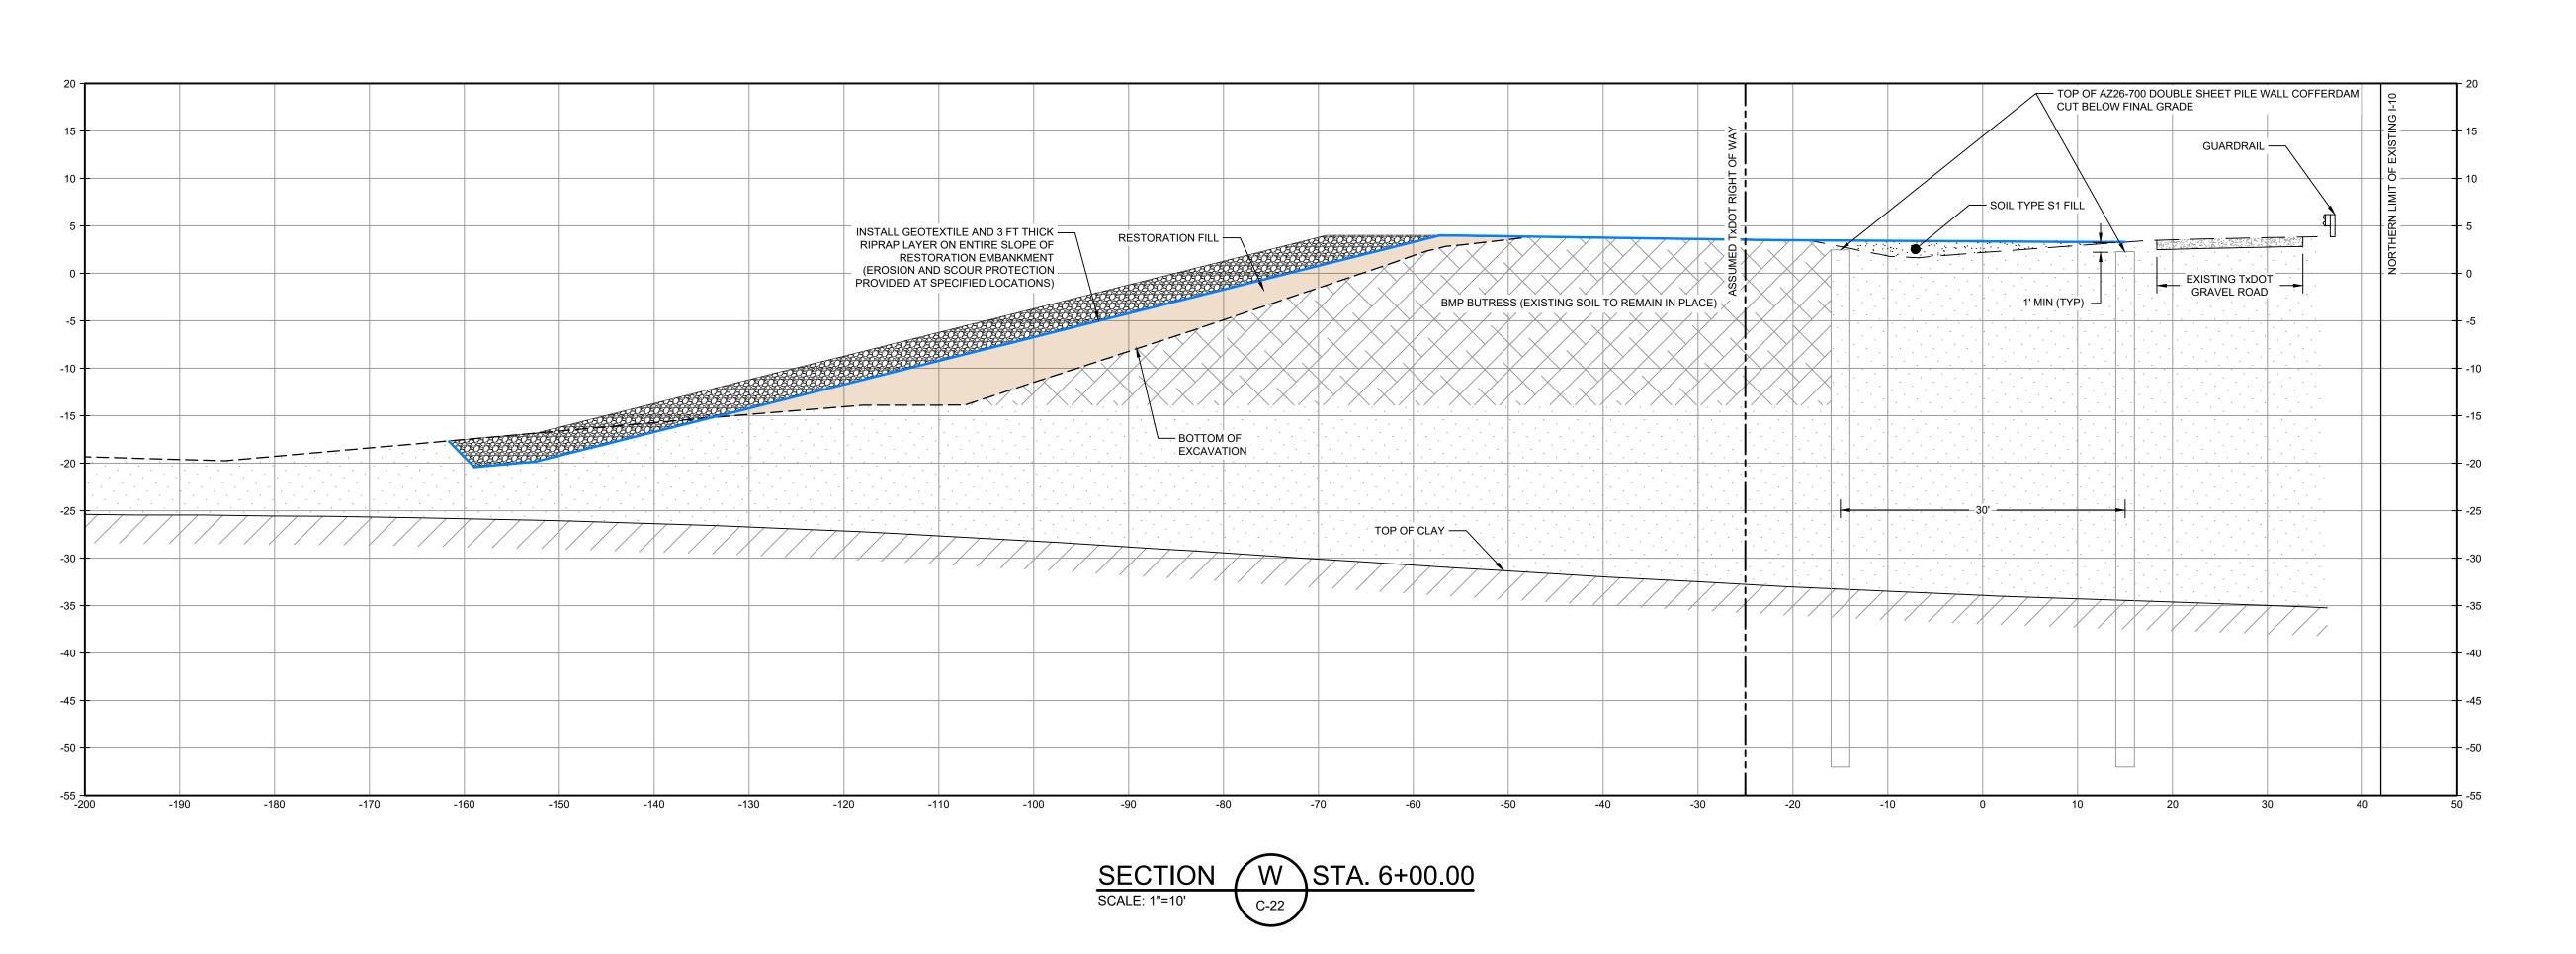

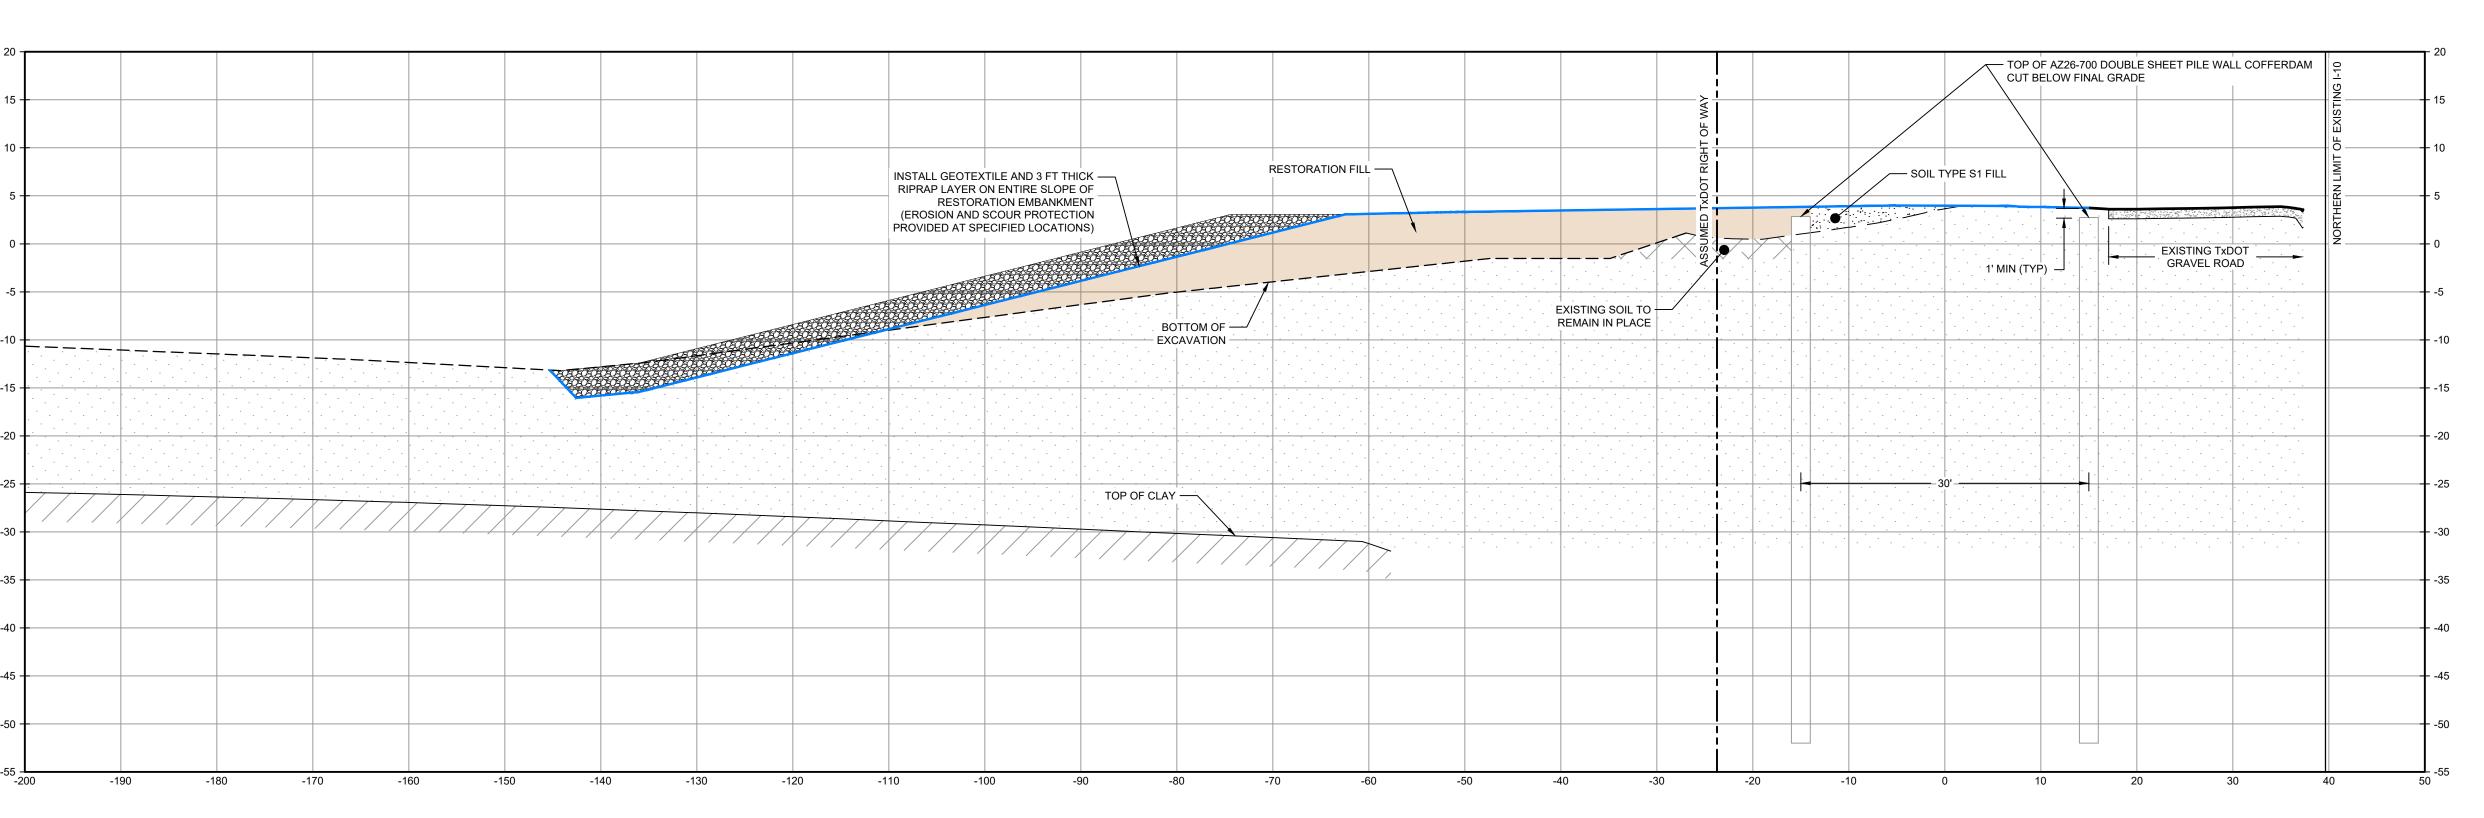

SECTION X STA. 8+00.00 SCALE: 1"=10' C-22 THIS DOCUMENT IS RELEASED FOR THE PURPOSE OF EPA REVIEW UNDER THE AUTHORITY OF CLARENCE R. HOEKSTRA, P.E. 147396 ON 11/25/2024. IT IS NOT TO BE USED FOR CONSTRUCTION, BIDDING, RECORDATION, CONVEYANCE OR SALES PURPOSES.

SOURCE:
TxDOT RIGHT OF WAY FROM A BOUNDARY AND RIGHT-OF-WAY SURVEY OF PORT
OF HOUSTON AUTHORITY PROPERTY & HOUSTON FLEETING SERVICES, LLC
PROPERTY ALONG INTERSTATE HIGHWAY 10 AT THE SAN JACINTO FLEET AREA,
IN THE J. T. HARRELL SURVEY, A-330 HARRIS COUNTY, TEXAS, COBBFENDLEY,
2402-028-01, JUNE 28, 2024

NOTES:

1. BOTTOM OF EXCAVATION IS SUBJECT TO CHANGE.



100% EPA SUBMITTAL



2237 S Acadian Thruway Suite 701
Baton Rouge Louisiana 70808 USA
T 225 292 9007



Reuse of Documents

This document and the ideas and designs incorporated herein, as an instrument of professional service, is the property of GHD and shall not be reused in whole or in part for any other project without GHD's written authorization. © 2024 GHD

LEGEND

RESTORED AREA INCLUDING SOIL BACKFILL AND EROSION CONTROL (NOT SHOWN) RESTORATION EMBANKMENT

C

# SAN JACINTO RIVER WASTE PITS

NORTHERN IMPOUNDMENT
FINAL 100% REMEDIAL DESIGN
HARRIS COUNTY, TEXAS

3	100% EPA SUBMITTAL	JC	CRH	11/25/202	
2	FOR CLIENT REVIEW	JC	CRH	11/21/202	
1	100% EPA SUBMITTAL	MW	CRH 07/17/2		
No.	Issue	Drawn	Approved	Date	
Draw	n <b>JC</b>	Designer	RH		
Drafti Chec	° В5	Design Check	WB		
Project CM Coordinator		Date	Nov 25, 20	)24	
This document shall not be used for construction unless signed and sealed for construction		Scale	AS SHOW	/N	

Original Size

Arch D

Arch D

Bar is one inch on original size drawing

0 1

Project No. **11215702** 

Title

RESTORATION SECTIONS

2 OF 2

Sheet No.

C-57

Sheet **58** of **83** 

#### <u>GENERAL</u>

- 1. VERIFY ALL DIMENSIONS AND EXISTING CONDITIONS BEFORE COMMENCING WORK. REPORT ANY DISCREPANCIES AND/OR INCONSISTENCIES TO THE OWNER FOR CLARIFICATION.
- 2. TEMPORARILY BRACE PILES AFTER DRIVING UNTIL TIE RODS ARE INSTALLED.

#### CODES AND GUIDELINES

- ASCE MINIMUM DESIGN LOADS AND ASSOCIATED CRITERIA FOR BUILDING AND OTHER STRUCTURES, ASCE 7, 2016 USACE ENGINEERING MANUAL, DESIGN OF SHEET PILE WALLS BY UNITED STATES ARMY CORPS OF ENGINEERS, EM 1110 2 2504
- AMERICAN INSTITUTE OF STEEL CONTRACTORS, STEEL CONSTRUCTION MANUAL 15TH EDITION, AISC 360-16.
- USACE HURRICANE AND STORM DAMAGE RISK REDUCTION SYSTEM DESIGN GUIDELINES, UPDATED JUNE 2012.
- AMERICAN ASSOCIATION OF STATE HIGHWAY AND TRANSPORTATION OFFICIALS, LRFD BRIDGE DESIGN SPECIFICATIONS, 2012.

#### **MATERIALS**

STEEL:

 BARS AND C, MC, AND L SHAPES ASTM A36, GALV, UNO

 SHEET PILE ASTM A572. GRADE 60

ASTM A252, GRADE 3 MODIFIED TO MEET ASTM A572 GRADE 55 PIPE PILES

 TIE ROD ASSEMBLY THREADED BARS GRADE 80 KSI BEARING PLATE ASTM A572/A588 GRADE 50 HARDENED WASHER ASTM F436 HEX NUT WITH JAM NUT ASTM 108/S576

 GALVANIZED BOLTS FOR SPLICE CONNECTIONS ASTM A325 WITH A563 NUTS AND HARDENED WASHER

#### STRUCTURAL STEEL AND MISCELLANEOUS METAL

- 1. WELDING SHALL CONFORM TO "STRUCTURAL WELDING CODE STEEL" (AWS D1.1).
- 2. PROVIDE 1" DIAMETER BLEED HOLES IN WALERS AT 10'-0" ON CENTER MAX, AVOID CONTACT WITH SPLICE PLATE CONNECTION.

#### FRP BARRIER WALL

PIPE PILE FENDER WALERS BOLTS NUTS

WASHERS

SPECIFICATION 31 62 23 SPECIFICATION 06 71 13 ASTM A193 316L STAINLESS STEEL GRADE B8M ASTM F594 TYPE 316L STAINLESS STEEL 316L STAINLESS STEEL

#### SECTION C1

CONSTRUCTION SEQUENCE

1. INSTALL LEFT AND RIGHT SHEET PILE WALL

2. INSTALL FILL UP TO EL. +3 FT UNIFORMLY OVER MIN 10 DAYS 3. INSTALL TIE ROD AT ELEVATION NOTED ON SHEET S-03

4. INSTALL FILL UP TO EL. +9 FT UNIFORMLY OVER MIN 6 DAYS 5. MINIMUM TIME FOR DEWATERING TO EXISTING MUDLINE: 4 DAYS

6. MINIMUM TIME FOR EXCAVATING TO 50% DEPTH: 17 DAYS 7. MINIMUM TIME FOR DEWATERING TO FINAL LEVEL: 3 DAYS 8. MINIMUM TIME FOR EXCAVATING TO 100% DEPTH: 14 DAYS

#### SECTION C2

1. INSTALL LEFT AND RIGHT SHEET PILE WALL 2. INSTALL FILL UP TO EL. -7 FT UNIFORMLY OVER MIN 7 DAYS 3. INSTALL TIE ROD AT ELEVATION NOTED ON SHEET S-03

4. INSTALL FILL UP TO EL. -1 FT UNIFORMLY OVER MIN 7 DAYS 5. INSTALL FILL UP TO EL. +5 FT UNIFORMLY OVER MIN 7 DAYS 6. INSTALL FILL UP TO EL. +9 FT UNIFORMLY OVER MIN 7 DAYS

7. INSTALL RAISED BENCH TO EL -9 FT, SLOPED AT 4H:1V AND WAIT 7 DAYS. 8. INSTALL RAISED BENCH FROM EL -9 FT TO EL -4 FT, SLOPED AT 4H:1V, TOP WIDTH

OF MIN 20-FT AND WAIT 7 DAYS BEFORE DEWATERING. 9. MINIMUM TIME FOR DEWATERING TO EXISTING MUDLINE: 4 DAYS 10. MINIMUM TIME FOR EXCAVATING TO 50% DEPTH: 17 DAYS

11. MINIMUM TIME FOR DEWATERING TO FINAL LEVEL: 3 DAYS 12. MINIMUM TIME FOR EXCAVATING TO 100% DEPTH: 14 DAYS

#### SECTION C3

1. INSTALL LEFT AND RIGHT SHEET PILE WALL

2. INSTALL FILL UP TO EL. +0 FT UNIFORMLY OVER MIN 10 DAYS 3. INSTALL TIE ROD AT ELEVATION NOTED ON SHEET S-03 4. INSTALL FILL UP TO EL. +3 FT UNIFORMLY OVER MIN 3 DAYS

5. INSTALL FILL UP TO EL. +9 FT UNIFORMLY OVER MIN 10 DAYS 6. MINIMUM TIME FOR DEWATERING TO EXISTING MUDLINE: 4 DAYS 7. MINIMUM TIME FOR EXCAVATING TO 50% DEPTH: 17 DAYS

8. MINIMUM TIME FOR DEWATERING TO FINAL LEVEL: 3 DAYS 9. MINIMUM TIME FOR EXCAVATING TO 100% DEPTH: 14 DAYS

#### SECTION C4A

1. INSTALL LEFT AND RIGHT SHEET PILE WALL

2. INSTALL FILL UP TO EL. +0 FT UNIFORMLY OVER MIN 10 DAYS

3. INSTALL TIE ROD AT ELEVATION NOTED ON SHEET S-03 4. INSTALL FILL UP TO EL. +9 FT UNIFORMLY OVER MIN 6 DAYS 5. MINIMUM TIME FOR DEWATERING TO EXISTING MUDLINE: 4 DAYS

6. MINIMUM TIME FOR EXCAVATING TO 50% DEPTH: 17 DAYS 7. MINIMUM TIME FOR DEWATERING TO FINAL LEVEL: 3 DAYS

8. MINIMUM TIME FOR EXCAVATING TO 100% DEPTH: 14 DAYS

#### SECTION C4

1. INSTALL LEFT AND RIGHT SHEET PILE WALL

2. INSTALL FILL UP TO EL. -3 FT UNIFORMLY OVER MIN 10 DAYS

3. INSTALL TIE ROD AT ELEVATION NOTED ON SHEET S-03

4. INSTALL FILL UP TO EL. +9 FT UNIFORMLY OVER MIN 6 DAYS 5. MINIMUM TIME FOR DEWATERING TO EXISTING MUDLINE: 4 DAYS

6. MINIMUM TIME FOR EXCAVATING TO 50% DEPTH: 17 DAYS

7. MINIMUM TIME FOR DEWATERING TO FINAL LEVEL: 3 DAYS

8. MINIMUM TIME FOR EXCAVATING TO 100% DEPTH: 14 DAYS

#### SECTION C5

1. INSTALL LEFT AND RIGHT SHEET PILE WALL

2. INSTALL FILL UP TO EL. -1 FT UNIFORMLY OVER MIN 10 DAYS

3. INSTALL TIE ROD AT ELEVATION NOTED ON SHEET S-03

4. INSTALL FILL UP TO EL. +9 FT UNIFORMLY OVER MIN 6 DAYS 5. MINIMUM TIME FOR DEWATERING TO EXISTING MUDLINE: 4 DAYS

6. MINIMUM TIME FOR EXCAVATING TO 50% DEPTH: 17 DAYS 7. MINIMUM TIME FOR DEWATERING TO FINAL LEVEL: 3 DAYS

### 8. MINIMUM TIME FOR EXCAVATING TO 100% DEPTH: 14 DAYS

#### SECTION C6, C7

1. INSTALL LEFT AND RIGHT SHEET PILE WALL

2. CUT BETWEEN THE SHEET PILES TO ELEVATION 0 FT

3. INSTALL TIE RODS AT ELEVATION NOTED ON SHEET S-03 4. INSTALL FILL UP TO EL. +9 FT UNIFORMLY OVER MIN 6 DAYS

5. MINIMUM TIME FOR DEWATERING TO EXISTING MUDLINE: 4 DAYS

6. MINIMUM TIME FOR EXCAVATING TO 50% DEPTH: 17 DAYS

7. MINIMUM TIME FOR DEWATERING TO FINAL LEVEL: 3 DAYS 8. MINIMUM TIME FOR EXCAVATING TO 100% DEPTH: 14 DAYS

#### **ABBREVIATIONS**

ANGLE ASCE AMERICAN SOCIETY OF CIVIL ENGINEERS AMERICAN WELDING SOCIETY AWS

BEG BEGINNING BOW **BOTTOM OF WALL** CONST CONSTRUCTION

CONTINUOUS OR CONTINUED CONT DIA DIAMETER DWG DRAWING EΑ EACH

**ELEVATION EASTING EXISTING** EXIST. FG FINISH GRADE FOW FACE OF WALL FS FINISH SURFACE FT FEET HORIZ HORIZONTAL

INV INVERT JT JOINT LF LINEAR FEET LT LEFT MAX MAXIMUM

MHW MEAN HIGH WATER MIN MINIMUM MISC. MISCELLANEOUS NORTHING

NTS NOT TO SCALE NAVD NORTH AMERICAN VERTICAL DATUM

OC ON CENTER PROF PROFILE PT POINT QTY QUANTITY RET RETAINING ROW RIGHT OF WAY RT RIGHT SHT SHEET STA STATION STD STANDARD T&B TOP AND BOTTOM TOW TOP OF WALL TYP **TYPICAL** UNK UNKNOWN

UNLESS NOTED OTHERWISE UNO USACE UNITED STATES ARMY CORPS OF ENGINEERS

**VERT** VERTICAL WIDTH WITH

2237 S Acadian Thruway Suite 701 Baton Rouge Louisiana 70808 USA **T** 225 292 9007



Reuse of Documents

This document and the ideas and designs incorporated herein, as an instrument of professional service, is the property of GHD and shall not be reused in whole or in part for any other project without GHD's written authorization. © 2024 GHD

**SAN JACINTO RIVER WASTE PITS** 

NORTHERN IMPOUNDMENT FINAL 100% REMEDIAL DESIGN HARRIS COUNTY, TEXAS

ı	5	100% EPA SUBMITTAL	DS	SC	11/25/20
	4	FOR CLIENT REVIEW	DS	sc	11/21/20
	3	100% EPA REVIEW	DS	sc	07/17/20
	2	90% EPA REVIEW	DS	06/27/20	
	No.	Issue	Drawn	Approved	Date
	Draw	n <b>DS</b>	Designer	KM	
	Drafti Chec	•	Design Check	sc	
	Proje Coor	ct dinator <b>CM</b>	Date	Nov 25, 20	)24

Project No. **11215702** 

This document shall not be used for

Arch D

construction unless signed and sealed for Scale N.T.S.

Original Size

**STRUCTURAL NOTES** 

Sheet No.

**S-01** 


Sheet **59** of **83** 

Bar is one inch on original size drawing

THIS DOCUMENT IS RELEASED FOR THE PURPOSE OF EPA REVIEW UNDER THE AUTHORITY OF SATISH CHILKA, P.E. 145120 ON 11/25/2024. IT IS NOT TO BE USED FOR CONSTRUCTION, BIDDING, RECORDATION, CONVEYANCE OR SALES PURPOSES.


> GHD TEXAS FIRM REGISTRATION NO. 276 **100% EPA SUBMITTAL**

GHD SERVICES INC.

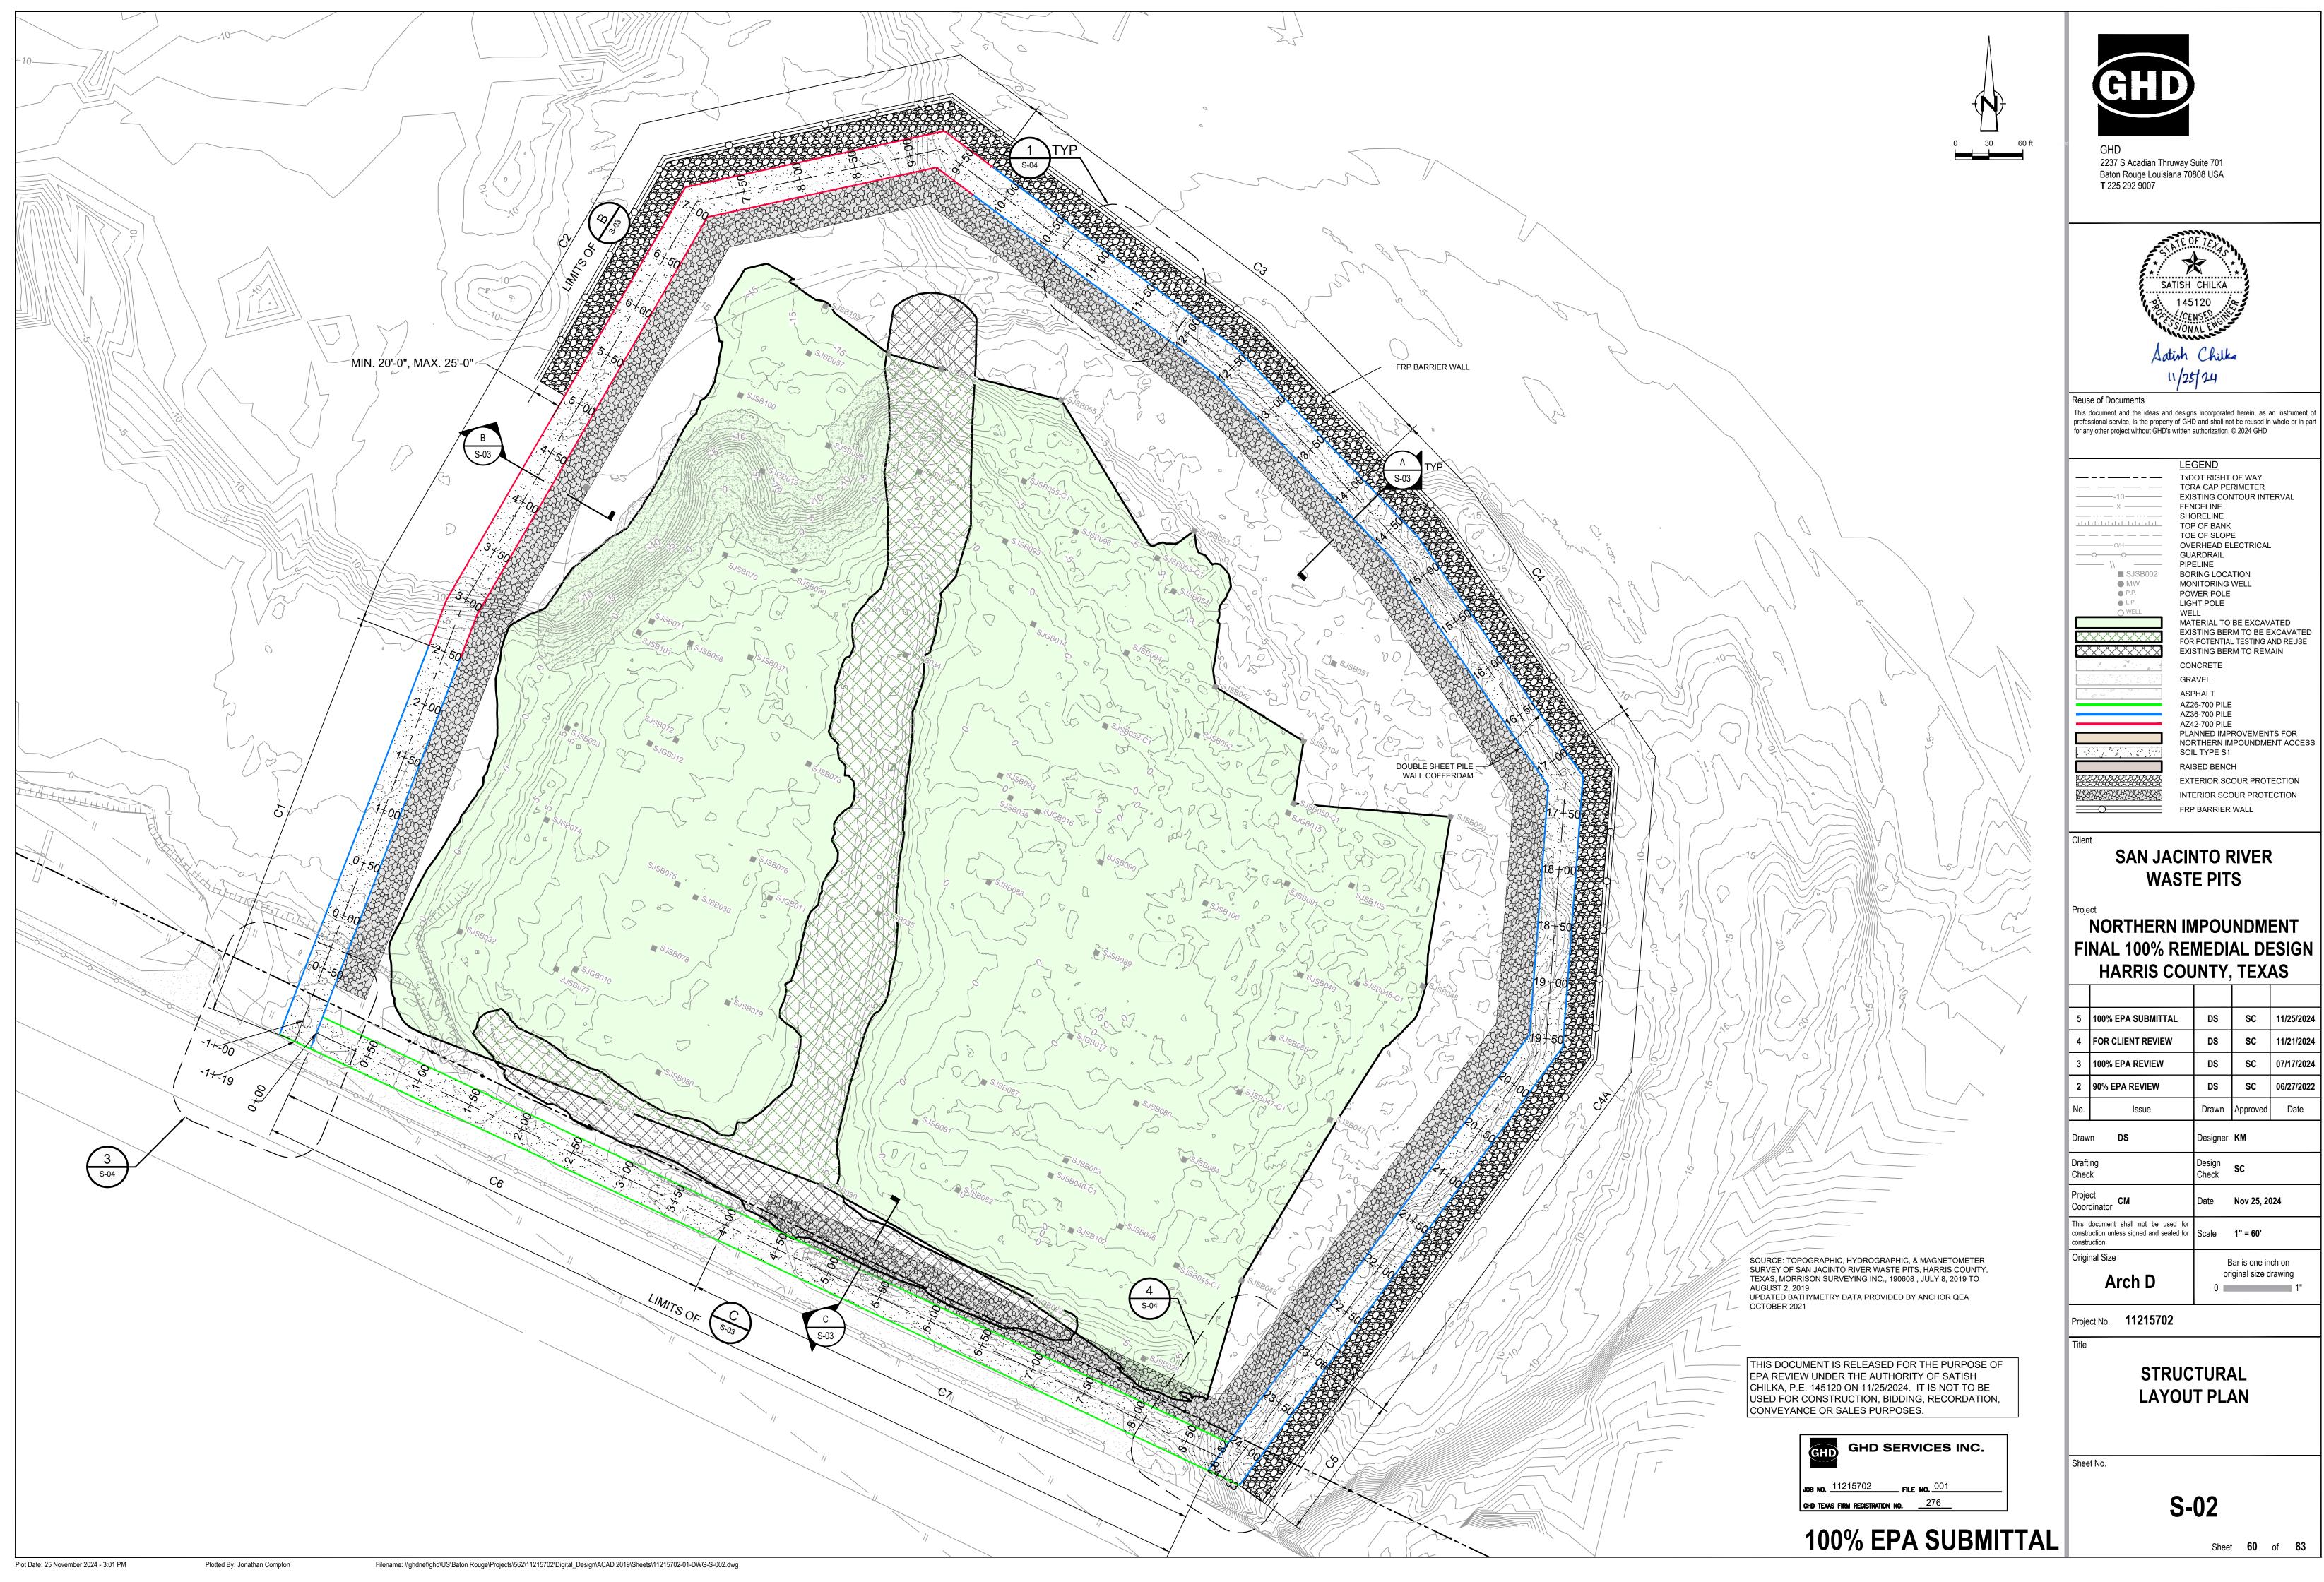

FINAL 100% REMEDIAL DESIGN

5	100% EPA SUBMITTAL	DS	SC	11/25/2024	
4	FOR CLIENT REVIEW	DS	SC	11/21/2024	
3	100% EPA REVIEW	DS	sc	07/17/2024	
2	90% EPA REVIEW	DS	sc	06/27/2022	
No.	Issue	Drawn	Approved	Date	
Draw	n DS	Designer	er KM		
Drafti Chec	•	Design Check	sc		
Proje	ct CM	Data	Nov 25 20	124	

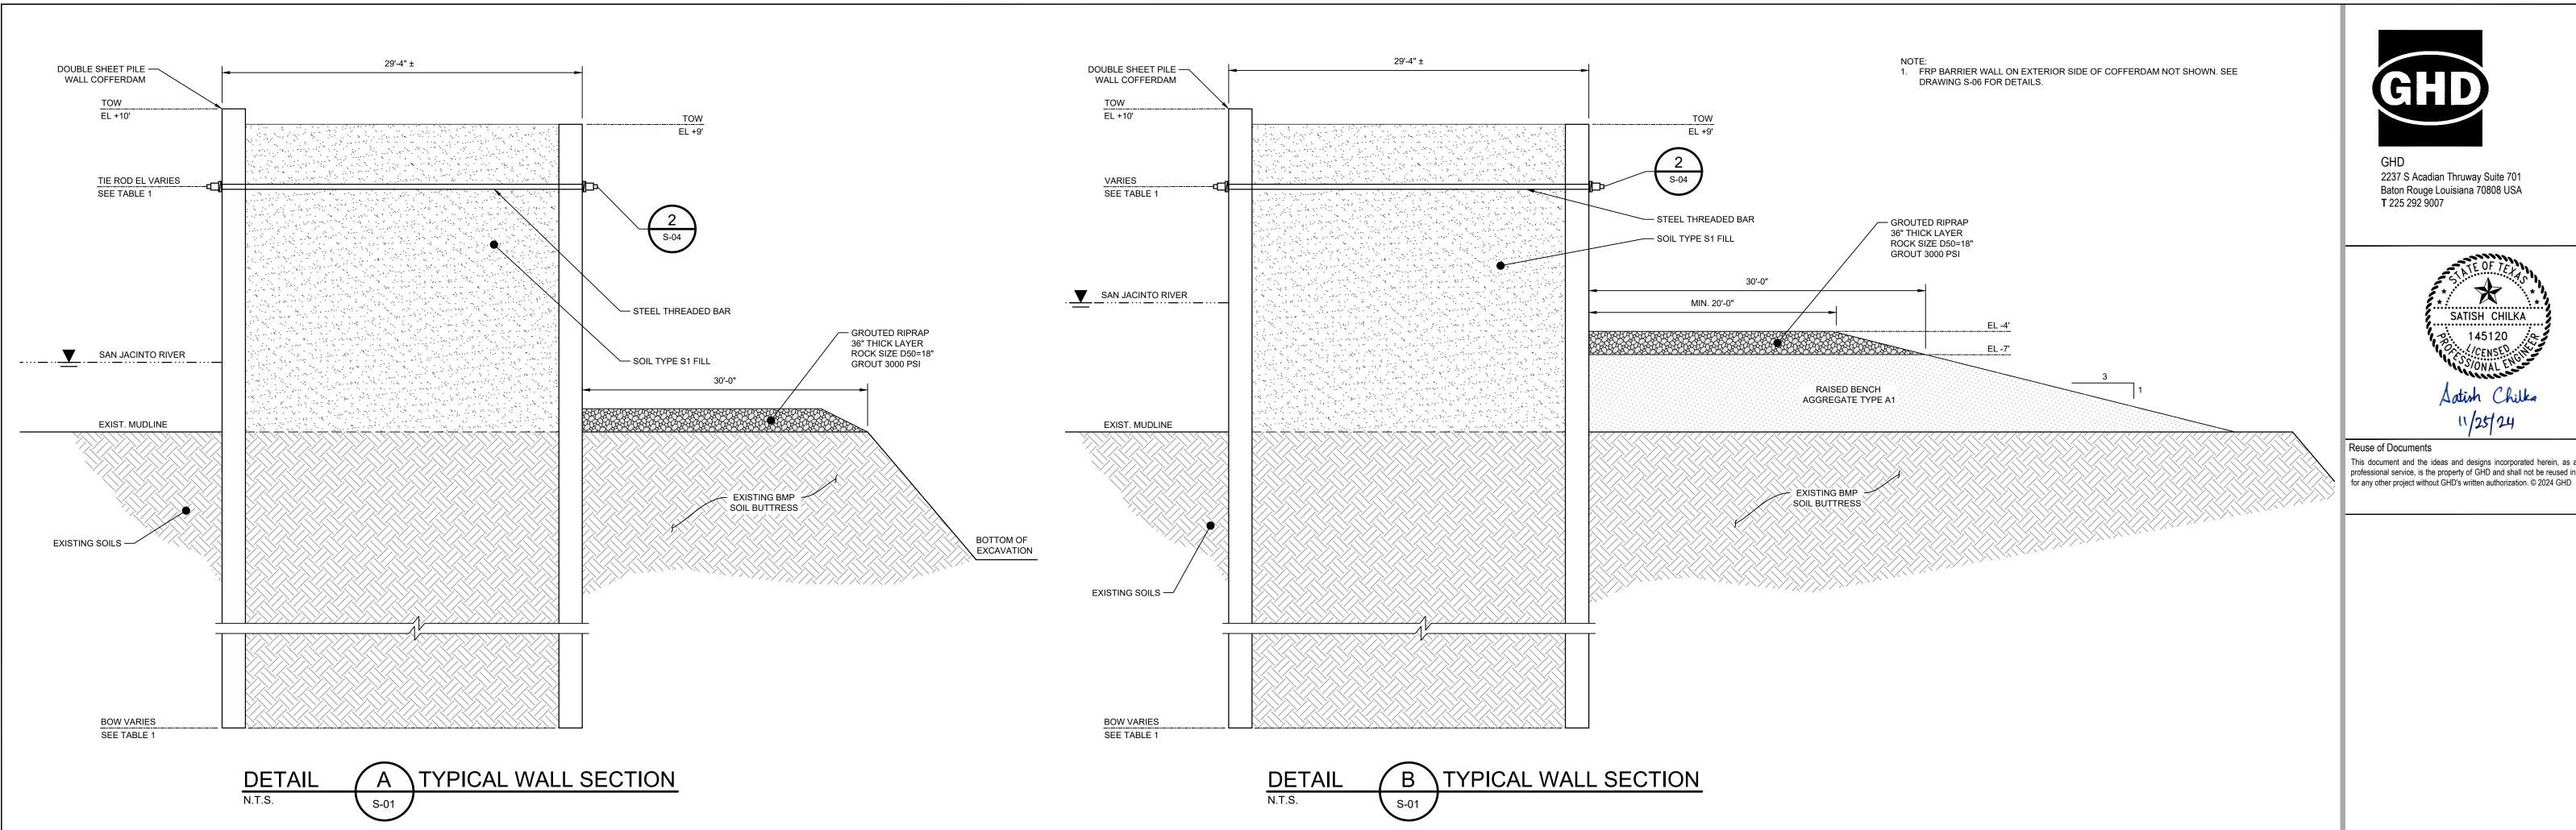



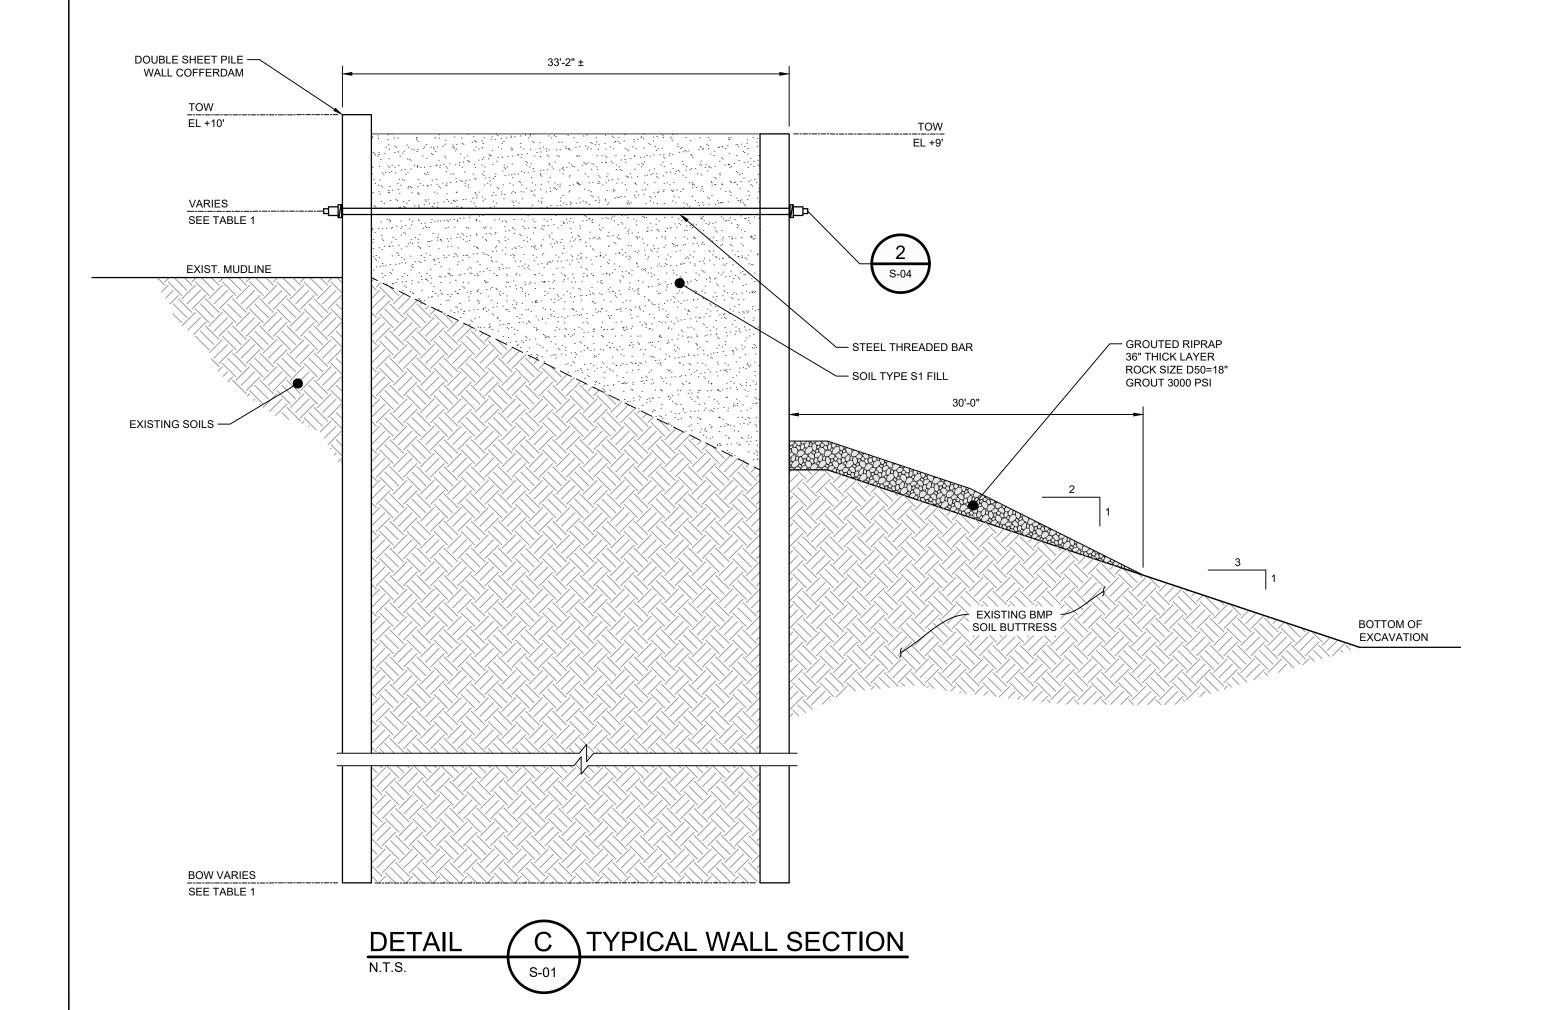


	TABLE 1									
WALL SEGMENT	START STA	END STA	DETAIL	SHEET PILE SECTION	SHEET PILE LENGTH (FT)	TIE ROD NOMINAL DIAMETER (IN)	TIE ROD SPACING (FT)	TIE ROD EL (FT)		
C1	-1+10	2+50	А	AZ36-700N	50		5	3		
C2	2+50	9+75	В	AZ42-700N	55		5	3		
C3	9+75	14+00	А	AZ36-700N	50		5	3		
C4	14+00	17+00	А	AZ36-700N	50	SEE TABLE 2 ON	5	3		
C4A	17+00	23+00	А	AZ36-700N	50	S-04	5	3		
C5	23+00	24+33	А	AZ36-700N	60	] [	5	3		
C6	0+00	4+00	С	AZ26-700	60	] [	5	3		
C7	4+00	8+82	С	AZ26-700	60	] [	5	3		

MINIMUM STEEL SHEET PILE										
SSP SECTION		YIELD	WIDTH w	HEIGHT h	THICKNESS (IN)		WEI	WEIGHT		
	ASTM	STRENGTH (KSI)	(IN)	(IN)	FLANGE tf	WEB tw	SINGLE PILE (LB/FT)	WALL AREA (LB/FT2)	MODULUS (IN3/FT)	
AZ26-700	A572	60	27.56	18.11	0.480	0.480	69.12	30.10	48.4	
AZ36-700N	A572	60	27.56	19.65	0.591	0.441	79.72	34.71	66.8	
AZ42-700N	A572	60	27.56	19.65	0.709	0.551	95.51	41.59	78.2	

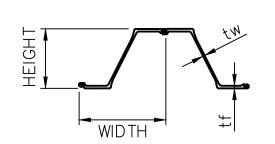


THIS DOCUMENT IS RELEASED FOR THE PURPOSE OF EPA REVIEW UNDER THE AUTHORITY OF SATISH CHILKA, P.E. 145120 ON 11/25/2024. IT IS NOT TO BE USED FOR CONSTRUCTION, BIDDING, RECORDATION, CONVEYANCE OR SALES PURPOSES.

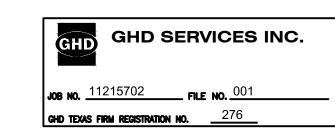

**100% EPA SUBMITTAL** 



2237 S Acadian Thruway Suite 701 Baton Rouge Louisiana 70808 USA **T** 225 292 9007

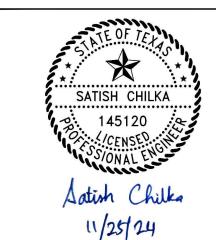

Reuse of Documents This document and the ideas and designs incorporated herein, as an instrument of professional service, is the property of GHD and shall not be reused in whole or in part

## **SAN JACINTO RIVER WASTE PITS**

NORTHERN IMPOUNDMENT FINAL 100% REMEDIAL DESIGN HARRIS COUNTY, TEXAS

100% EPA SUBMITTAL	DS	S SC 11		
FOR CLIENT REVIEW	DS	SC	11/21/2	
100% EPA REVIEW	DS	SC	07/17/2	
90% EPA REVIEW	DS	06/27/2		
Issue	Drawn	Date		
n <b>DS</b>	Designer	KM		
•	Design Check	sc		
	Date	Nov 25, 2024		
uction unless signed and sealed for	Scale	N.T.S.		
	FOR CLIENT REVIEW  100% EPA REVIEW  90% EPA REVIEW  Issue  On DS  ing ing	FOR CLIENT REVIEW  100% EPA REVIEW  90% EPA REVIEW  DS  Issue  Drawn  Designer  Ing  Ek  Ct  dinator  CM  document shall not be used for uction unless signed and sealed for Scale	FOR CLIENT REVIEW  DS  SC  100% EPA REVIEW  DS  SC  90% EPA REVIEW  DS  SC  Prawn  Approved  Designer  Check  Ct  dinator  CM  Cd  Cd  Cd  Cd  Cd  Cd  Cd  Cd  Cd	

Original Size Bar is one inch on original size drawing Arch D

Project No. **11215702** 


STRUCTURAL SECTIONS

Sheet No.


**S-03** 

Sheet **61** of **83** 

Plot Date: 25 November 2024 - 3:01 PM

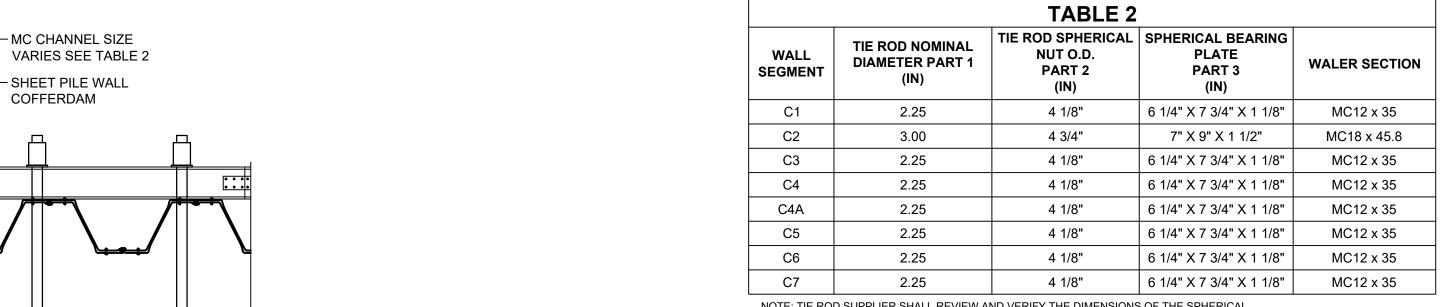


NOTE: TIE ROD SUPPLIER SHALL REVIEW AND VERIFY THE DIMENSIONS OF THE SPHERICAL NUT AND BEARING PLATE TO MATCH THE REQUIRED TIE ROD NOMINAL DIAMETER

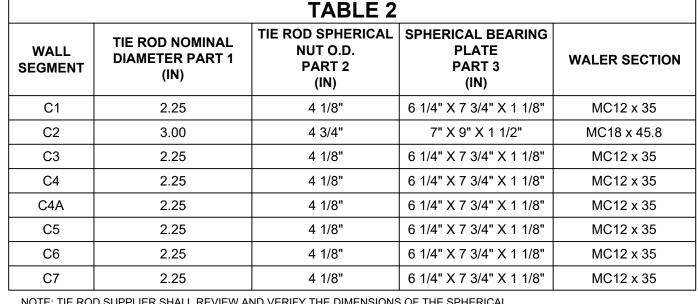



2237 S Acadian Thruway Suite 701 Baton Rouge Louisiana 70808 USA **T** 225 292 9007

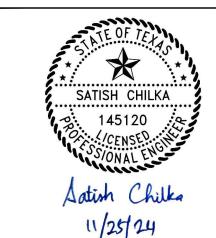

#### Reuse of Documents

This document and the ideas and designs incorporated herein, as an instrument of professional service, is the property of GHD and shall not be reused in whole or in part for any other project without GHD's written authorization. © 2024 GHD

**SAN JACINTO RIVER WASTE PITS** 

5 100% EPA SUBMITTAL

NORTHERN IMPOUNDMENT FINAL 100% REMEDIAL DESIGN HARRIS COUNTY, TEXAS

DS

SC 11/25/2024

4	FOR CLIENT REVIEW	DS	11/21/202	
3	100% EPA REVIEW	DS	SC	07/17/202
2	90% EPA REVIEW	DS	SC	06/27/202
No.	Issue	Drawn	Approved	Date
Draw	n <b>DS</b>	Designer	KM	
Drafti Chec	•	Design Check SC		
Proje Coor	ct dinator	Date	Nov 25, 20	024
	document shall not be used for uction unless signed and sealed for uction.			
Origi	nal Size	_	ar is one in	
	Arch D	ori	iginal size d	Irawing 1"

Project No. **11215702** 


STRUCTURAL

DETAILS 1 of 2

Sheet No.

**S-04** 


Sheet **62** of **83** 

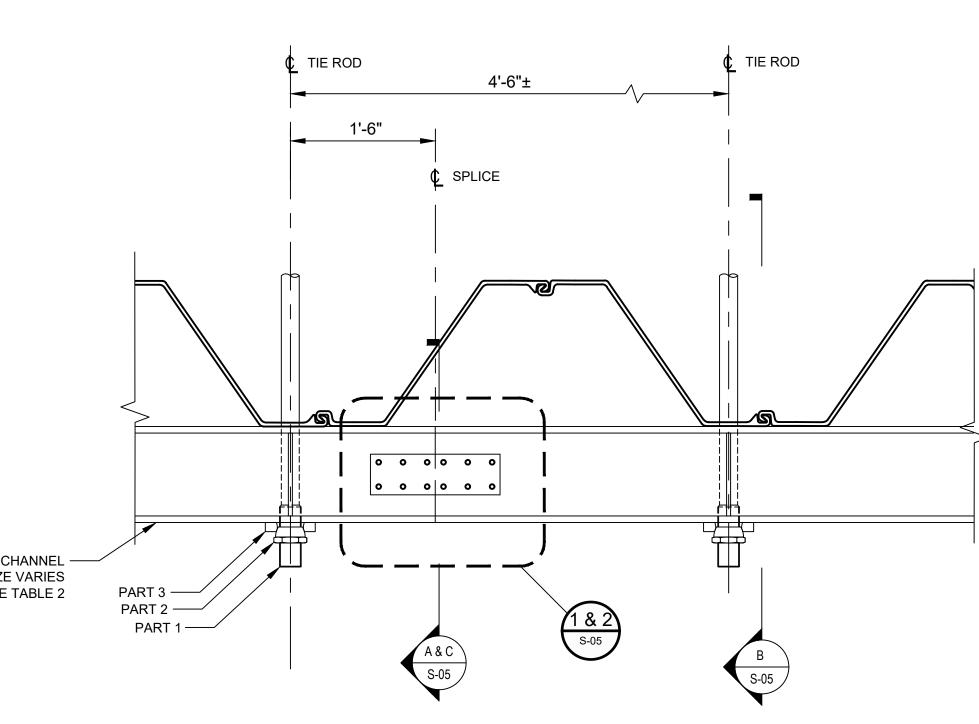

MC CHANNEL SIZE VARIES SEE TABLE 2

> 1. STAGGER WALER SPLICE ON INTERIOR AND EXTERIOR WALL BY 10'-0" +/-2. WELD 1/2" THICK STEEL PLATES BETWEEN T&B WALERS TO MAINTAIN SPACING

> > 2 PLAN VIEW

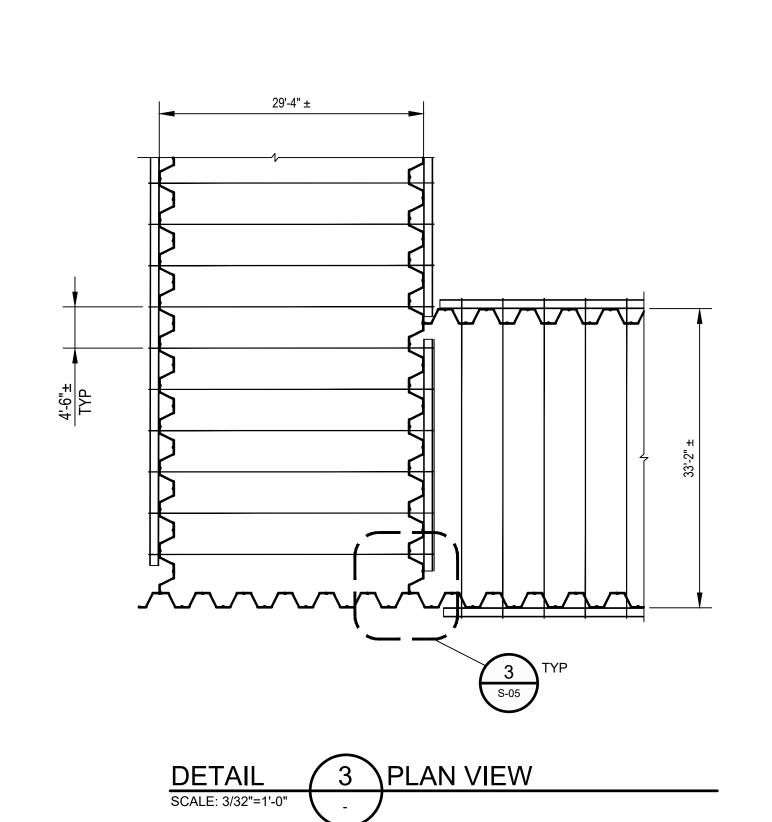


SHEET PILE WALL -

MC CHANNEL SIZE -VARIES SEE TABLE 2

COFFERDAM

SCALE: 1"=3'-0"

DETAIL 1 PLAN VIEW

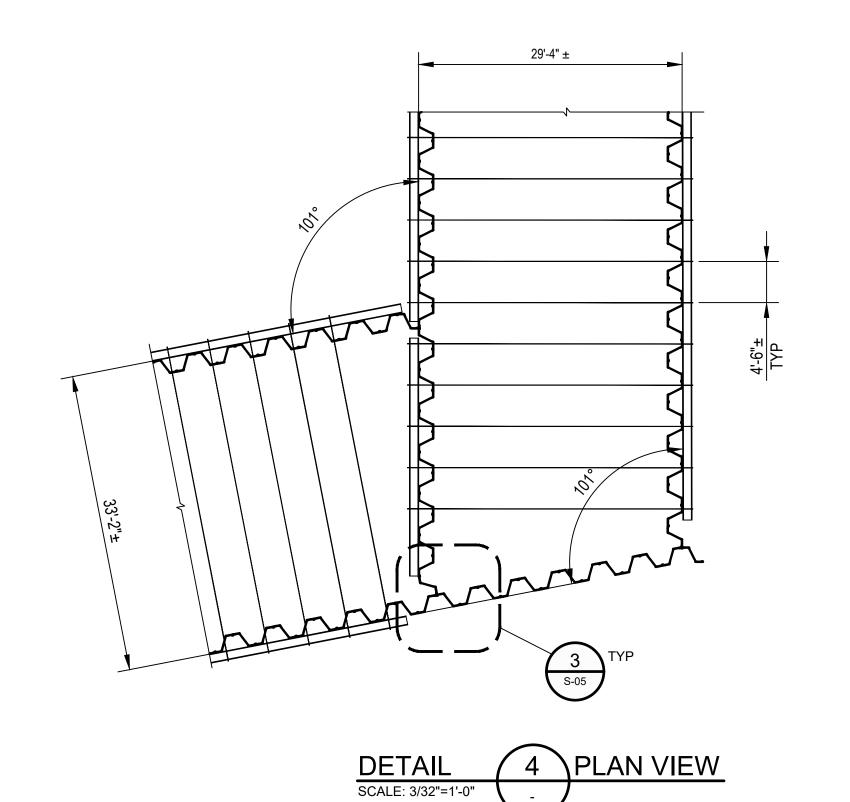


— THREADED BAR TIE-ROD


w/ FORGED EYES AND LINK PLATE AT MID-SPAN TO ALLOW ARTICULATION

SEE TABLE 2


THIS DOCUMENT IS RELEASED FOR THE PURPOSE OF EPA REVIEW UNDER THE AUTHORITY OF SATISH CHILKA, P.E. 145120 ON 11/25/2024. IT IS NOT TO BE USED FOR CONSTRUCTION, BIDDING, RECORDATION, CONVEYANCE OR SALES PURPOSES. GHD SERVICES INC.

100% EPA SUBMITTAL

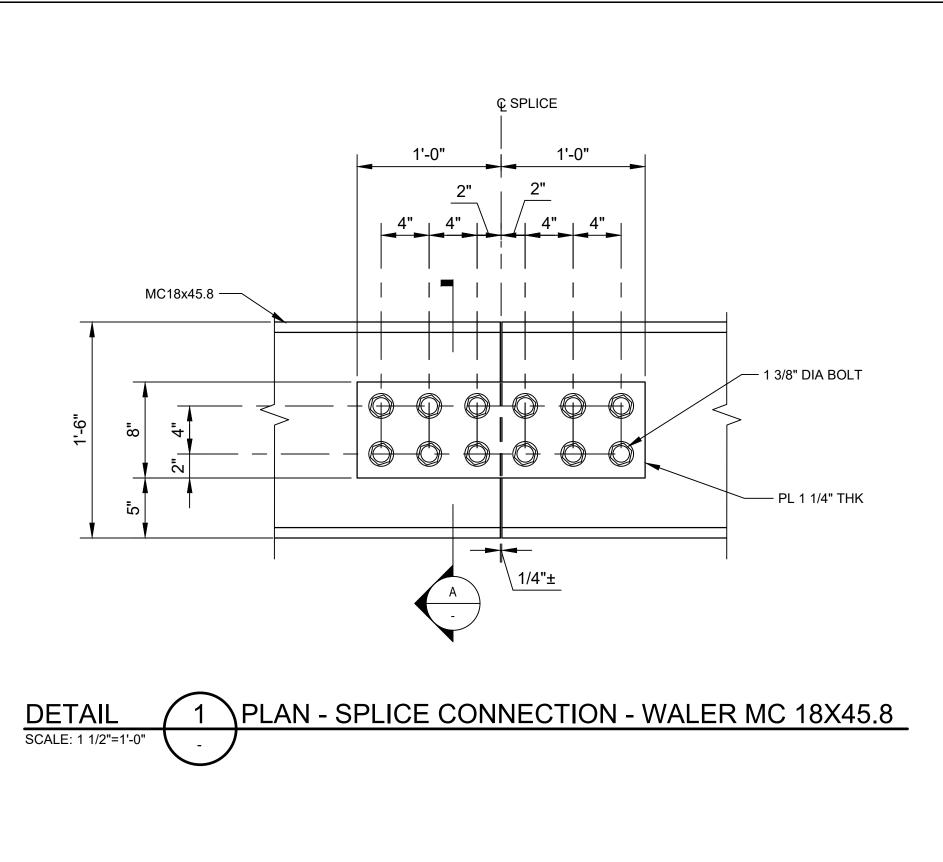


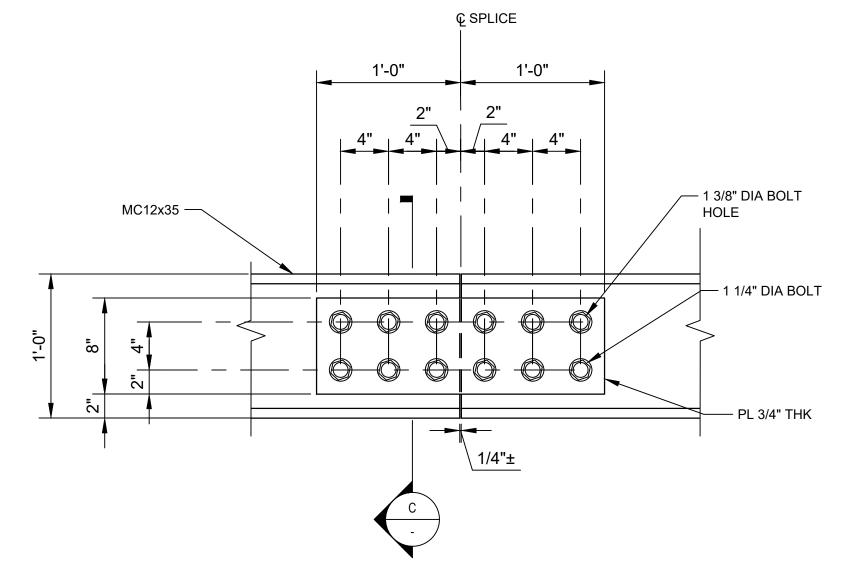




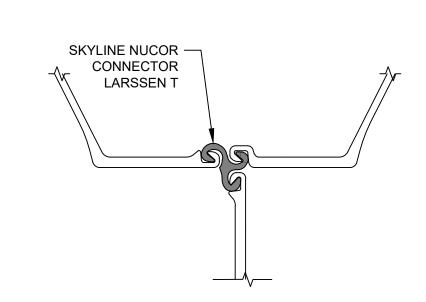




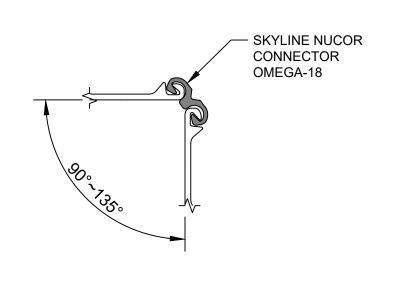




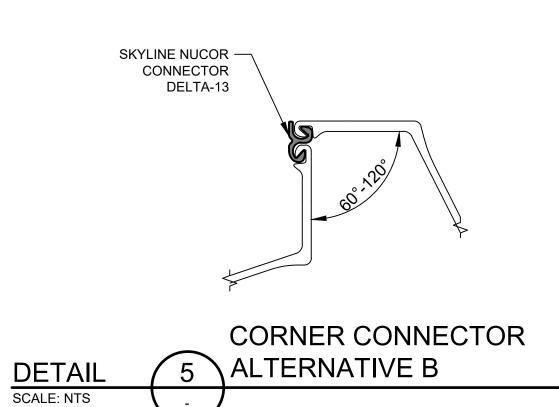


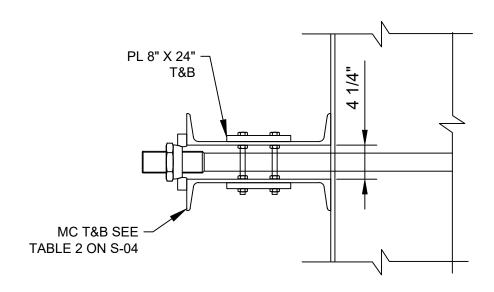



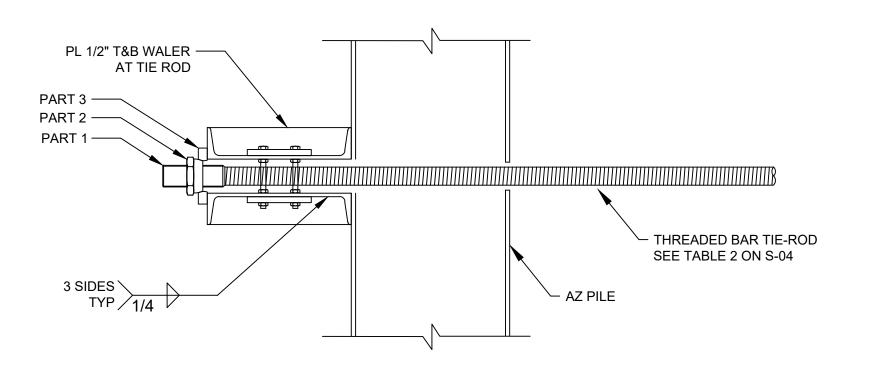



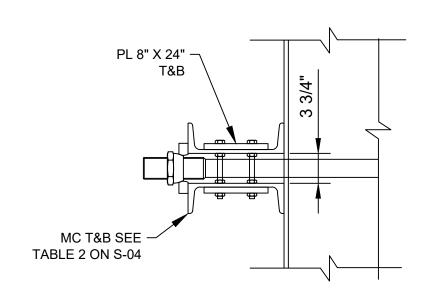



THIS DOCUMENT IS RELEASED FOR THE PURPOSE OF EPA REVIEW UNDER THE AUTHORITY OF SATISH CHILKA, P.E. 145120 ON 11/25/2024. IT IS NOT TO BE USED FOR CONSTRUCTION, BIDDING, RECORDATION, CONVEYANCE OR SALES PURPOSES.



100% EPA SUBMITTAL



2237 S Acadian Thruway Suite 701
Baton Rouge Louisiana 70808 USA
T 225 292 9007



Reuse of Documents

This document and the ideas and designs incorporated herein, as an instrument of professional service, is the property of GHD and shall not be reused in whole or in part

for any other project without GHD's written authorization. © 2024 GHD

SAN JACINTO RIVER
WASTE PITS

NORTHERN IMPOUNDMENT FINAL 100% REMEDIAL DESIGN HARRIS COUNTY, TEXAS

5	100% EPA SUBMITTAL	DS	SC	11/25/2024	
4	FOR CLIENT REVIEW	DS	sc	11/21/2024	
3	100% EPA REVIEW	DS	DS SC 07/		
2	90% EPA REVIEW	DS	SC	06/27/202	
No.	Issue	Drawn	Approved	Date	
Draw	n <b>DS</b>	Designer	KM		
Drafti Chec	•	Design Check	sc		
Project CM Coordinator		Date	Nov 25, 20	)24	
This document shall not be used for construction unless signed and sealed for construction.		Scale	AS SHOWN		
Original Size		В	Bar is one in	ch on	

Arch D

Project No. **11215702** 


Sheet No.

STRUCTURAL DETAILS 2 OF 2

S-05

Sheet **63** of **83** 


original size drawing

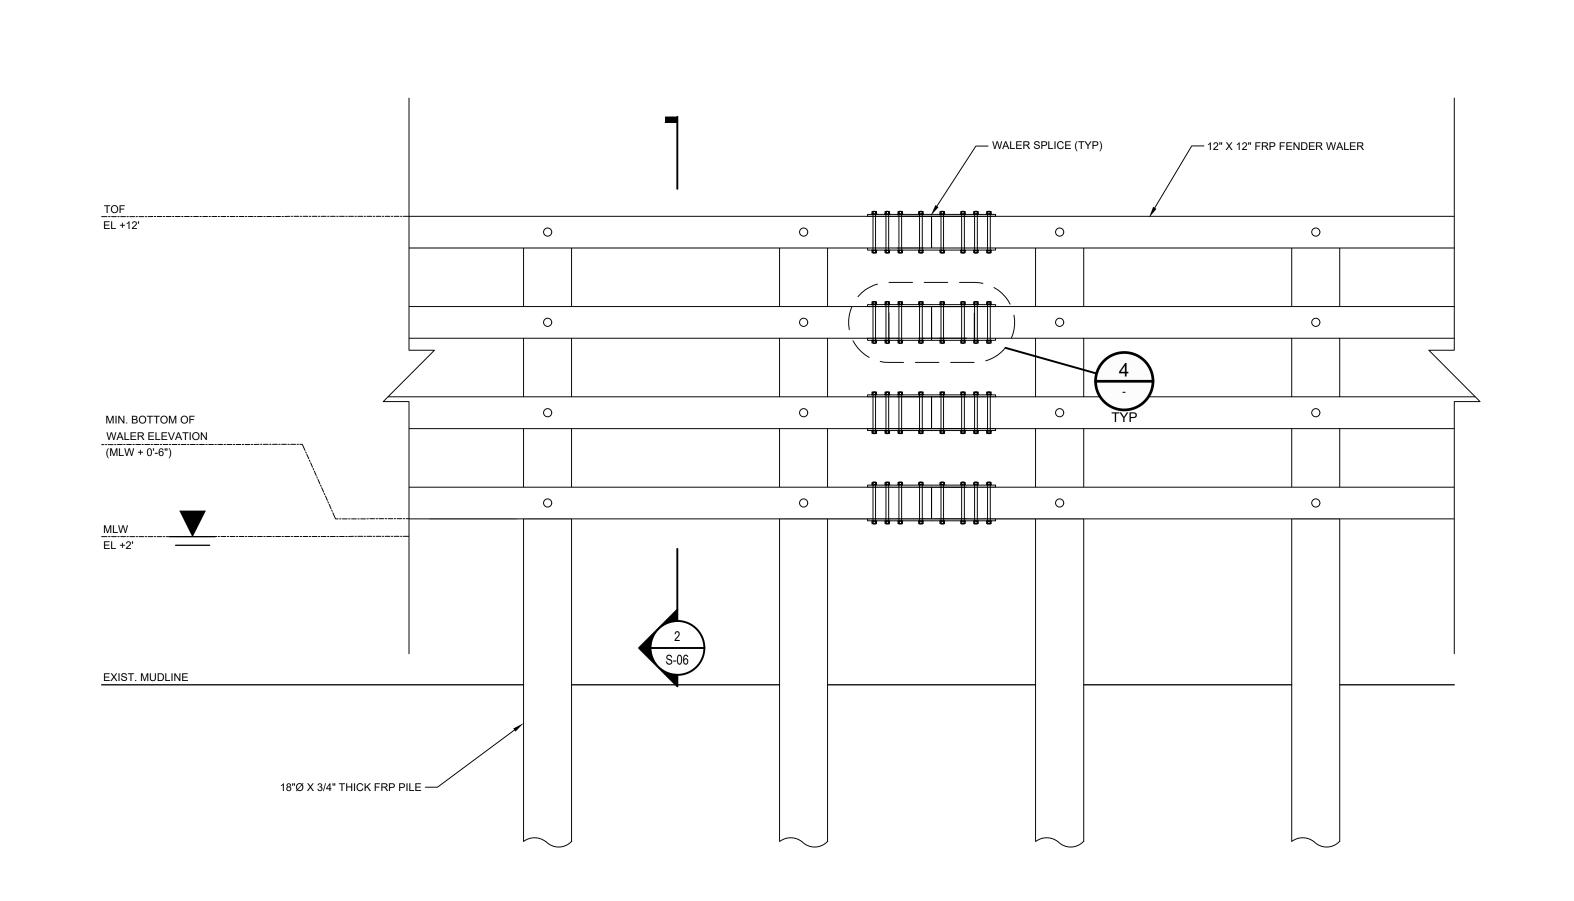

DETAIL
SCALE: 1"=3'-0"

1 TYPICAL FRP BARRIER ELEVATION

8-06

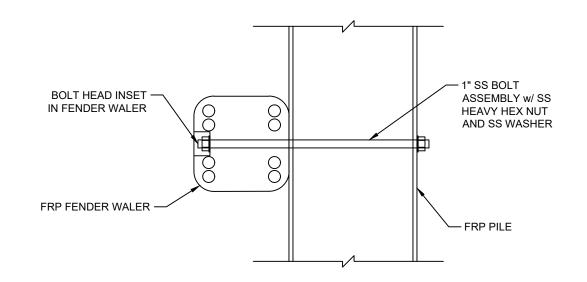


DETAIL

SCALE: 1"=1'-0"


3
TYPICAL WALER SECTION

S-06

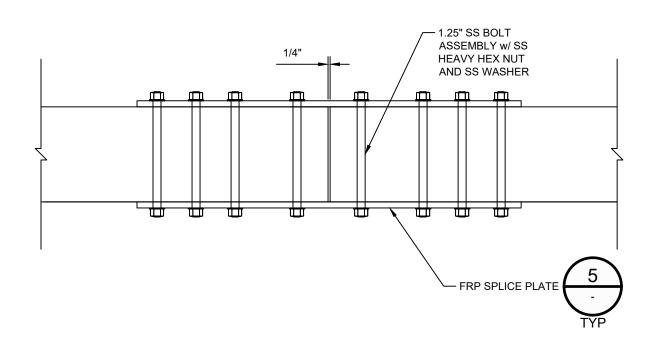


DETAIL
SCALE: 1"=1'-0"

4 TYPICAL WALER SECTION
S-06

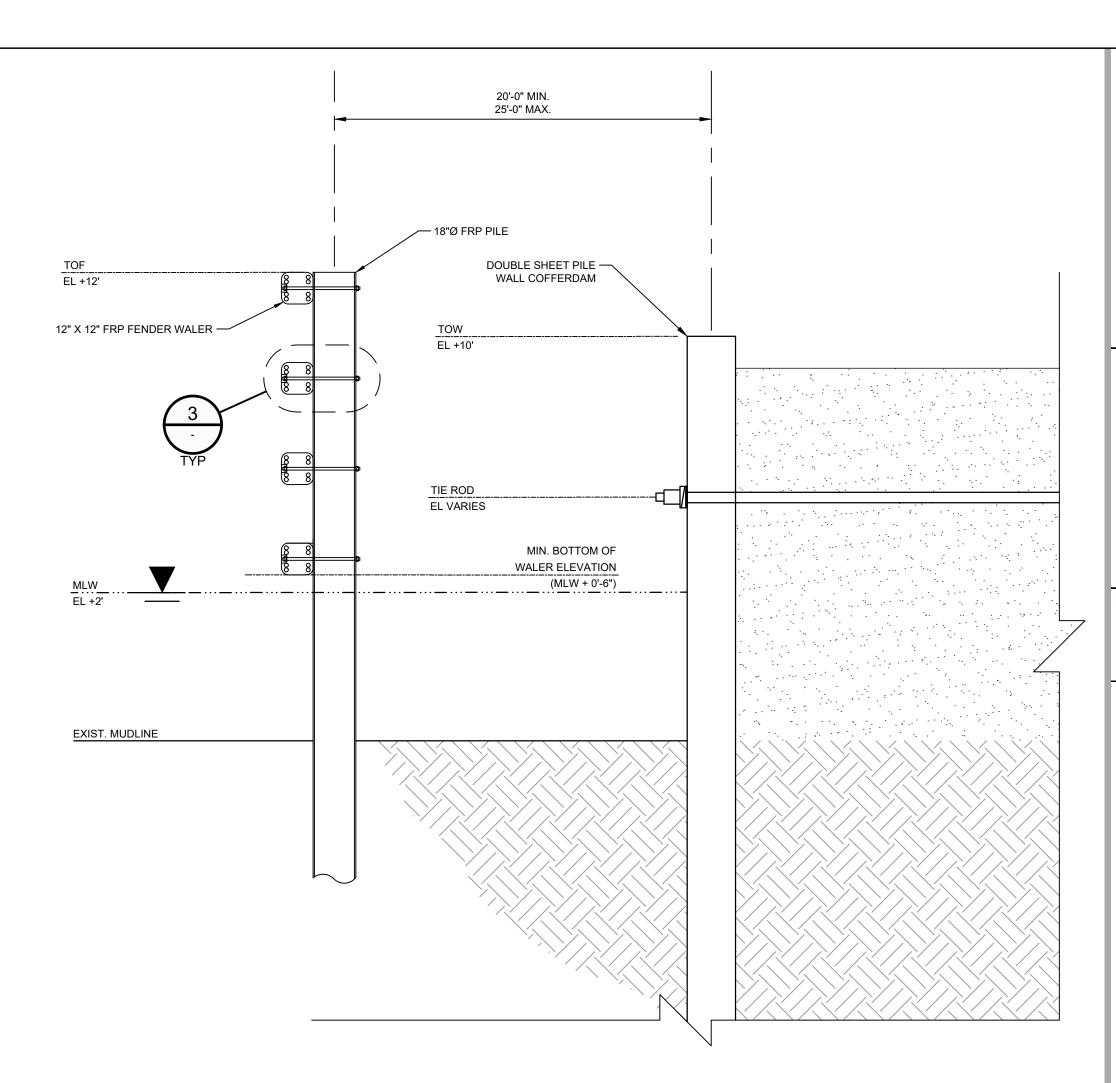

DETAIL
SCALE: 1"=3'-0"

TYPICAL FRP BARRIER SECTION
S-06

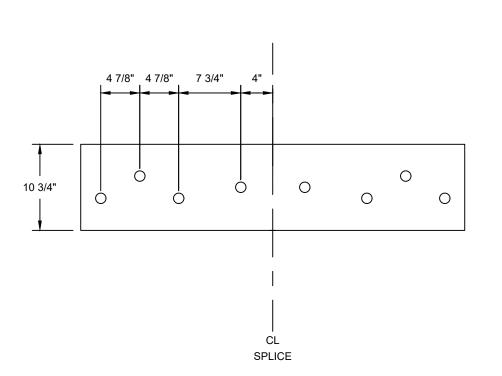

DETAIL
SCALE: 1"=1'-0"

5 TYPICAL BOLT PATTERN FOR FRP SPLICE PLATE

8-06


THIS DOCUMENT IS RELEASED FOR THE PURPOSE OF EPA REVIEW UNDER THE AUTHORITY OF SATISH CHILKA, P.E. 145120 ON 11/25/2024. IT IS NOT TO BE USED FOR CONSTRUCTION, BIDDING, RECORDATION, CONVEYANCE OR SALES PURPOSES.



100% EPA SUBMITTAL



GHD
2237 S Acadian Thruway Suite 701
Baton Rouge Louisiana 70808 USA
T 225 292 9007

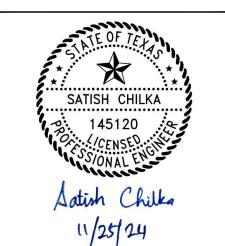

Reuse of Documents

This document and the ideas and designs incorporated herein, as an instrument of professional service, is the property of GHD and shall not be reused in whole or in part for any other project without GHD's written authorization. © 2024 GHD

**SAN JACINTO RIVER** 

**WASTE PITS** 

NORTHERN IMPOUNDMENT

FINAL 100% REMEDIAL DESIGN

HARRIS COUNTY, TEXAS

DS

DS

DS

DS

Drawn

Designer KM

SC 11/25/2024

SC 07/17/2024

06/27/2022

SC

Check

Check

Project
Coordinator

CM

Date

Nov 25, 2024

This document shall not be used for construction unless signed and sealed for construction.

Original Size

5 100% EPA SUBMITTAL

4 FOR CLIENT REVIEW

Issue

3 100% EPA REVIEW

2 90% EPA REVIEW

Original Size

Arch D

Bar is one inch on original size drawing

0 1"

Project No. **11215702** 


FRP BARRIER WALL

Sheet No.

S-06

Sheet **64** of **83** 

Plot Date: 25 November 2024 - 3:01 PM

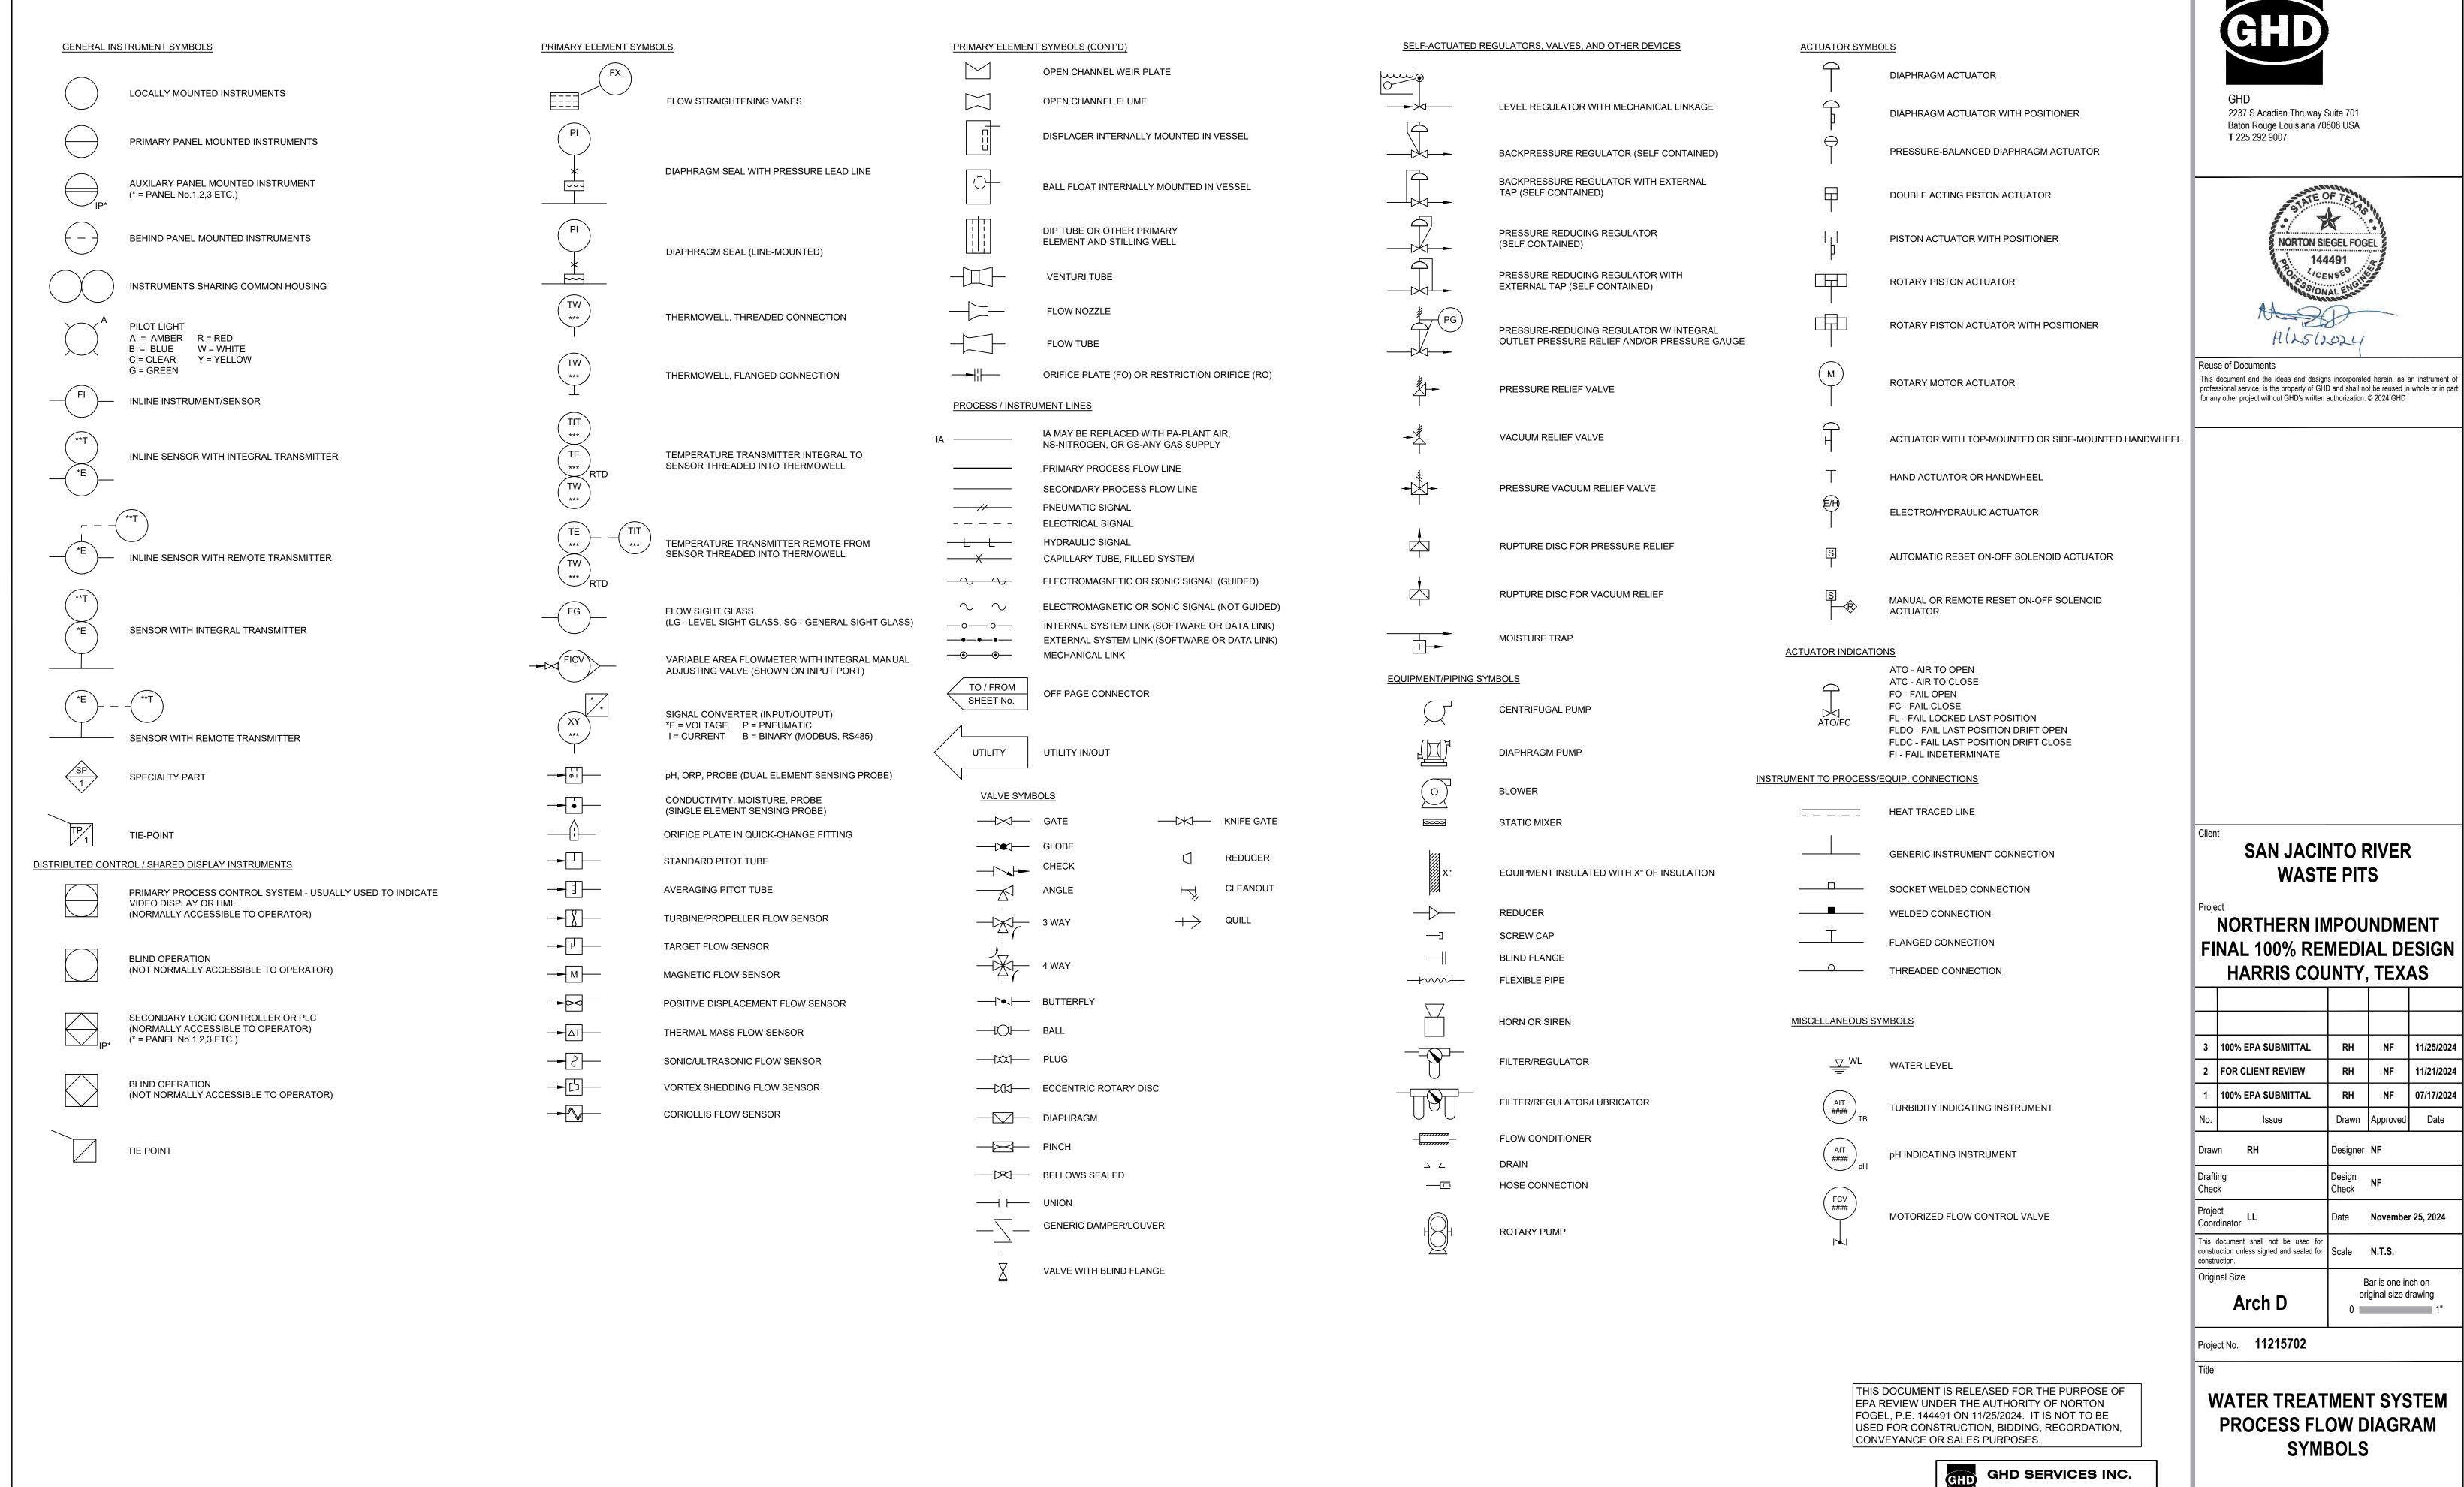

3	100% EPA SUBMITTAL	RH	NF	11/25/202		
2	FOR CLIENT REVIEW	RH	NF	11/21/202		
1	100% EPA SUBMITTAL	RH	NF	07/17/202		
lo.	Issue	Drawn	Approved	Date		
raw	n <b>RH</b>	Designer <b>NF</b>				
rafti hec	•	Design Check	NF			
roje oor	ct dinator	Date	November 25, 2024			
nstr	document shall not be used for uction unless signed and sealed for uction.	Scale N.T.S.				
rigii	nal Size	В	ar is one in	ich on		

Sheet No.

P-000A

Sheet **65** of **83** 

JOB NO. 11215702 FILE NO. 001 GHD TEXAS FIRM REGISTRATION NO. 276

Plot Date: 25 November 2024 - 3:05 PM

#### TYPICAL INTERNATIONAL SOCIETY OF AUTOMATION LETTER COMBINATIONS

Fire			Conf	trollers	Self- Actuated	Readout D	Devices		witches a		Tı	ransmitter	s	Solenoids, Relays,	Delica	T4	Well	Viewing	Cafat	Fig.
First- Letters	Initiating or Measured Variable	Recording	gIndicatin	g Blind	Control Valves	Recording	Indicating	High **	Low	Comb	Recording	gIndicatin	g Blind	Computing Devices	Element	Test Point	or Probe	Device, Glass	Safety Device	Final Element
A	Analysis	ARC	AIC	AC		AR	Al	ASH	ASL	ASHL	ART	AIT	АТ	AY	AE	AP	AW			AV
В	Burner/Combustion	BRC	BIC	ВС		BR	ВІ	BSH	BSL	BSHL	BRT	BIT	ВТ	BY	BE		BW	BG		BZ
С	User's Choice																			
D	User's Choice																			
Е	Voltage	ERC	EIC	EC		ER	El	ESH	ESL	ESHL	ERT	EIT	ET	EY	EE					EZ
F	Flow Rate	FRC	FIC	FC	FCV,	FR	FI	FSH	FSL	FSHL	FRT	FIT	FT	FY	FE	FP		FG		FV
FQ	Flow Quantity	FQRC	FQIC		FICV	FQR	FQI	FQSH	FQSL			FQIT	FQT	FQY	FQE					FQV
FF	Flow Ratio	FFRC	FFIC	FFC		FFR	FFI	FFSH	FFSL						FE					FFV
G	User's Choice																			
н	Hand		HIC	HC						HS										HV
ı	Current	IRC	IIC			IR	II	ISH	ISL	ISHL	IRT	IIT	IT	IY	ΙE					ΙZ
J	Power	JRC	JIC			JR	JI	JSH	JSL	JSHL	JRT	JIT	JT	JY	JE					JV
К	Time	KRC	KIC	KC	KCV	KR	KI	KSH	KSL	KSHL	KRT	KIT	KT	KY	KE					KV
L	Level	LRC	LIC	LC	LCV	LR	LI	LSH	LSL	LSHL	LRT	LIT	LT	LY	LE		LW	LG		LV
М	User's Choice																			
N	User's Choice																			
0	User's Choice																			
Р	Pressure/Vacuum	PRC	PIC	PC	PCV	PR	PI	PSH	PSL	PSHL	PRT	PIT	PT	PY	PE	PP			PSV,	PV
PD	Pressure, Differential	PDRC	PDIC	PDC	PDCV	PDR	PDI	PDSH	PDSL		PDRT	PDIT	PDT	PDY	PE	PP			PSE	PDV
Q	Quantity	QRC	QIC			QR	QI	QSH	QSL	QSHL	QRT	QIT	QT	QY	QE					QZ
R	Radiation	RRC	RIC	RC		RR	RI	RSH	RSL	RSHL	RRT	RIT	RT	RY	RE		RW			RZ
S	Speed/Frequency	SRC	SIC	SC	SCV	SR	SI	SSH	SSL	SSHL	SRT	SIT	ST	SY	SE					SV
Т	Temperature	TRC	TIC	TC	TCV	TR	TI	TSH	TSL	TSHL	TRT	TIT	TT	TY	TE	TP	TW		TSE	TV
TD	Temperature, Differential	TDRC	TDIC	TDC	TDCV	TDR	TDI	TDSH	TDSL		TDRT	TDIT	TDT	TDY	TE	TP	TW			TDV
U	Multivariable					UR	UI							UY						UV
V	Vibration/Machinery Analysis					VR	VI	VSH	VSL	VSHL	VRT	VIT	VT	VY	VE					VZ
W	Weight/Force	WRC	WIC	WC	WCV	WR	WI	WSH	WSL	WSHL	WRT	WIT	WT	WY	WE					WZ
WD	Weight/Force, Differential	WDRC	WDIC	WDC			WDI	WDSH	WDSL		WDRT	WDIT	WDT	WDY	WE					WDZ
X	Unclassified																			
Y	Event/State/Presence		YIC	YC		YR	ΥI	YSH	YSL				ΥT	YY	YE					YZ
Z	Position/Dimension	ZRC	ZIC	ZC	ZCV	ZR	ZI	ZSH	ZSL	ZSHL	ZRT	ZIT	ZT	ZY	ZE					ZV
ZD	Gauging/Deviation	ZDRC	ZDIC	ZDC	ZDCV	ZDR	ZDI	ZDSH	ZDSL		ZDRT	ZDIT	ZDT	ZDY	ZDE					ZDV

NOTE: THIS TABLE IS NOT ALL-INCLUSIVE.

\* A, ALARM, THE ANNUNCIATING DEVICE, MAY BE USED IN THE SAME FASHION AS S, SWITCH, THE ACTUATING DEVICE.

\*\* THE LETTERS H AND L MAY BE OMITTED IN THE UNDEFINED CASE.

FO (RESTRICTION ORIFICE)

OTHER POSSIBLE COMBINATIONS:

LLH (LEVEL LIGHT HIGH)

FRK, HIK (CONTROL STATIONS LCL (LEVEL CONTROL LOW) HMS (HAND MOMENTARY SWITCH)

ABBREVIATIONS:

KQI (RUNNING TIME INDICATOR) LCH (LEVEL CONTROL HIGH)

### **INSTRUMENTS**

HOA - HAND/OFF/AUTO NC - NORMALLY CLOSED LOR - LOCAL/OFF/REMOTE NO - NORMALLY OPEN OPN - OPEN ST - START / ENABLE CLS - CLOSE SP - STOP / DISABLE STPT - SETPOINT JOG - PUMP MOTOR ES - EMERGENCY STOP SA - SINGLE ACTING

DA - DOUBLE ACTING

PIPE FLUID SERVICE CODE INDEX SEE PIPING SPECIFICATIONS FOR DETAILS

CODE	SERVICE
CL21	CHLORINE LIQUID OR GAS
CTW1	COOLING TOWER WATER
CW3	PROCESS WATER
CW4	CHILLED WATER
NaOH	CAUSTIC SODA SOLUTION
GCO	GLYCOL
N20	NITROGEN (DRY COMPRESSED GAS)
SI	STEAM
CI	CONDENSATE
PV	PROCESS VENT
STS	STORM SEWER
PR	PROCESS RELIEF
GW	GROUNDWATER
DR	DRAIN
IA	INSTRUMENT AIR
VE	VAPOR EXTRACTION
NPW	NON POTABLE WATER
H2SO4	SULFURIC ACID
DW	DOMESTIC WATER
INF	INFLUENT WATER (CONTACT WATER)
EFF	EFFLUENT WATER (TREATED WATER)
SLG	SLUDGE
BW	BACKWASH
COAG	COAGULANT
POLY	POLYMER
os	ORGANOSULFIDE
DEC	DECANT WATER
CONT	CONTAINMENT AREA DRAINAGE

#### **IDENTIFICATION LETTERS**

	FIRST-LETTER		SUCCEEDING-LETTERS	SUCCEEDING-LETTERS		
	MEASURED OR INITIATING VARIABLE	MODIFIER	READOUT OR PASSIVE FUNCTION	OUTPUT FUNCTION	MODIFIER	
A	Analysis		Alarm			
В	Burner/Combustion		User's Choice	User's Choice	User's Choice	
С	User's Choice	Conductivity		Control		
D	User's Choice	Differential, Density				
E	Voltage	·	Sensor (Primary Element)			
F	Flow Rate	Ratio (Fraction)				
G	User's Choice		Glass, Viewing Device, Gauge			
Н	Hand				High	
1	Current (Electrical)		Indicate			
J	Power	Scan				
K	Time, Time Schedule	Time Rate of Change		Control Station		
L	Level		Light		Low	
М	User's Choice	Momentary, Moisture			Middle, Intermediate	
N	User's Choice		User's Choice	User's Choice	User's Choice	
0	User's Choice		Orifice, Restriction			
Р	Pressure, Vacuum		Point (Test) Connection			
Q	Quantity	Integrate, Totalize				
R	Radiation		Record			
S	Speed, Frequency	Safety		Switch		
Т	Temperature			Transmit		
U	Multivariable		Multifunction	Multifunction	Multifunction	
V	Vibration, Machinery Analysis			Valve, Damper, Louver		
W	Weight, Force		Well			
X	Unclassified	X Axis	Unclassified	Unclassified	Unclassified	
Y	Event, State, or Presence	Y Axis		Relay, Compute, Convert		
Z	Position, Dimension	Z Axis		Driver, Actuator, Unclassified Final Control Element		

## LINE DESIGNATION - NOMINAL DIAMETER (INCHES) PIPE FLUID SERVICE CODE (SEE PIPE FLUID SERVICE CODE INDEX) PIPE MATERIAL DESCRIPTION (SEE PIPE MATERIAL INDEX) PIPE LINE NUMBER LAST 2 DIGITS OF PID NUMBER &SEQUENTIAL LINE NUMBER PIPE INSULATION CODE (IF REQUIRED) (SEE PIPE INSULATION CODE INDEX) 2"-NaOH7-CS\_PTFEL-02101-I(2")ET


PIPE MATERIAL INDEX SEE PIPING SPECIFICATIONS FOR DETAILS

MAT'L	DESCRIPTION	SPEC
CS_40	CARBON STEEL SCHEDULE 40 PIPE	
CS_80	CARBON STEEL SCHEDULE 80 PIPE	
316L_10	316L STAINLESS STEEL SCHEDULE 10 PIPE	
304_40	304 STAINLESS STEEL SCHEDULE 40 PIPE	
316L_ST	316L STAINLESS STEEL TUBING	
304_ST	304 STAINLESS STEEL TUBING	
CS_T	CARBON STEEL TUBING	
CU_T	COPPER TUBING	
PE_T	POLYETHYLENE TUBING	
CS_PTFEL	CARBON STEEL PTFE LINED PIPE	
CS-PFAL	CARBON STEEL PFA LINED PIPE	
CS-GL	CARBON STEEL GLASS LINED PIPE	
CPVC_80	CPVC SCHEDULE 80 PIPE	
PCV_80	PVC SCHEDULE 80 PIPE	
304_10	304 STAINLESS STEEL SCHEDULE 10 PIPE	
FRP	FIBERGLASS REINFORCED PIPE	
HDPE_11	HIGH-DENSITY POLYETHYLENE SDR-11	
FRH	FLEXIBLE RUBBER HOSE	
304L_ST	304L STAINLESS STEEL TUBING	
304L_10	304L STAINLESS STEEL SCHEDULE 10 PIPE	
304L_ST	TEFLON TUBING, CPVC CARRIER AND CONTAINMENT PIPE	
HDPE_DW_11	HIGH-DENSITY POLYETHYLENE SDR-11, DOUBLE WALLED CARRIER AND CONTAINMENT PIPE	
PTFE_CPVC	TEFLON TUBING, CPVC CARRIER AND CONTAINMENT PIPE	

PIPE INSULATION CODE INDEX SEE PIPING SPECIFICATIONS FOR DETAILS

CODE	DESCRIPTION
I(2")	INSULATED (2")
NI	NOT INSULATED
JKT	JACKETED PIPE
I(2")ET	INSULATED (2") AND ELECTRICALLY TRACED
I(2")ST	INSULATED (2") AND STEAM TRACED
I(2")JKT	INSULATED (2") AND JACKETED

THIS DOCUMENT IS RELEASED FOR THE PURPOSE OF EPA REVIEW UNDER THE AUTHORITY OF NORTON FOGEL, P.E. 144491 ON 11/25/2024. IT IS NOT TO BE USED FOR CONSTRUCTION, BIDDING, RECORDATION, CONVEYANCE OR SALES PURPOSES.

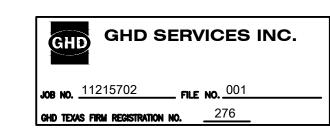

**100% EPA SUBMITTAL** 



2237 S Acadian Thruway Suite 701 Baton Rouge Louisiana 70808 USA **T** 225 292 9007



Reuse of Documents This document and the ideas and designs incorporated herein, as an instrument of professional service, is the property of GHD and shall not be reused in whole or in part

for any other project without GHD's written authorization. © 2024 GHD

Client

## **SAN JACINTO RIVER WASTE PITS**

NORTHERN IMPOUNDMENT FINAL 100% REMEDIAL DESIGN HARRIS COUNTY, TEXAS

3	100% EPA SUBMITTAL	RH	NF	11/25/20
2	FOR CLIENT REVIEW	RH	NF	11/21/20
1	100% EPA SUBMITTAL	RH	NF	07/17/20
No.	Issue	Drawn	Approved	Date
Draw	n <b>RH</b>	Designer	NF	
Drafti Chec	•	Design Check	NF	
Proje Coor	ct dinator	Date	Novembe	r 25, 2024
	document shall not be used for uction unless signed and sealed for uction.	Scale	N.T.S.	
Origi	nal Size	В	ar is one in	ch on

original size drawing Arch D

Project No. **11215702** 


WATER TREATMENT SYSTEM PROCESS FLOW DIAGRAM **SCHEDULES** 


Sheet No.


P-000B

Sheet **66** of **83** 

Bar is one inch on

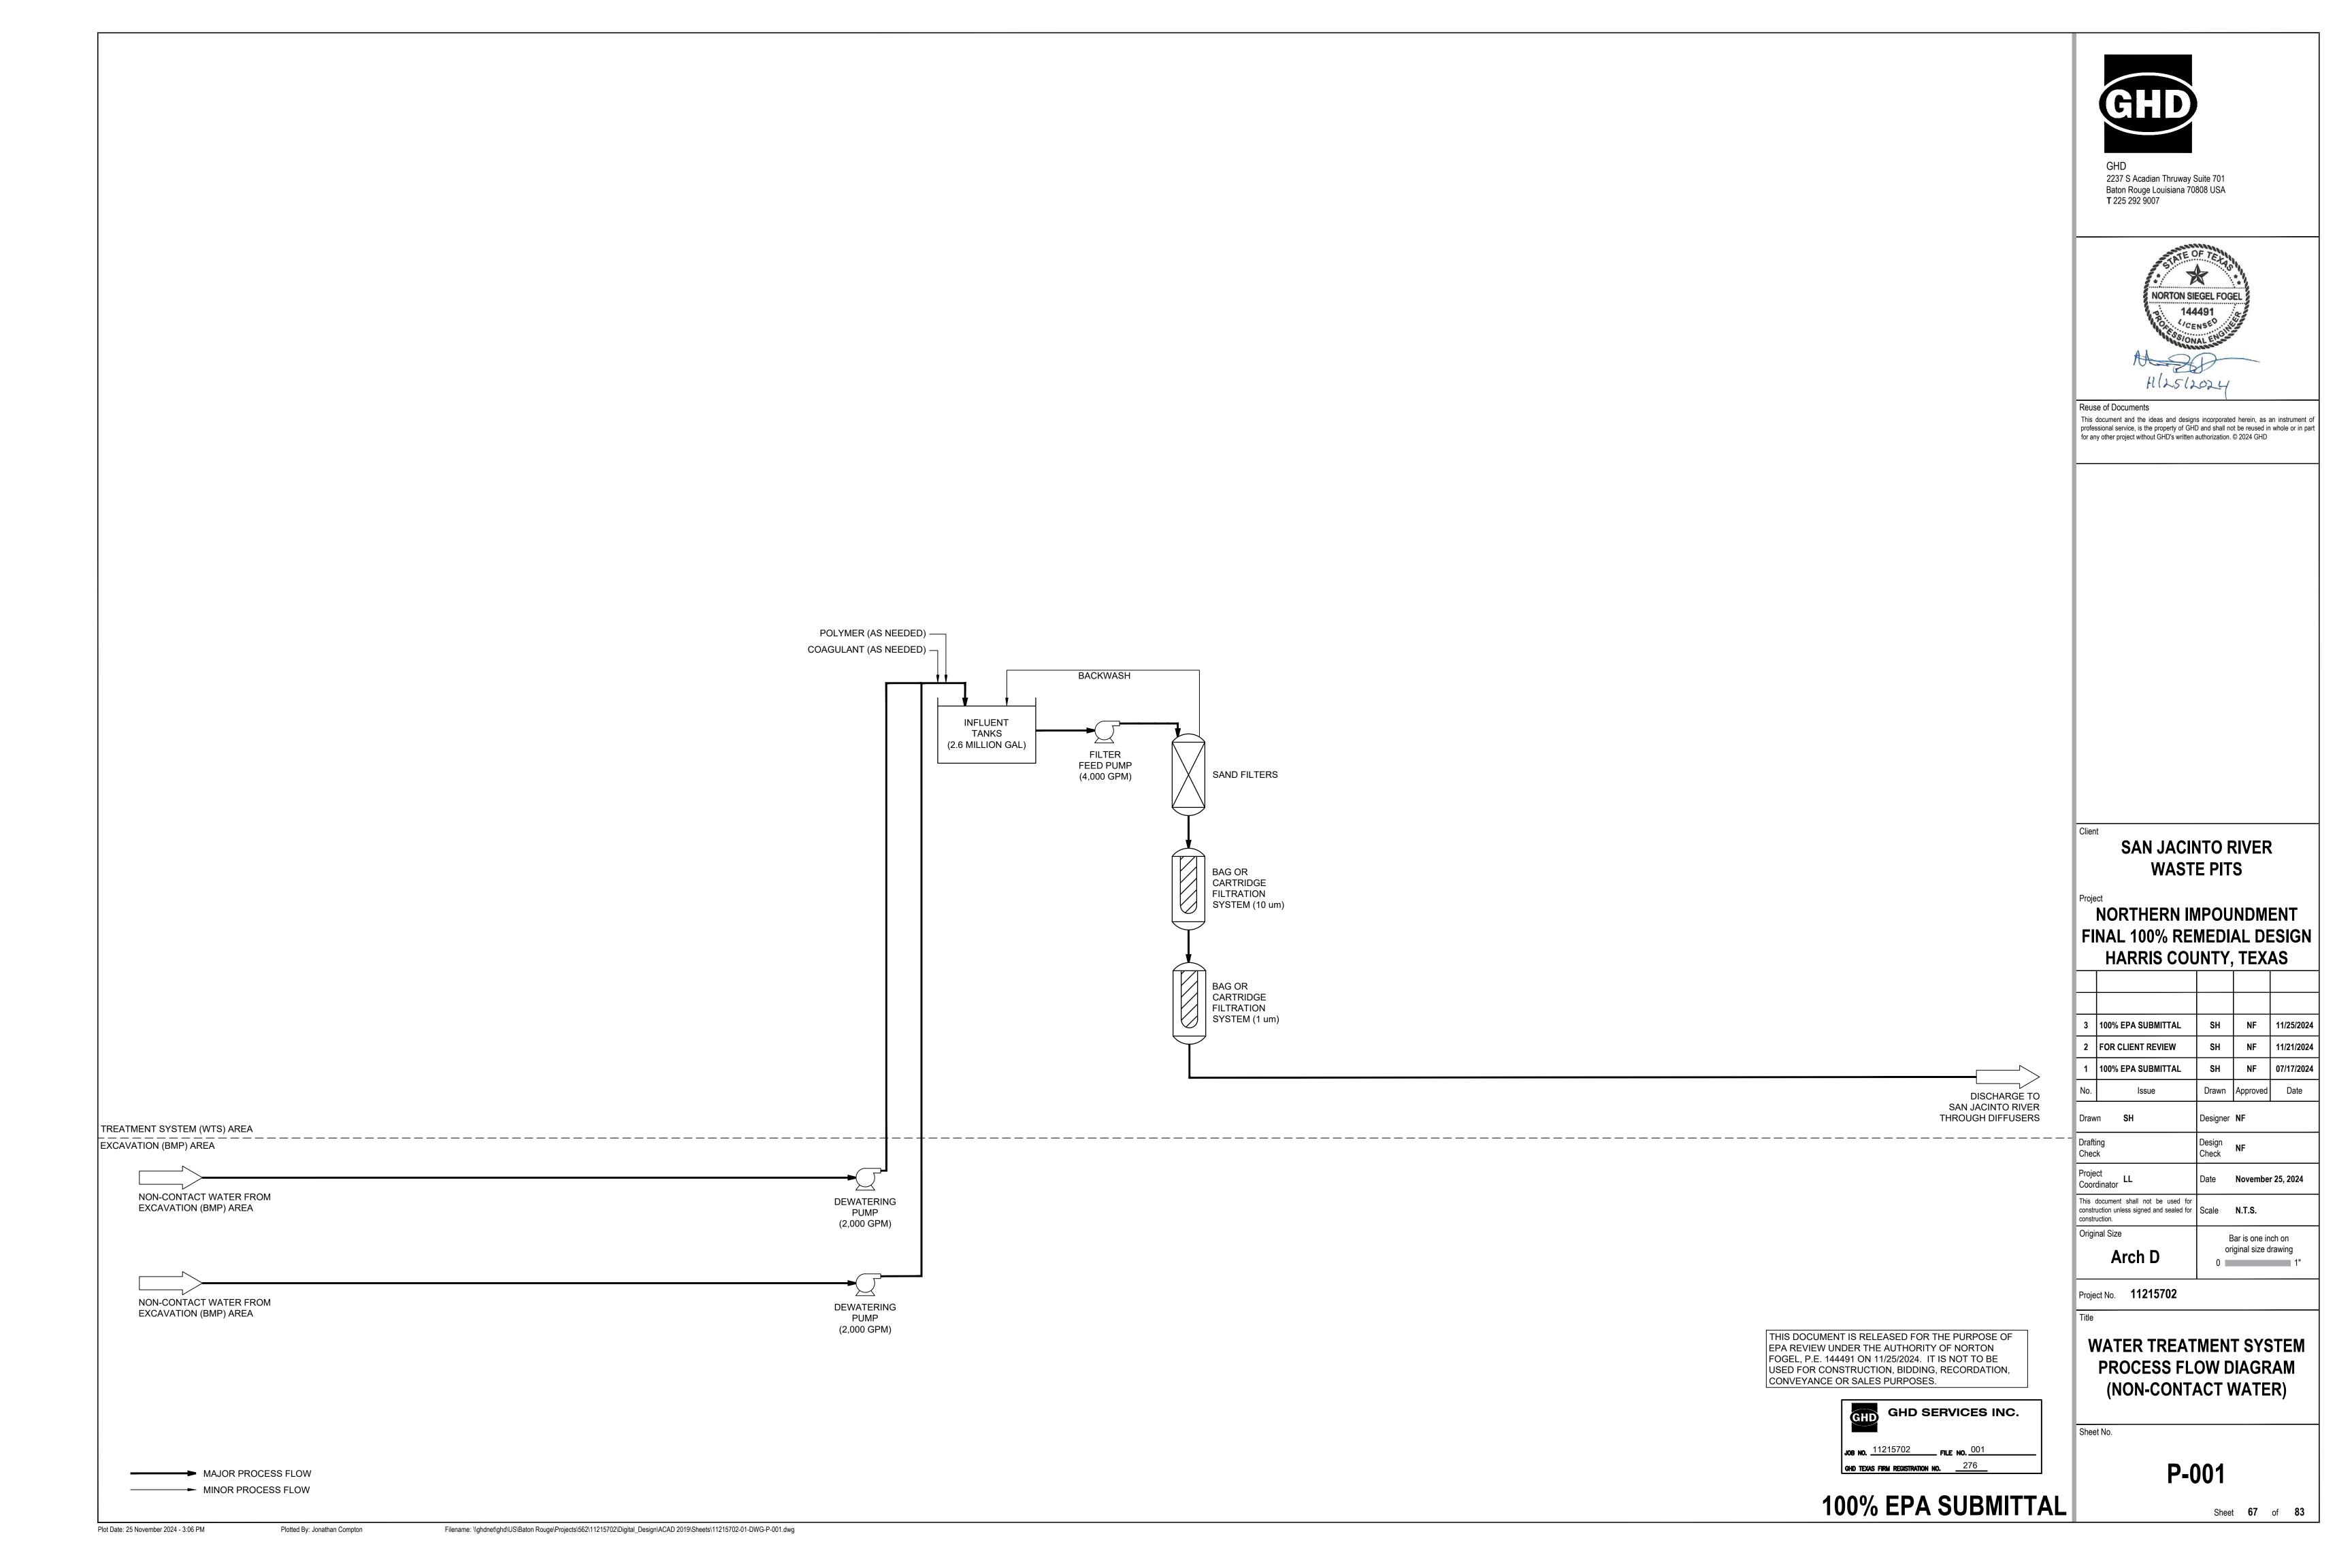

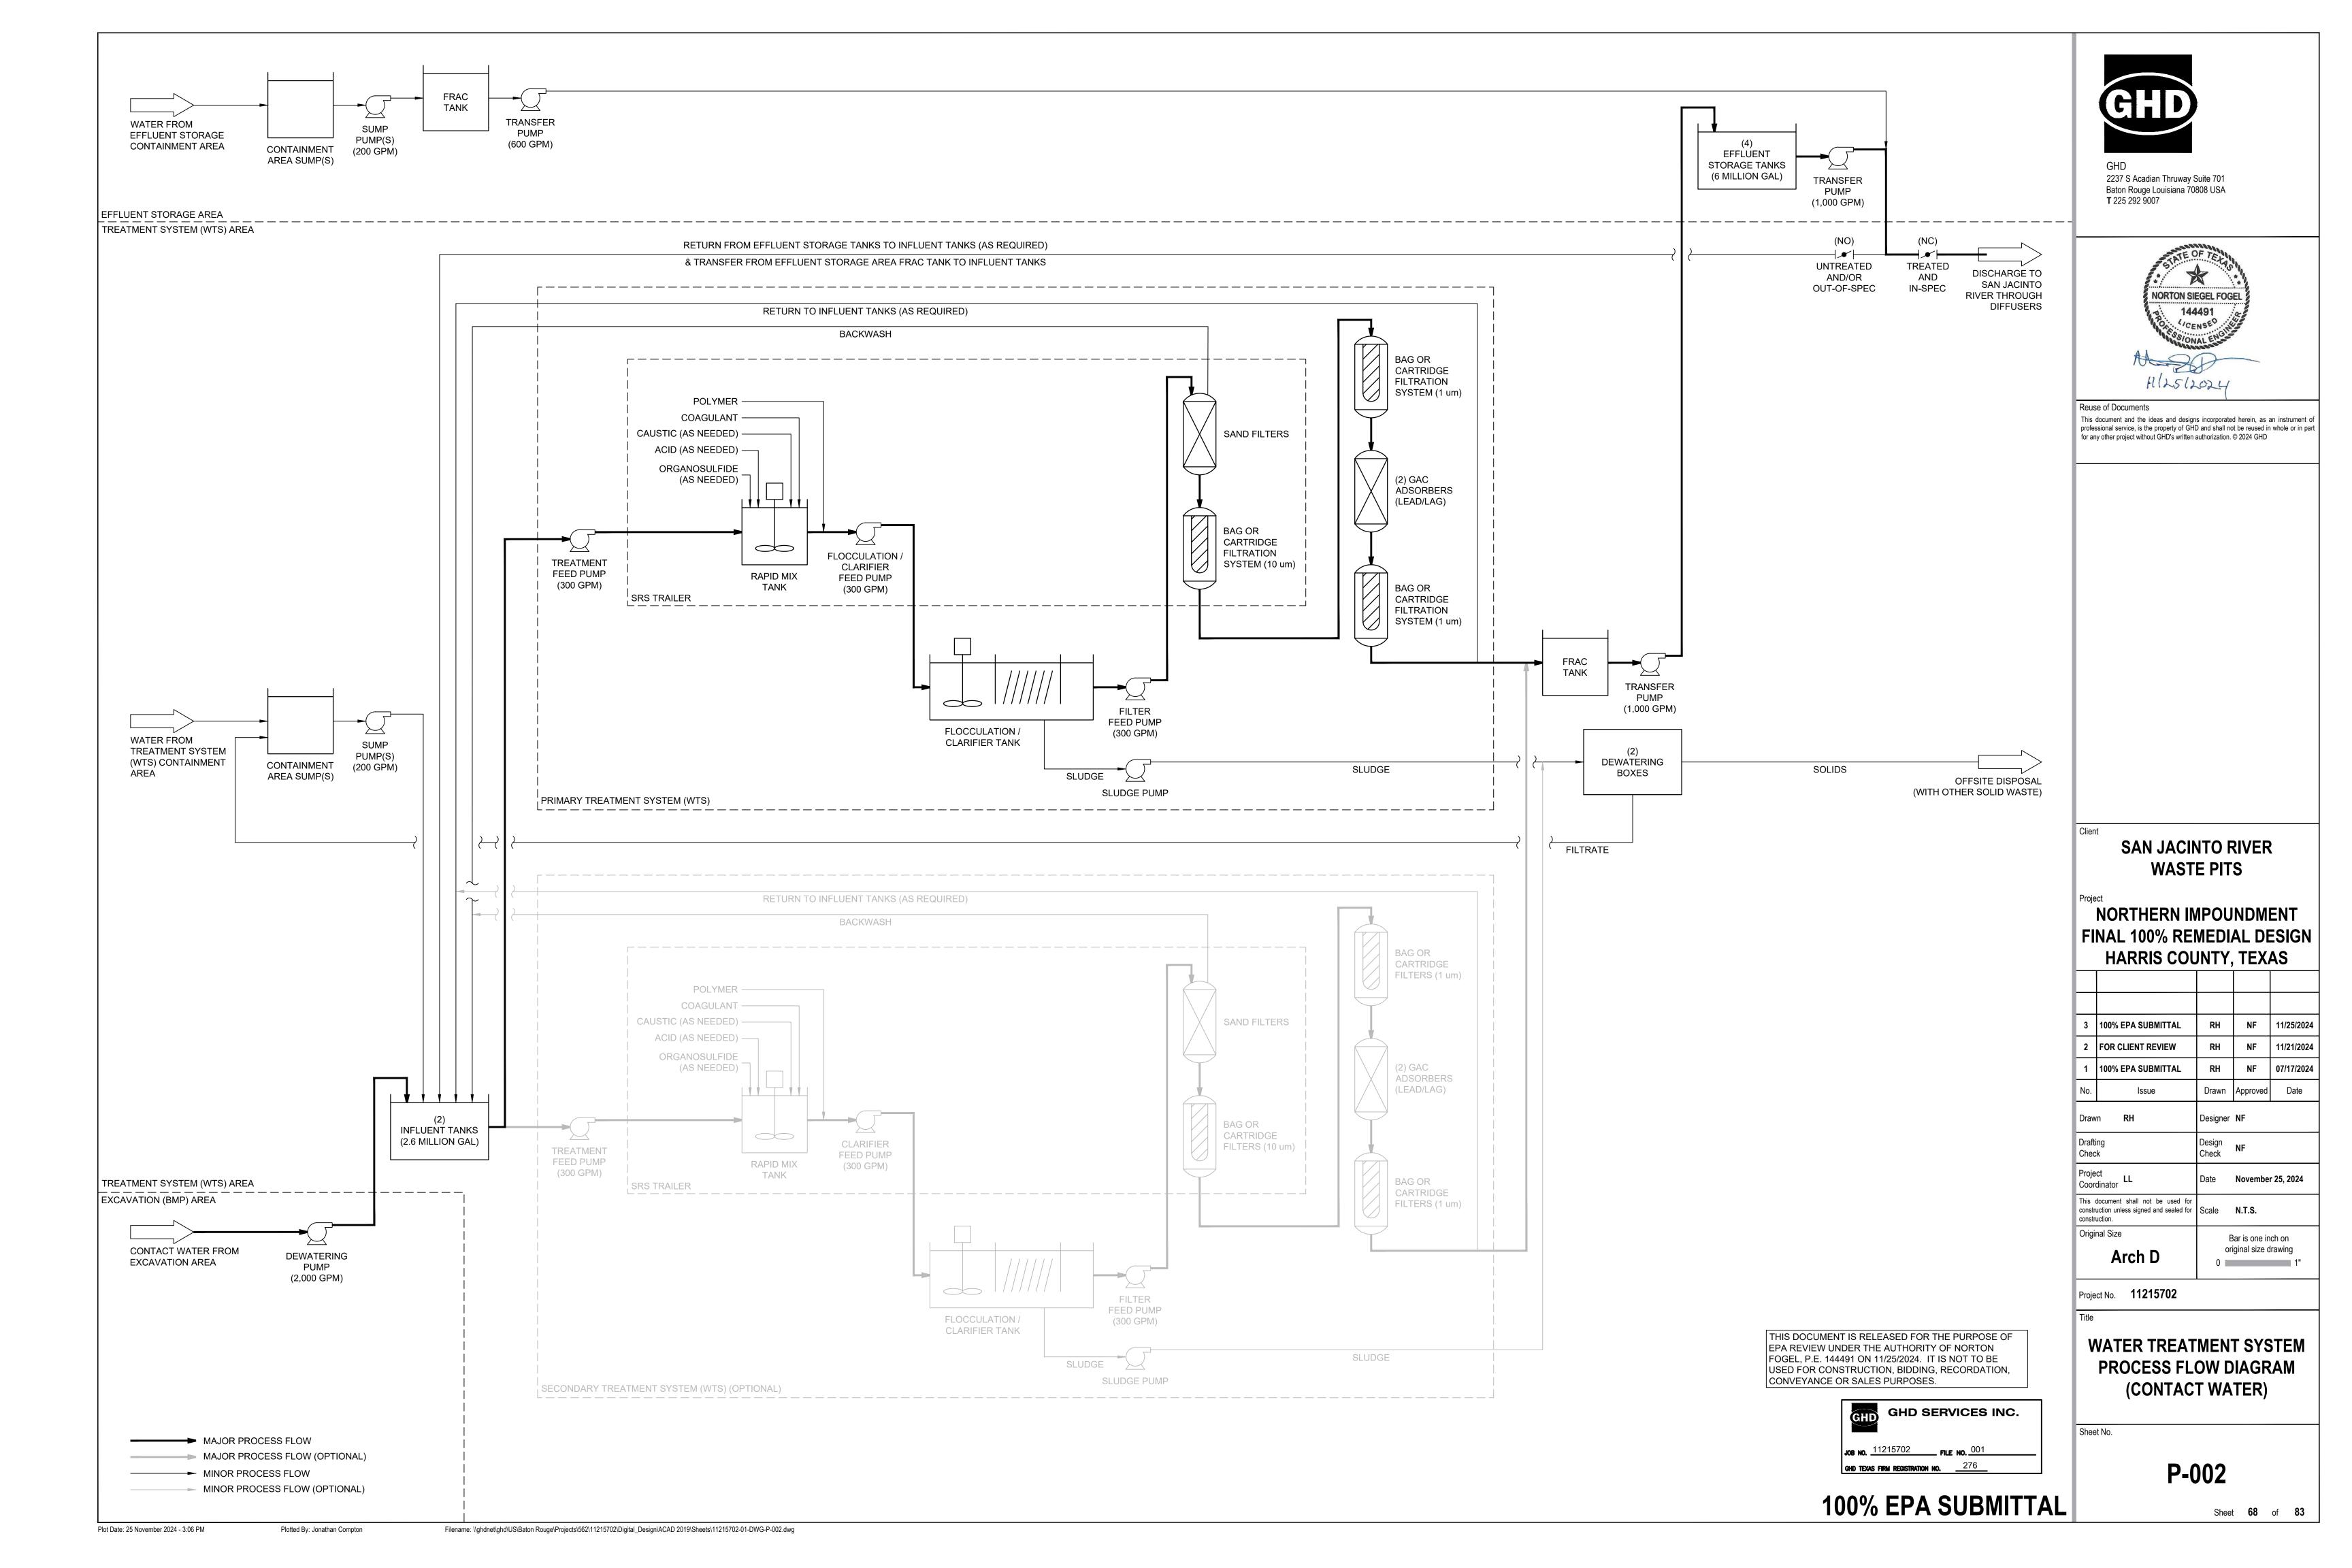

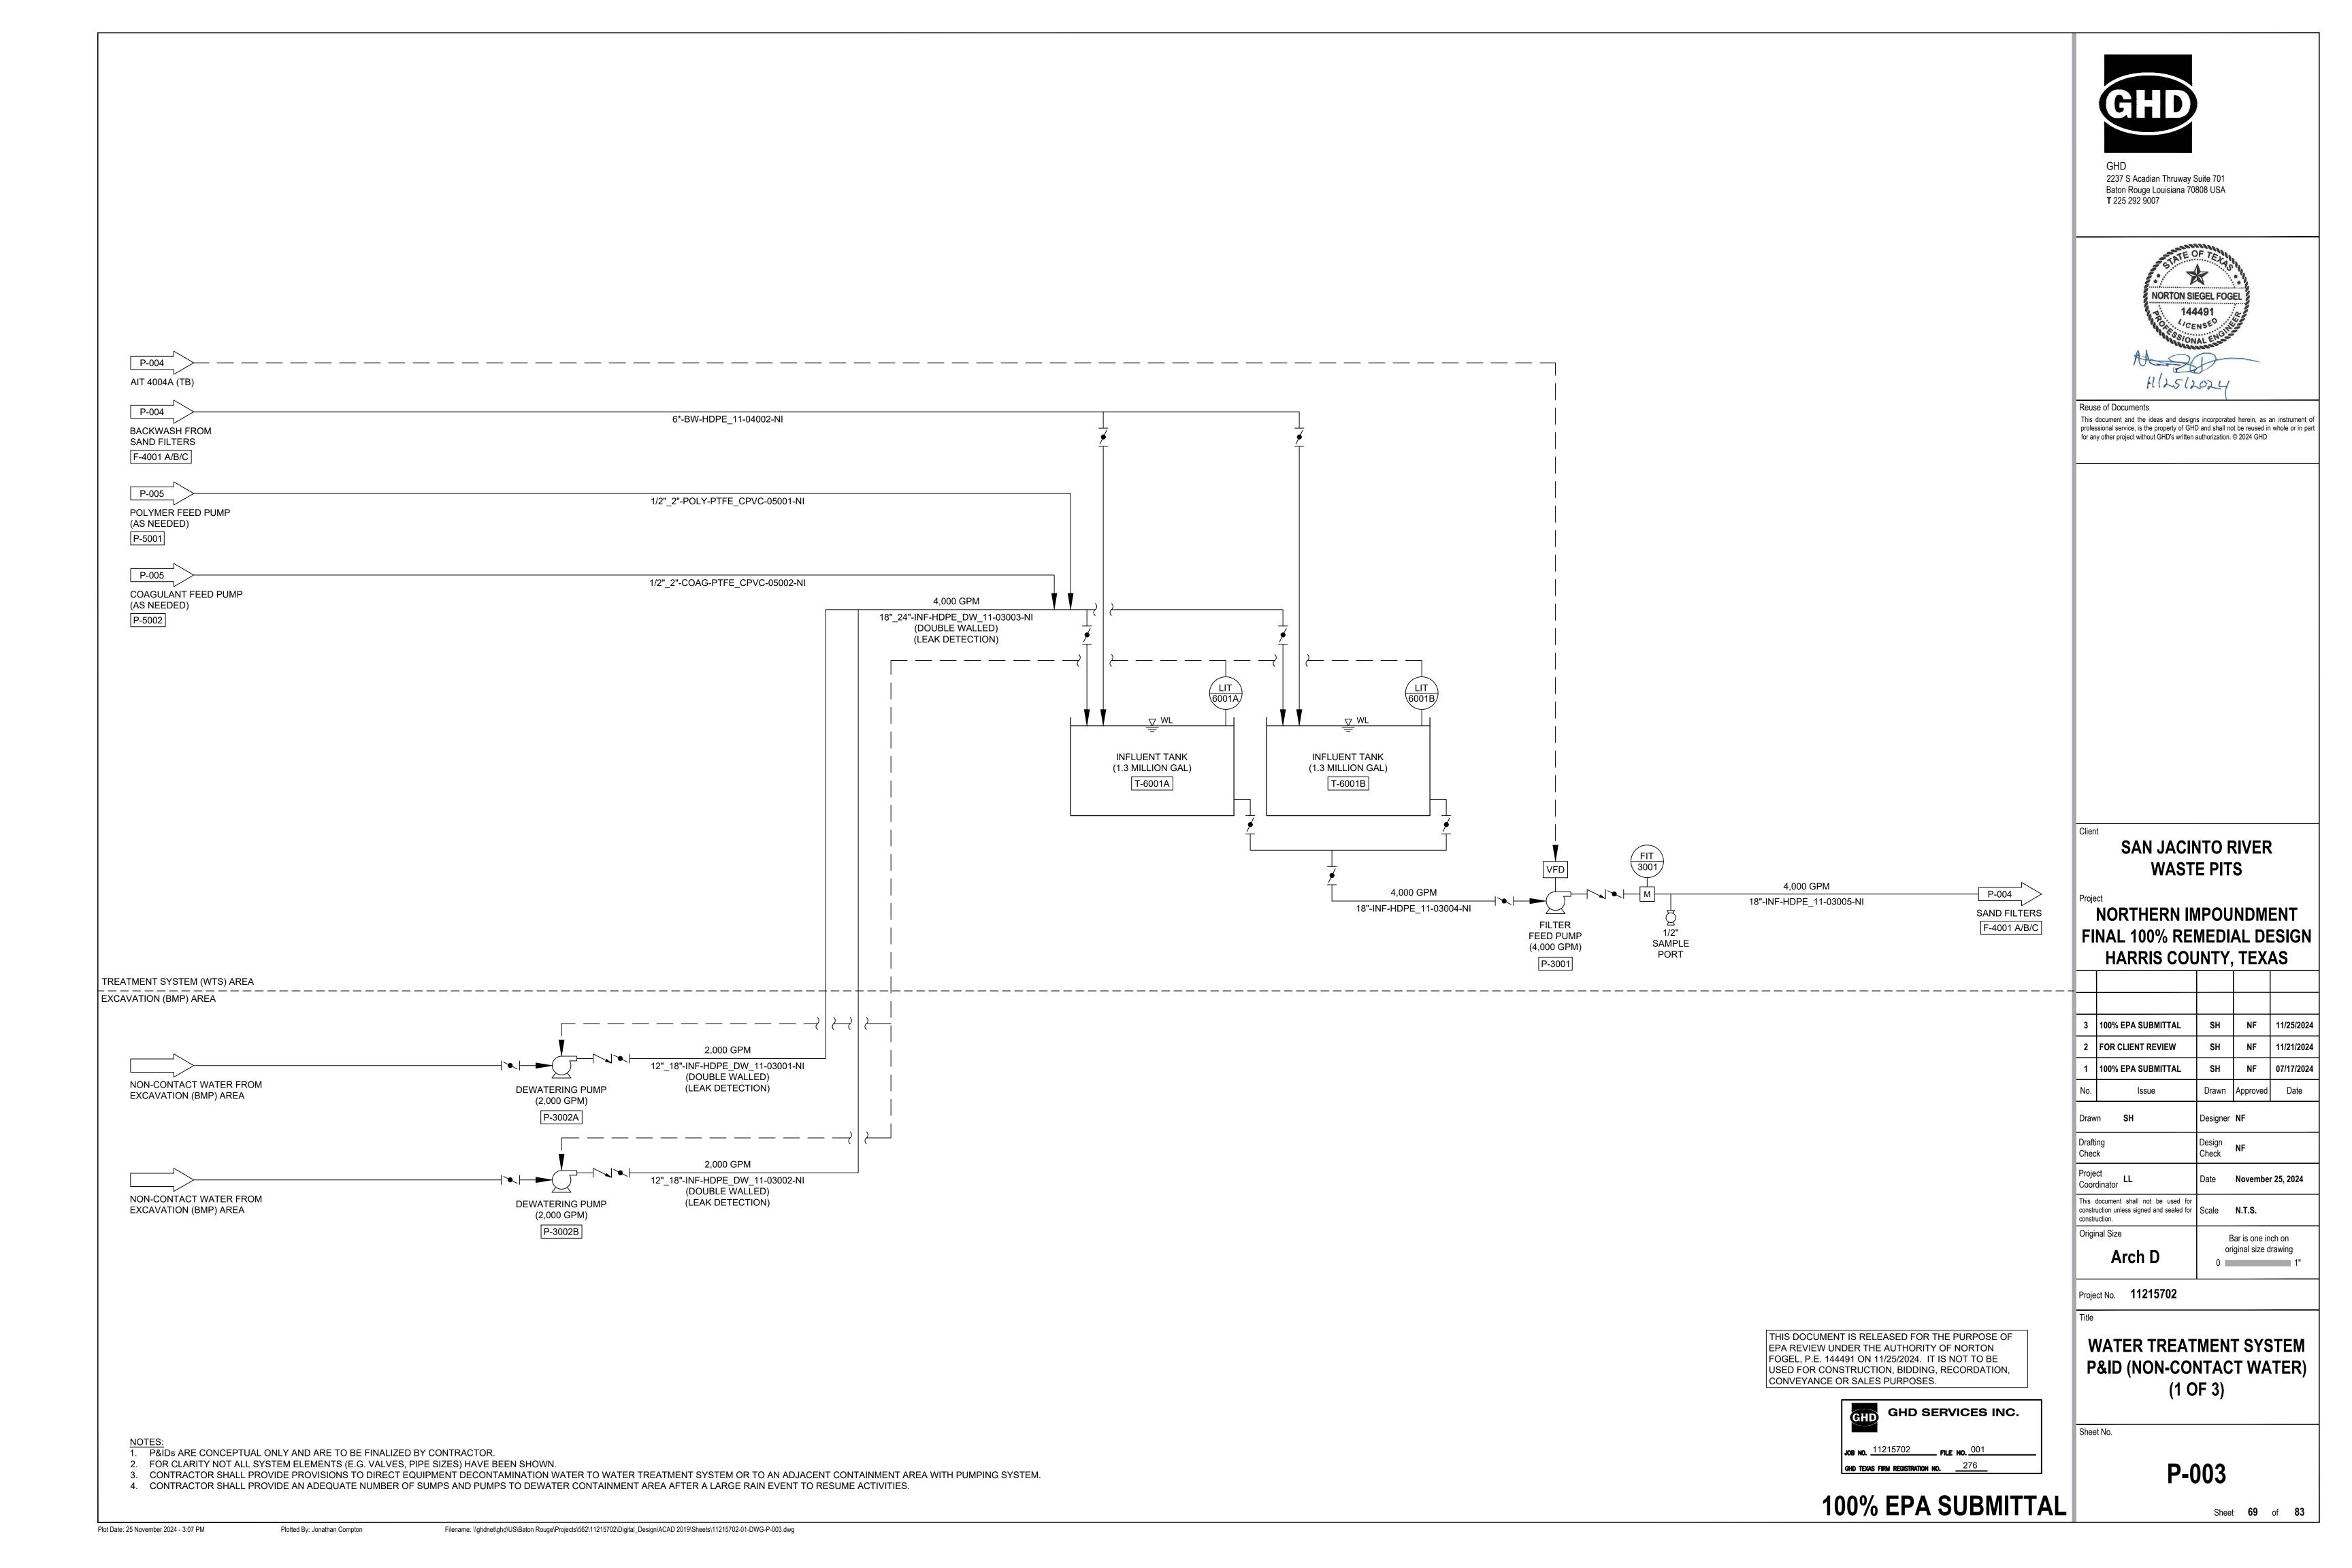




2237 S Acadian Thruway Suite 701 Baton Rouge Louisiana 70808 USA **T** 225 292 9007



Reuse of Documents

This document and the ideas and designs incorporated herein, as an instrument of professional service, is the property of GHD and shall not be reused in whole or in part for any other project without GHD's written authorization. © 2024 GHD

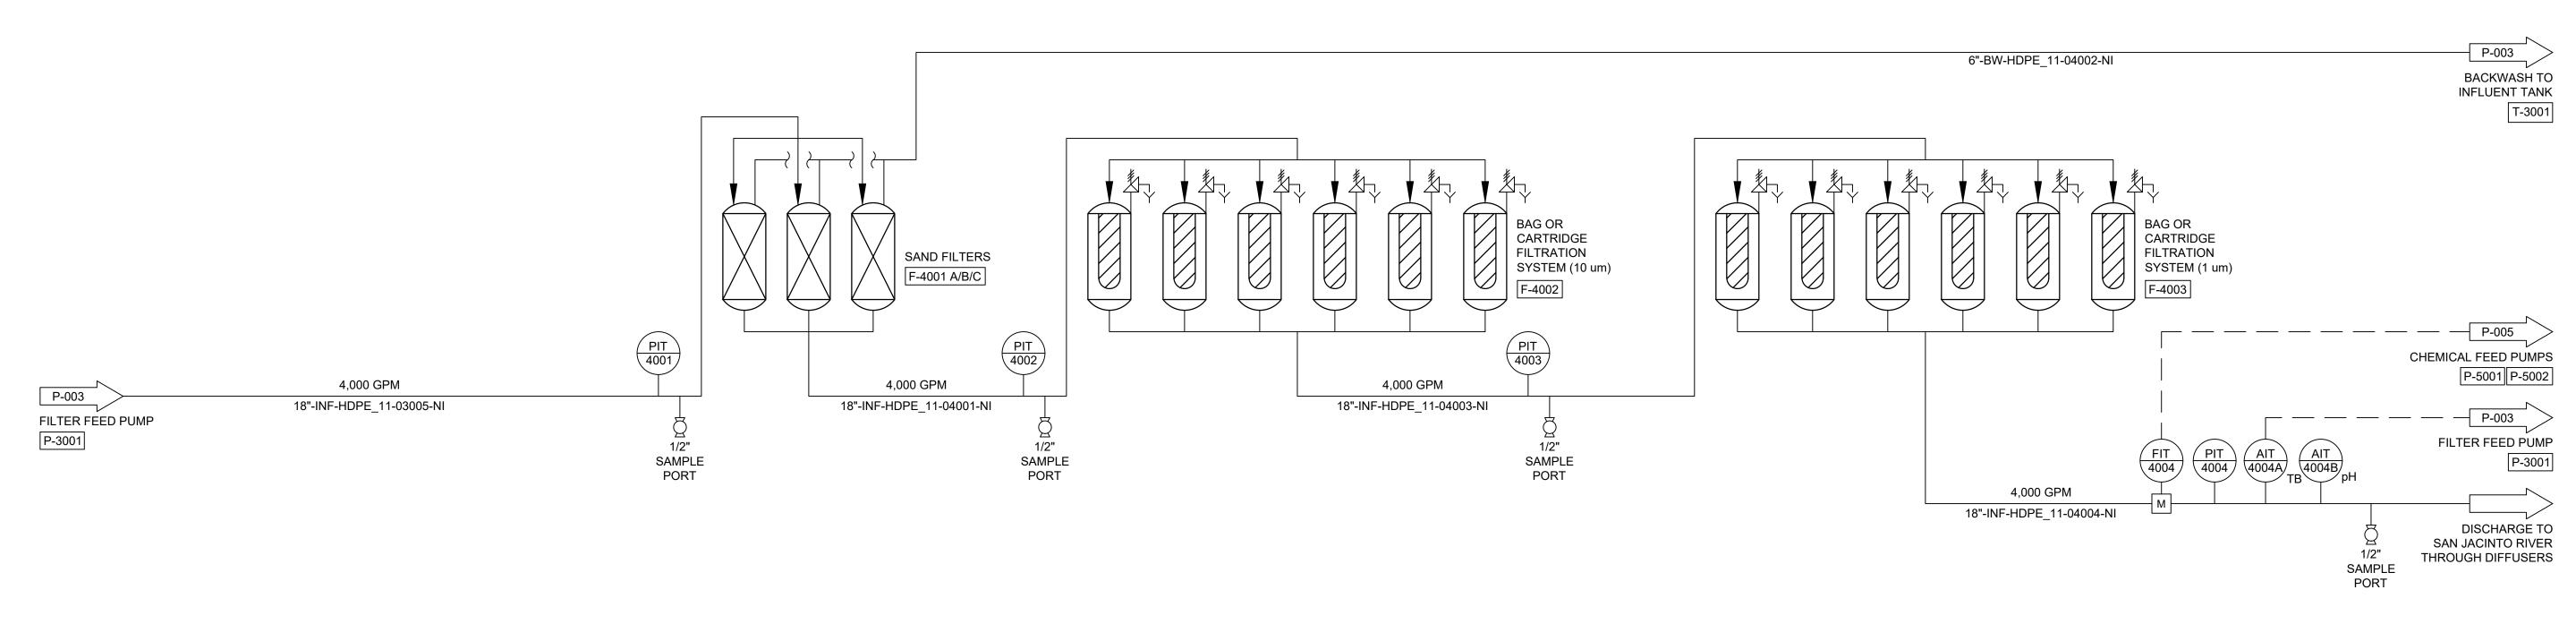

**SAN JACINTO RIVER WASTE PITS** 

NORTHERN IMPOUNDMENT FINAL 100% REMEDIAL DESIGN HARRIS COUNTY, TEXAS

3	100% EPA SUBMITTAL	SH	NF	11/25/2024			
2	FOR CLIENT REVIEW	SH	SH NF 11/21				
1	100% EPA SUBMITTAL	SH	07/17/2024				
No.	Issue	Drawn	Approved	Date			
Draw	Drawn SH		Designer <b>NF</b>				
Drafting Check		Design Check	NF				
Proje Coord	ct dinator	Date	November 25, 2024				
This document shall not be used for construction unless signed and sealed for construction.		Scale N.T.S.					
Original Size		Е	Bar is one in	ch on			
	Arch D	ori 0	iginal size d	rawing 1"			

Project No. **11215702** 

WATER TREATMENT SYSTEM P&ID (NON-CONTACT WATER) (2 OF 3)

Sheet No.

P-004

Sheet **70** of **83** 

THIS DOCUMENT IS RELEASED FOR THE PURPOSE OF EPA REVIEW UNDER THE AUTHORITY OF NORTON FOGEL, P.E. 144491 ON 11/25/2024. IT IS NOT TO BE USED FOR CONSTRUCTION, BIDDING, RECORDATION, CONVEYANCE OR SALES PURPOSES.



**100% EPA SUBMITTAL** 

2. FOR CLARITY NOT ALL SYSTEM ELEMENTS (E.G. VALVES, PIPE SIZES) HAVE BEEN SHOWN. 3. CONTRACTOR SHALL PROVIDE PROVISIONS TO DIRECT EQUIPMENT DECONTAMINATION WATER TO WATER TREATMENT SYSTEM OR TO AN ADJACENT CONTAINMENT AREA WITH PUMPING SYSTEM.

1. P&IDs ARE CONCEPTUAL ONLY AND ARE TO BE FINALIZED BY CONTRACTOR.

4. CONTRACTOR SHALL PROVIDE AN ADEQUATE NUMBER OF SUMPS AND PUMPS TO DEWATER CONTAINMENT AREA AFTER A LARGE RAIN EVENT TO RESUME ACTIVITIES.

Plotted By: Jonathan Compton

Plot Date: 25 November 2024 - 3:07 PM

Filename: \\ghd\uS\Baton Rouge\Projects\562\11215702\Digital\_Design\ACAD 2019\Sheets\11215702-01-DWG-P-004.dwg



2237 S Acadian Thruway Suite 701 Baton Rouge Louisiana 70808 USA **T** 225 292 9007



Reuse of Documents

This document and the ideas and designs incorporated herein, as an instrument of professional service, is the property of GHD and shall not be reused in whole or in part for any other project without GHD's written authorization. © 2024 GHD

T-3001

**SAN JACINTO RIVER WASTE PITS** 

NORTHERN IMPOUNDMENT FINAL 100% REMEDIAL DESIGN HARRIS COUNTY, TEXAS

3	100% EPA SUBMITTAL	SH	NF	11/25/202	
2	FOR CLIENT REVIEW	SH	NF	11/21/202	
1	100% EPA SUBMITTAL	SH	SH NF 07/		
No.	Issue	Drawn	Approved	Date	
Draw	n <b>SH</b>	Designer	NF		
Drafti Chec	•	Design Check	NF		
Proje Coor	ct dinator	Date	Novembe	r 25, 2024	
This document shall not be used for construction unless signed and sealed for construction.		Scale	N.T.S.		

Project No. **11215702** 

Arch D

Original Size

WATER TREATMENT SYSTEM P&ID (NON-CONTACT WATER) (3 OF 3)

Sheet No.

P-005

Sheet **71** of **83** 

Bar is one inch on original size drawing

POLYMER TANK T-5001 P-003 1/2"\_2"-POLY-PTFE\_CPVC-05001-NI POLYMER INFLUENT TANK FEED PUMP (AS NEEDED) P-5001 COAGULANT TANK T-5002 P-003 1/2"\_2"-COAG-PTFE\_CPVC-05002-NI COAGULANT FEED PUMP INFLUENT TANK (AS NEEDED) T-3001 P-5002

Plot Date: 25 November 2024 - 3:08 PM

1. P&IDs ARE CONCEPTUAL ONLY AND ARE TO BE FINALIZED BY CONTRACTOR.

2. FOR CLARITY NOT ALL SYSTEM ELEMENTS (E.G. VALVES, PIPE SIZES) HAVE BEEN SHOWN.

3. CONTRACTOR SHALL PROVIDE PROVISIONS TO DIRECT EQUIPMENT DECONTAMINATION WATER TO WATER TREATMENT SYSTEM OR TO AN ADJACENT CONTAINMENT AREA WITH PUMPING SYSTEM.

4. CONTRACTOR SHALL PROVIDE AN ADEQUATE NUMBER OF SUMPS AND PUMPS TO DEWATER CONTAINMENT AREA AFTER A LARGE RAIN EVENT TO RESUME ACTIVITIES.

Filename: \\ghdnet\ghd\US\Baton Rouge\Projects\562\11215702\Digital\_Design\ACAD 2019\Sheets\11215702-01-DWG-P-005.dwg

100% EPA SUBMITTAL

GHD SERVICES INC.

JOB NO. 11215702 FILE NO. 001


GHD TEXAS FIRM REGISTRATION NO. 276


THIS DOCUMENT IS RELEASED FOR THE PURPOSE OF

USED FOR CONSTRUCTION, BIDDING, RECORDATION,

EPA REVIEW UNDER THE AUTHORITY OF NORTON FOGEL, P.E. 144491 ON 11/25/2024. IT IS NOT TO BE

CONVEYANCE OR SALES PURPOSES.

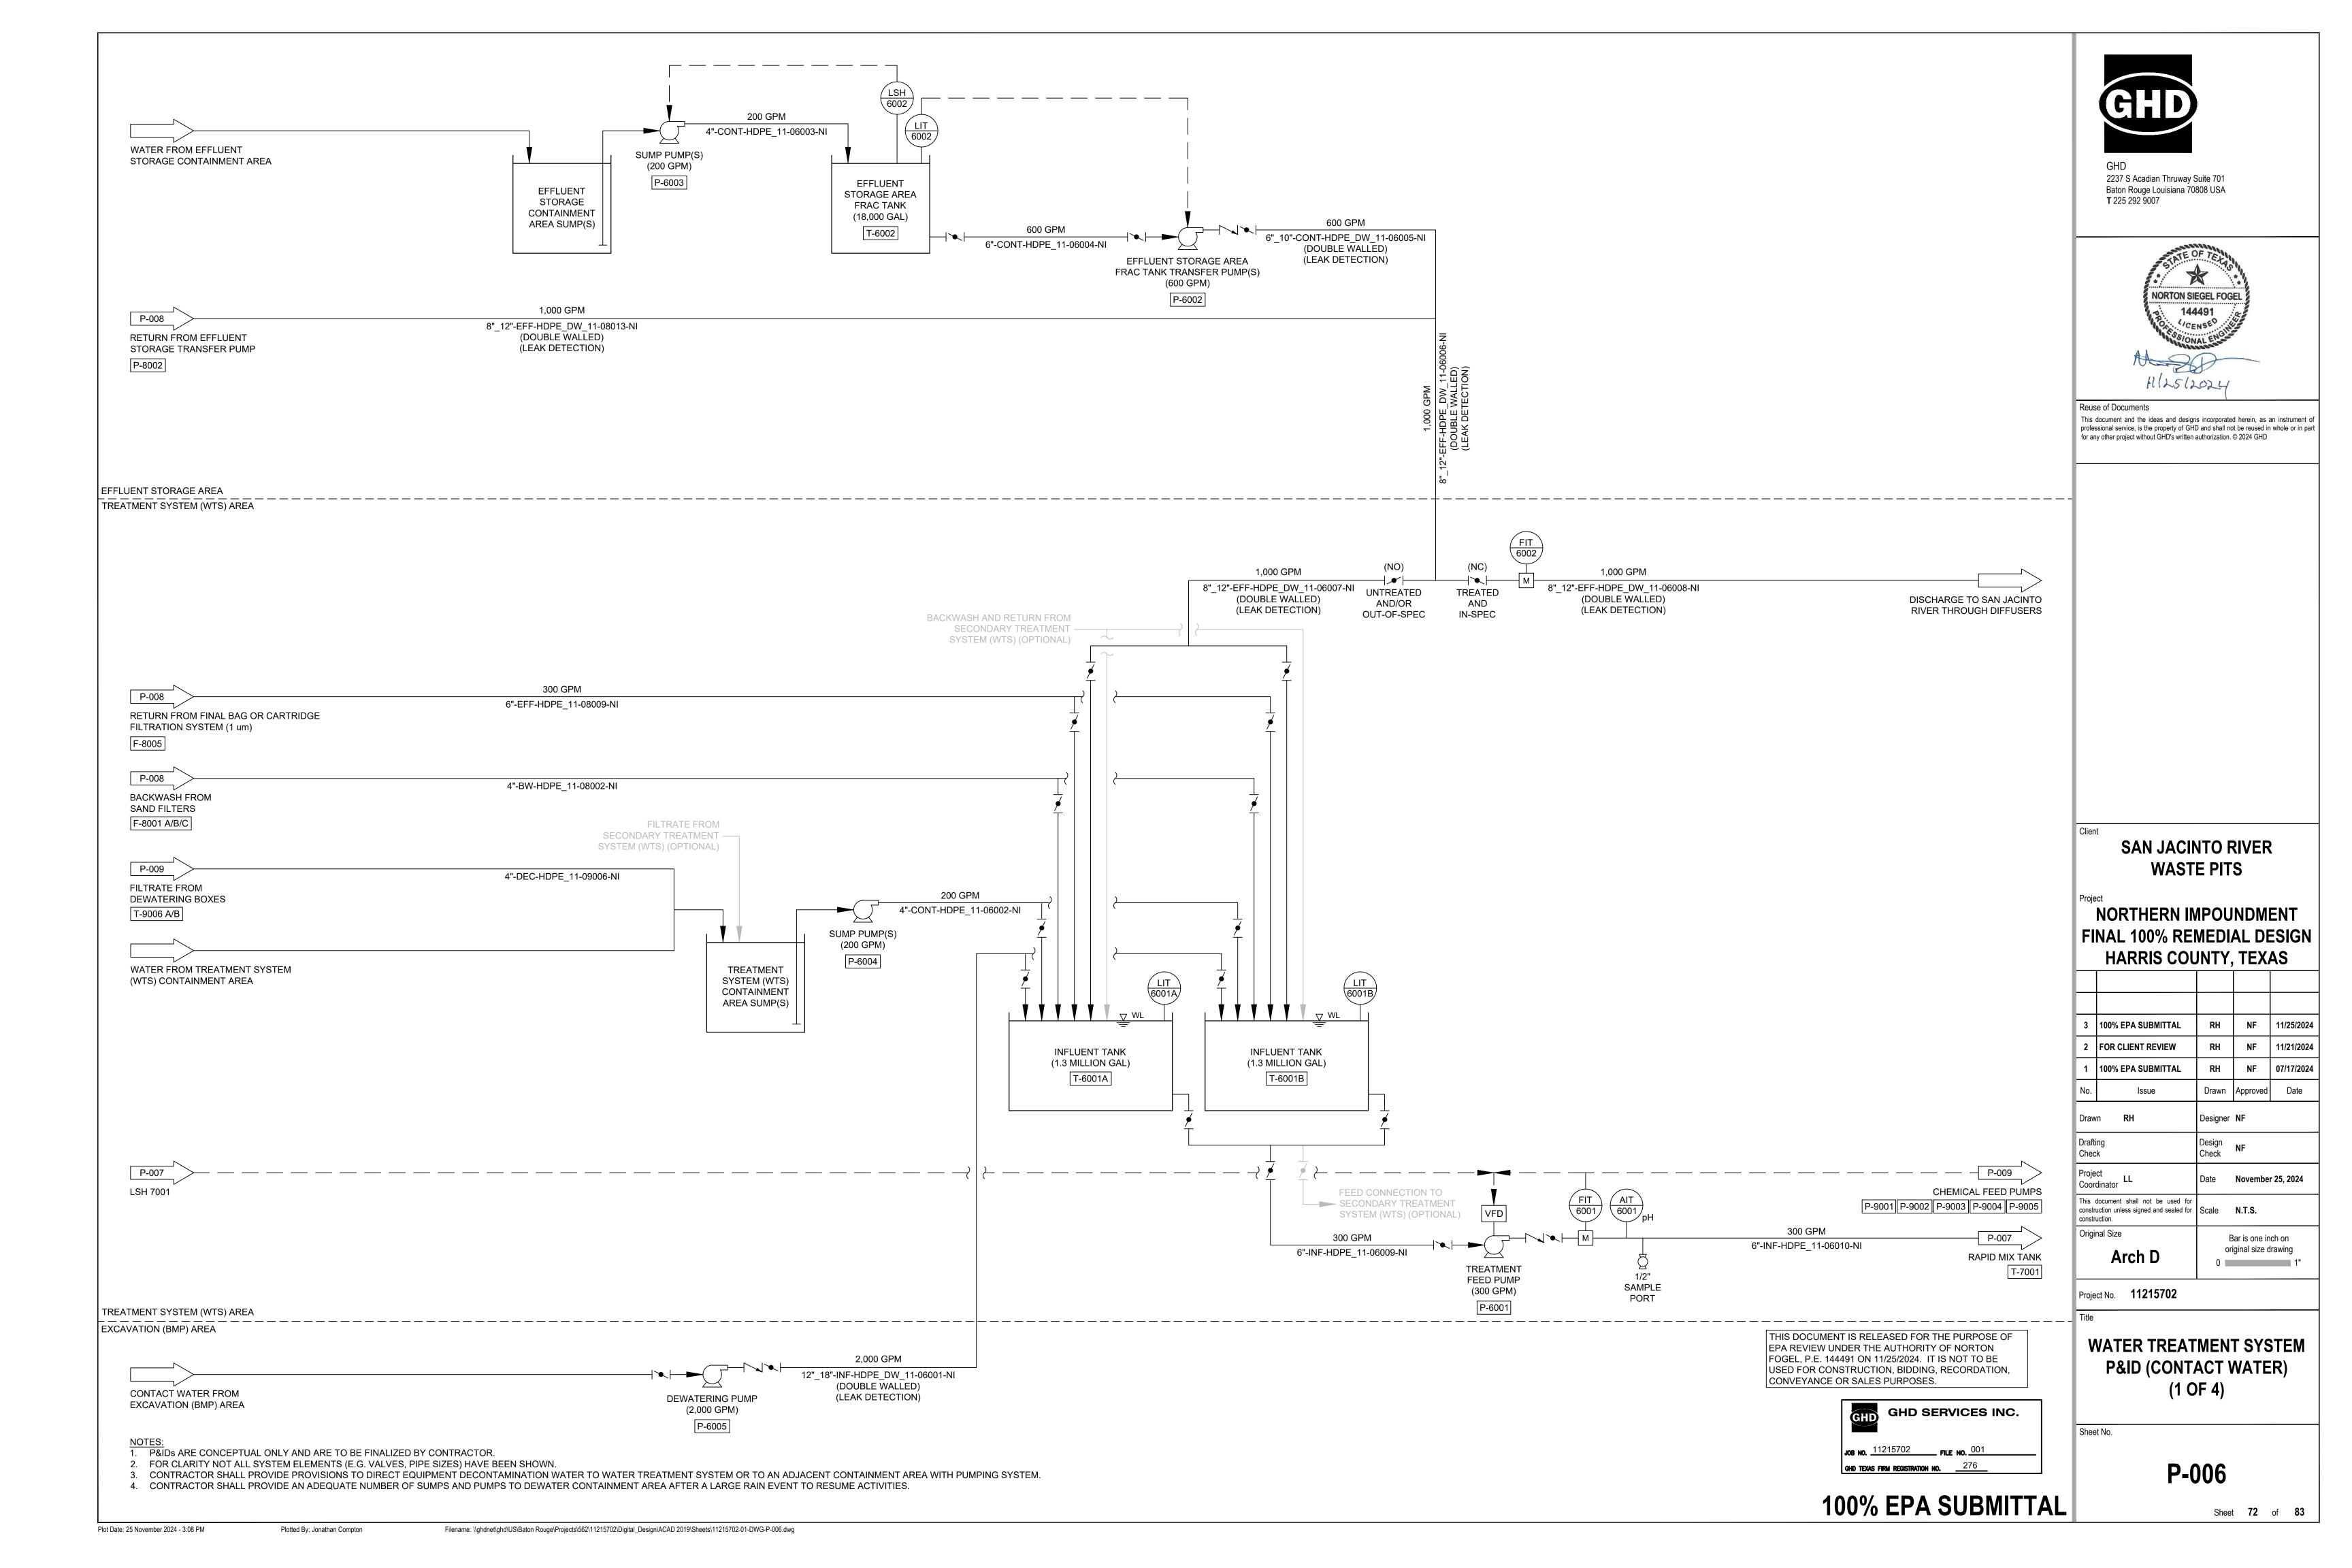

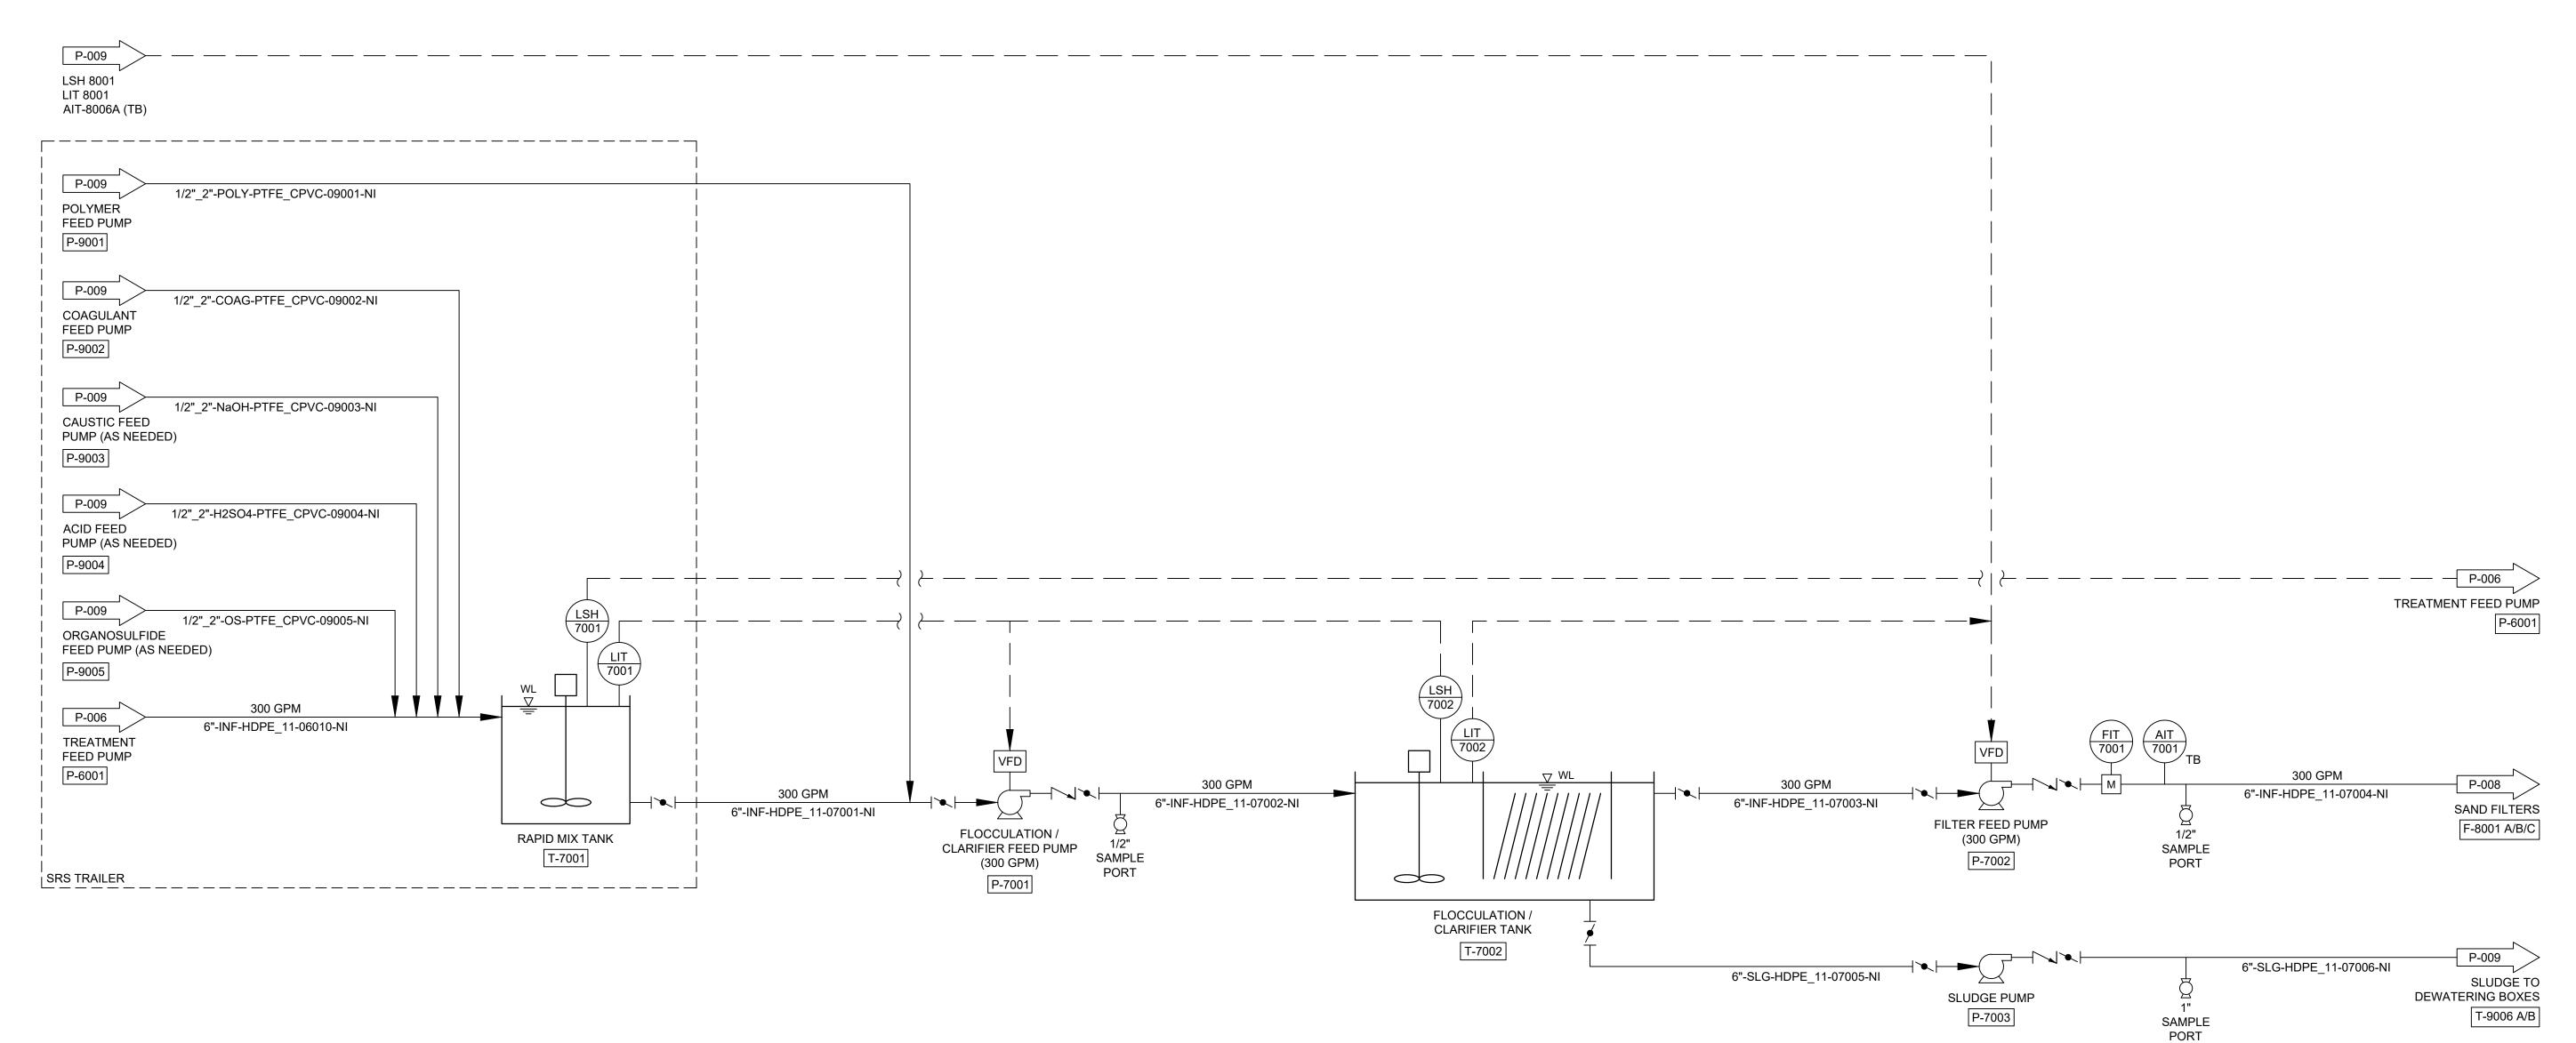



Reuse of Documents

This document and the ideas and designs incorporated herein, as an instrument of professional service, is the property of GHD and shall not be reused in whole or in part for any other project without GHD's written authorization. © 2024 GHD

**SAN JACINTO RIVER WASTE PITS** 

NORTHERN IMPOUNDMENT FINAL 100% REMEDIAL DESIGN HARRIS COUNTY, TEXAS

3	100% EPA SUBMITTAL	SH	NF	11/25/202
2	FOR CLIENT REVIEW	SH	NF	11/21/20
1	100% EPA SUBMITTAL	SH	NF	07/17/202
No.	Issue	Drawn	Approved	Date
Draw	n <b>SH</b>	Designer	NF	
Drafti Chec	•	Design Check	NF	
Proje Coor	ct dinator	Date <b>November</b>		r 25, 2024
	document shall not be used for uction unless signed and sealed for uction.	Scale	N.T.S.	
Origi	nal Size	Bar is one inch on		

Project No. **11215702** 

Arch D

THIS DOCUMENT IS RELEASED FOR THE PURPOSE OF

USED FOR CONSTRUCTION, BIDDING, RECORDATION,

GHD SERVICES INC.

**100% EPA SUBMITTAL** 

JOB NO. 11215702 FILE NO. 001

GHD TEXAS FIRM REGISTRATION NO. 276

EPA REVIEW UNDER THE AUTHORITY OF NORTON FOGEL, P.E. 144491 ON 11/25/2024. IT IS NOT TO BE

CONVEYANCE OR SALES PURPOSES.

WATER TREATMENT SYSTEM P&ID (CONTACT WATER) (2 OF 4)

Sheet No.

P-007

Sheet **73** of **83** 

original size drawing


Plot Date: 25 November 2024 - 3:08 PM


1. P&IDs ARE CONCEPTUAL ONLY AND ARE TO BE FINALIZED BY CONTRACTOR.


2. FOR CLARITY NOT ALL SYSTEM ELEMENTS (E.G. VALVES, PIPE SIZES) HAVE BEEN SHOWN.

3. CONTRACTOR SHALL PROVIDE PROVISIONS TO DIRECT EQUIPMENT DECONTAMINATION WATER TO WATER TREATMENT SYSTEM OR TO AN ADJACENT CONTAINMENT AREA WITH PUMPING SYSTEM.


4. CONTRACTOR SHALL PROVIDE AN ADEQUATE NUMBER OF SUMPS AND PUMPS TO DEWATER CONTAINMENT AREA AFTER A LARGE RAIN EVENT TO RESUME ACTIVITIES.

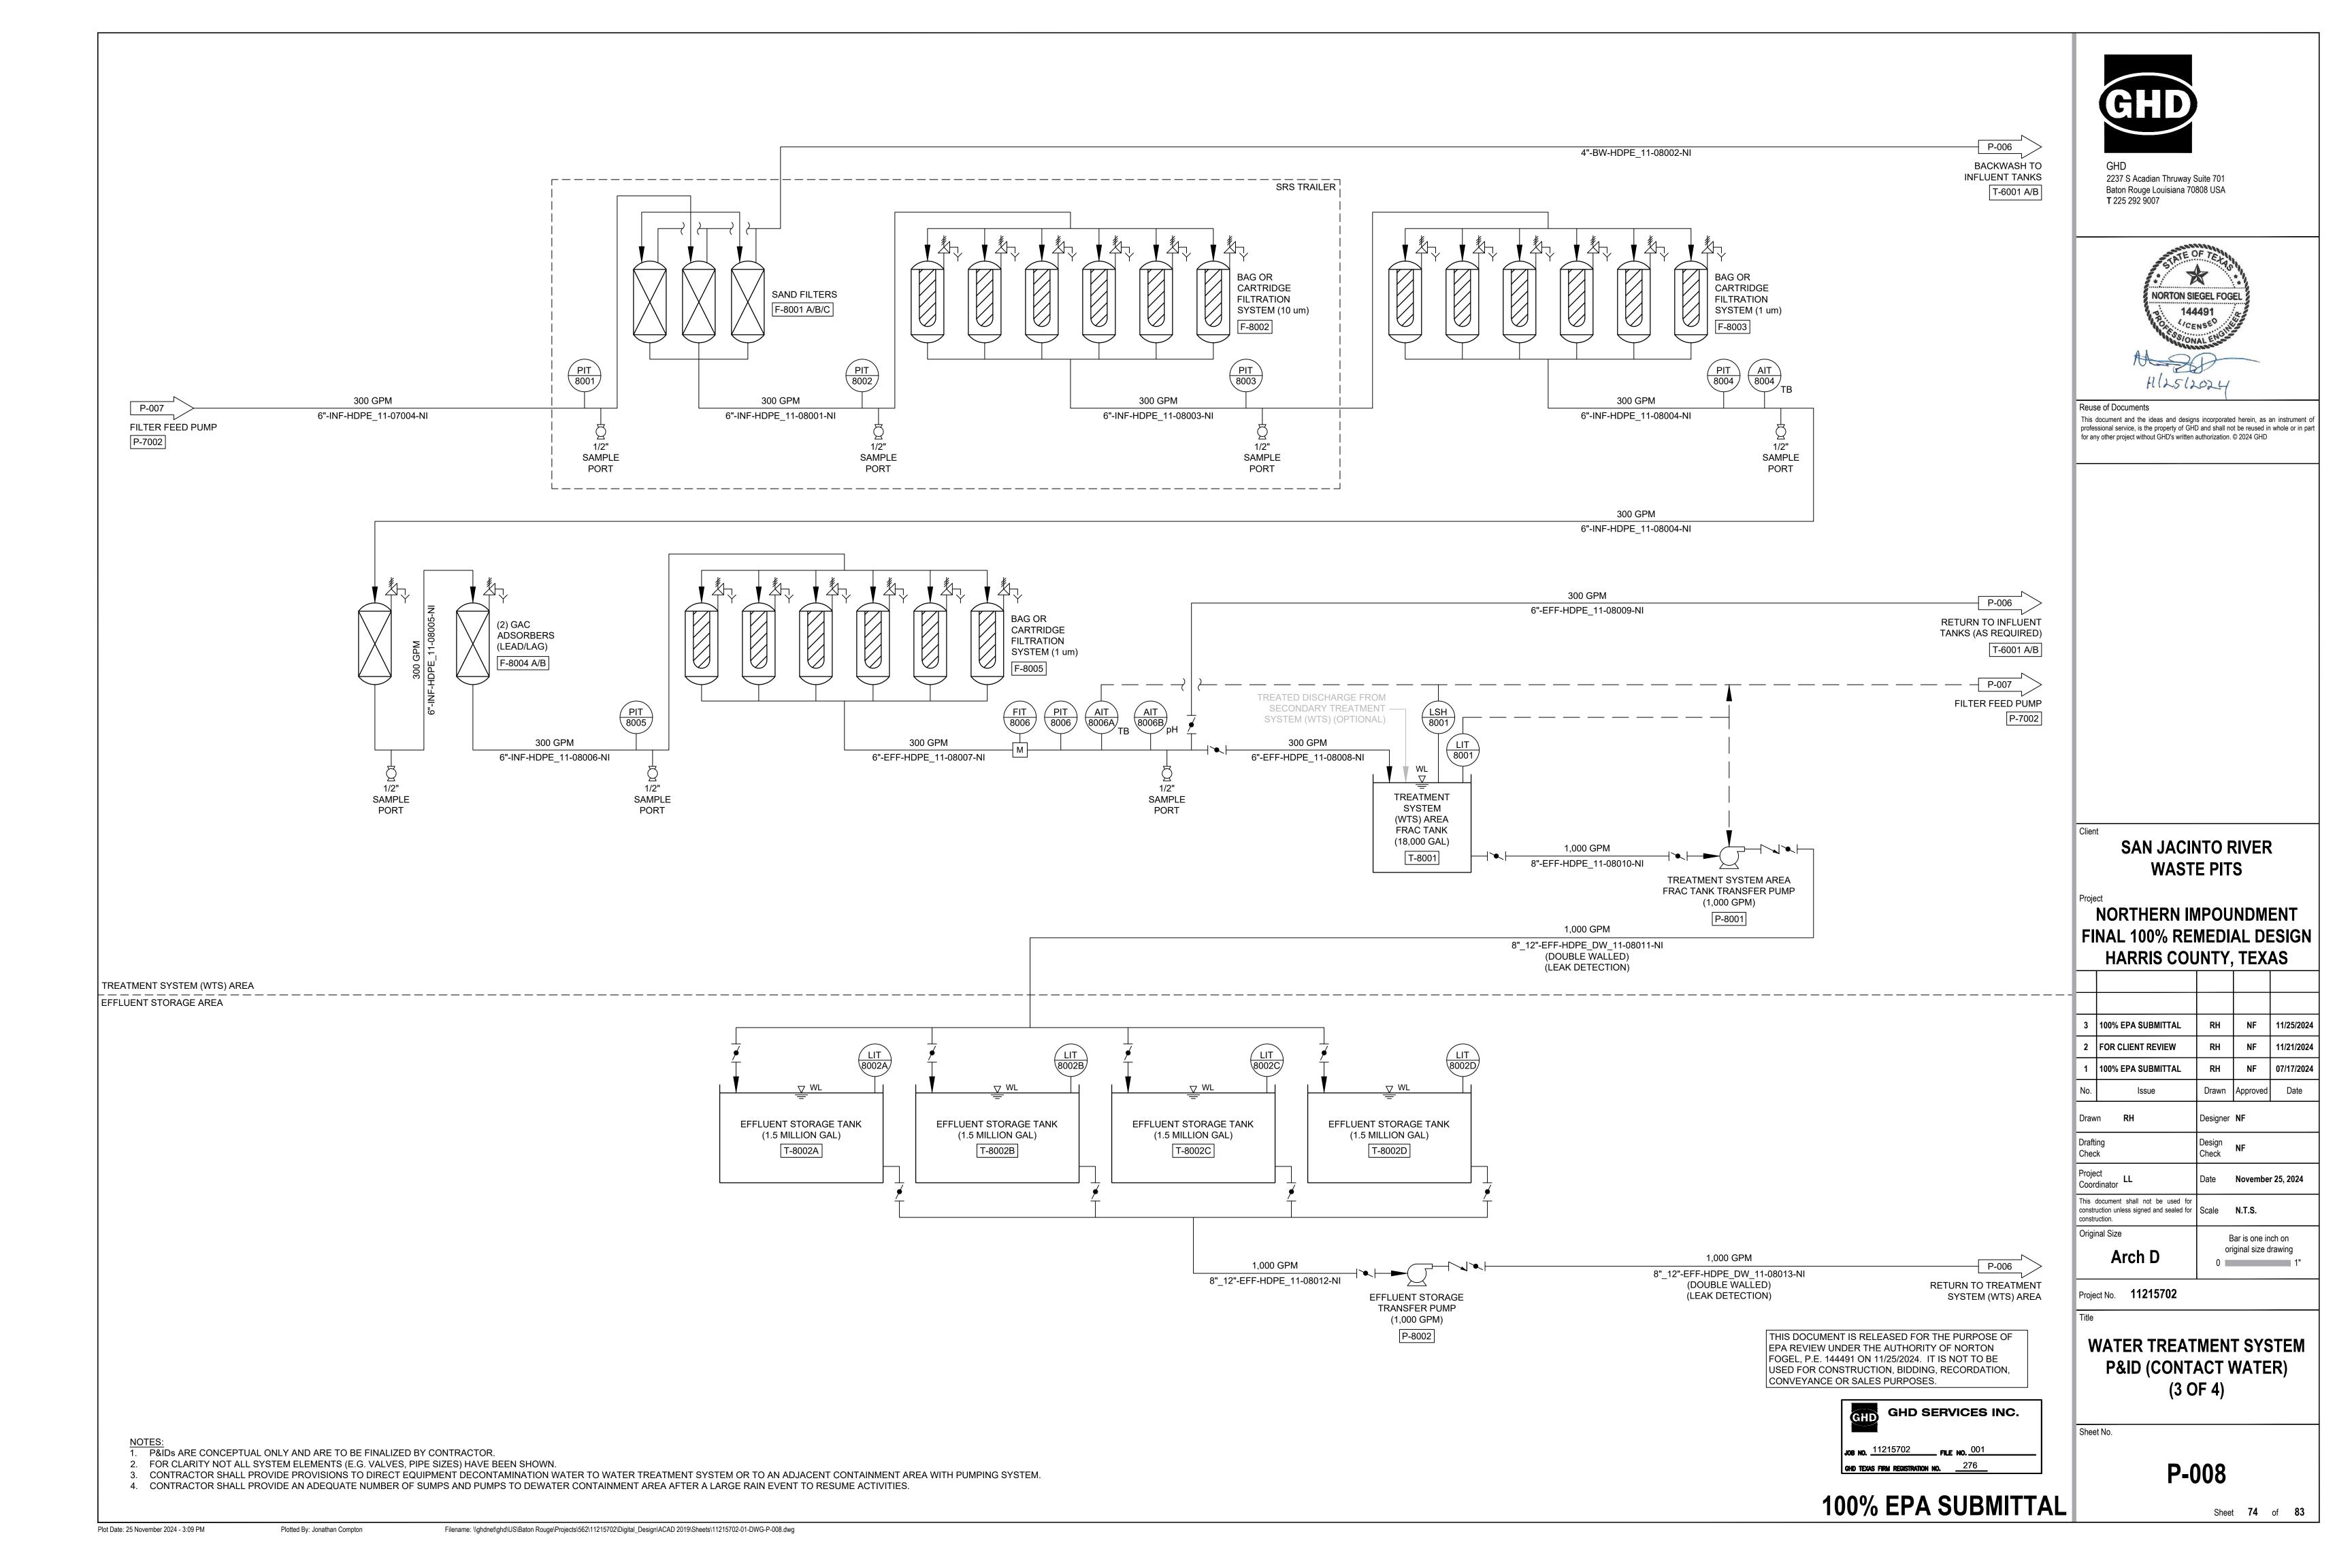

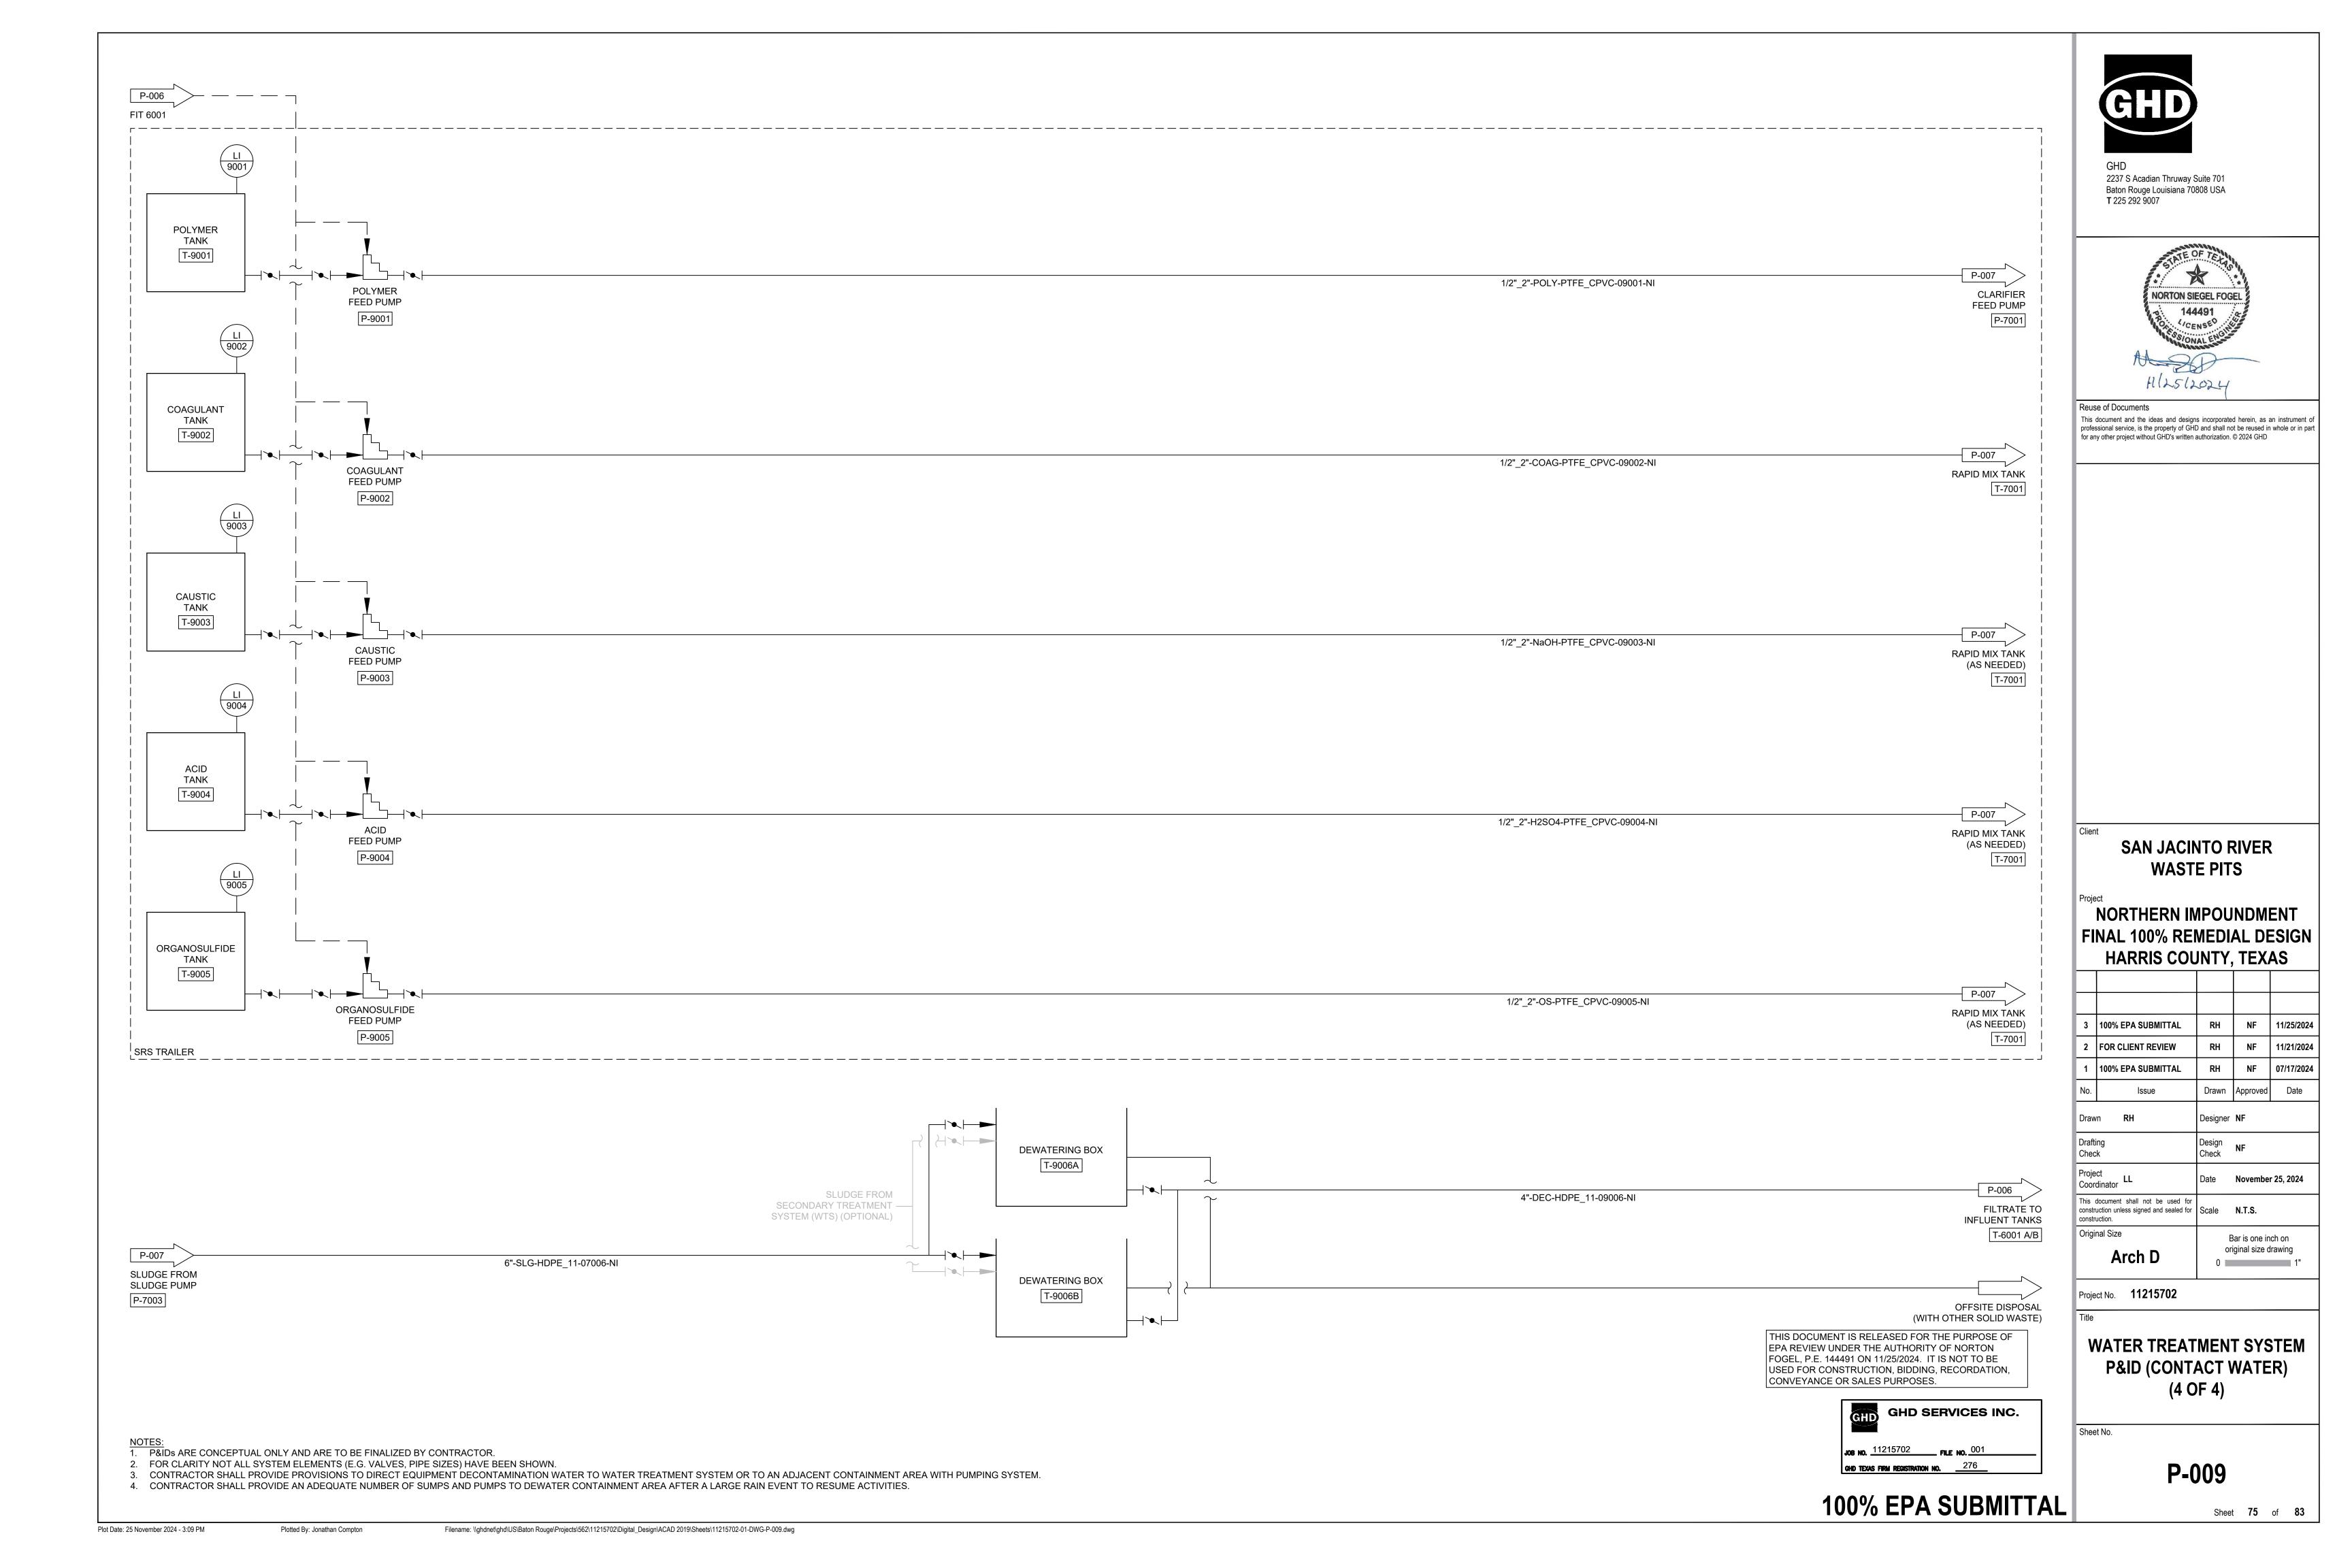

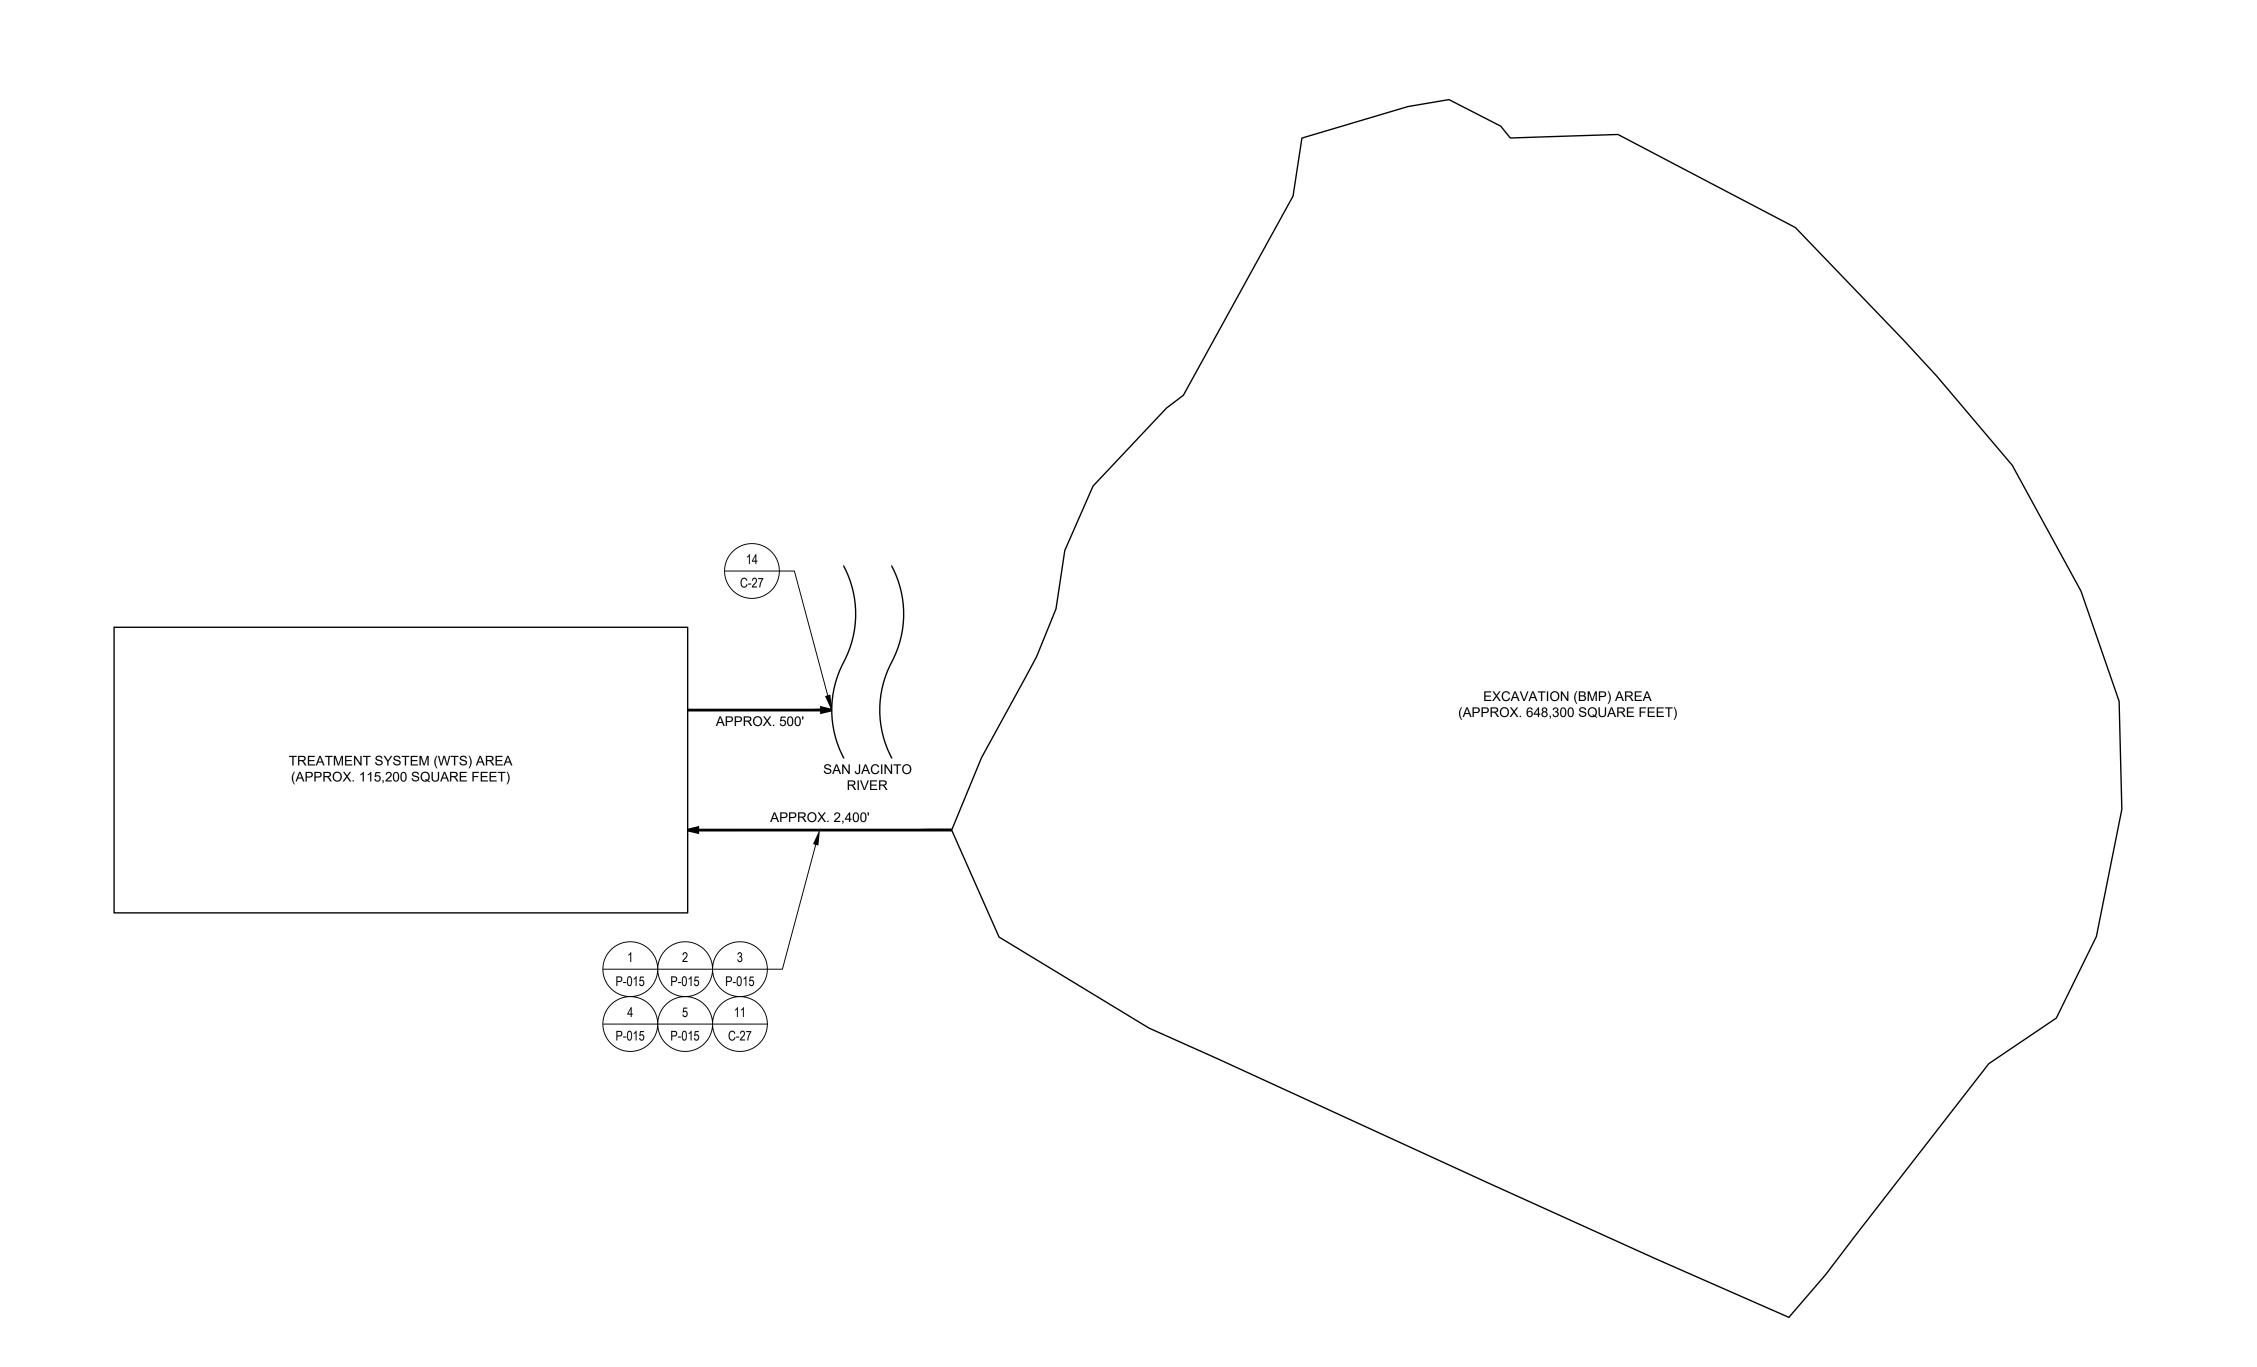



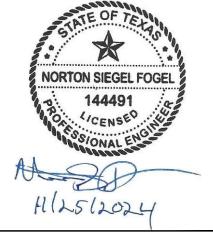

#### Reuse of Documents

This document and the ideas and designs incorporated herein, as an instrument of professional service, is the property of GHD and shall not be reused in whole or in part for any other project without GHD's written authorization. © 2024 GHD

## **SAN JACINTO RIVER WASTE PITS**

NORTHERN IMPOUNDMENT FINAL 100% REMEDIAL DESIGN HARRIS COUNTY, TEXAS

3	100% EPA SUBMITTAL	RH	NF	11/25/202
2	FOR CLIENT REVIEW	RH	NF	11/21/202
1	100% EPA SUBMITTAL	RH	NF	07/17/202
No.	Issue	Drawn	Approved	Date
Draw	n <b>RH</b>	Designer	NF	
Drafti Chec	_	Design Check NF		
Proje Coor	ct dinator	Date November 25, 202		
	document shall not be used for uction unless signed and sealed for uction.	Scale	N.T.S.	
Origi	nal Size	E	Bar is one in	ch on
	Arch D	or 0 ■	iginal size d	Irawing

Project No. **11215702** 

WATER TREATMENT SYSTEM SITE PLAN (NON-CONTACT WATER)

Sheet No.


P-010


Sheet **76** of **83** 

THIS DOCUMENT IS RELEASED FOR THE PURPOSE OF EPA REVIEW UNDER THE AUTHORITY OF NORTON FOGEL, P.E. 144491 ON 11/25/2024. IT IS NOT TO BE USED FOR CONSTRUCTION, BIDDING, RECORDATION, CONVEYANCE OR SALES PURPOSES.

## GHD SERVICES INC. JOB NO. 11215702 FILE NO. 001 GHD TEXAS FIRM REGISTRATION NO. 276

2. CONTRACTOR SHALL PROVIDE LEAK DETECTION AT LOW POINT ON ALL PIPELINES (SEE DETAIL 4/P-015). 3. CONTRACTOR SHALL INSTALL BIDIRECTIONAL CLEANOUTS EVERY 500' (MINIMUM) ON ALL PIPELINES.

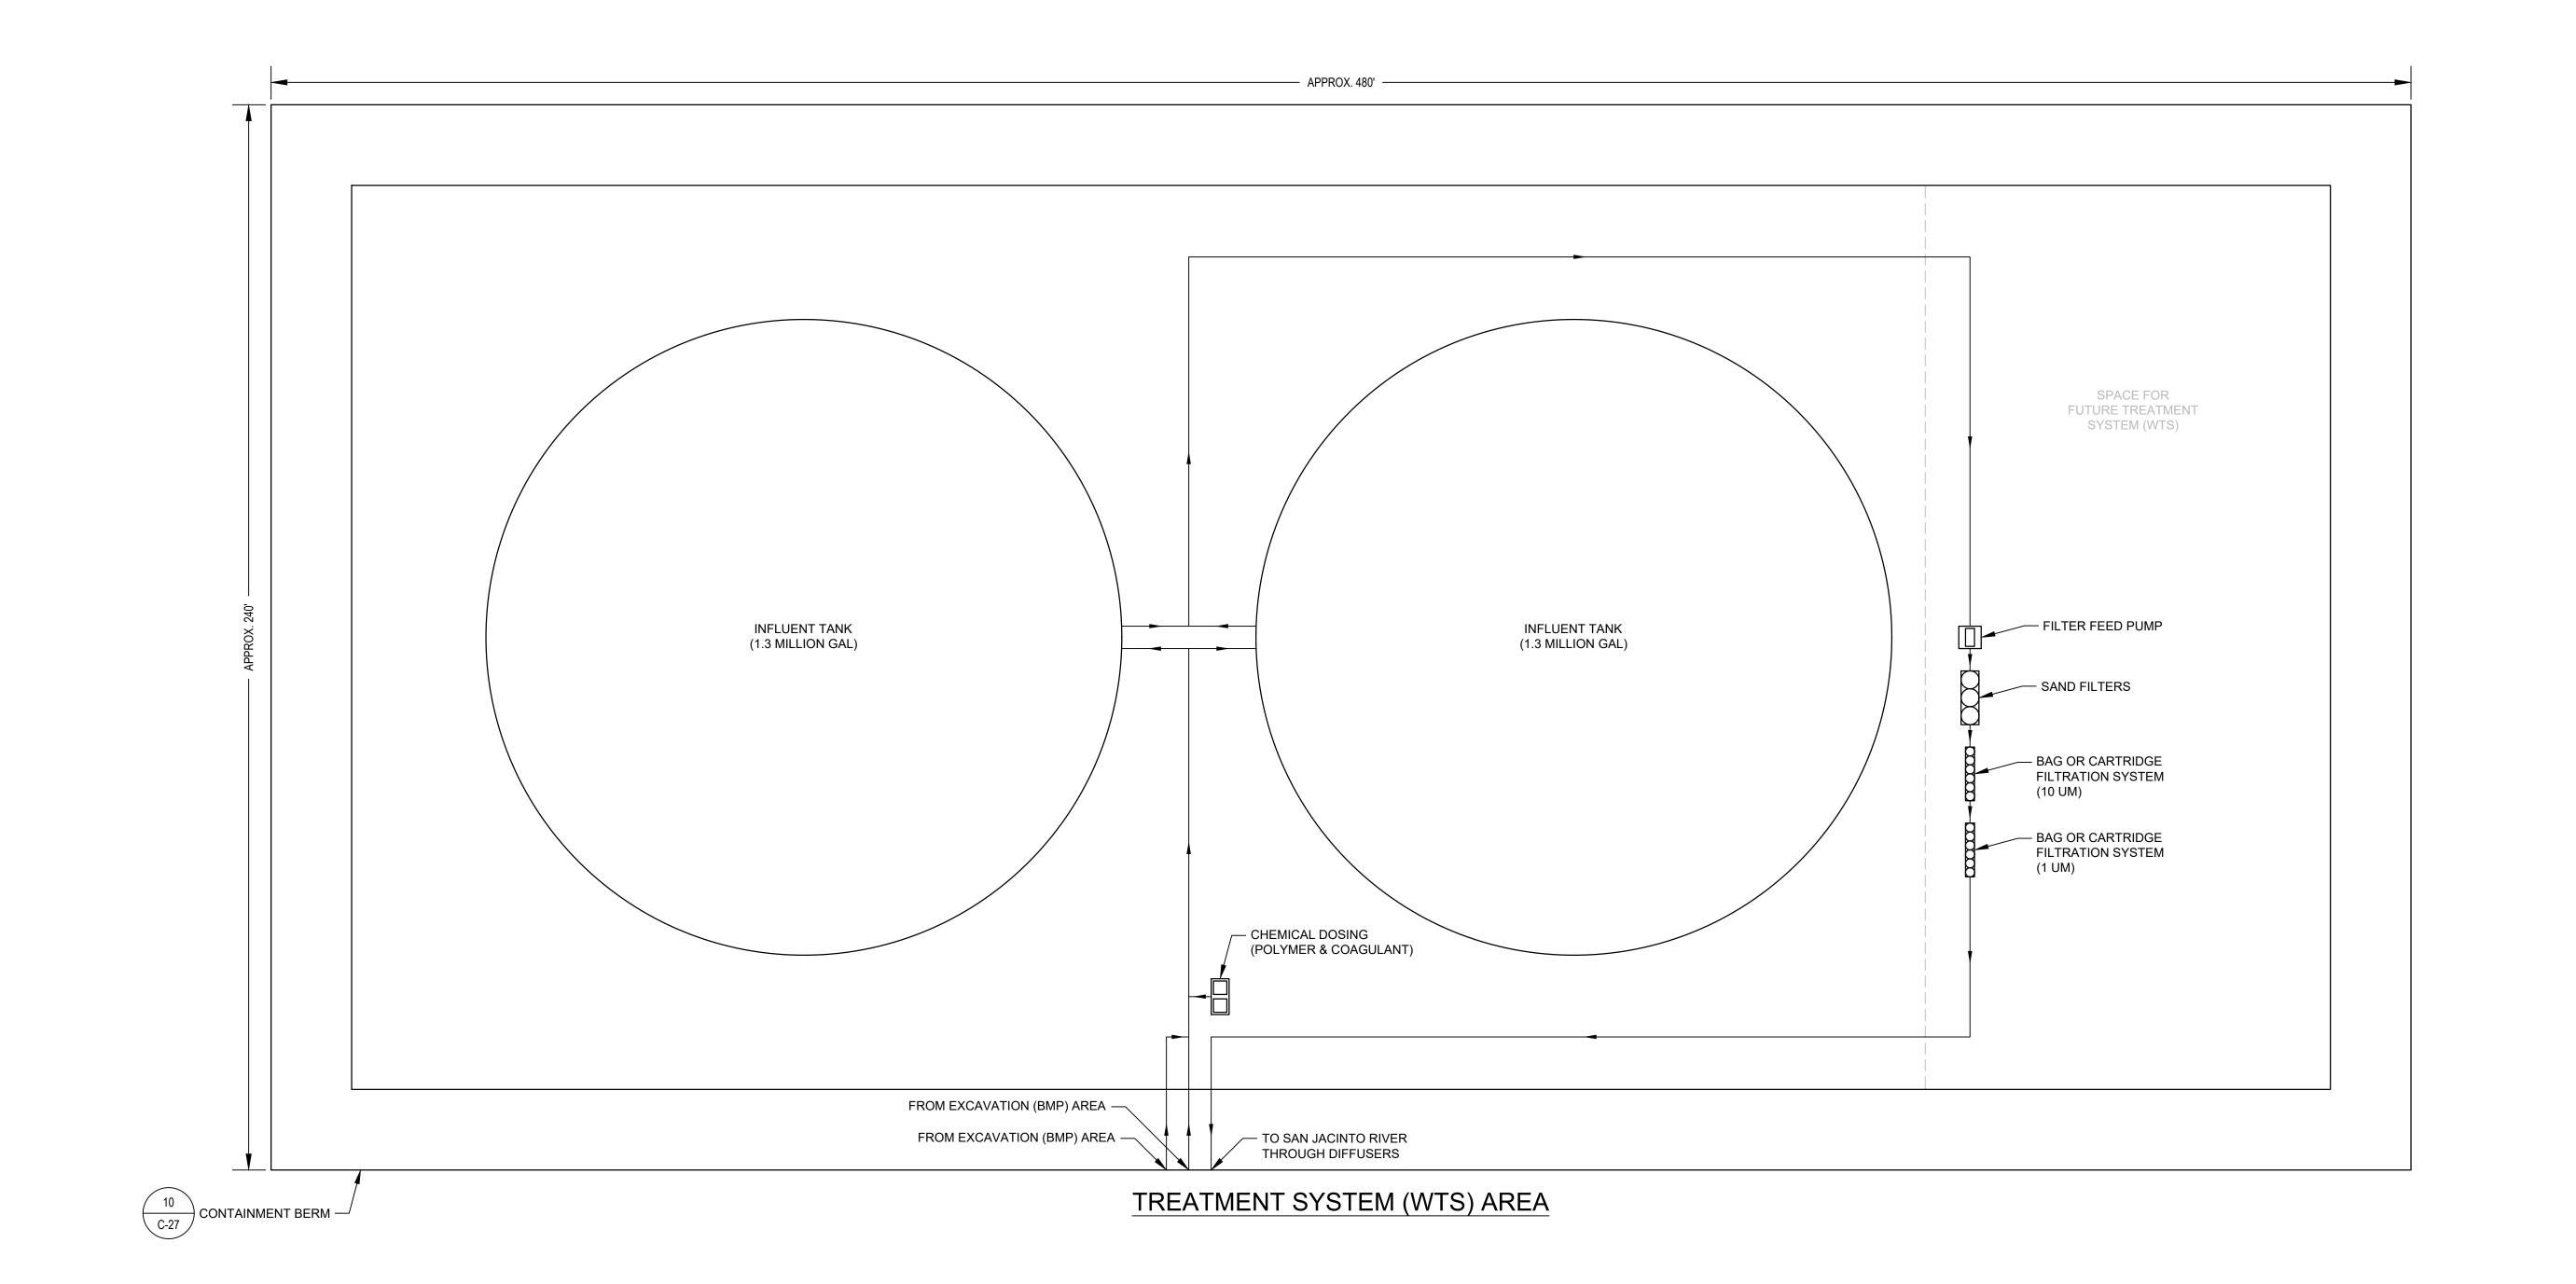

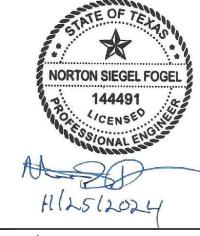

Reuse of Documents

This document and the ideas and designs incorporated herein, as an instrument of professional service, is the property of GHD and shall not be reused in whole or in part for any other project without GHD's written authorization. © 2024 GHD

### **SAN JACINTO RIVER WASTE PITS**

NORTHERN IMPOUNDMENT FINAL 100% REMEDIAL DESIGN HARRIS COUNTY, TEXAS

2	100% EPA SUBMITTAL	RH	NF	11/25	
1	FOR CLIENT REVIEW	RH	NF	11/21	
0	100% EPA SUBMITTAL	RH	NF	07/17	
No.	Issue	Drawn	Approved	Da	
Draw	n <b>RH</b>	Designer	NF		
Drafting Check		Design Check	NF		
Project Coordinator		Date	Novembe	r 25, 20	
This document shall not be used for construction unless signed and sealed for construction.		Scale	1" = 20'		
Origi	nal Size	В	ar is one in	ch on	

Project No. **11215702** 

Arch D

WATER TREATMENT SYSTEM **EQUIPMENT LAYOUT** (NON-CONTACT WATER)

Sheet No.

P-011

Sheet **77** of **83** 

Bar is one inch on original size drawing

GHD GHD SERVICES INC. JOB NO. 11215702 FILE NO. 001

GHD TEXAS FIRM REGISTRATION NO. 276

THIS DOCUMENT IS RELEASED FOR THE PURPOSE OF EPA REVIEW UNDER THE AUTHORITY OF NORTON

USED FOR CONSTRUCTION, BIDDING, RECORDATION,

FOGEL, P.E. 144491 ON 11/25/2024. IT IS NOT TO BE

CONVEYANCE OR SALES PURPOSES.


**100% EPA SUBMITTAL** 

Plot Date: 25 November 2024 - 3:10 PM

NOTES:

1. EQUIPMENT LAYOUTS ARE CONCEPTUAL ONLY AND ARE TO BE FINALIZED BY CONTRACTOR.

2. FOR CLARITY NOT ALL SYSTEM ELEMENTS (E.G. VALVES, PIPE SIZES, RETURN LINES) HAVE BEEN SHOWN.

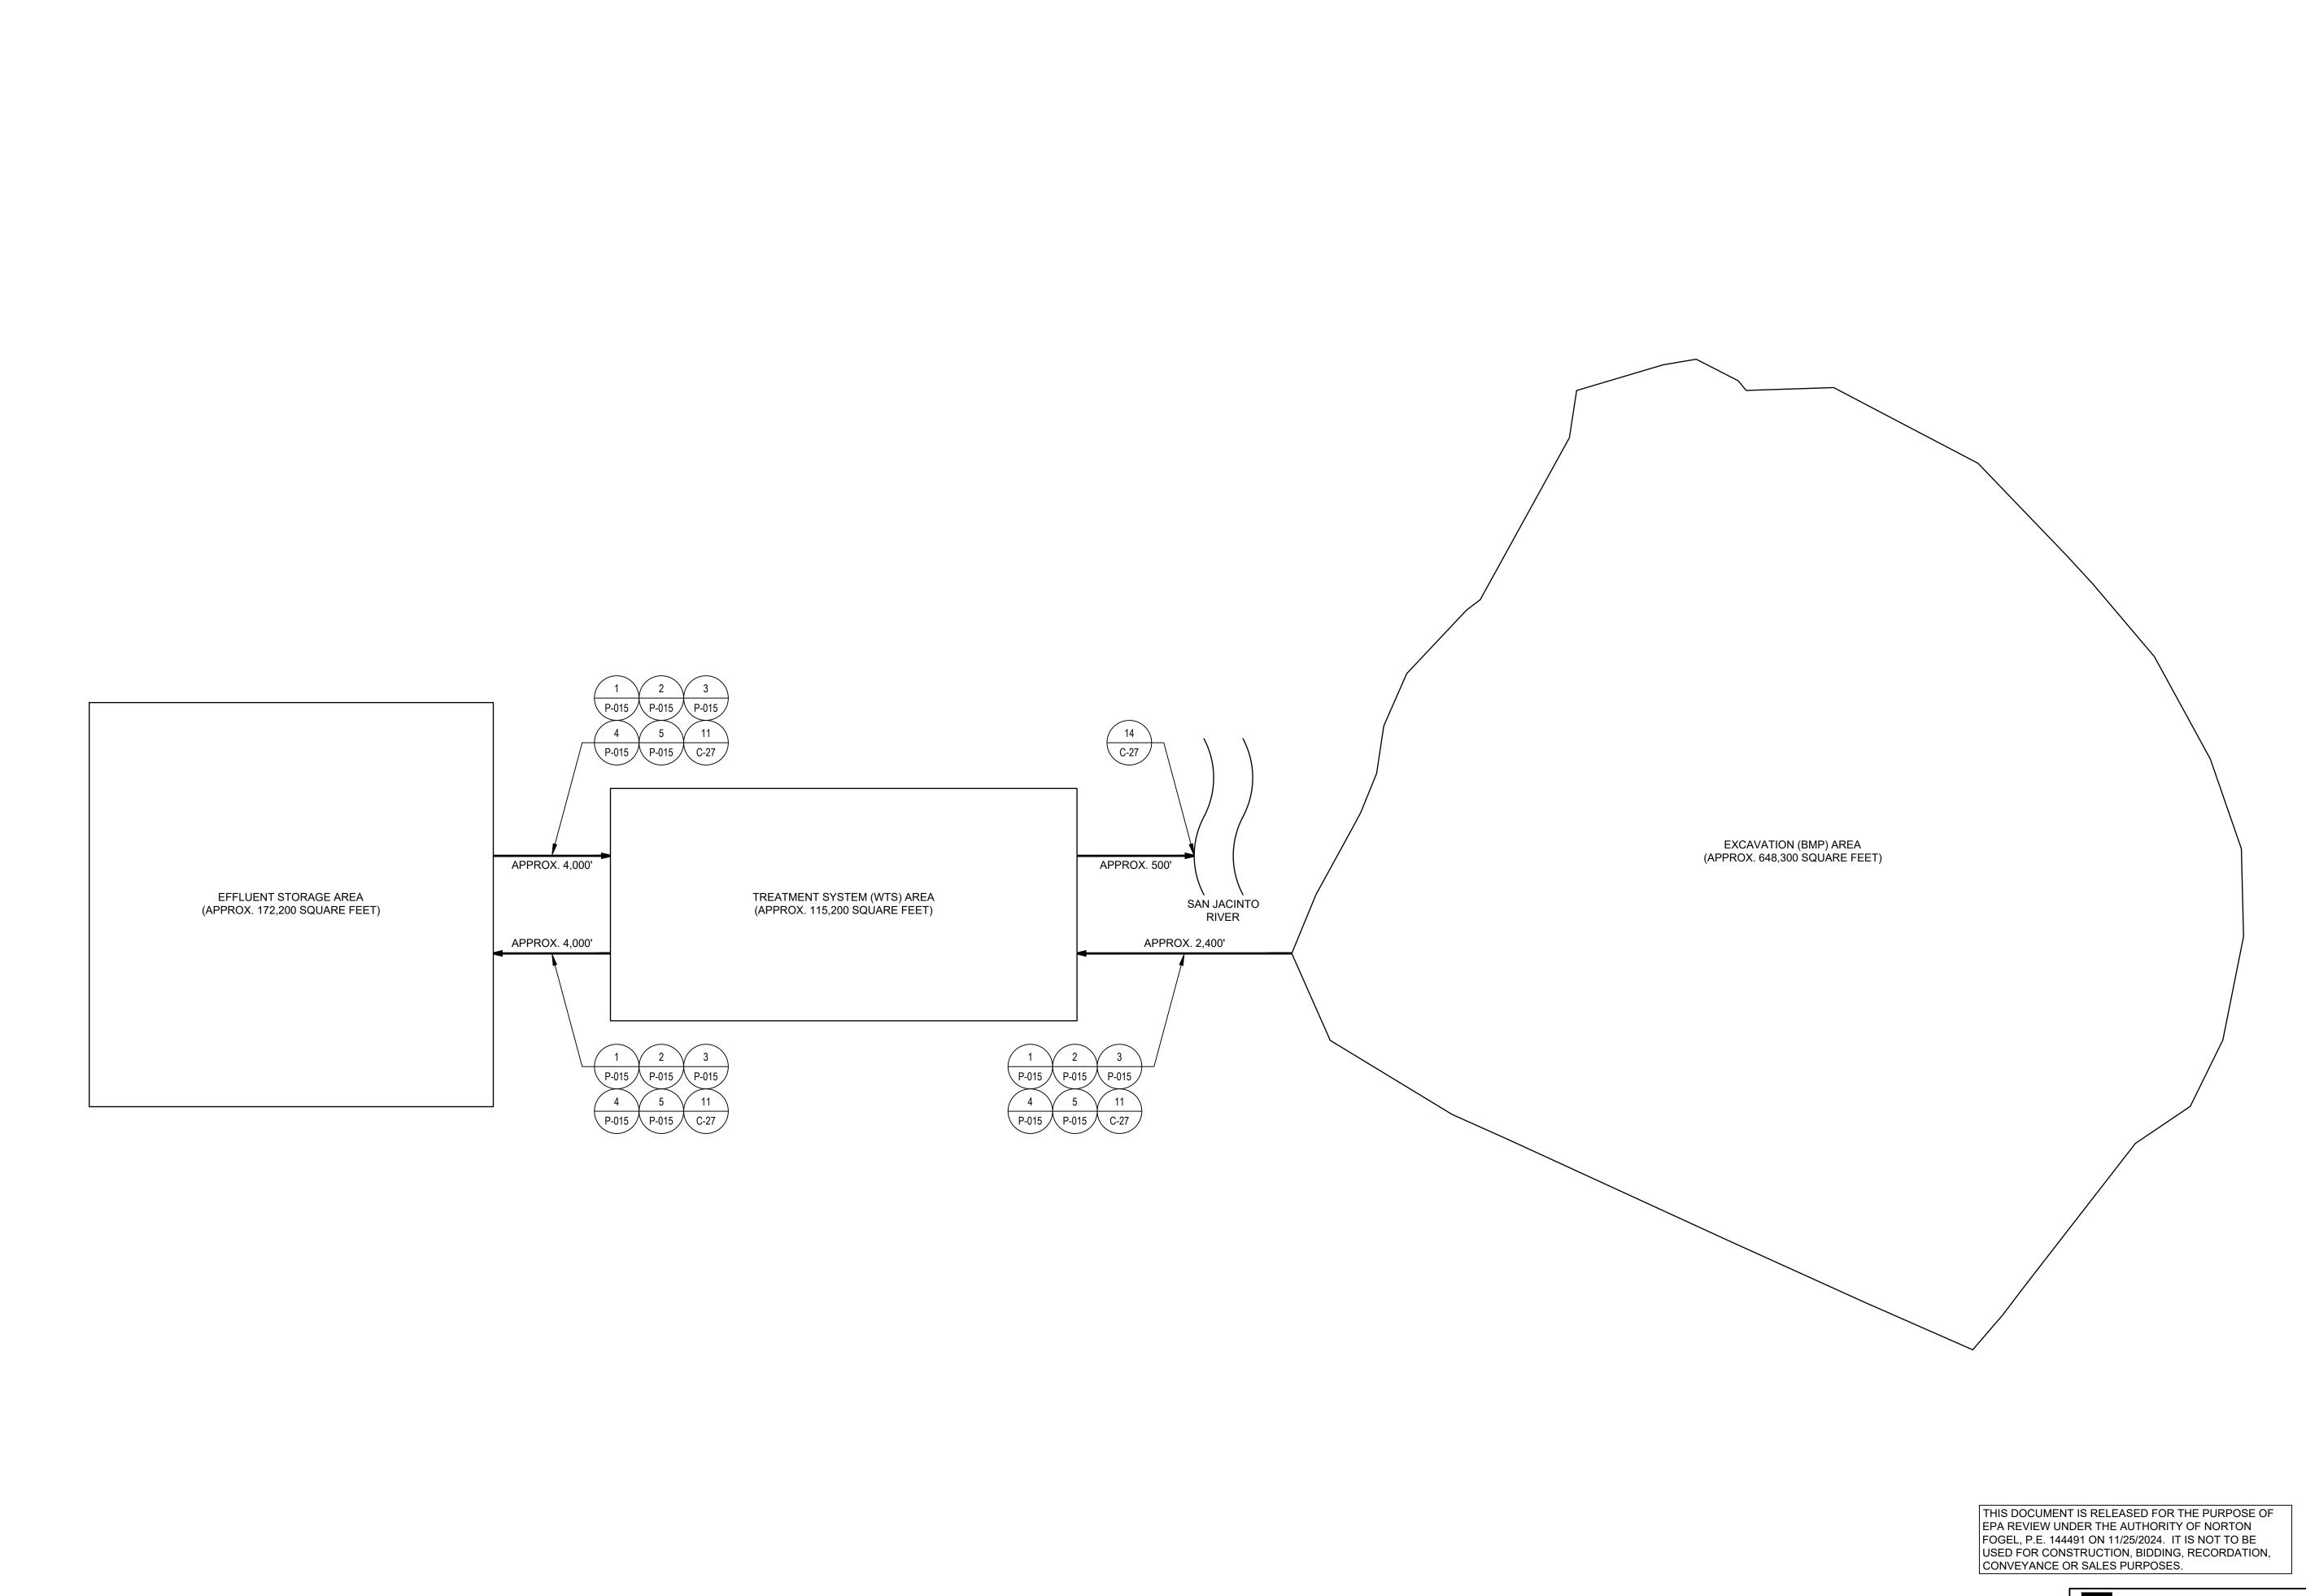



Reuse of Documents

This document and the ideas and designs incorporated herein, as an instrument of professional service, is the property of GHD and shall not be reused in whole or in part for any other project without GHD's written authorization. © 2024 GHD

### **SAN JACINTO RIVER WASTE PITS**

NORTHERN IMPOUNDMENT FINAL 100% REMEDIAL DESIGN HARRIS COUNTY, TEXAS

1					
1	3	100% EPA SUBMITTAL	RH	NF	11/25/202
1	2	FOR CLIENT REVIEW	RH	NF	11/21/202
1	1	100% EPA SUBMITTAL	RH	NF	07/17/202
1	No.	Issue	Drawn	Date	
	Draw	n <b>RH</b>	Designer	NF	
	Drafti Chec	•	Design Check	NF	
	Proje Coord	ct dinator	Date	Novembe	r 25, 2024
	constri	This document shall not be used for construction unless signed and sealed for construction.		N.T.S.	
1	Origin	nal Size	Е	Bar is one in	ch on
ı		Arch D	ori	iginal size d	Irawing 1"

Project No. **11215702** 

WATER TREATMENT SYSTEM SITE PLAN (CONTACT WATER)

Sheet No.

P-012

Sheet **78** of **83** 

GHD SERVICES INC.


JOB NO. 11215702 FILE NO. 001 GHD TEXAS FIRM REGISTRATION NO. 276


100% EPA SUBMITTAL

NOTES:

1. SITE PLANS ARE CONCEPTUAL ONLY AND ARE TO BE FINALIZED BY CONTRACTOR.

2. CONTRACTOR SHALL PROVIDE LEAK DETECTION AT LOW POINT ON ALL PIPELINES (SEE DETAIL 4/P-015). 3. CONTRACTOR SHALL INSTALL BIDIRECTIONAL CLEANOUTS EVERY 500' (MINIMUM) ON ALL PIPELINES.

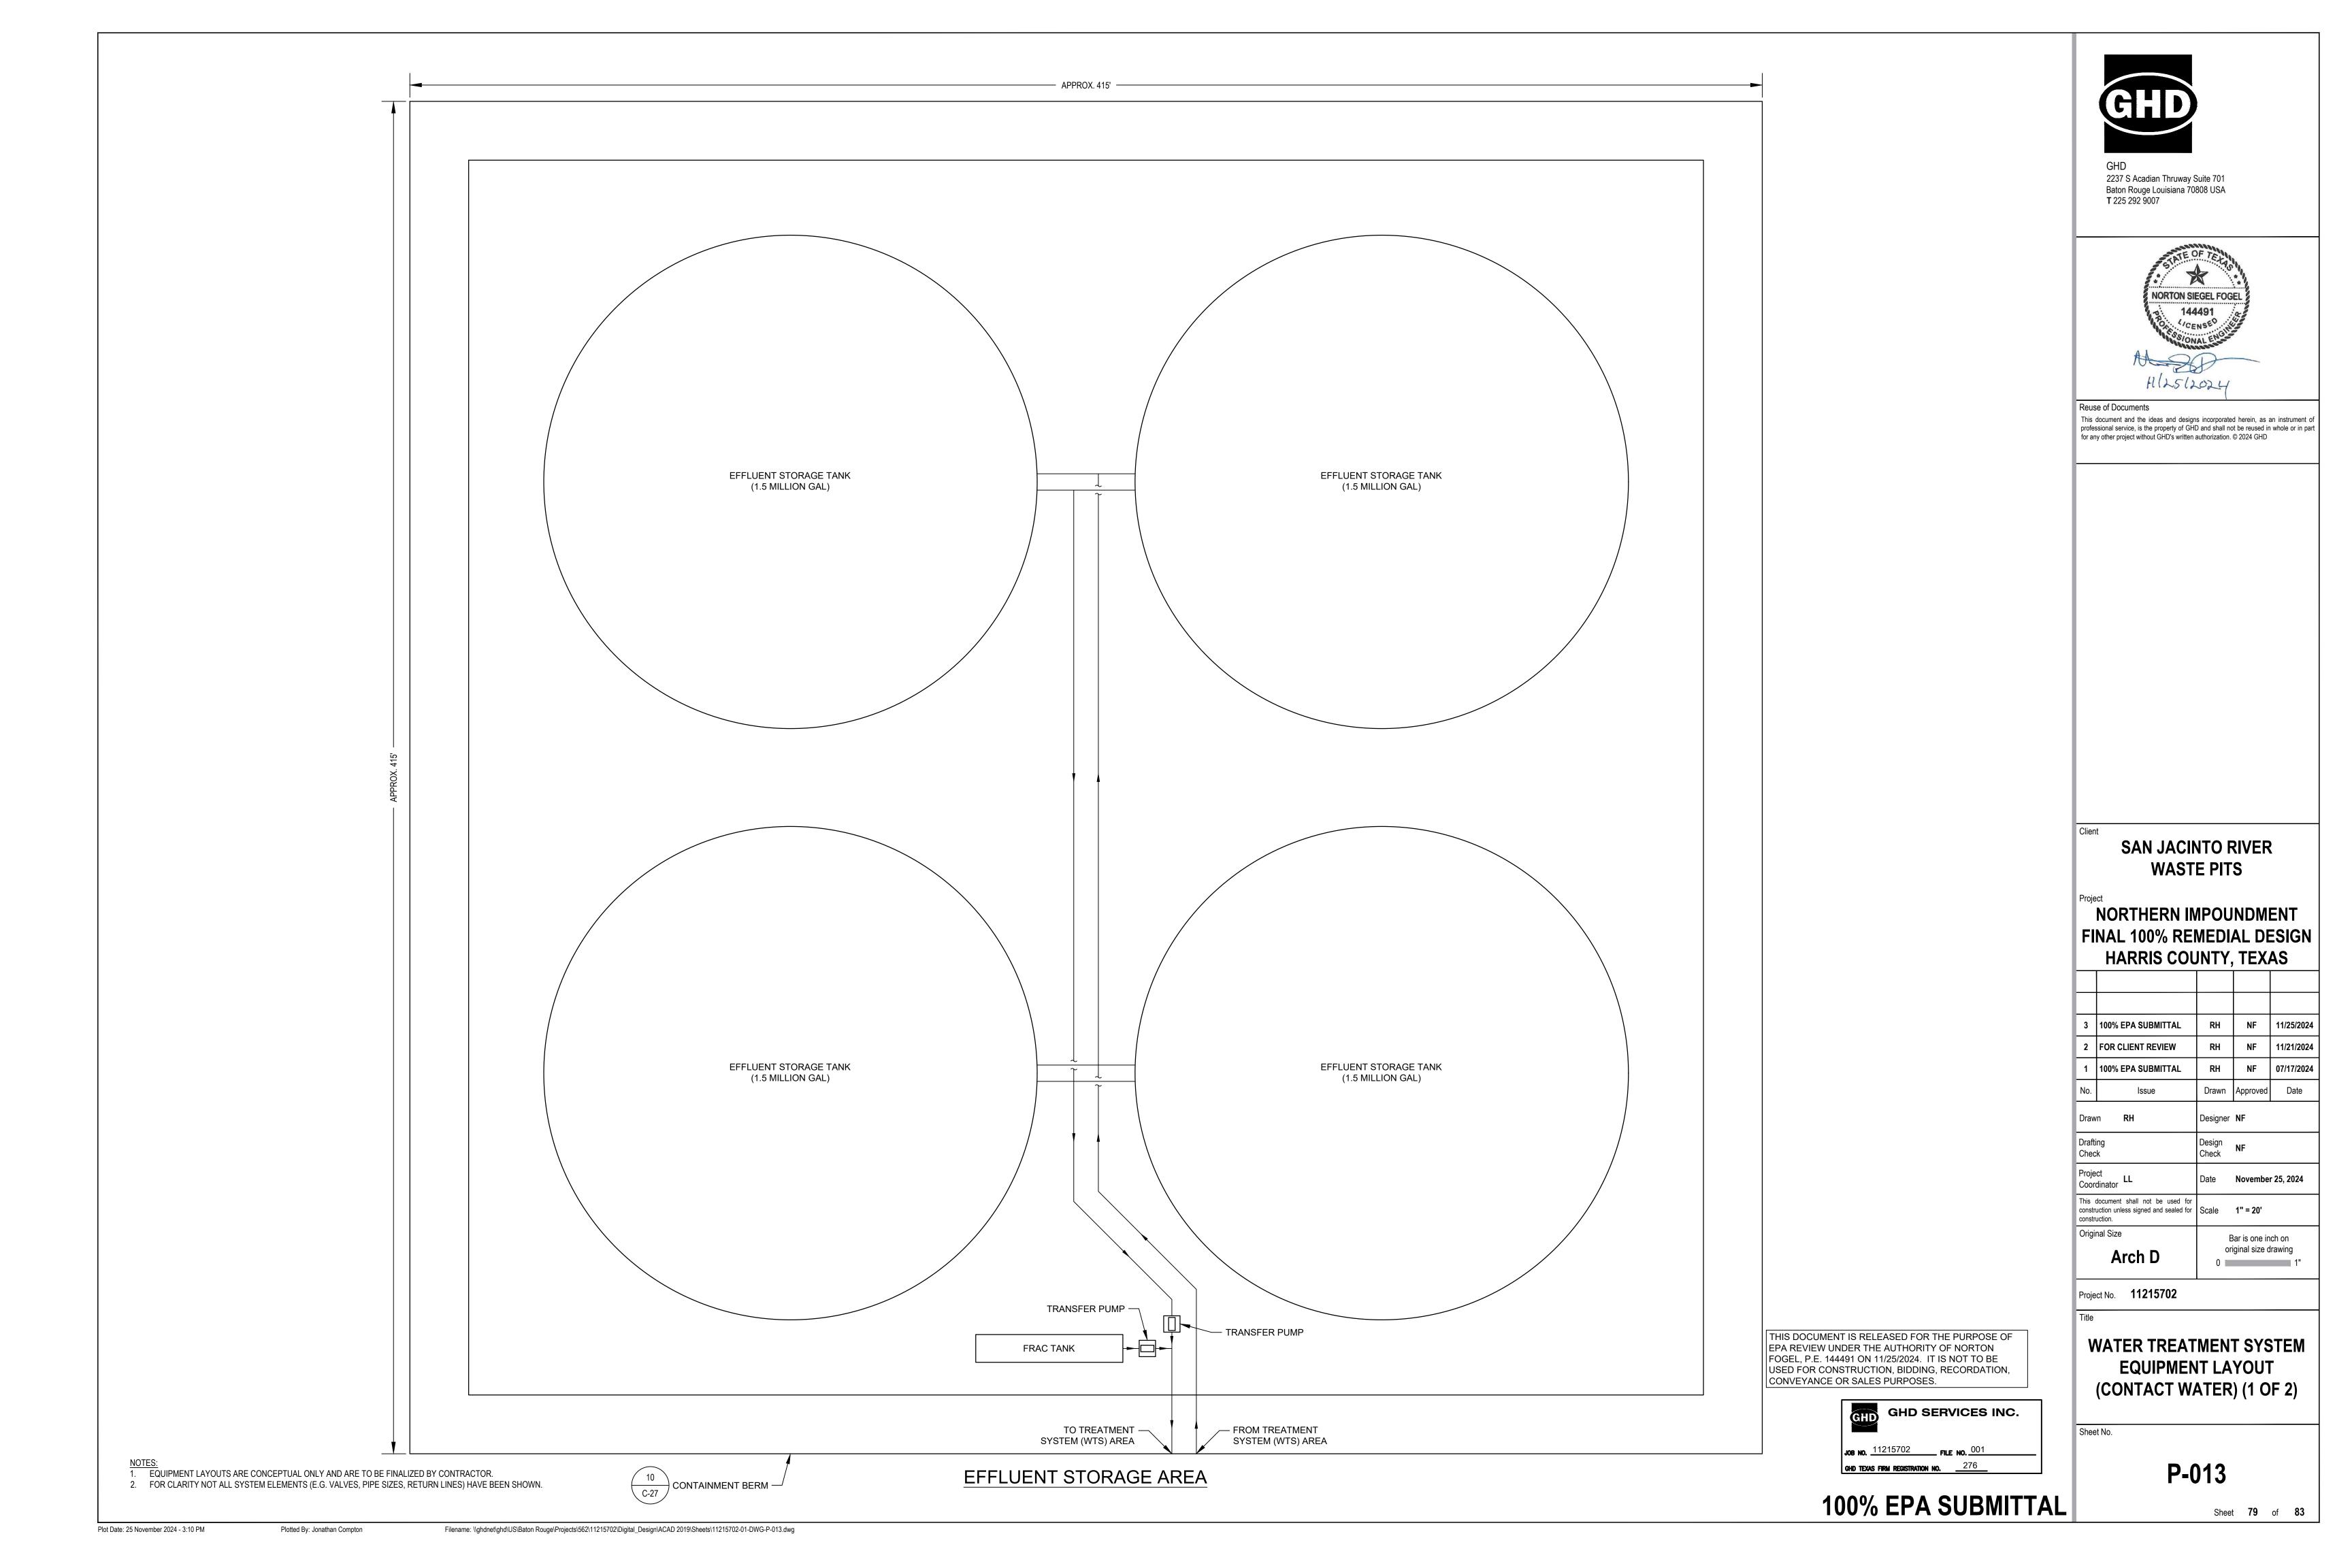

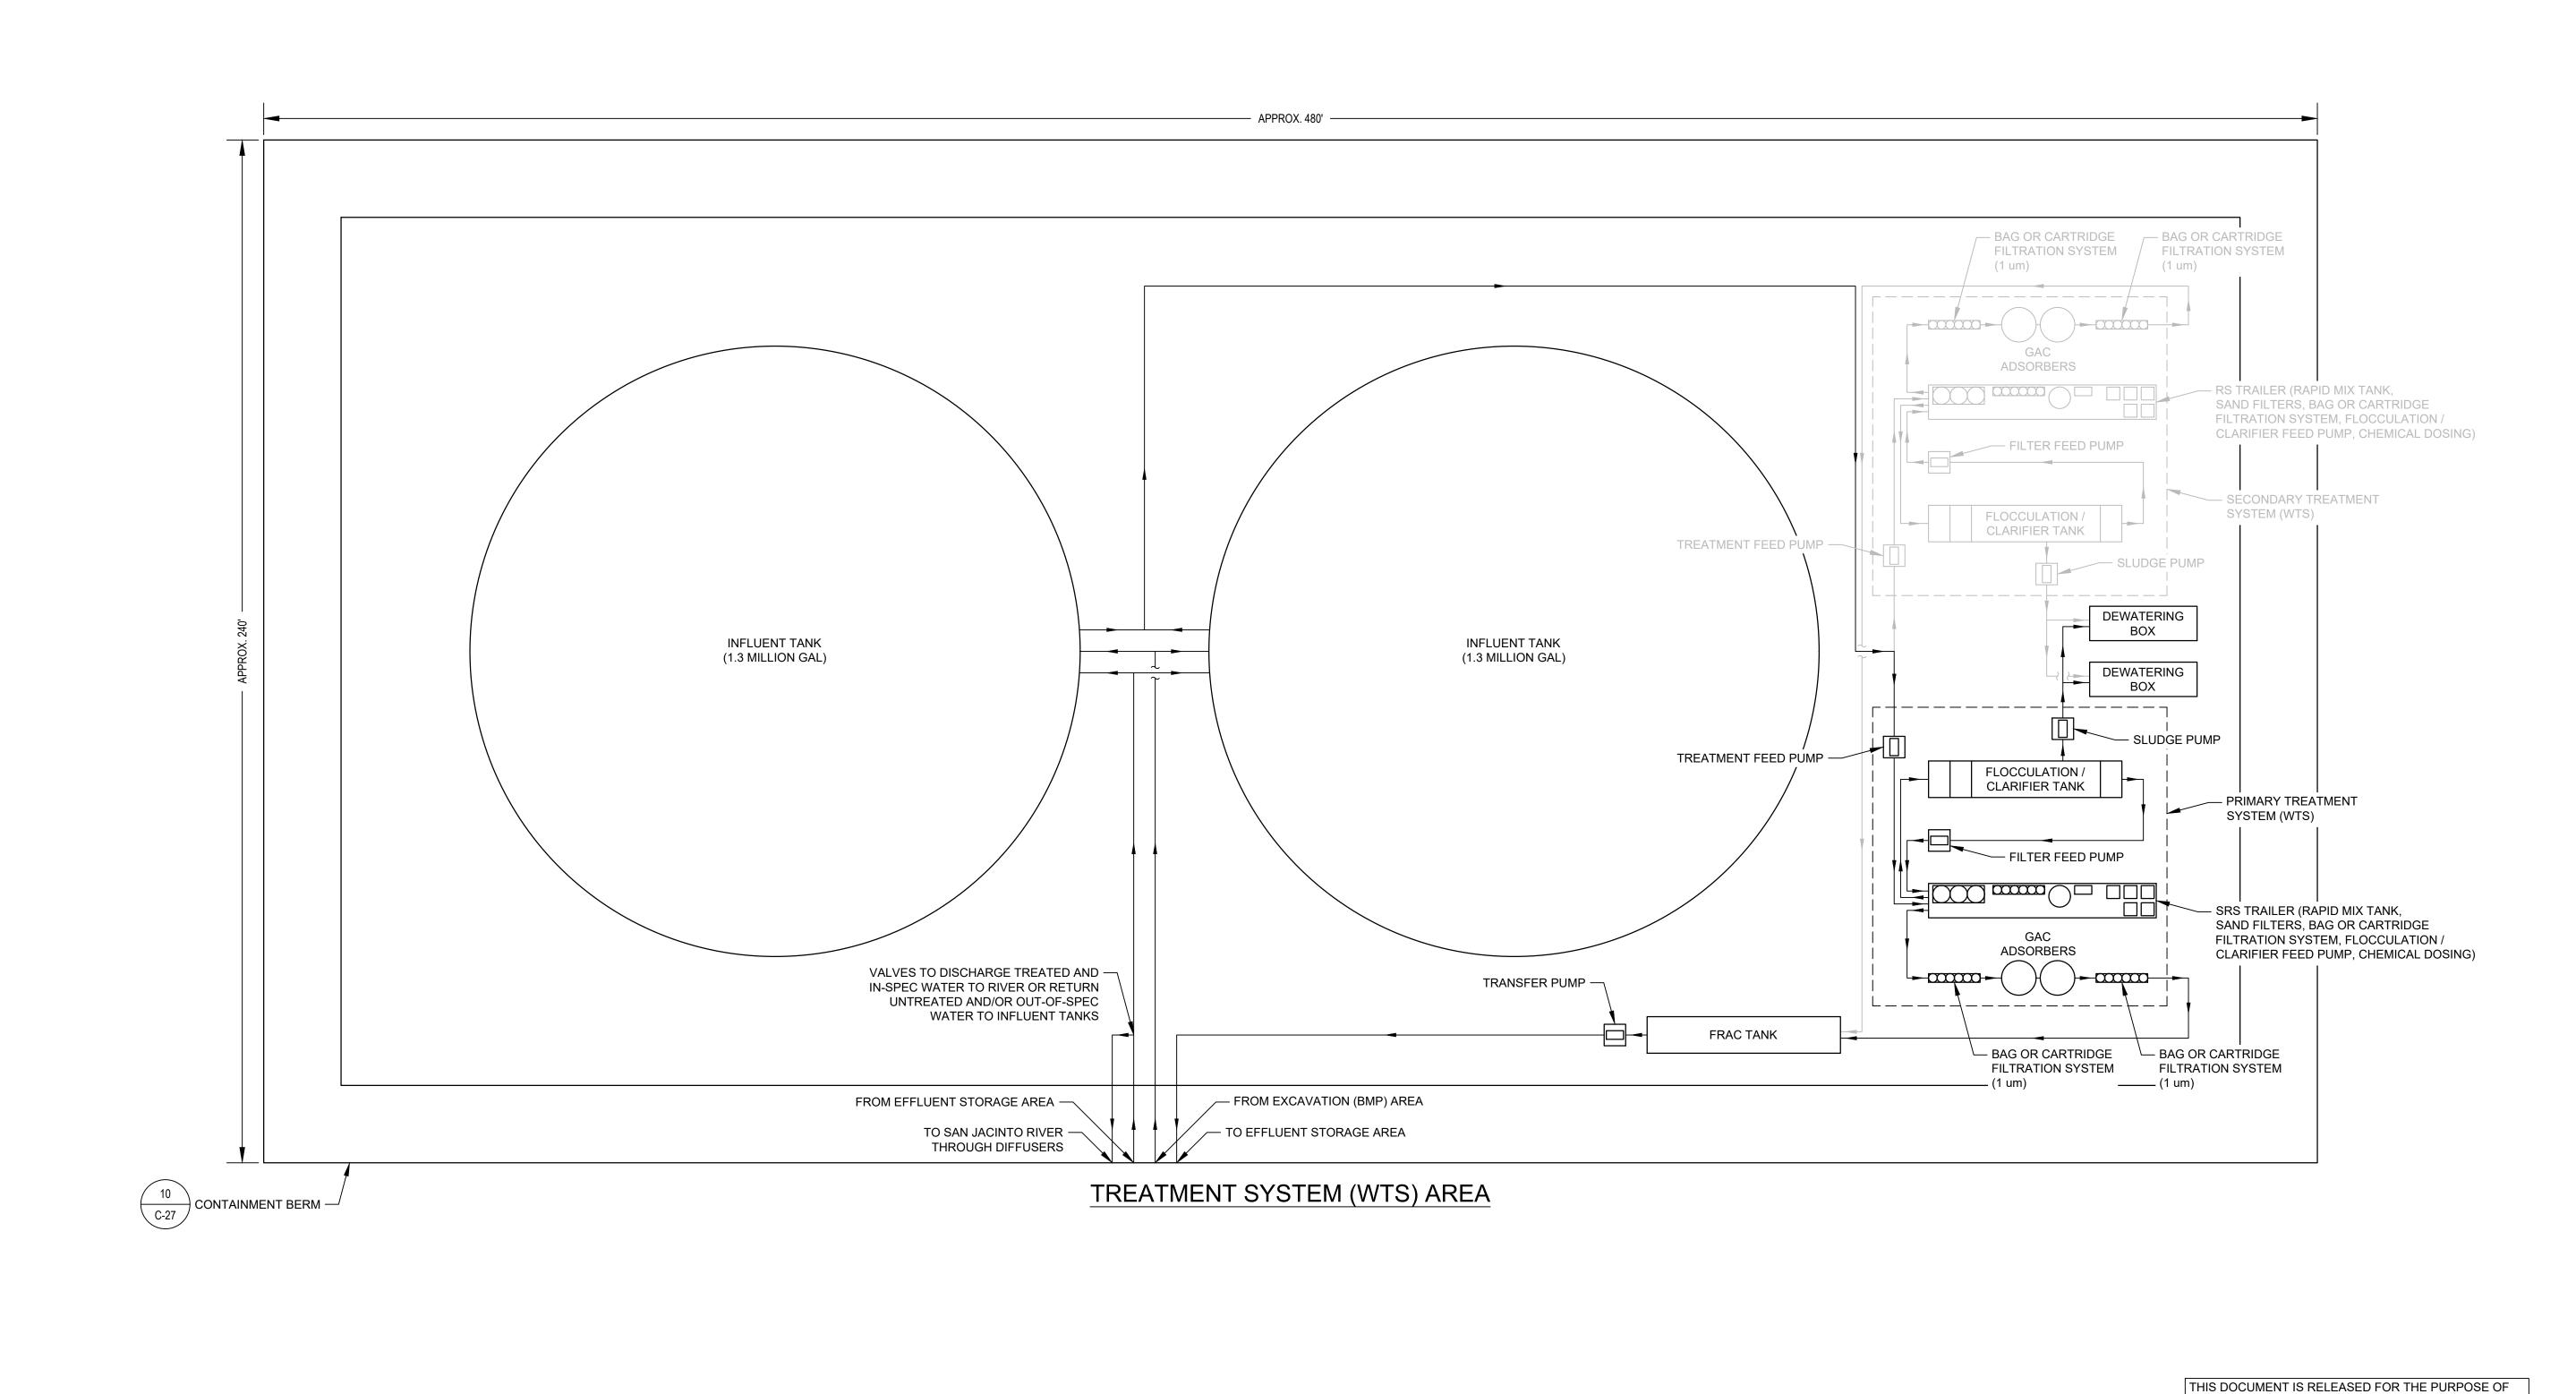

GHD

GHD
2237 S Acadian Thruway Suite 701
Baton Rouge Louisiana 70808 USA
T 225 292 9007



Reuse of Documents

This document and the ideas and designs incorporated herein, as an instrument of professional service, is the property of GHD and shall not be reused in whole or in part for any other project without GHD's written authorization. © 2024 GHD

SAN JACINTO RIVER
WASTE PITS

NORTHERN IMPOUNDMENT FINAL 100% REMEDIAL DESIGN HARRIS COUNTY, TEXAS

3	100% EPA SUBMITTAL	RH	NF 11/2		
2	FOR CLIENT REVIEW	RH	NF	11/21	
1	100% EPA SUBMITTAL	RH	NF	07/17	
No.	Issue	Drawn	Approved	Da	
Draw	n <b>RH</b>	Designer	NF		
Drafti Chec	•	Design Check	NF		
Project LL Coordinator		Date	November 25, 20		
	document shall not be used for uction unless signed and sealed for uction.	Scale	1" = 20'		
Origi	nal Size	В	ar is one in	ch on	

Project No. **11215702** 

Arch D

Title

WATER TREATMENT SYSTEM EQUIPMENT LAYOUT

(CONTACT WATER) (2 OF 2)

Sheet No.

P-014

Sheet **80** of **83** 

Bar is one inch on original size drawing

GHD SERVICES INC.

JOB NO.  $\frac{11215702}{}$  FILE NO.  $\frac{001}{}$ GHD TEXAS FIRM REGISTRATION NO.  $\frac{276}{}$ 

EPA REVIEW UNDER THE AUTHORITY OF NORTON FOGEL, P.E. 144491 ON 11/25/2024. IT IS NOT TO BE

CONVEYANCE OR SALES PURPOSES.


USED FOR CONSTRUCTION, BIDDING, RECORDATION,

2. FOR CLARITY NOT ALL SYSTEM ELEMENTS (E.G. VALVES, PIPE SIZES, RETURN LINES) HAVE BEEN SHOWN.


NOTES:

1. EQUIPMENT LAYOUTS ARE CONCEPTUAL ONLY AND ARE TO BE FINALIZED BY CONTRACTOR.


Plot Date: 25 November 2024 - 3:11 PM

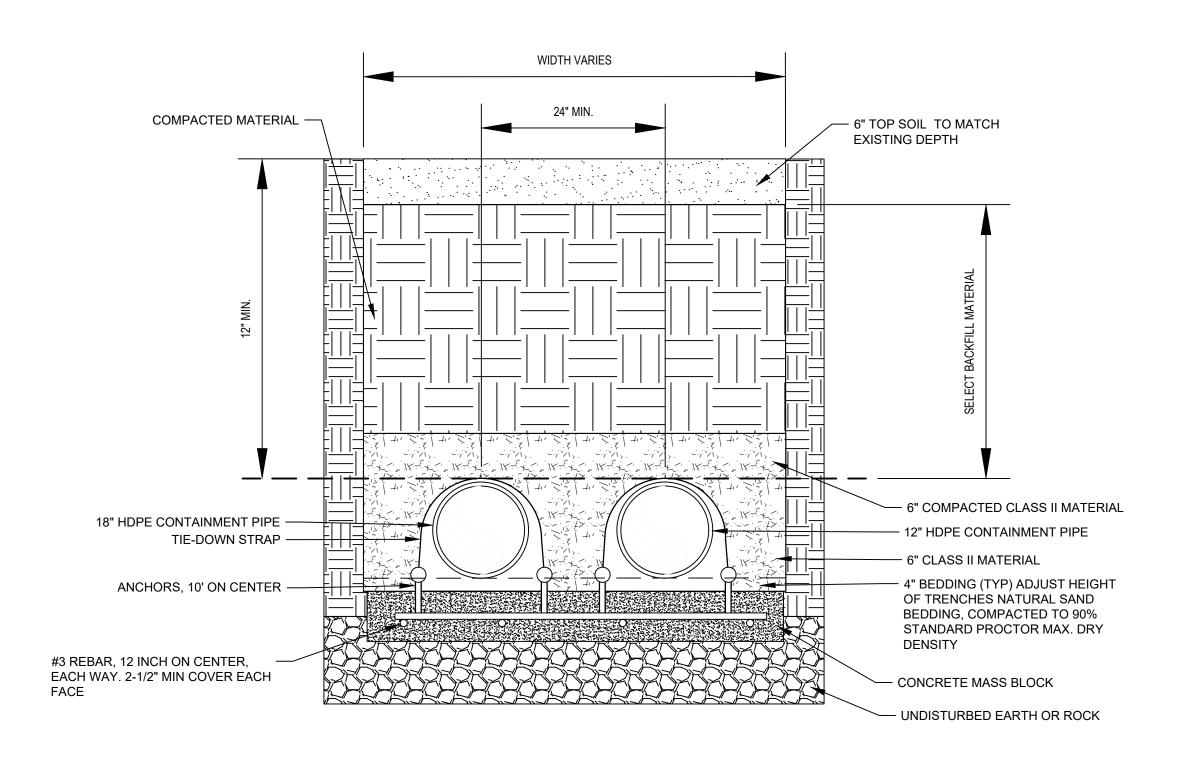




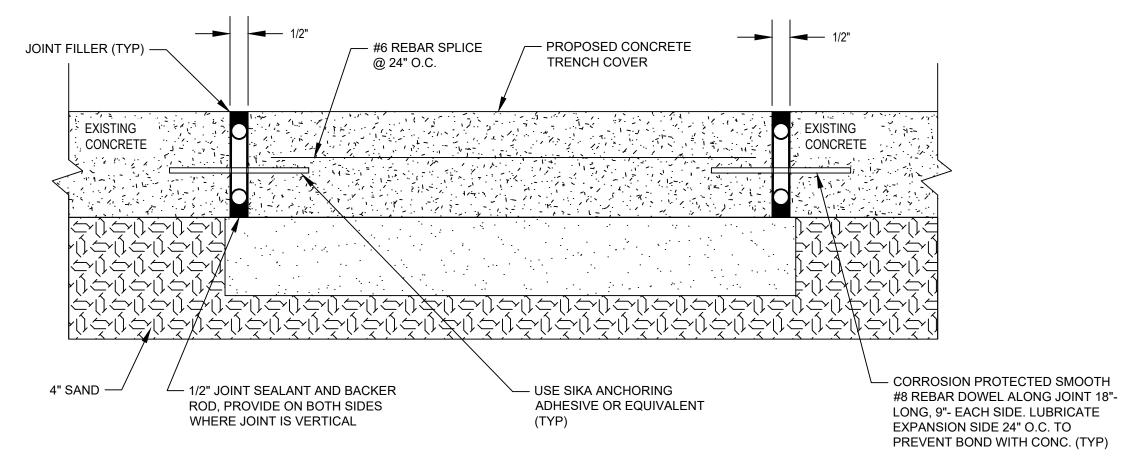


TRENCH COVER OVER RIGID PAVEMENT **DETAIL** SCALE: NTS

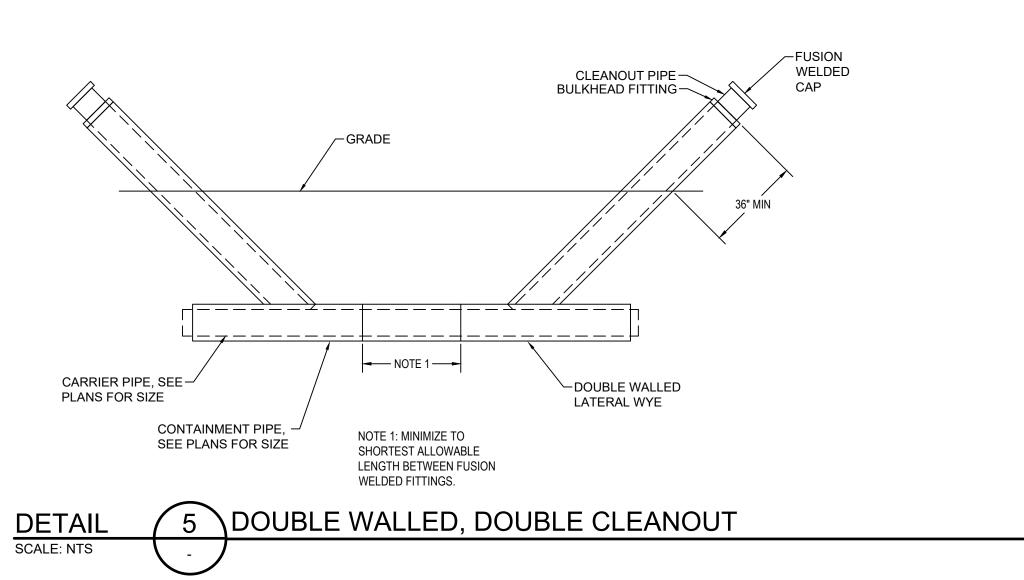

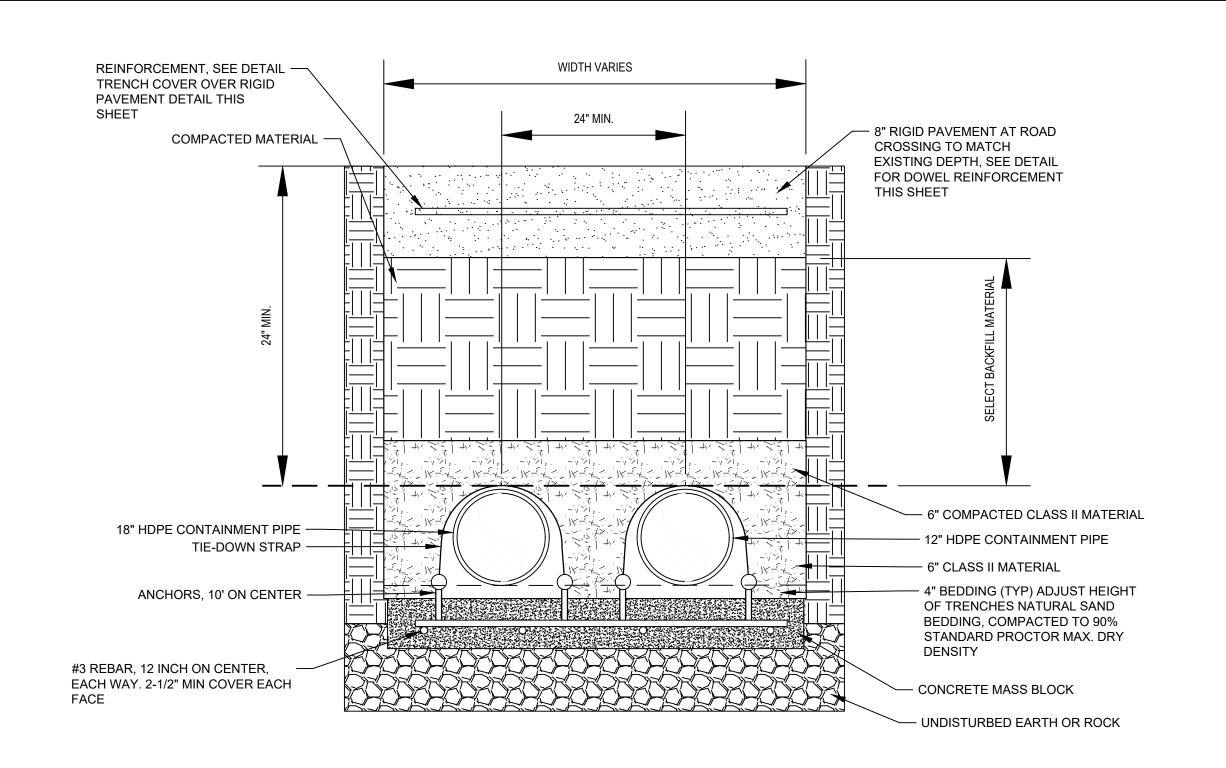

\UTILITY TRENCH - RIGID PAVEMENT OR ROADWAY SURFACE

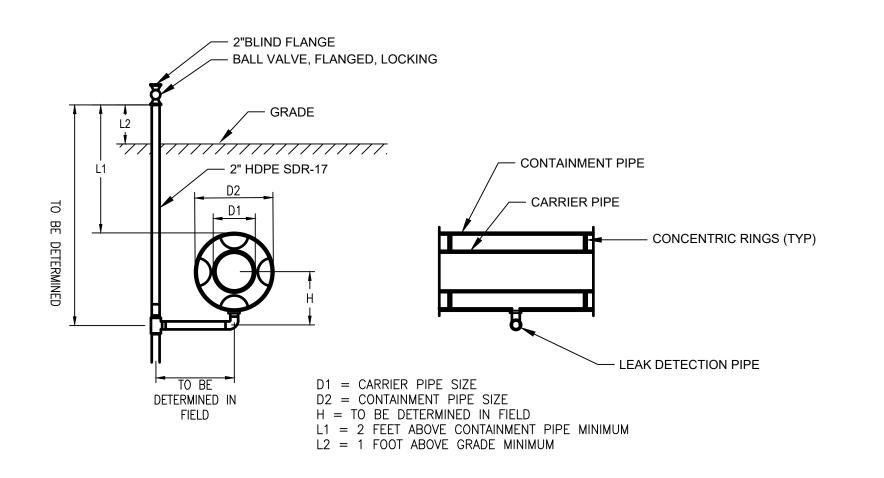

1. FOR ABOVE GROUND INSTALLATIONS, 2" PIPE MUST BE ABOVE GRADE AND CLEAR OF SUPPORTS TO AVOID DAMAGE FROM THERMAL



THIS DOCUMENT IS RELEASED FOR THE PURPOSE OF EPA REVIEW UNDER THE AUTHORITY OF NORTON FOGEL, P.E. 144491 ON 11/25/2024. IT IS NOT TO BE USED FOR CONSTRUCTION, BIDDING, RECORDATION, CONVEYANCE OR SALES PURPOSES.



**100% EPA SUBMITTAL** 



2237 S Acadian Thruway Suite 701 Baton Rouge Louisiana 70808 USA **T** 225 292 9007



Reuse of Documents This document and the ideas and designs incorporated herein, as an instrument of professional service, is the property of GHD and shall not be reused in whole or in part

for any other project without GHD's written authorization. © 2024 GHD

Client **SAN JACINTO RIVER WASTE PITS** 

NORTHERN IMPOUNDMENT FINAL 100% REMEDIAL DESIGN HARRIS COUNTY, TEXAS

3	100% EPA SUBMITTAL	EAW	NF	11/25/20
2	2 FOR CLIENT REVIEW		NF	11/21/20
1	100% EPA SUBMITTAL	EAW	NF	07/17/20
No.	Issue	Drawn	Approved	Date
Draw	n <b>EAW</b>	Designer	WSK	
Drafti Chec	•	Design Check	WSK	
Project Coordinator <b>CM</b>		Date	Novembe	r 25, 2024
This document shall not be used for construction unless signed and sealed for construction.		Scale	AS SHOW	/N

Project No. **11215702** 

Arch D

Original Size

**MECHANICAL** 


**DETAILS 1 OF 1** 


Sheet No.

P-015

Sheet **81** of **83** 

Bar is one inch on original size drawing

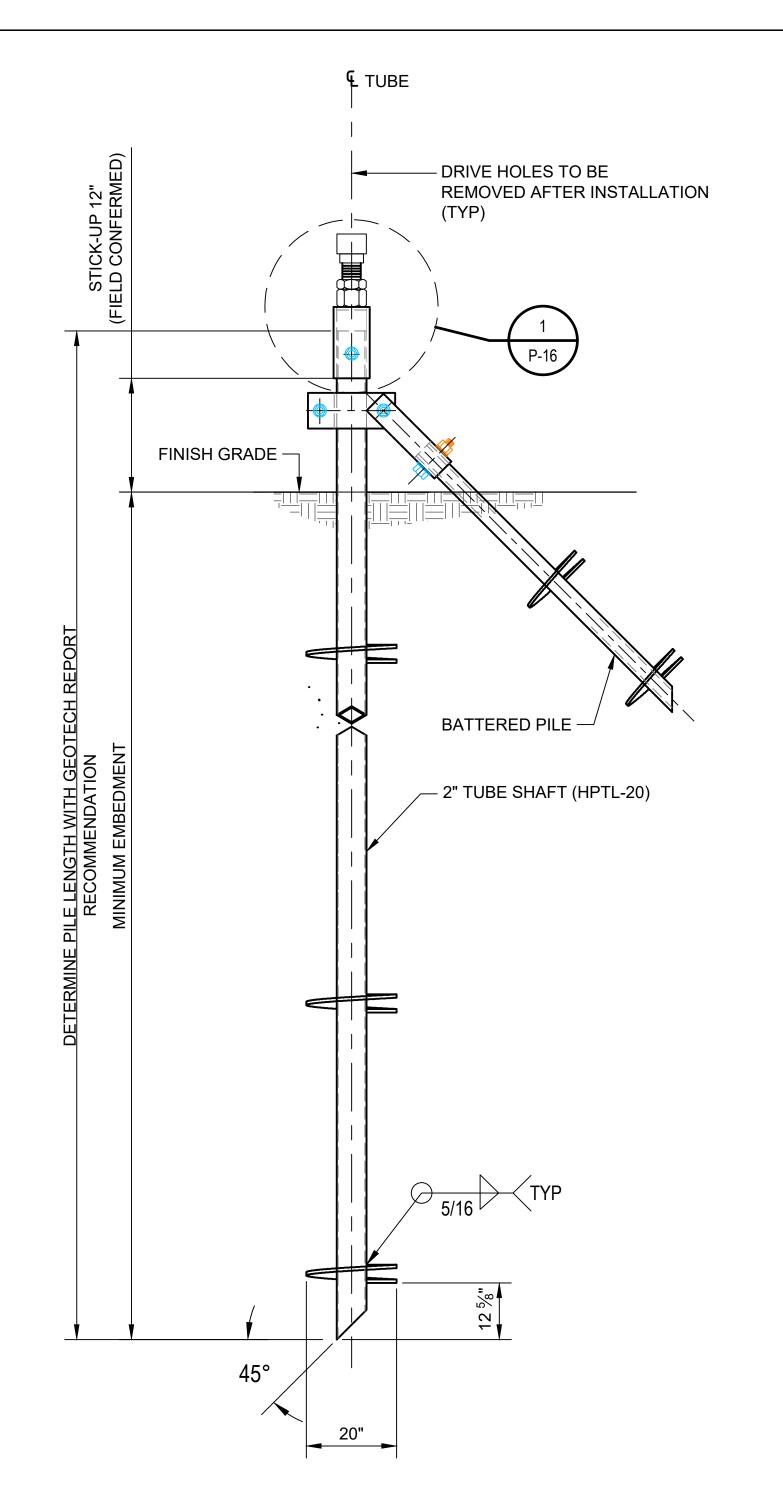

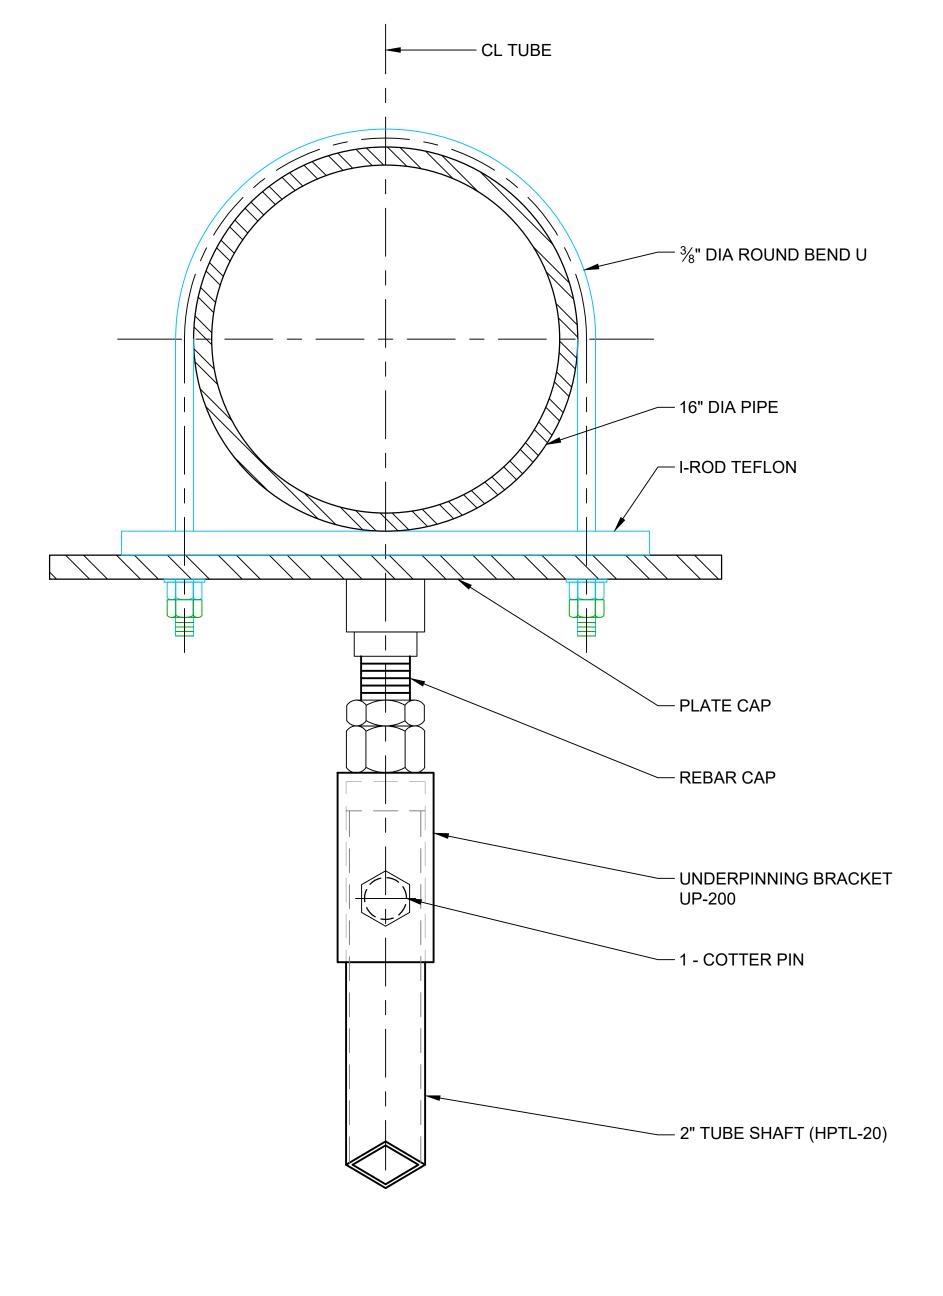

HELICAL COMPOSITE PILE HPTL-20

**DETAIL** SCALE: NTS P-16

PIPE SUPPORT BRAKET FOR 16" PIPE

#### NOTES:

- 1. CONTRACTOR TO SUB-CONTRACT GEOTECH ENGINEER LICENSE IN THE STATE OF TEXAS FOR THE DESIGN OF PIPE SUPPORTS.
- DESIGN CRITERIA

BASIC WIND SPEED, V: 143 mph WIND EXPOSURE:

PIPE WEIGHT: 135 bl/ft (ASSUMING 16" STEEL SCH 40

SHELL / 12" HDPE SDR 7)

- USE BATTERED PILE AT EACH END OF THE PIPE RUN WITH A MAXIMUM OF 100 FT SPACING FOR BATTERED PILES.
- 4. HARDWARE TO BE HELI-PILE OR APROVED EQUAL.

CONTACT: **HELI-PILE** 

A: 5135 WARD ROAD

WHEATRIDGE, CO 80033

P: 303-423-0591

W: https://helipile.com

2237 S Acadian Thruway Suite 701 Baton Rouge Louisiana 70808 USA **T** 225 292 9007



Reuse of Documents

This document and the ideas and designs incorporated herein, as an instrument of professional service, is the property of GHD and shall not be reused in whole or in part for any other project without GHD's written authorization. © 2024 GHD

**SAN JACINTO RIVER WASTE PITS** 

NORTHERN IMPOUNDMENT FINAL 100% REMEDIAL DESIGN HARRIS COUNTY, TEXAS

5	100% EPA SUBMITTAL	AL	SC	11/25/2024
4	FOR CLIENT REVIEW AL		SC	11/21/2024
3	100% EPA REVIEW	AL	SC	07/17/2024
2	90% EPA REVIEW	DS	SC	06/27/2022
No.	Issue	Drawn	Approved	Date
Draw	vn <b>AL</b>	Designer	TN	
Draft Chec	•	Design Check	· ·	
	Project CM Coordinator		Nov 25, 2024	
This document shall not be used for construction unless signed and sealed for construction		Scale	AS SHOW	/N

Arch D

Project No. **11215702** 

Original Size

**HELICAL PILE DETAILS** 


Sheet No.

P-016

Sheet **82** of **83** 

Bar is one inch on original size drawing

THIS DOCUMENT IS RELEASED FOR THE PURPOSE OF EPA REVIEW UNDER THE AUTHORITY OF SATISH CHILKA, P.E. 145120 ON 11/25/2024. IT IS NOT TO BE USED FOR CONSTRUCTION, BIDDING, RECORDATION, CONVEYANCE OR SALES PURPOSES.

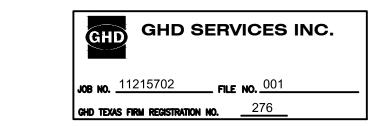

Plot Date: 25 November 2024 - 3:12 PM

**DETAIL** 

SCALE: NTS

P-16

		PUM	IP SCH	HEDUL	.E					
		CAPA	ACITY		ELECT	RICITY		POTENTIAL	MODEL	REMARKS
PUMP NO.	SERVICE	FLOW (GPM)		KW	HP	VOLTS	PHASE MANUFACTUREER	VENDOR		
P-3001	FILTER FEED (NON-CONTACT WATER)	4,000						TREATMENT VENDOR		
P-3002A	EXCAVATION (BMP) AREA DEWATERING TO INFLUENT TANK	2,000	90					RAIN FOR RENT	DV-200C	
P-3002B	EXCAVATION (BMP) AREA DEWATERING TO INFLUENT TANK	2,000	90					RAIN FOR RENT	DV-200C	
P-6001	TREATMENT FEED	300						TREATMENT VENDOR		
P-6002	EFFLUENT STORAGE AREA FRAC TANK TO INFLUENT TANKS	600	208					RAIN FOR RENT	HH-125C	
P-6003	EFFLUENT STORAGE AREA SUMP TO EFFLUENT STORAGE AREA FRAC TANK	200	9					RAIN FOR RENT	DV-80M	
P-6004	TREATMENT SYSTEM (WTS) AREA SUMP TO INFLUENT TANK	200	24					RAIN FOR RENT	DV-80M	
P-6005	EXCAVATION (BMP) AREA DEWATERING TO INFLUENT TANK	2,000	90					RAIN FOR RENT	DV-200C	
P-7001	FLOCCULATION / CLARIFIER FEED	300						TREATMENT VENDOR		
P-7002	FILTER FEED (CONTACT WATER)	300						TREATMENT VENDOR		
P-7003	CLARIFIER SLUDGE							TREATMENT VENDOR		
P-8001	TREATMENT SYSTEM (WTS) AREA FRAC TANK TO EFFLUENT STORAGE TANKS	1,000	140					RAIN FOR RENT	DV-150I	
P-8002	EFFLUENT STORAGE TANKS TO DIFFUSER OR INFLUENT TANKS	1,000	64					RAIN FOR RENT	DV-200C	





Reuse of Documents

This document and the ideas and designs incorporated herein, as an instrument of professional service, is the property of GHD and shall not be reused in whole or in part for any other project without GHD's written authorization. © 2024 GHD

SAN JACINTO RIVER

# WASTE PITS

NORTHERN IMPOUNDMENT FINAL 100% REMEDIAL DESIGN HARRIS COUNTY, TEXAS

3	100% EPA SUBMITTAL	EAW	NF	11/25/2024	
2	FOR CLIENT REVIEW	EAW	NF	11/21/2024	
1	100% EPA SUBMITTAL	EAW	07/17/2024		
No.	Issue	Drawn	Date		
Draw	n <b>EAW</b>	Designer <b>WSK</b>			
Drafti Chec	<u> </u>	Design Check	WSK		
Proje Coor	ct dinator <b>CM</b>	Date	Novembe	r 25, 2024	
	document shall not be used for uction unless signed and sealed for uction.	Scale	e AS SHOWN		
Origi	nal Size	В	ar is one in	ch on	
Arch D		ori 0	ginal size d	lrawing 1"	

Project No. 11215702

Title

MECHANICAL SCHEDULE

Sheet No.

P-017

Sheet **83** of **83** 

THIS DOCUMENT IS RELEASED FOR THE PURPOSE OF EPA REVIEW UNDER THE AUTHORITY OF NORTON FOGEL, P.E. 144491 ON 11/25/2024. IT IS NOT TO BE USED FOR CONSTRUCTION, BIDDING, RECORDATION, CONVEYANCE OR SALES PURPOSES.



Plot Date: 25 November 2024 - 3:12 PM