
Appendix G


Design Drawing Package

SAN JACINTO RIVER WASTE PITS NORTHERN IMPOUNDMENT PRE-FINAL 90% REMEDIAL DESIGN HARRIS COUNTY, TEXAS


JUNE 2022 11215702

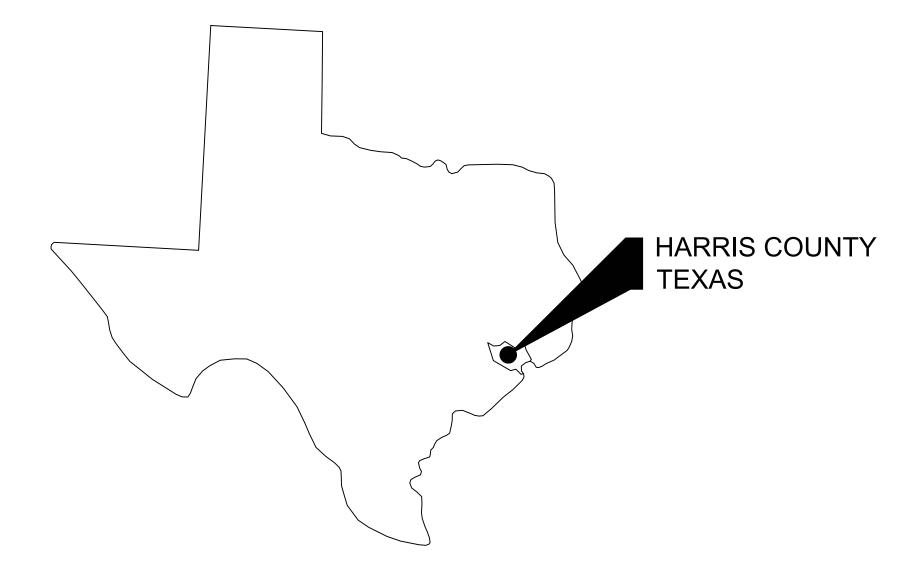

STATE OF TEXAS **VICINITY MAP**

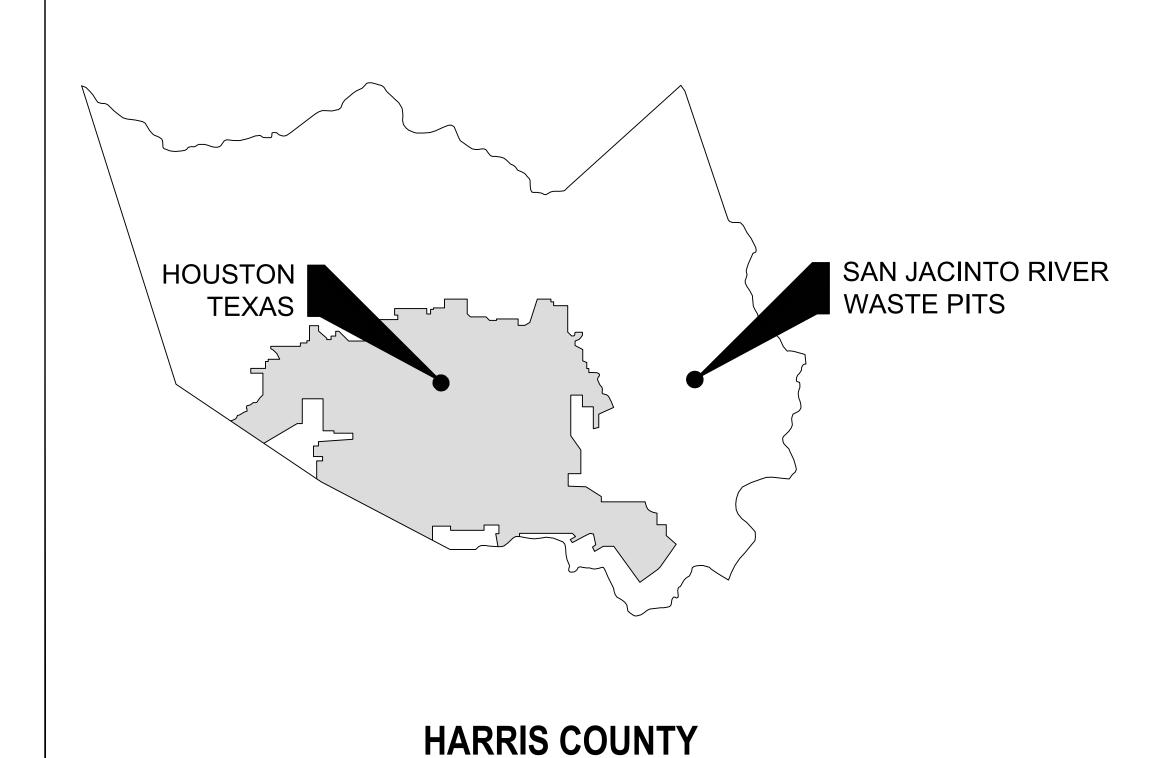

VICINITY MAP

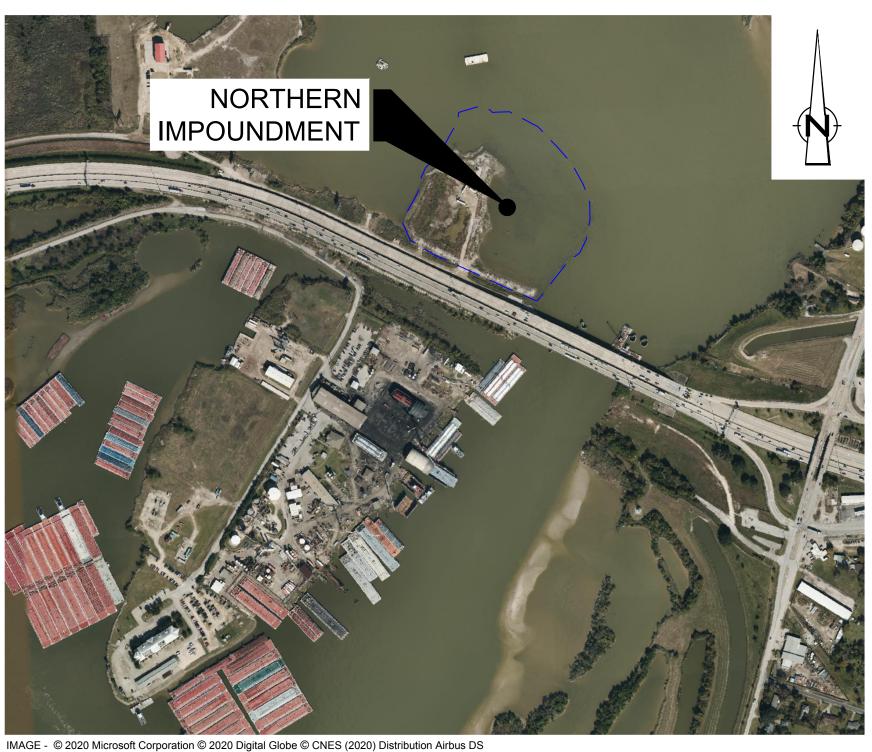

LOCATION MAP

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STATE OF TELYON
CHARLES W. MUNCE
CENSE

5551 Corporate Boulevard Suite 200

DRAWING NAME

COVER SHEET

EXISTING CONDITIONS

EXCAVATION PLAN SOUTHWES **EXCAVATION SECTION - 2 OF 6 EXCAVATION SECTION - 3 OF 6**

EXCAVATION SECTION - 6 OF 6

RESTORATION PLAN

TYPICAL DETAILS - 1 OF 3

TYPICAL DETAILS - 2 OF 3 TYPICAL DETAILS - 3 OF 3

TYPICAL SEASONAL EXCAVATION SEQUENCING TYPICAL EXCAVATION SEQUENCING - 1 OF 2

TYPICAL CONSTRUCTION SEQUENCING - 1 OF 2

TYPICAL CONSTRUCTION SEQUENCING - 2 OF 2

PILE WALL LAYOUT PLAN
DOUBLE PILE WALL PLAN AND PROFILE - 1 OF 4 DOUBLE PILE WALL PLAN AND PROFILE - 2 OF 4 DOUBLE PILE WALL PLAN AND PROFILE - 3 OF 4

DOUBLE PILE WALL PLAN AND PROFILE - 4 OF 4 SOUTH WALL PLAN AND PROFILE - 1 OF 2

WATER TREATMENT SYSTEM PROCESS FLOW DIAGRAM SYMBOLS

WATER TREATMENT SYSTEM PROCESS FLOW DIAGRAM SCHEDULES

WATER TREATMENT SYSTEM PROCESS FLOW DIAGRAM/MASS BALANCE

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SOUTH WALL PLAN AND PROFILE - 2 OF 2 DOUBLE PILE WALL SECTIONS - 1 OF 7

DOUBLE PILE WALL SECTIONS - 2 OF 7

DOUBLE PILE WALL SECTIONS - 3 OF 7 DOUBLE PILE WALL SECTIONS - 4 OF 7

DOUBLE PILE WALL SECTIONS - 5 OF 7 DOUBLE PILE WALL SECTIONS - 6 OF 7 DOUBLE PILE WALL SECTIONS - 7 OF 7 SOUTH WALL SECTIONS - 1 OF 3 SOUTH WALL SECTIONS - 2 OF 3 SOUTH WALL SECTIONS - 3 OF 3

WATER TREATMENT SYSTEM P&ID (1 OF 4)

WATER TREATMENT SYSTEM P&ID (2 OF 4) WATER TREATMENT SYSTEM P&ID (3 OF 4)

WATER TREATMENT SYSTEM P&ID (4 OF 4)

SITE PLAN WATER TREATMENT SYSTEM SEASON 3-6

STRUCTURAL NOTES STRUCTURAL LAYOUT PLAN

STRUCTURAL SECTIONS STRUCTURAL DETAILS 1 OF 2 STRUCTURAL DETAILS 2 OF 2

TYPICAL EXCAVATION SEQUENCING - 2 OF 2

SSA AREA AND NORTHERN IMPOUNDMENT WORKS SOIL EROSION AND SEDIMENT CONTROL PLAN - OVERAL

DRAWING NUMBER GENERAL SERIES

STRUCTURAL SERIES

PROCESS FLOW AND INSTRUMENTATION SERIES

S-01 S-02

S-03 S-04

P-00B

P-01 P-02

P-03

P-05 P-06

CIVIL SERIES

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SAN JACINTO RIVER WASTE PITS

NORTHERN IMPOUNDMENT PRE-FINAL 90% REMEDIAL DESIGN HARRIS COUNTY, TEXAS

Г				
4	90% EPA REVIEW	MW	СМ	06/27/20
No.	Issue	Drawn	Approved	Date
Draw	n MW	Designer	RH	
Draft Chec	· .)(.	Design Check	LL	
	Project CM Coordinator		Jun 27, 20)22
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Original Size Arch D

Bar is one inch on original size drawing

Project No. **11215702**

COVER SHEET


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G-01


90% EPA REVIEW

Plot Date: 27 June 2022 - 3:53 PM

Filename: N:\US\Baton Rouge\Projects\562\11215702\Digital_Design\ACAD 2019\Sheets\11215702-01-DWG-G-001.dwg



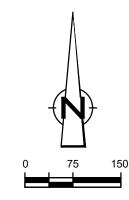

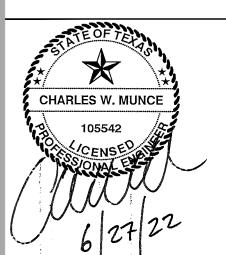

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— — TCRA CAP PERIMETER _____ x ____ FENCELINE TOP OF BANK

 $----- \qquad \text{TOE OF SLOPE}$ OVERHEAD ELECTRICAL ——O——O——— GUARDRAIL _____ \\ ____ PIPELINE ■ SJSB002 BORING LOCATION

MONITORING WELL POWER POLE LIGHT POLE WELL ASPHALT CONCRETE

GRAVEL

SAN JACINTO RIVER WASTE PITS

NORTHERN IMPOUNDMENT PRE-FINAL 90% REMEDIAL DESIGN HARRIS COUNTY, TEXAS

4	90% EPA REVIEW	MW	СМ	06/27/20
No.	Issue	Drawn	Approved	Date
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Project No. **11215702**

OVERALL

PLAN

Sheet No.


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Sheet - of -

90% EPA REVIEW



Plot Date: 27 June 2022 - 1:55 PM

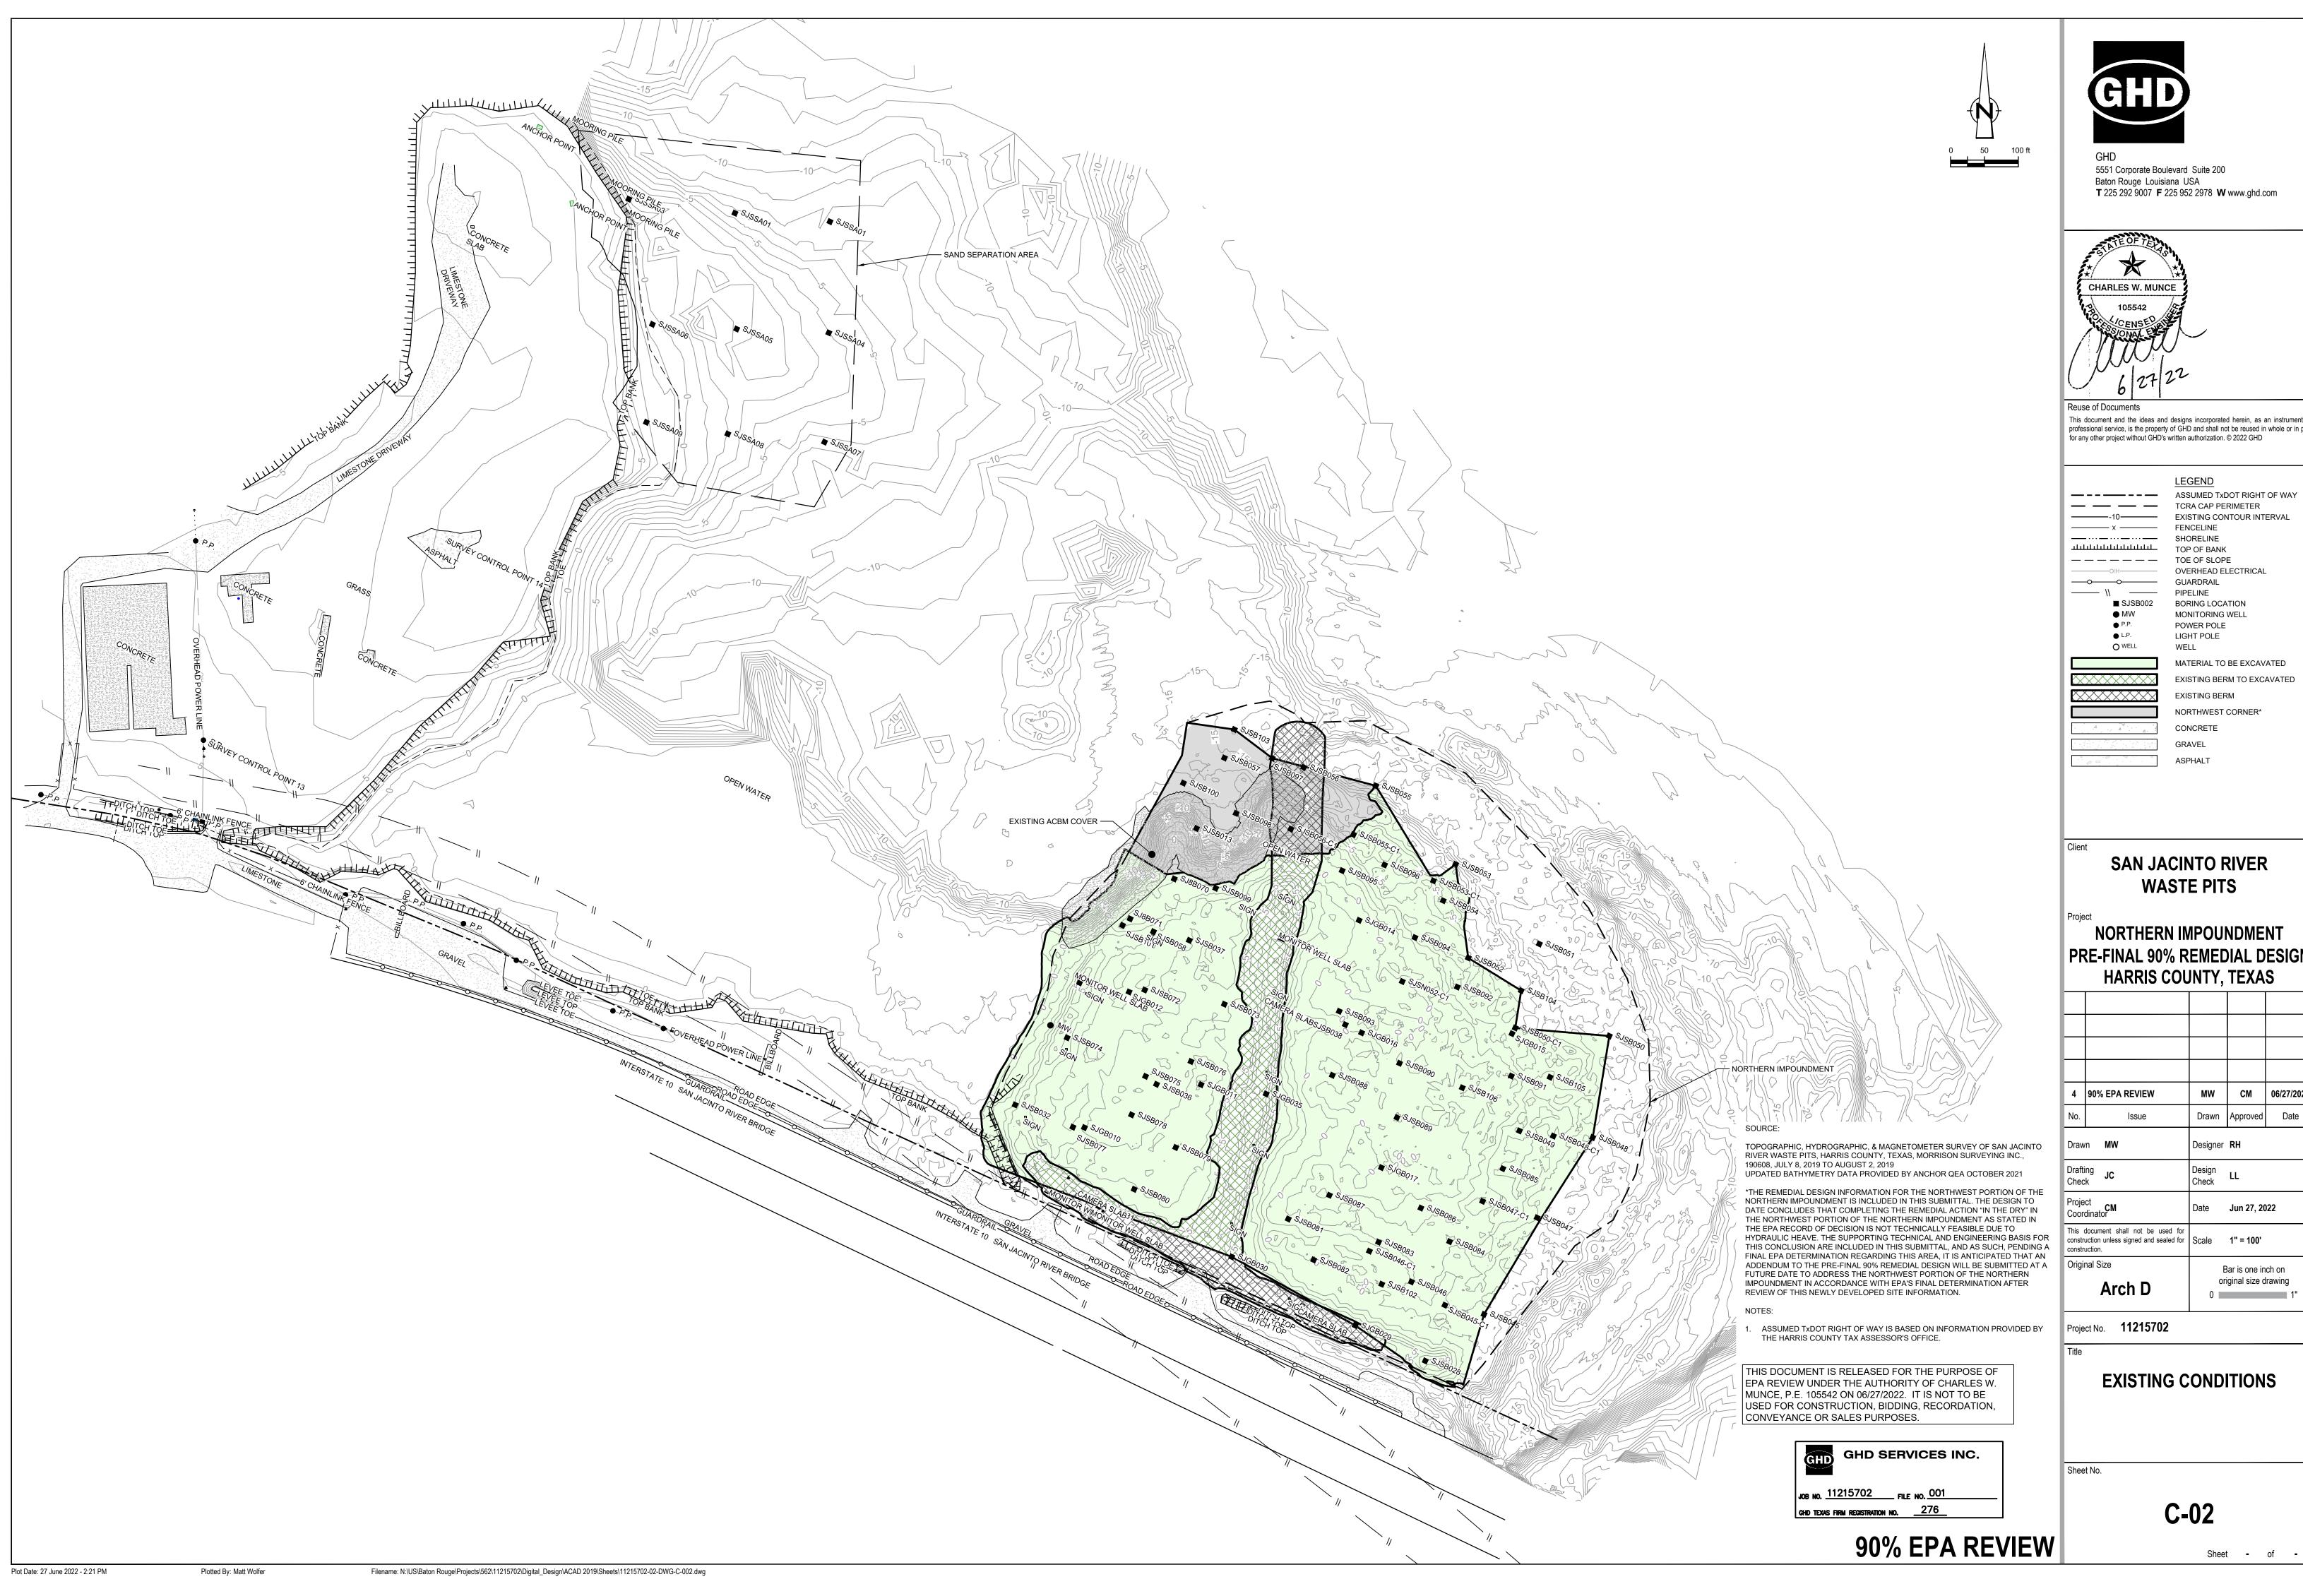


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PRE-FINAL 90% REMEDIAL DESIGN

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Project CM Coordinator		Date	Jun 27, 20)22
	document shall not be used for uction unless signed and sealed for uction.	Scale	1" = 100'	
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-10	LEGEND ASSUMED TXDOT RIGHT OF WAY TCRA CAP PERIMETER EXISTING CONTOUR INTERVAL FENCELINE SHORELINE TOP OF BANK TOE OF SLOPE OVERHEAD ELECTRICAL GUARDRAIL PIPELINE BORING LOCATION
P.P. L.P. WELL	MONITORING WELL POWER POLE LIGHT POLE WELL
	MATERIAL TO BE EXCAVATED
	EXISTING BERM TO EXCAVATED
	EXISTING BERM
	NORTHWEST CORNER*
	CONCRETE
	GRAVEL

SAN JACINTO RIVER

ASPHALT

AZ26-700 PILE

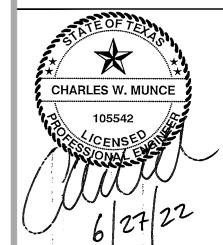AZ40-700 PILE

SOIL TYPE S1

PLANNED IMPROVEMENTS FOR NORTHERN IMPOUNDMENT ACCESS

WASTE PITS

NORTHERN IMPOUNDMENT PRE-FINAL 90% REMEDIAL DESIGN HARRIS COUNTY, TEXAS

4	90% EPA REVIEW	MW	СМ	06/27/2022
No.	Issue	Drawn	Approved	Date
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Proj Coo	ect rdinator	Date	Jun 27, 20)22
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Arch D

original size drawing

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Sheet - of -


Project No. **11215702**


Original Size

SSA AREA AND NORTHERN IMPOUNDMENT **WORKS**

Sheet No.

C-03

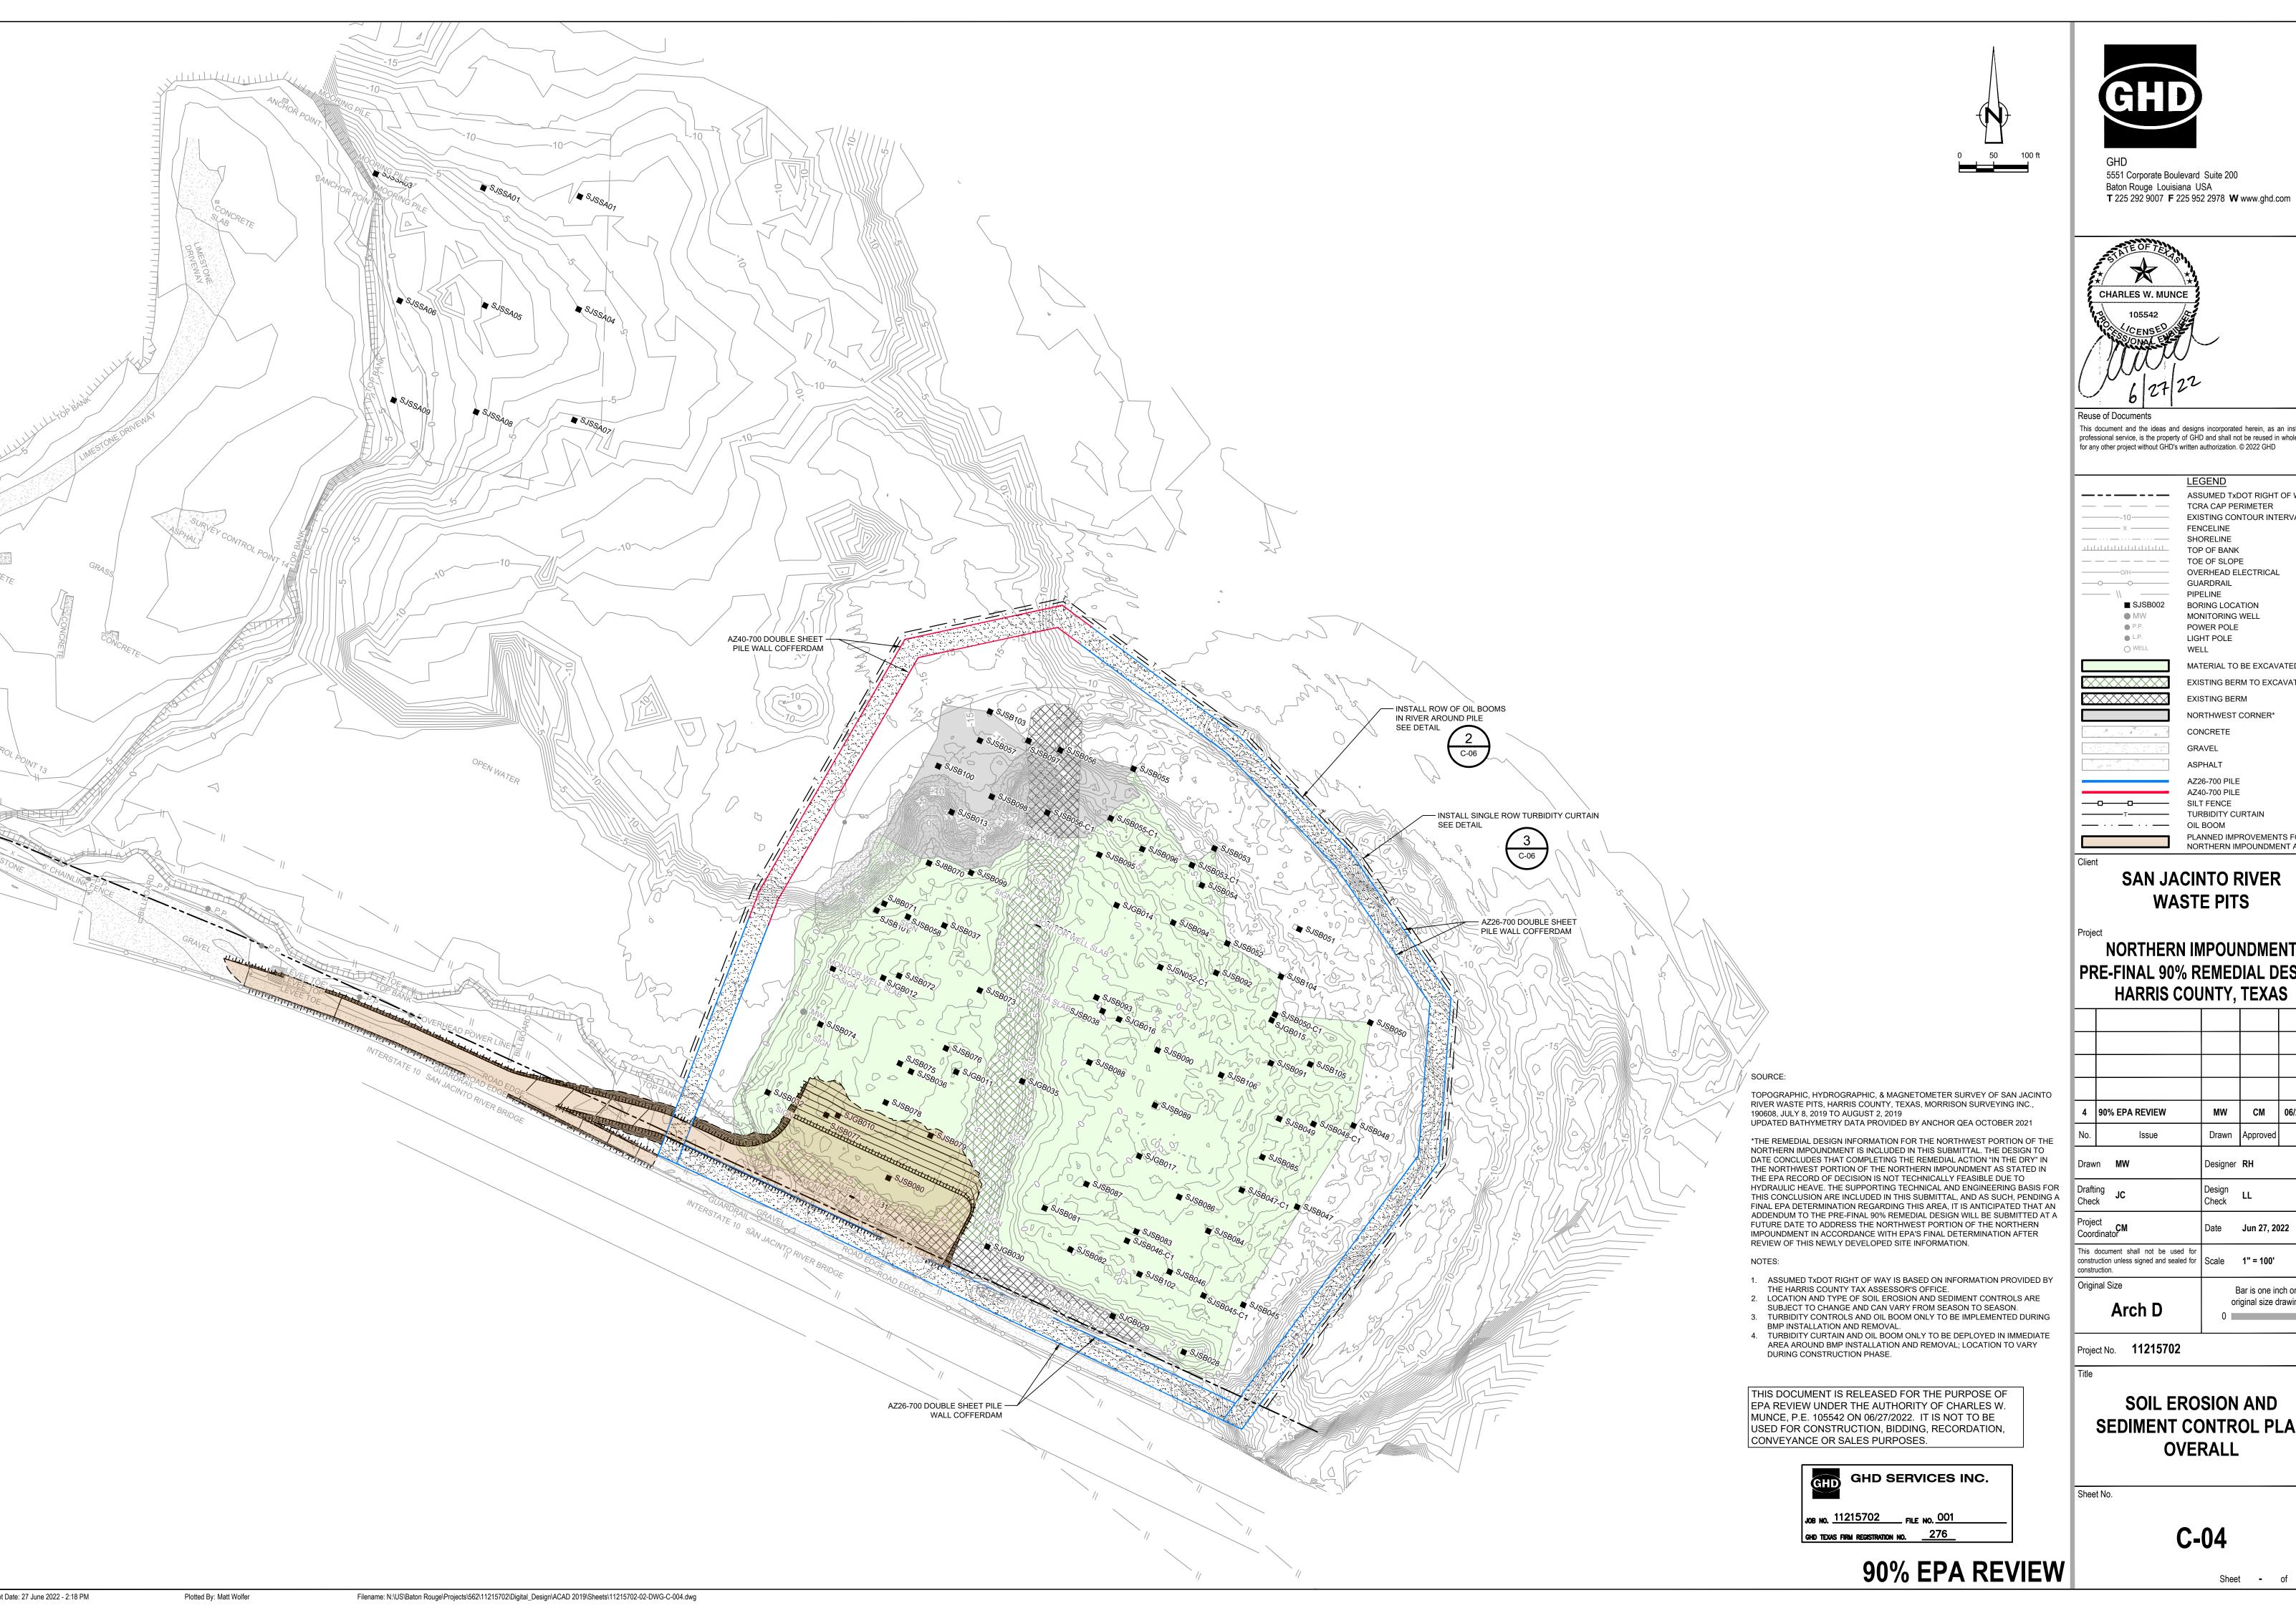

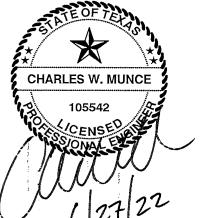

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---- TCRA CAP PERIMETER FENCELINE TOP OF BANK ____ TOE OF SLOPE OVERHEAD ELECTRICAL GUARDRAIL PIPELINE ■ SJSB002 BORING LOCATION MONITORING WELL POWER POLE LIGHT POLE MATERIAL TO BE EXCAVATED EXISTING BERM TO EXCAVATED **EXISTING BERM** NORTHWEST CORNER*

CONCRETE GRAVEL

ASPHALT AZ26-700 PILE AZ40-700 PILE SILT FENCE TURBIDITY CURTAIN

PLANNED IMPROVEMENTS FOR

SAN JACINTO RIVER WASTE PITS

NORTHERN IMPOUNDMENT PRE-FINAL 90% REMEDIAL DESIGN

4	90% EPA REVIEW	MW	СМ	06/27/2022
No.	Issue	Drawn	Approved	Date
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Drafting JC Check		Design Check	LL	
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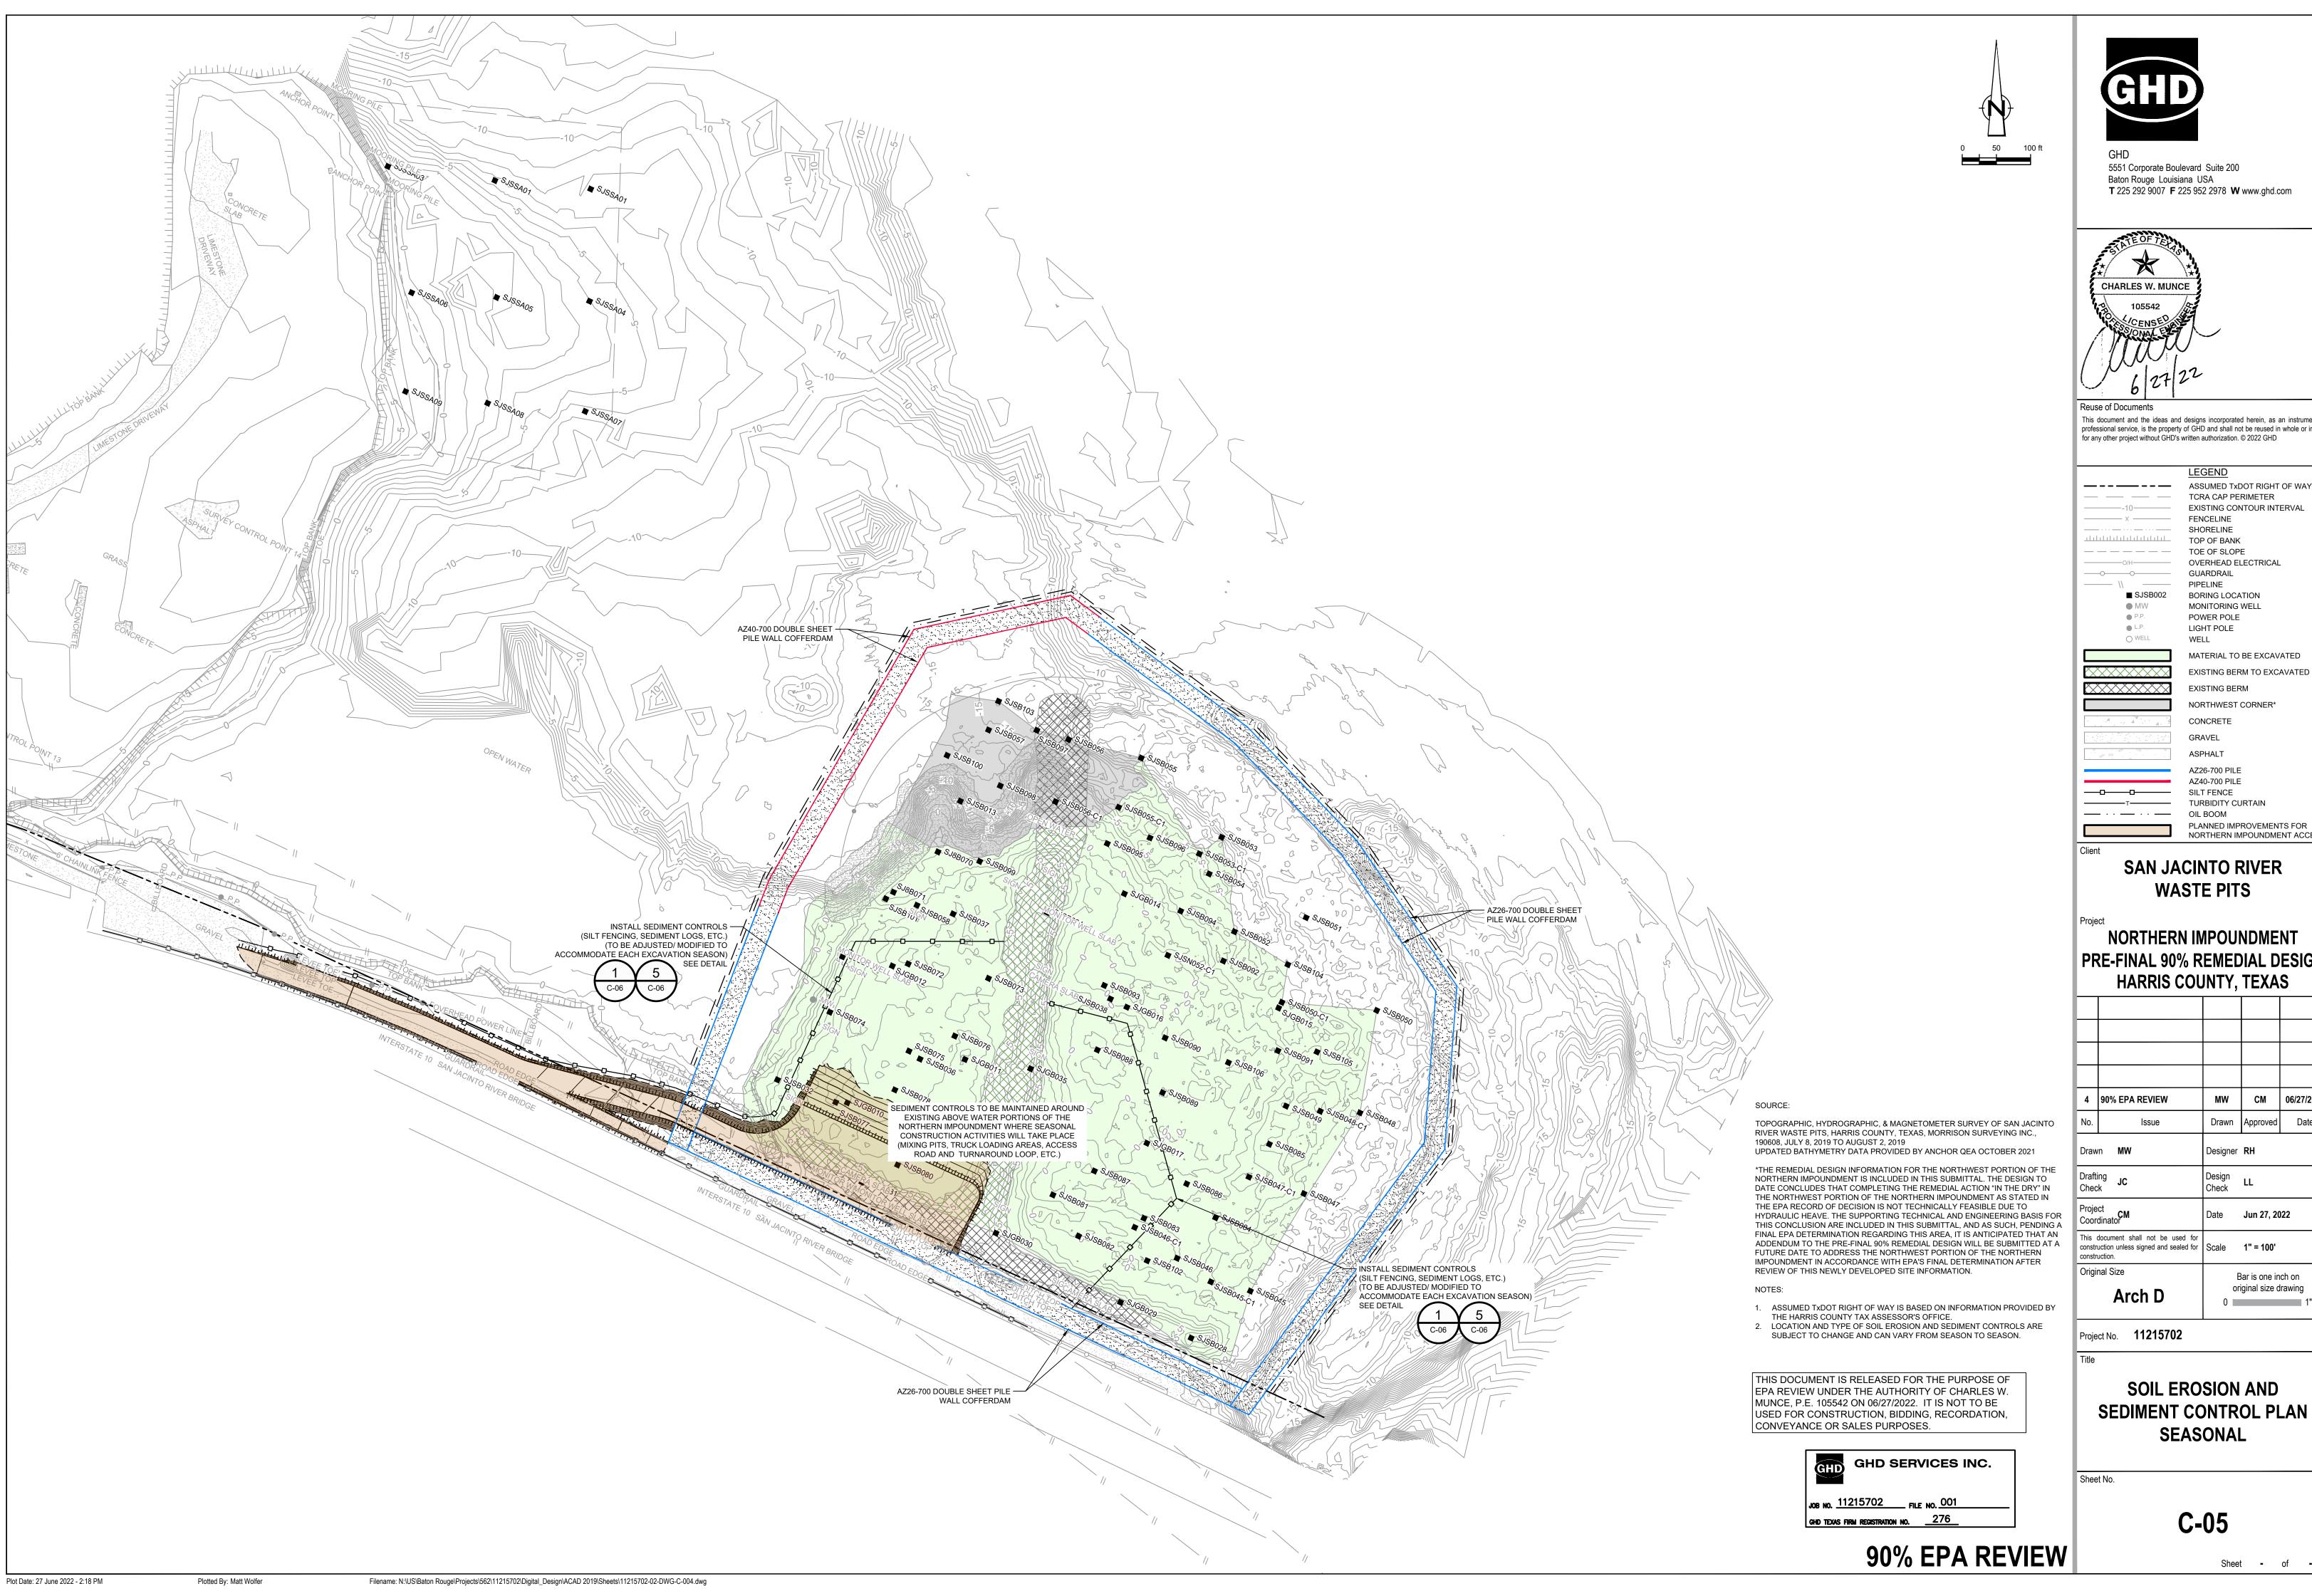
original size drawing

Bar is one inch on

SOIL EROSION AND

SEDIMENT CONTROL PLAN **OVERALL**

C-04



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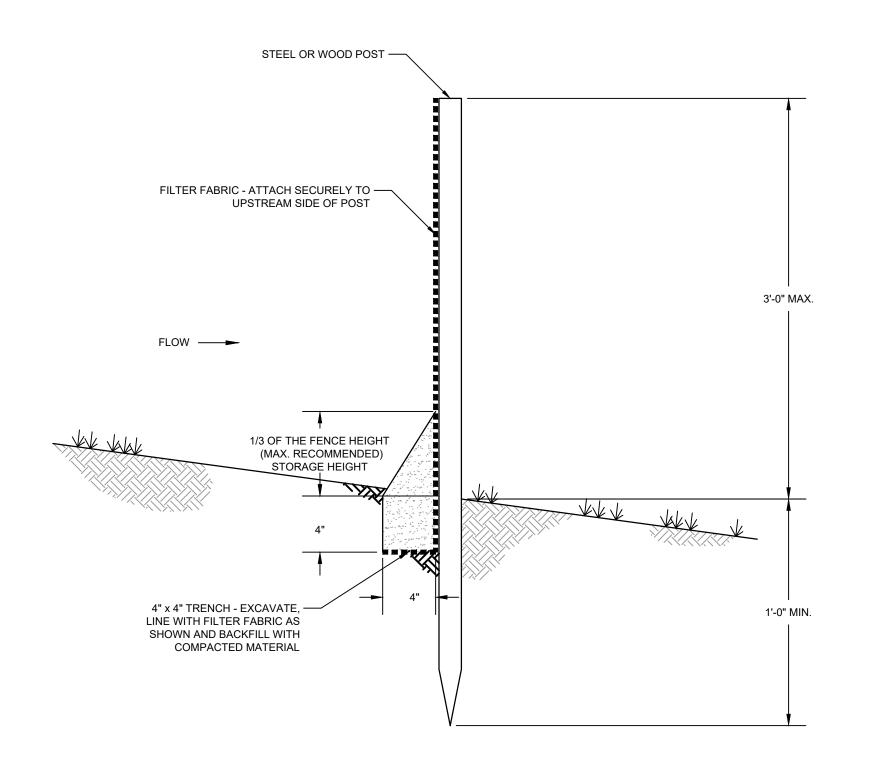
	<u>LEGEND</u>
	ASSUMED TXDOT RIGHT OF WA
	TCRA CAP PERIMETER
-10	EXISTING CONTOUR INTERVAL
x	FENCELINE
	SHORELINE
	TOP OF BANK
	TOE OF SLOPE
O/H	OVERHEAD ELECTRICAL
0	GUARDRAIL
\\	PIPELINE
■ SJSB002	BORING LOCATION
MW	MONITORING WELL
P.P.	POWER POLE
♠ L.P.	LIGHT POLE
O WELL	WELL


PLANNED IMPROVEMENTS FOR

NORTHERN IMPOUNDMENT PRE-FINAL 90% REMEDIAL DESIGN

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4	90% EPA REVIEW	MW	СМ	06/27/2022
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	Drafting JC Check		LL	
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SEDIMENT CONTROL PLAN



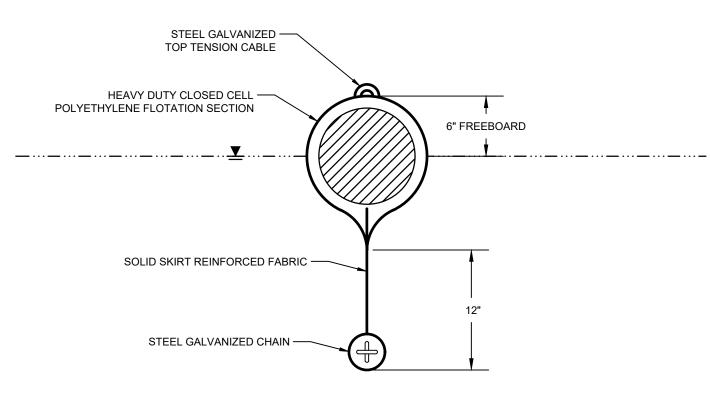


1. OIL BOOM SHALL CONFORM TO COAST GUARD OPA 90 REGULATION AND ASTM F-1523

NON-ABSORBENT OIL BOOM

<u>NOTES</u>

2. OIL BOOM SHALL BE CONTINUOUS TYPE.

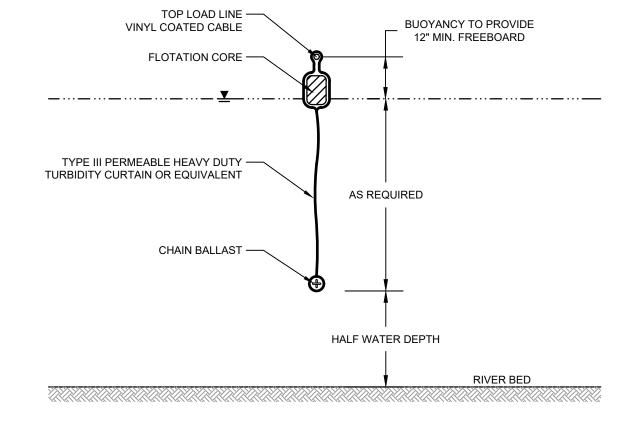


TURBIDITY CURTAIN SHALL BE TYPE III ACCORDING TO DEPARTMENT OF THE ARMY, US ARMY CORPS OF ENGINEERS WASHINGTON, DC, ENGINEERING AND DESIGN "HANDBOOK FOR THE PREPARATION OF STORM WATER POLLUTION PREVENTION PLANS FOR CONSTRUCTION ACTIVITIES", APPENDIX 'C' BMP 27 TURBIDITY CURTAIN, DOCUMENT EP1110-1-16, 1997.
 CURTAIN SYSTEM SHALL BE EQUIPPED WITH LOAD TRANSFER TYPE PANEL CONNECTORS INCLUDE MOORING SYSTEM IF REQUIRED.


DETAIL 3 TURBIDITY CURTAIN

DETAIL 1 TEMPORARY SILT FENCE


C-05

C-05

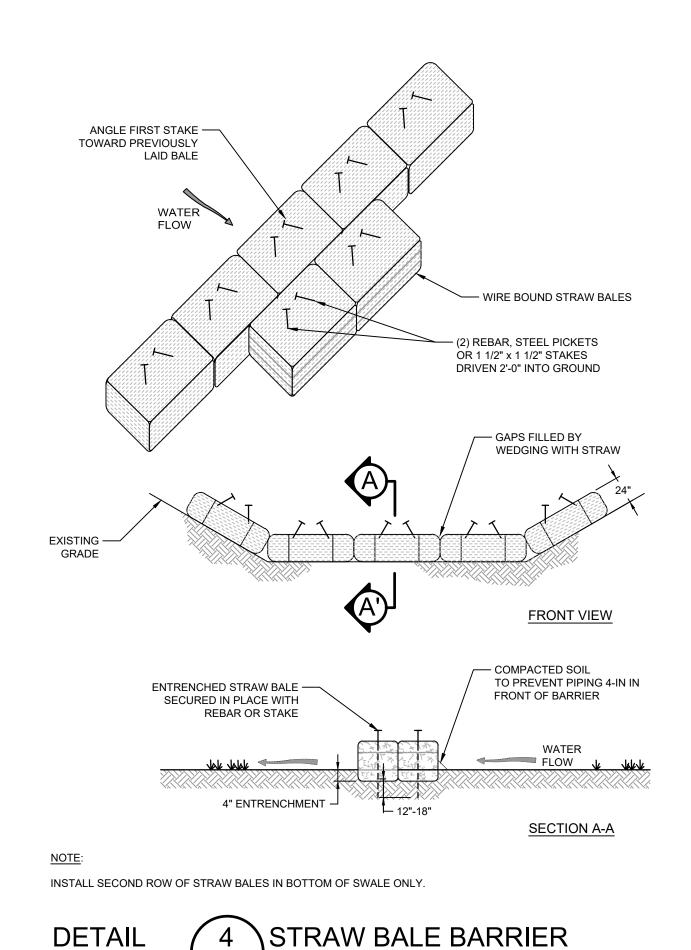

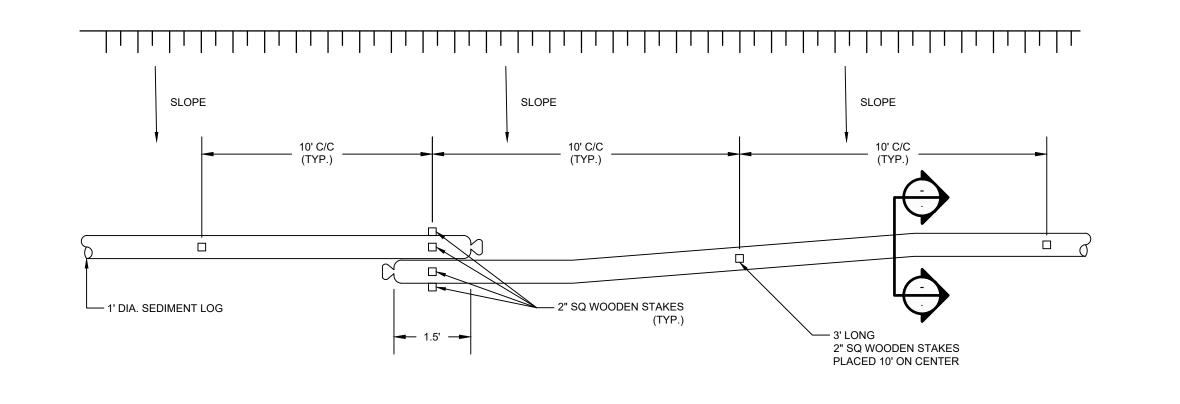

<u>PLAN</u>

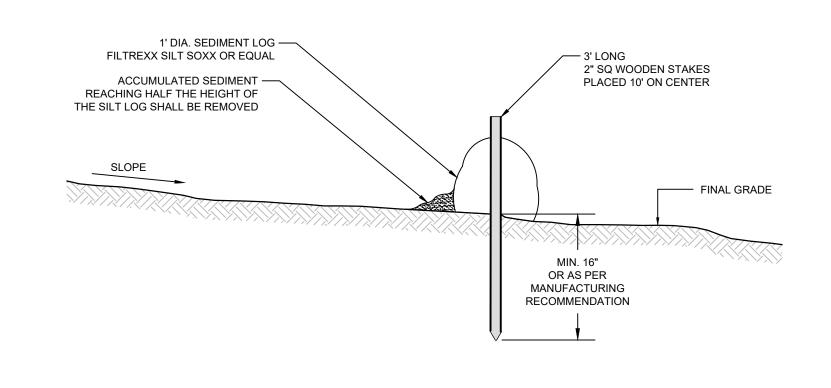

DETAIL 5 SEDIMENT LOG

N.T.S. C-05


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SAN JACINTO RIVER
WASTE PITS

NORTHERN IMPOUNDMENT
PRE-FINAL 90% REMEDIAL DESIGN
HARRIS COUNTY, TEXAS

4	90% EPA REVIEW	MW	СМ	06/27/20
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	Project CM Coordinator		Jun 27, 20)22
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Arch D

original size drawing

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1'

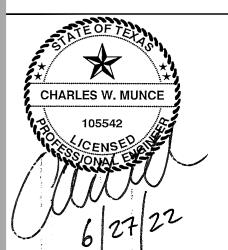Bar is one inch on

Project No. **11215702**

Original Size

SOIL EROSION AND

SEDIMENT CONTROL DETAILS

Sheet No.


C-06

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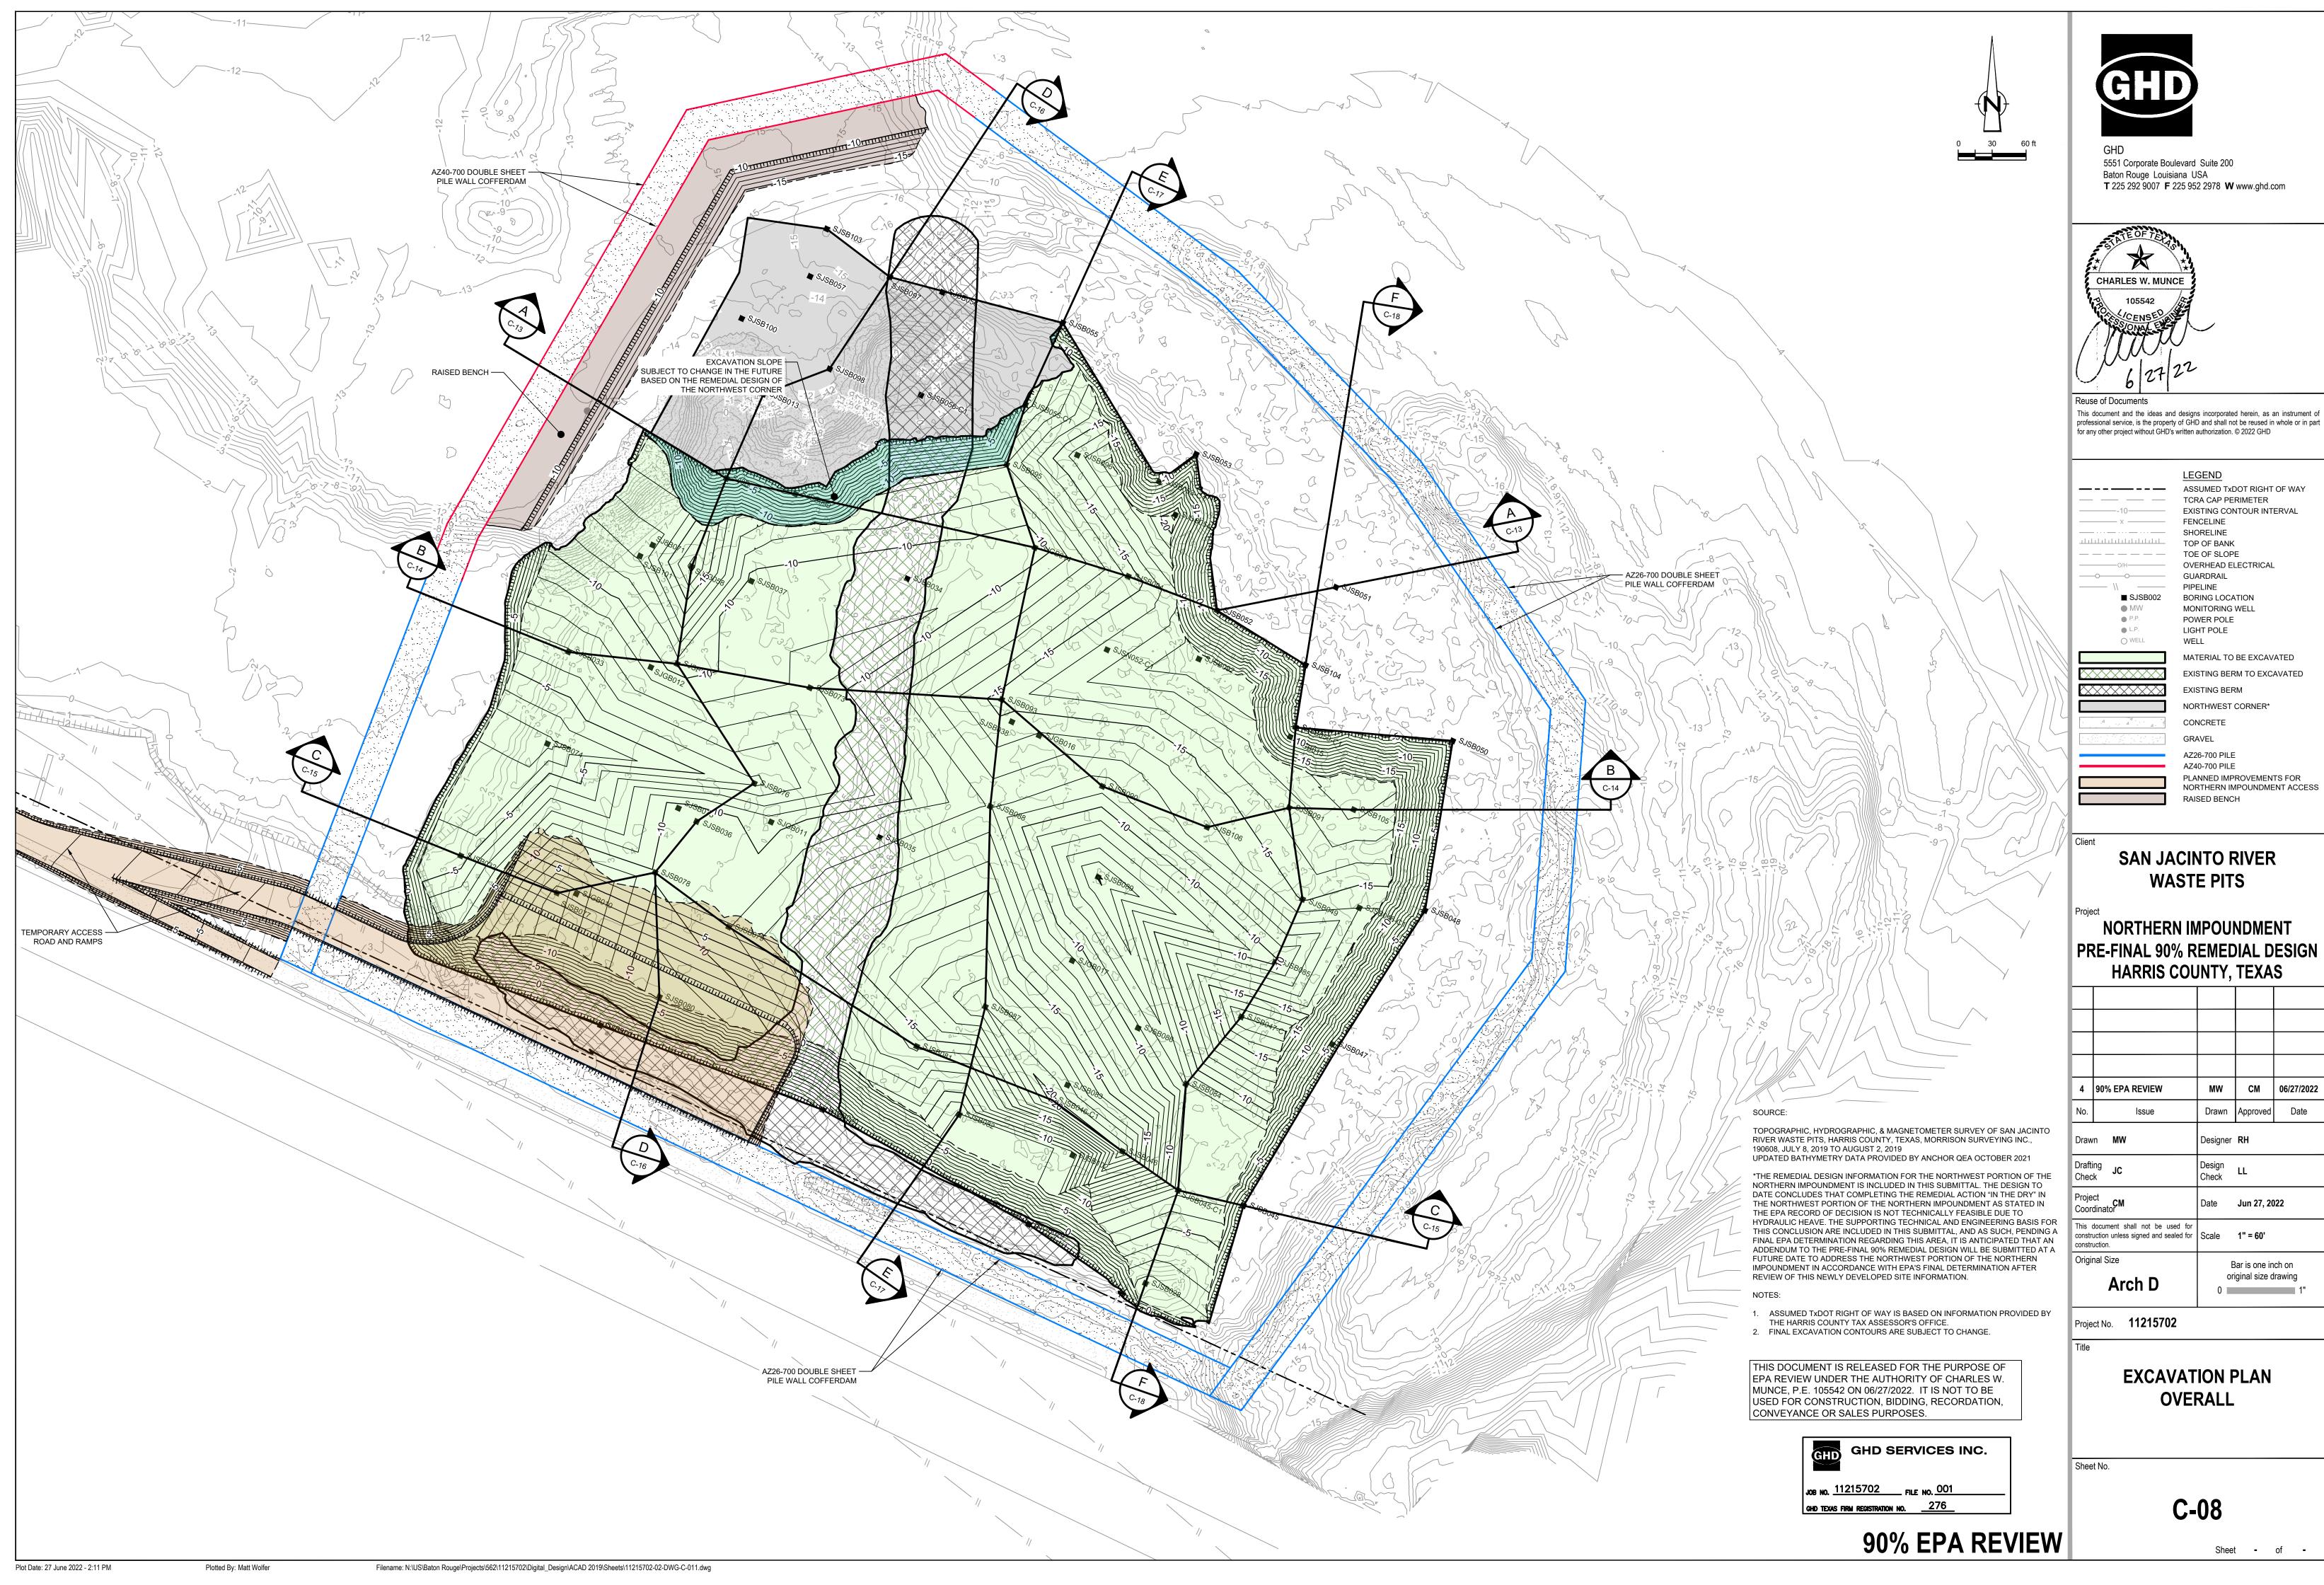
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Plotted By: Matt Wolfer

Filename: N:\US\Baton Rouge\Projects\562\11215702\Digital_Design\ACAD 2019\Sheets\11215702-01-DWG-C-006.dwg





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4	90% EPA REVIEW	MW	СМ	06/27/2022
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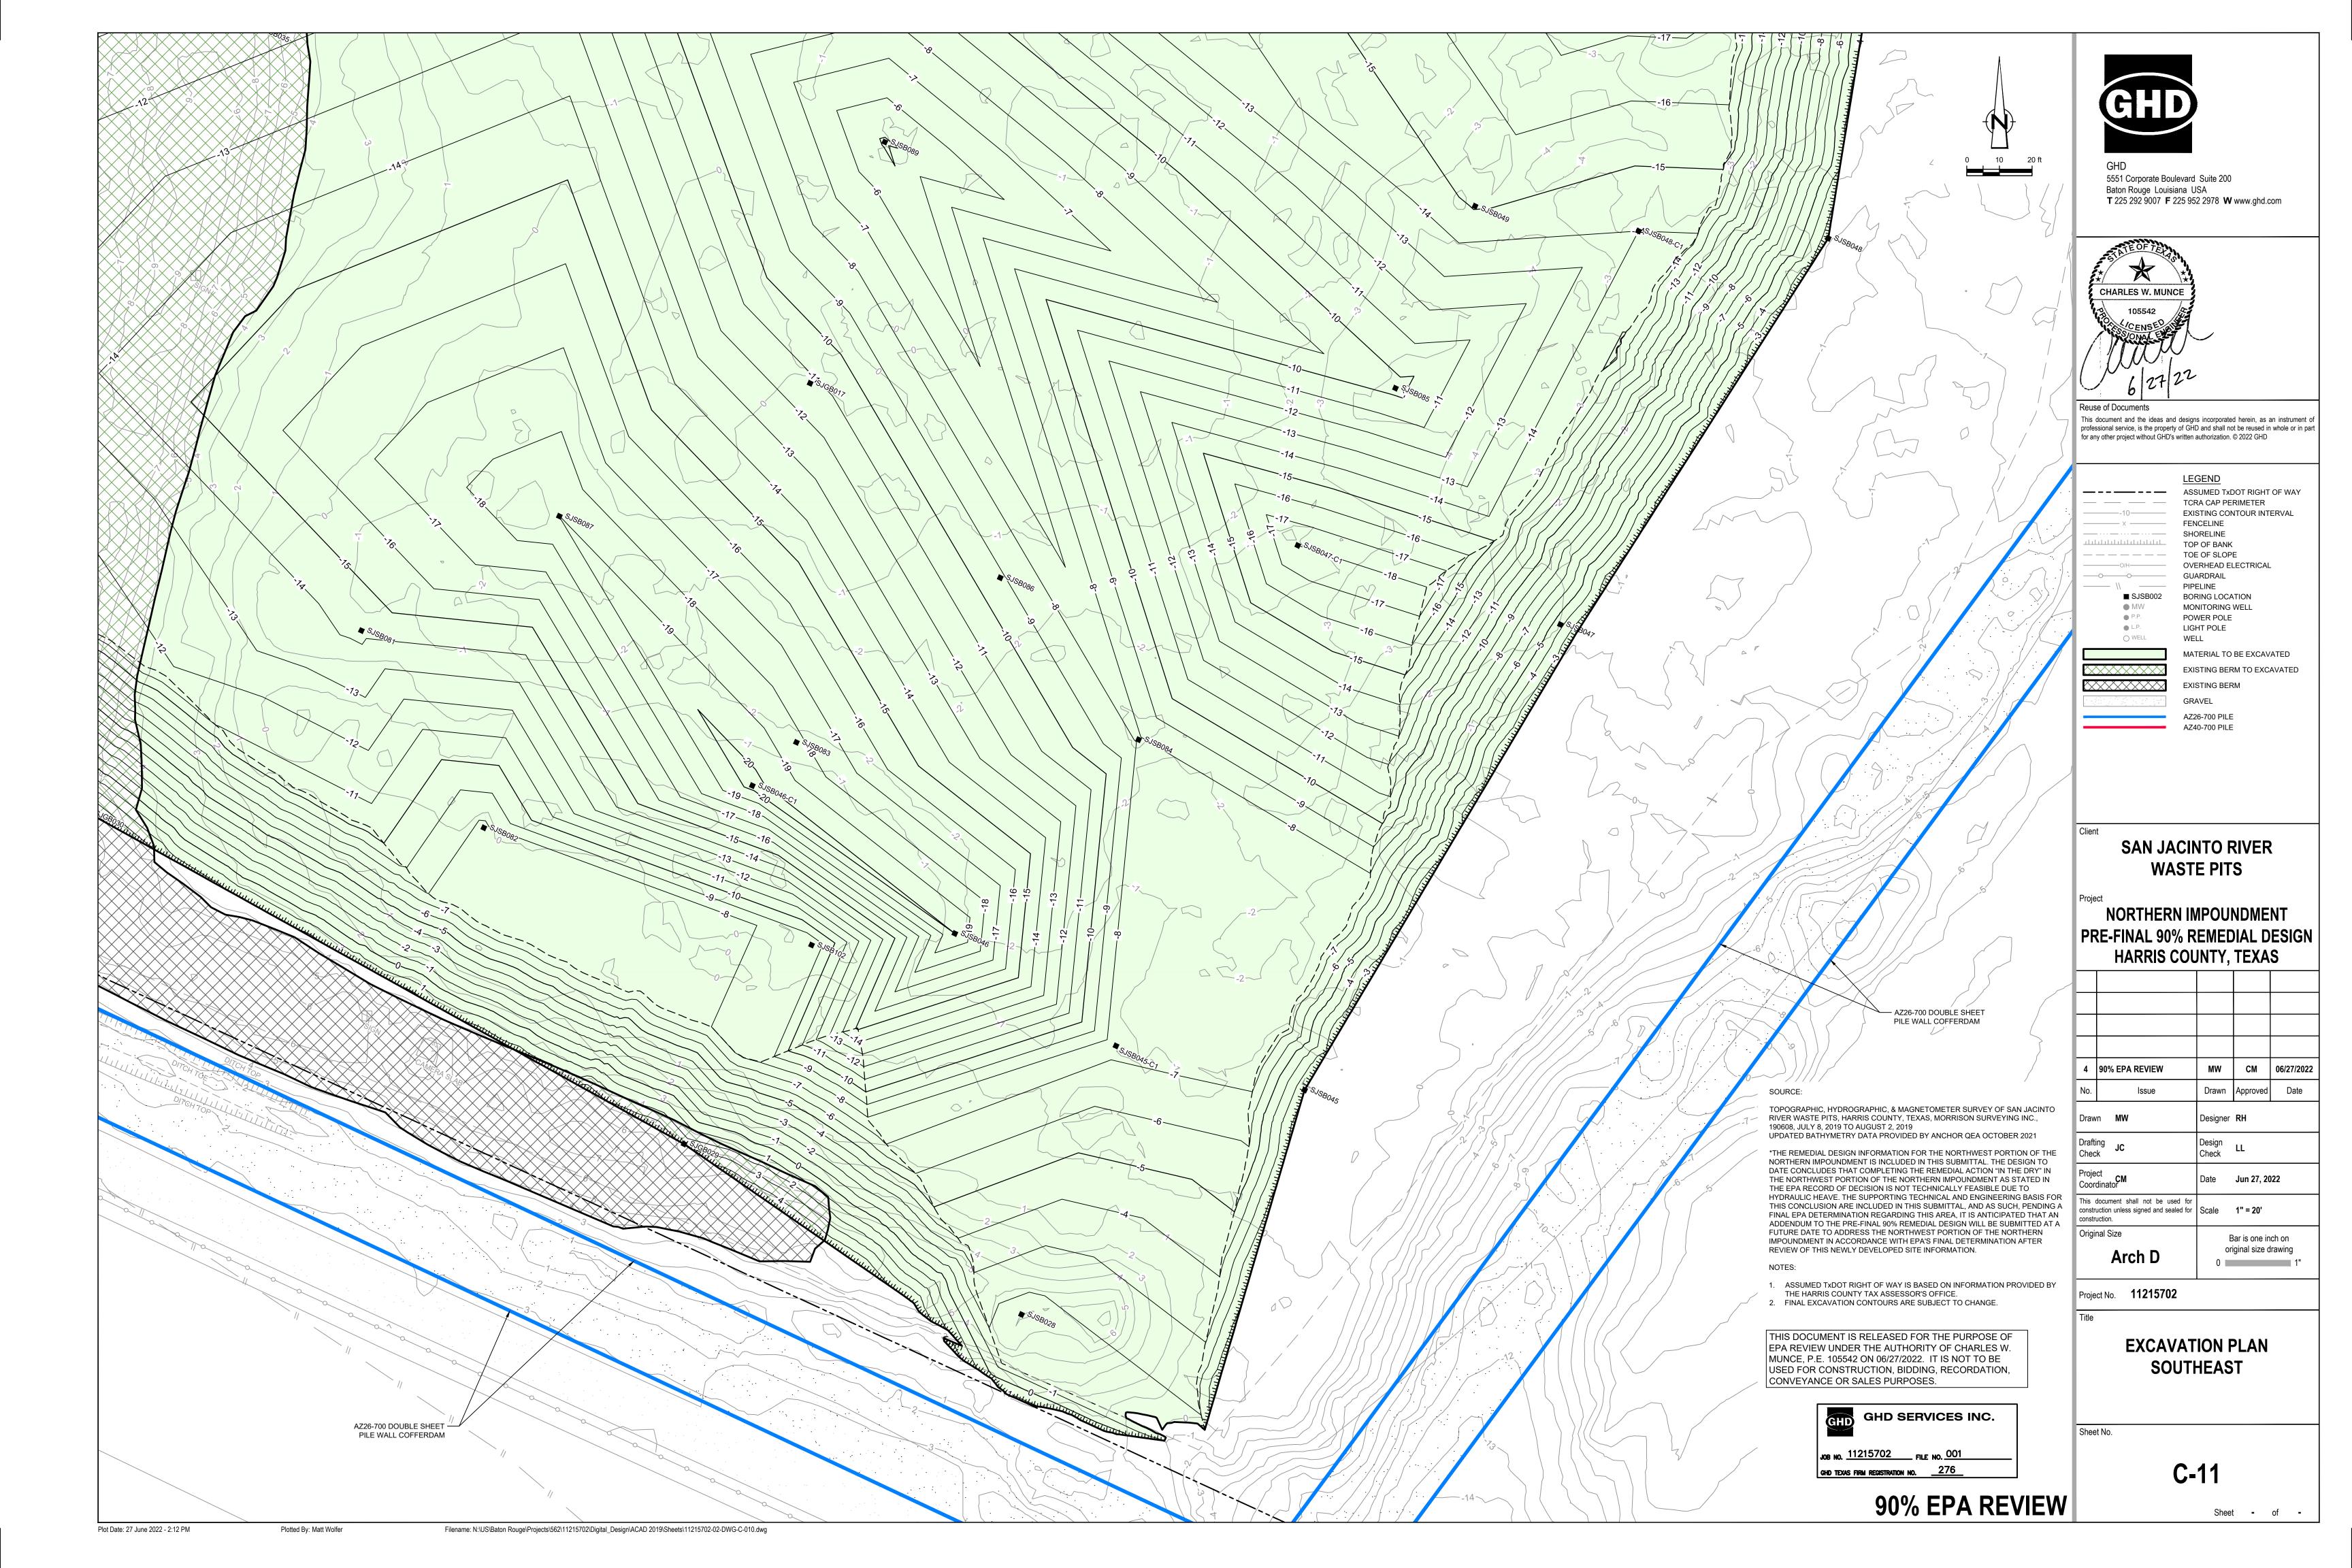


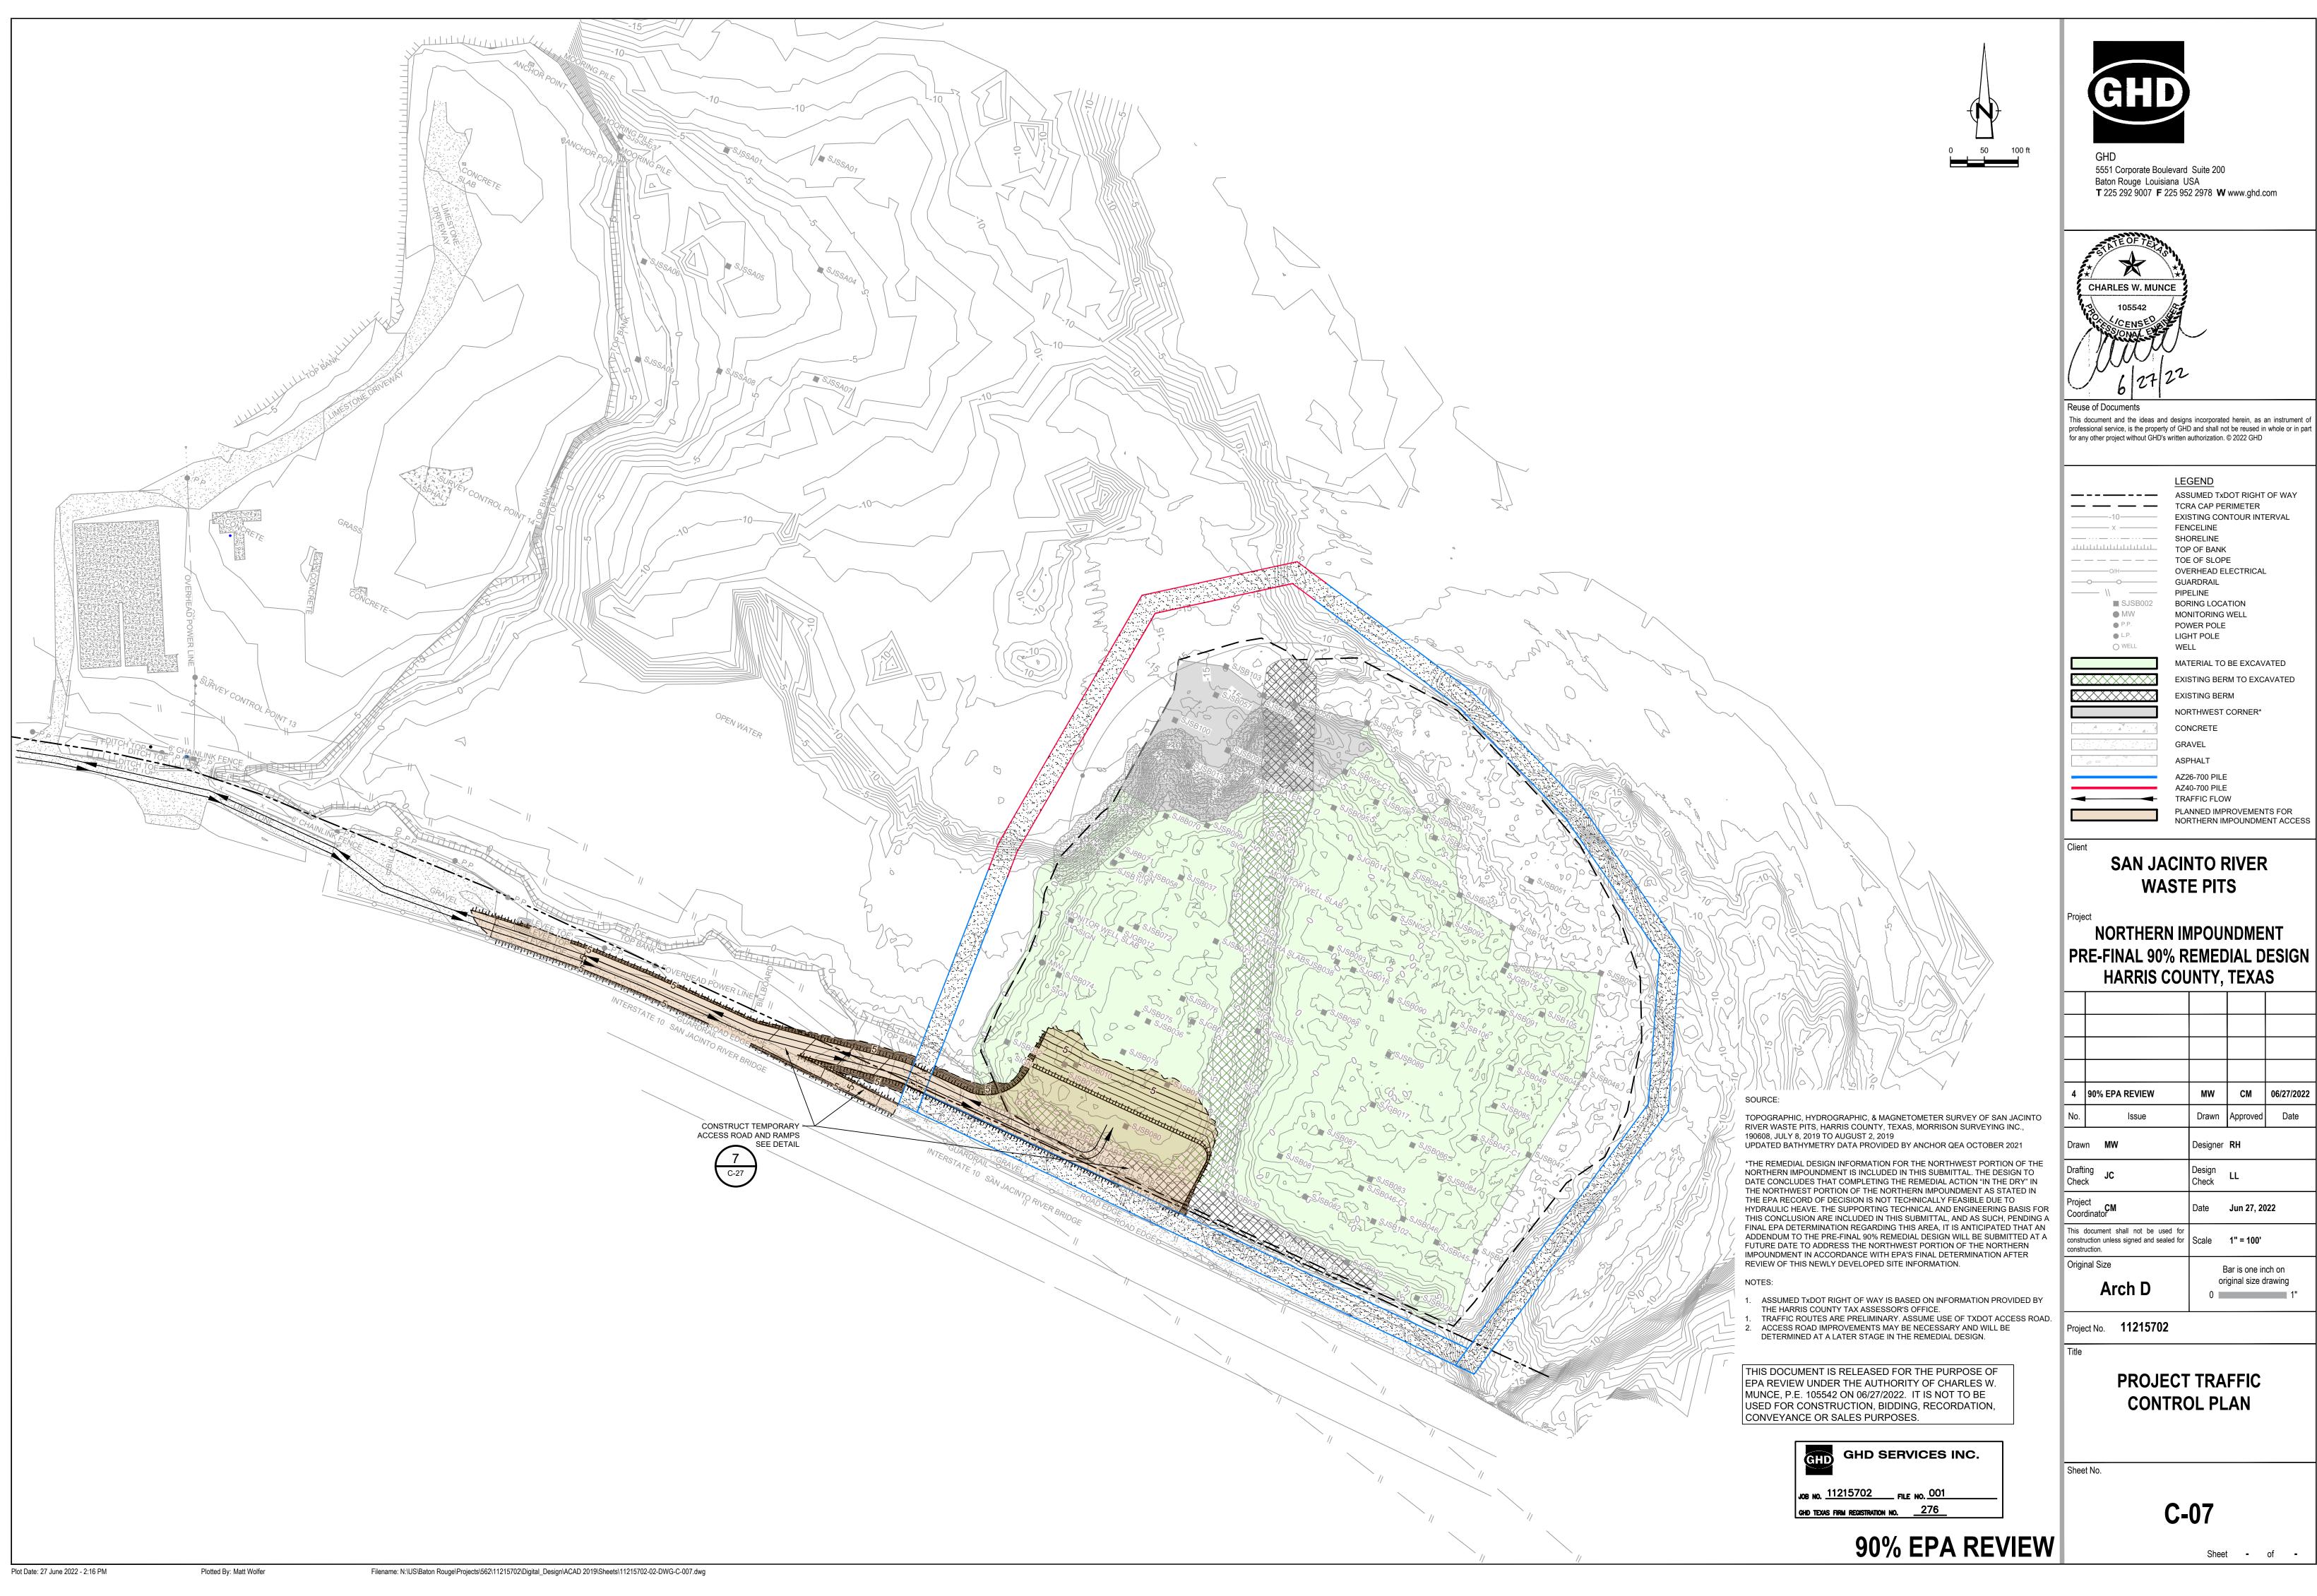
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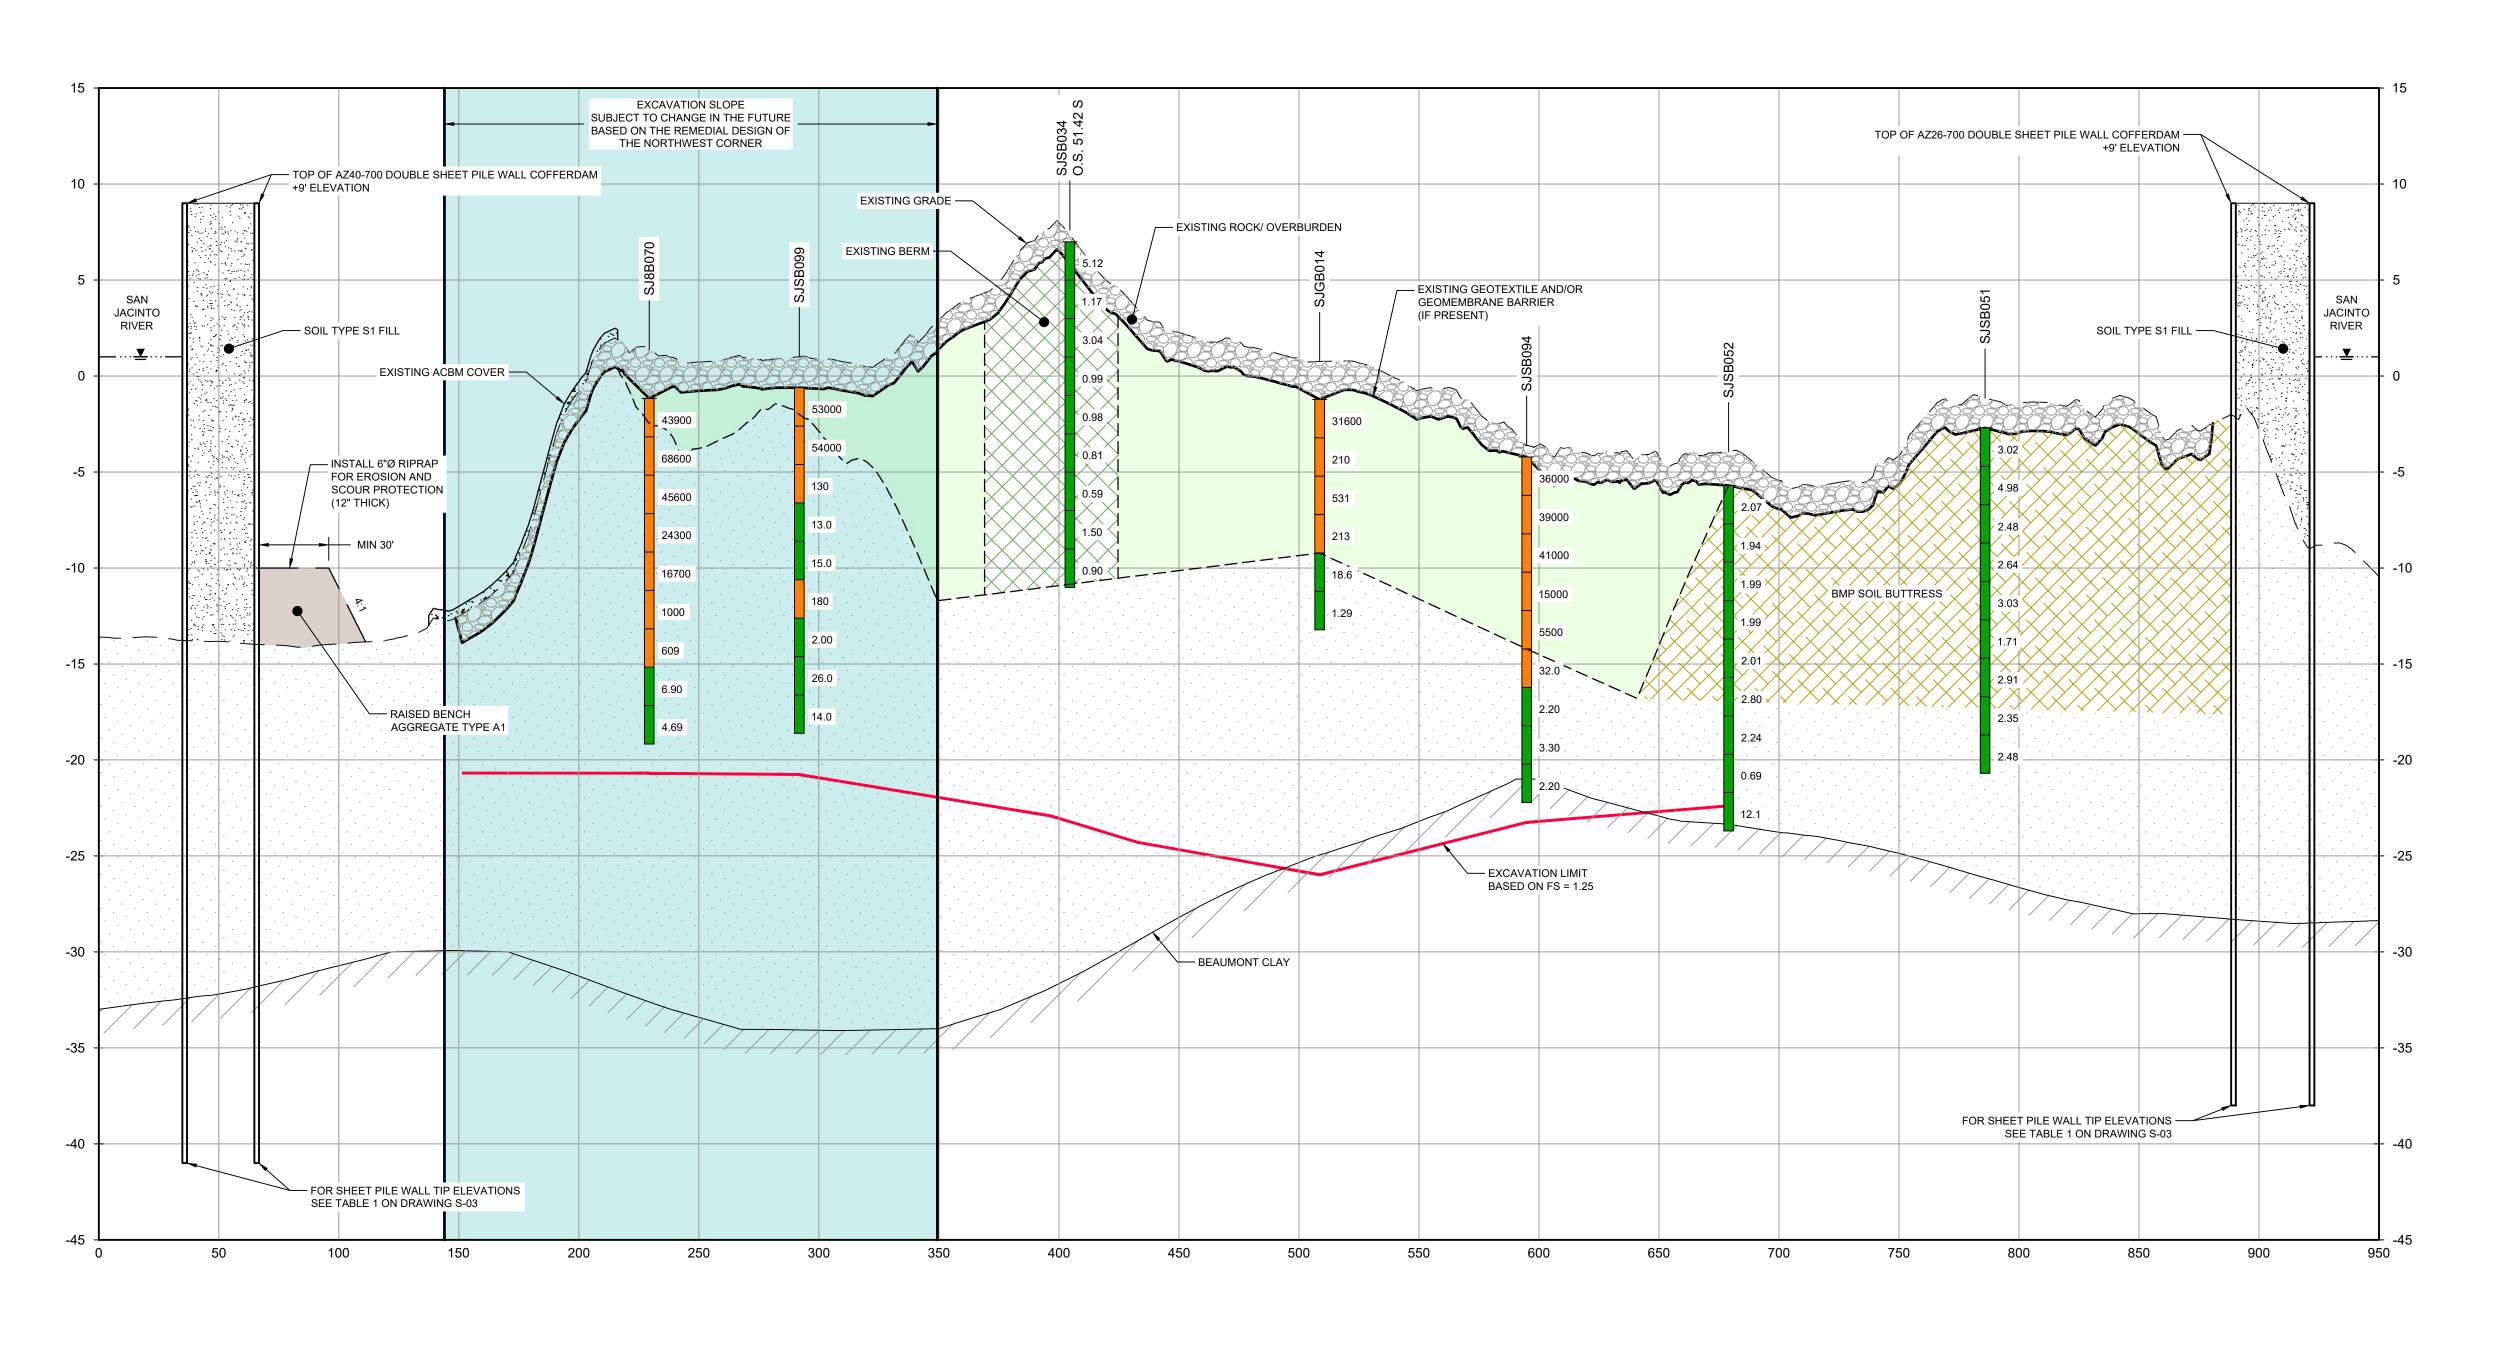
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Drawn MW		Designer	RH	
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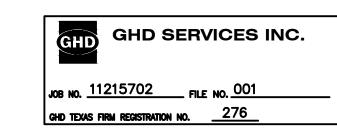


SECTION A WEST/EAST
HORIZ: 1"=40'
VERT: 1"=5'

NOTES:

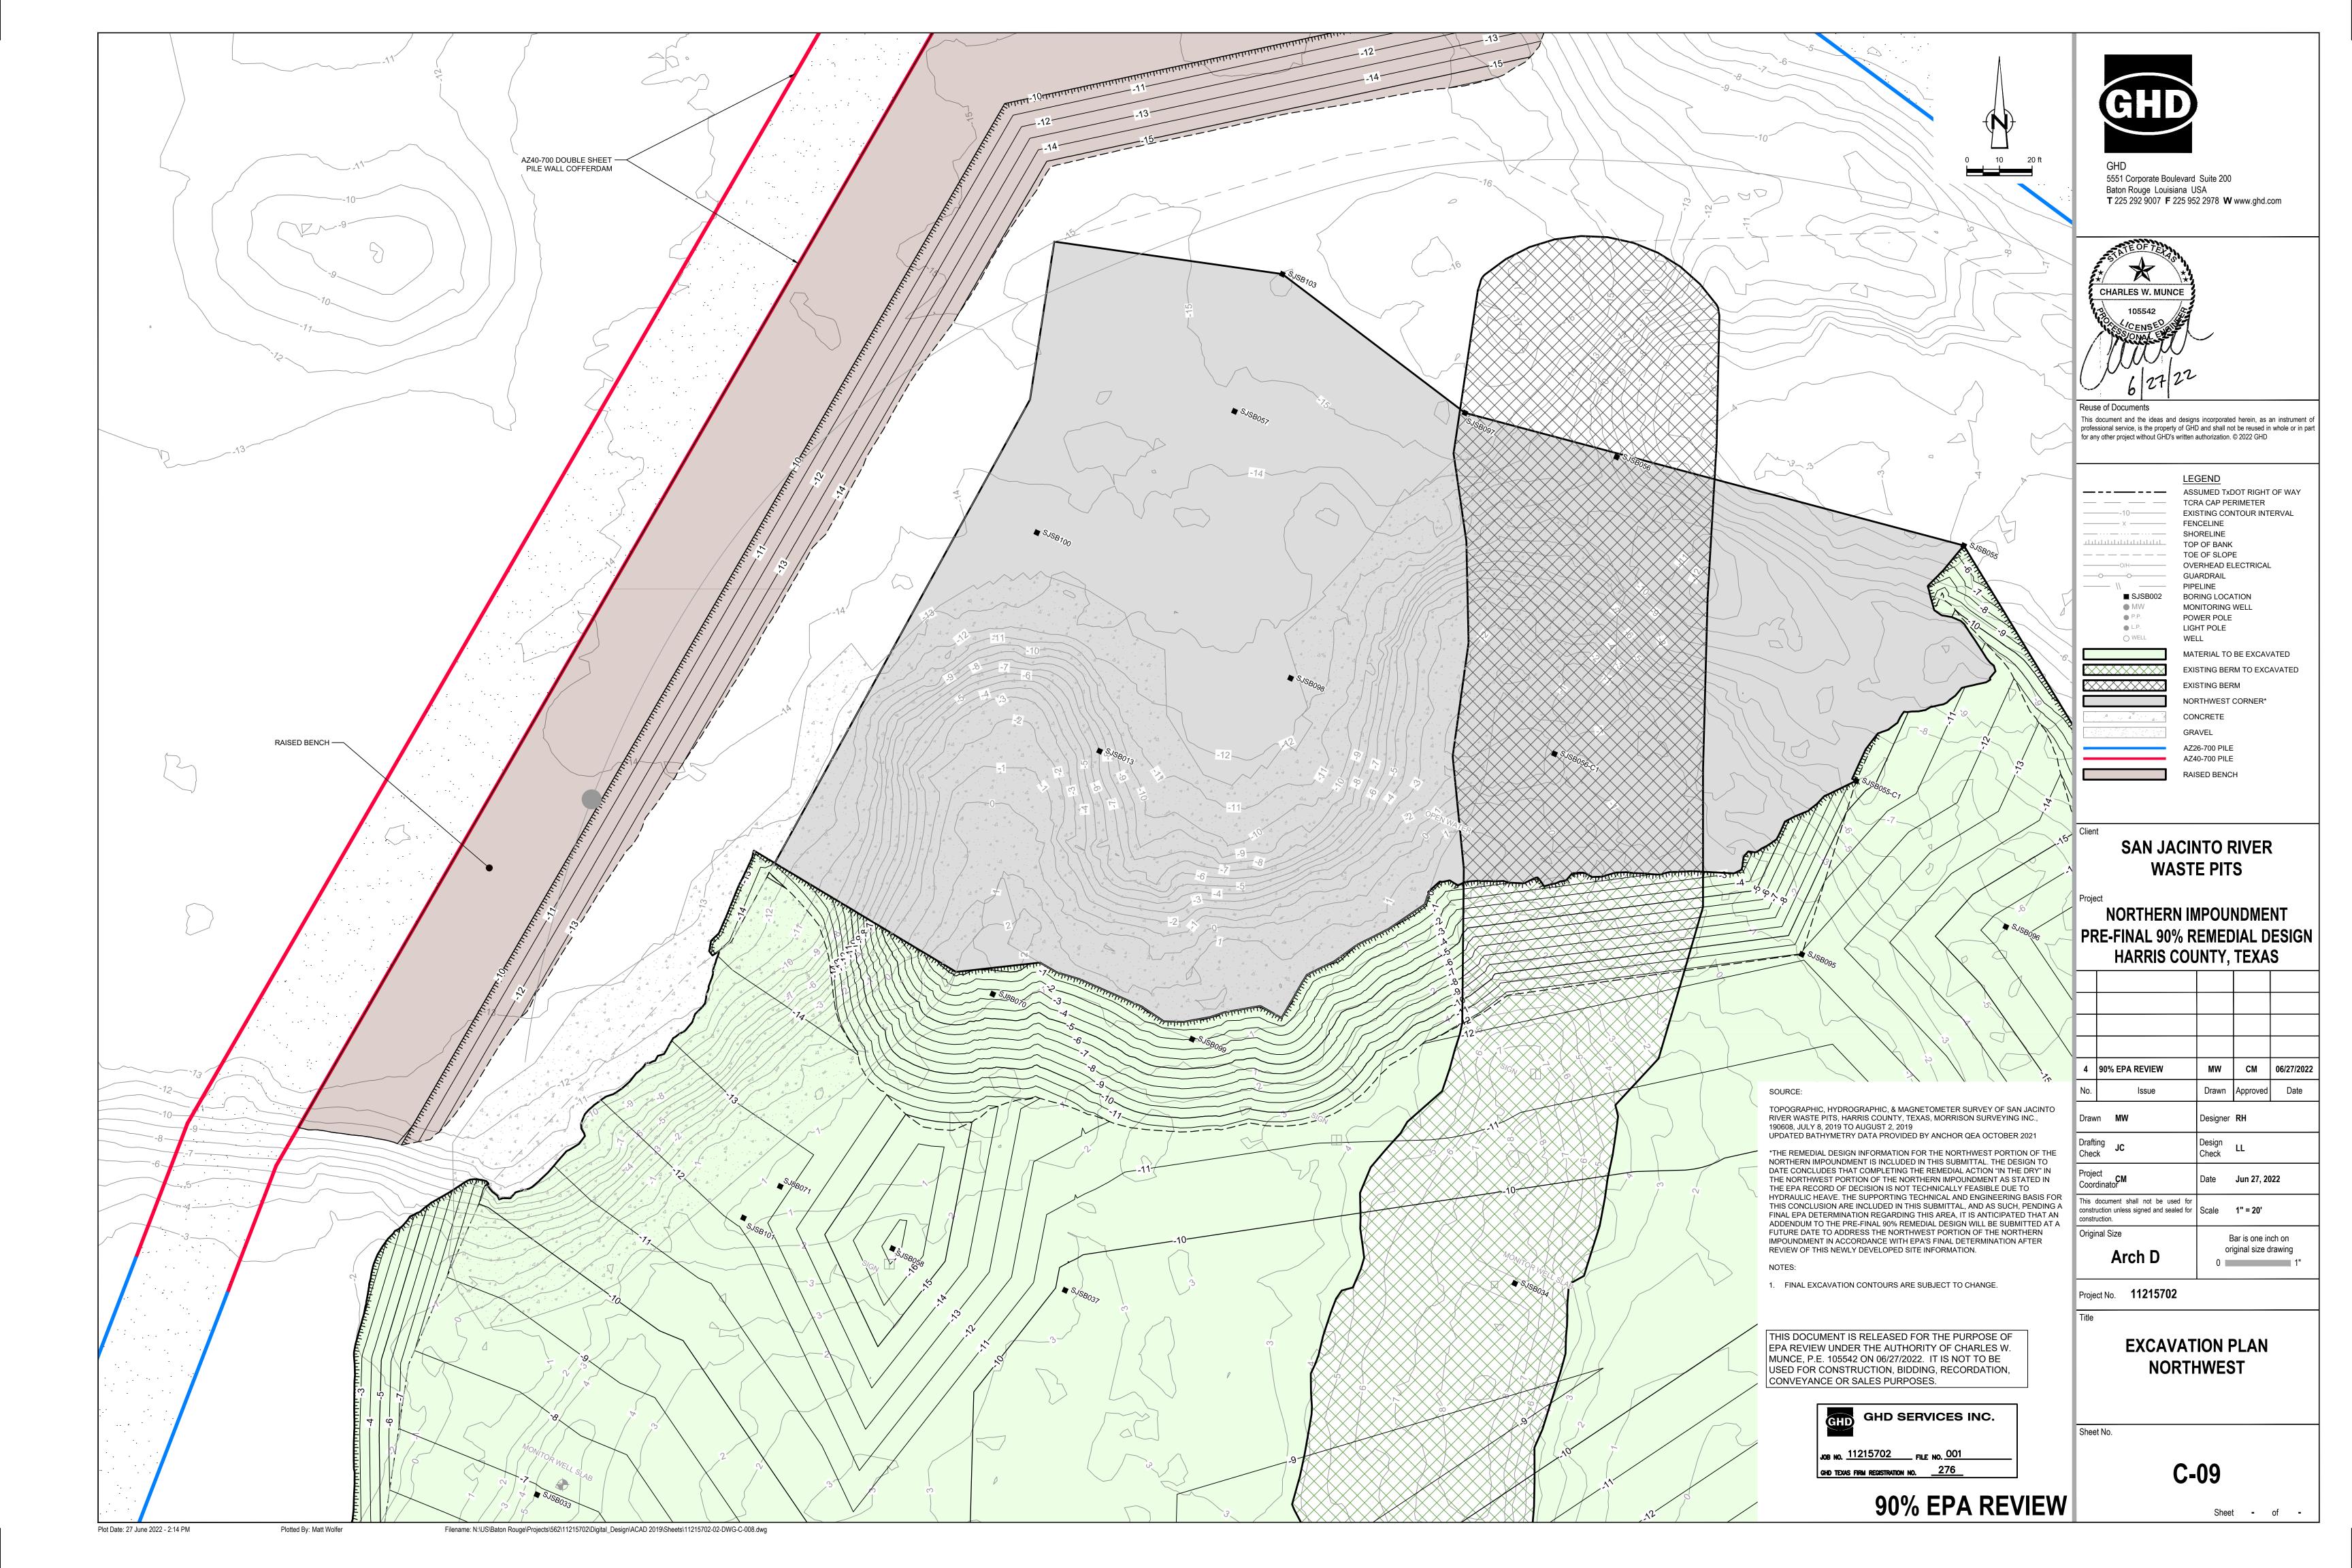1. BOTTOM OF EXCAVATION IS SUBJECT TO CHANGE.

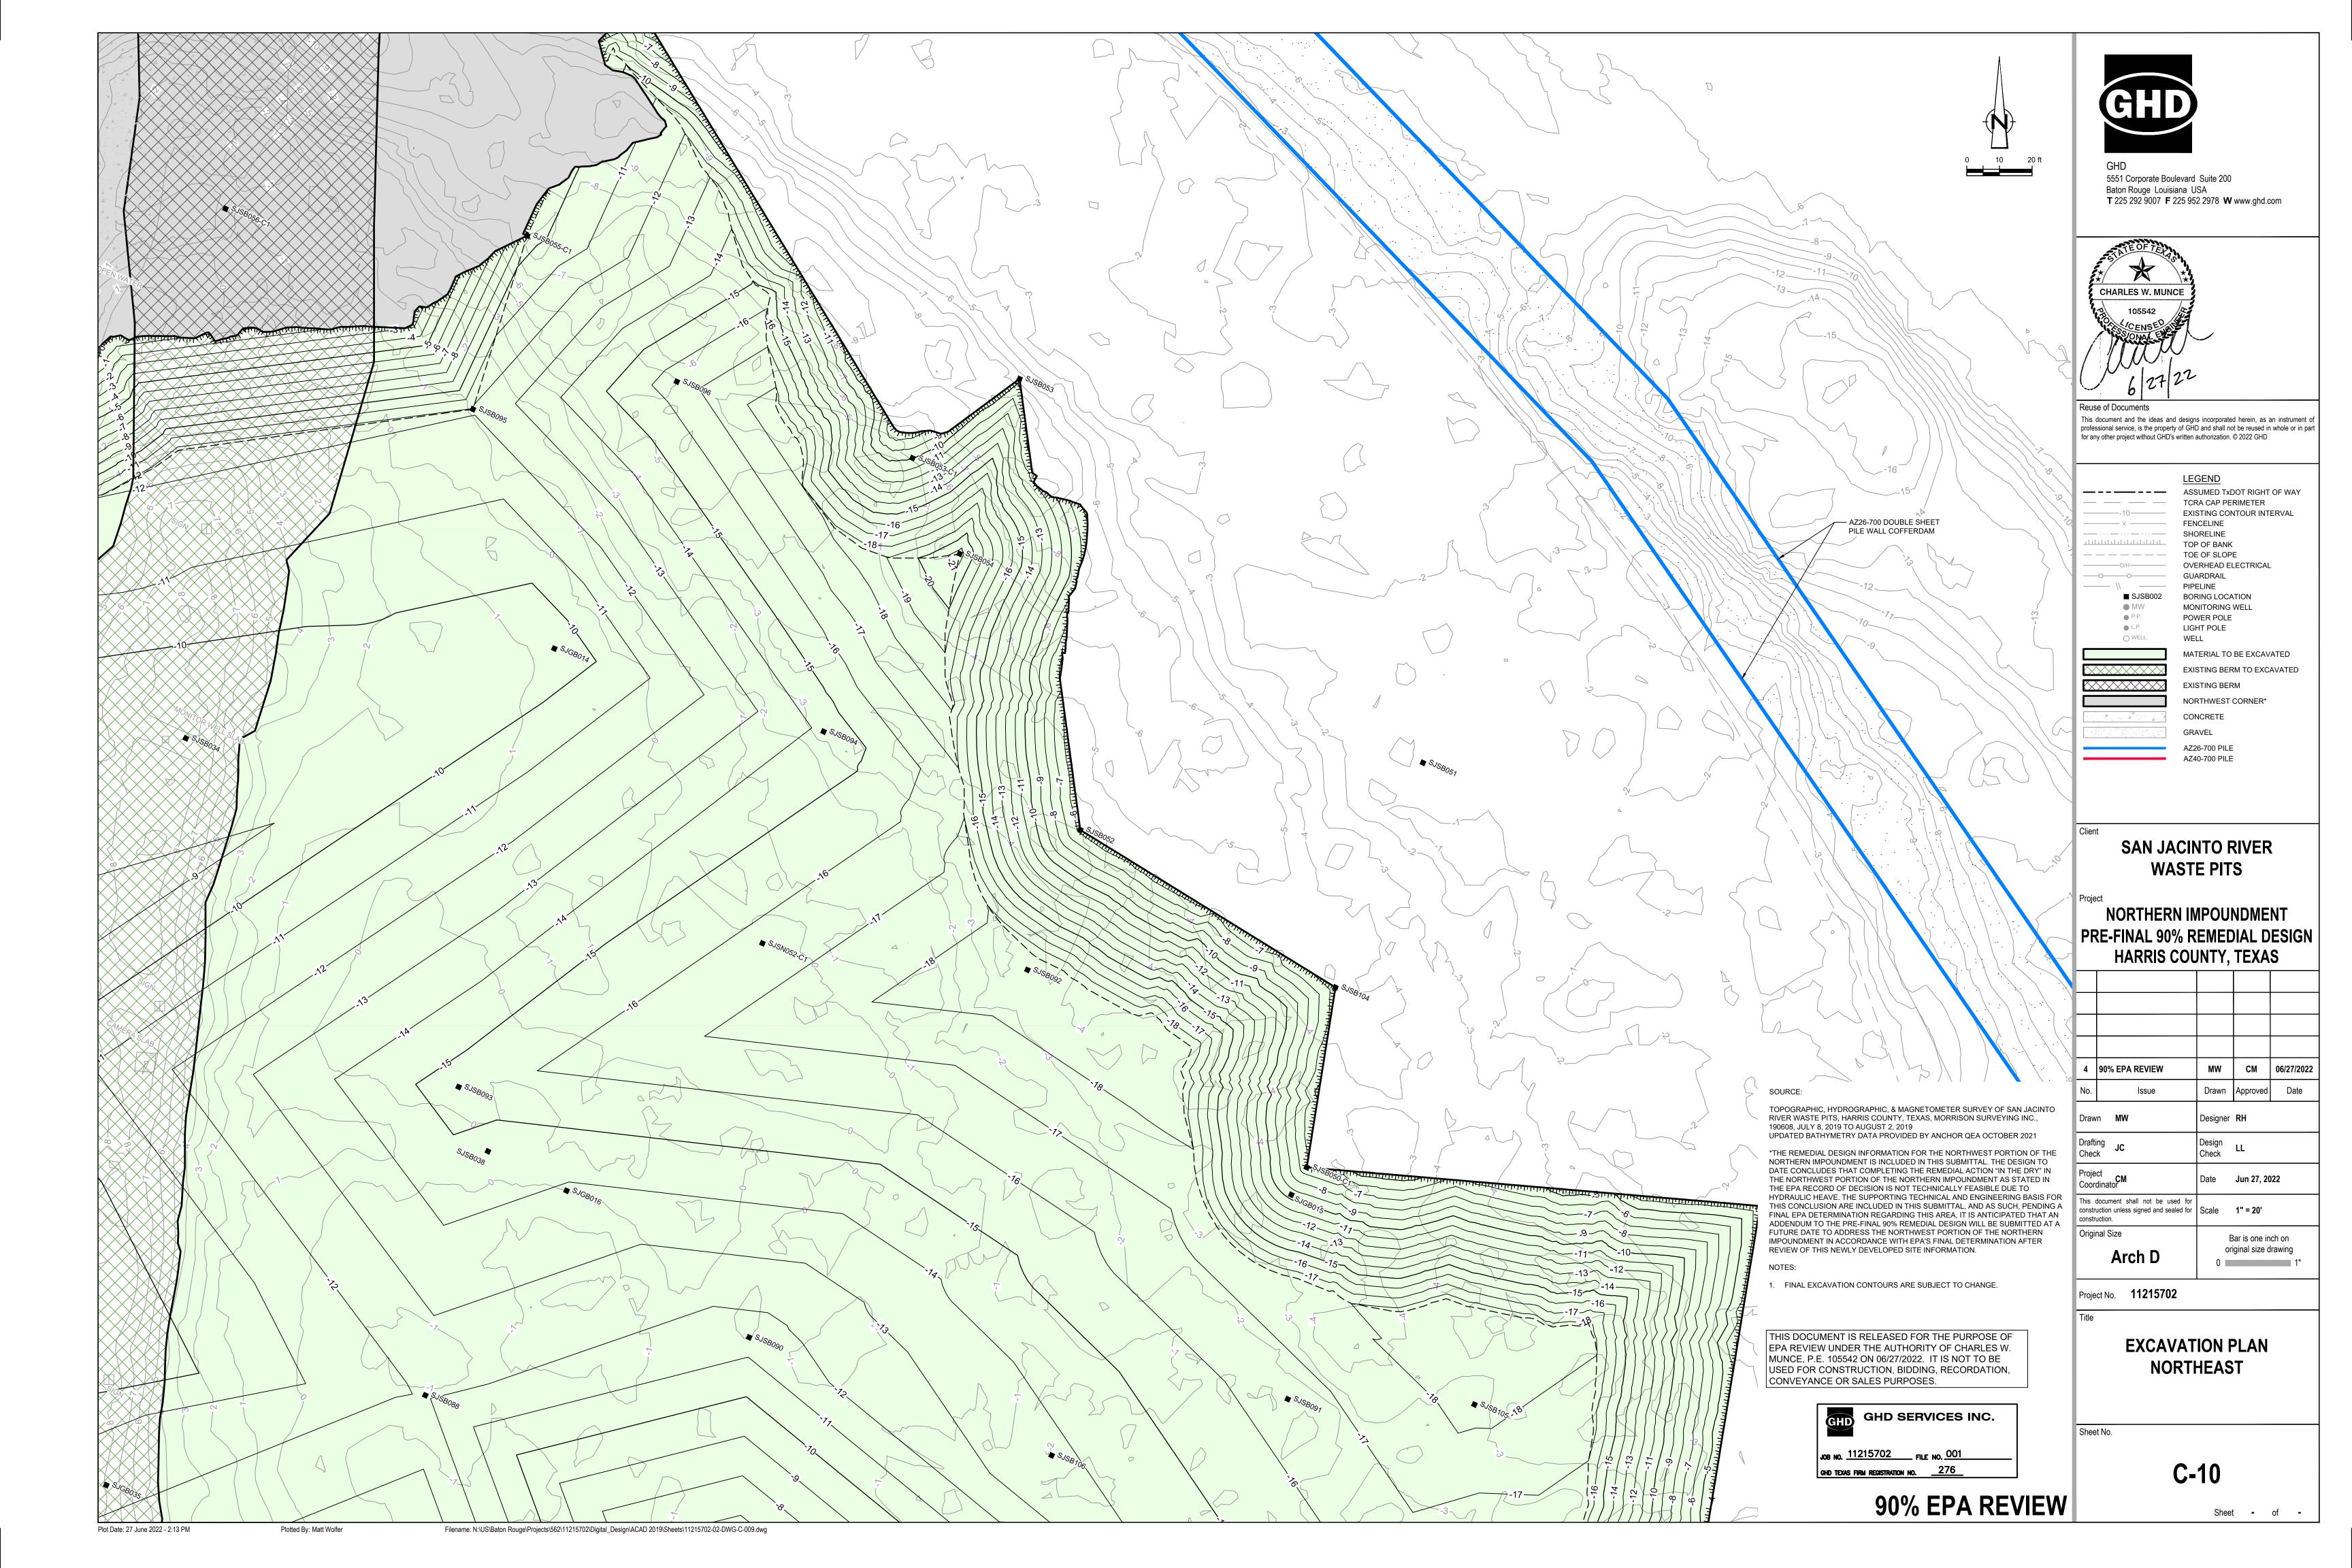
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LEGEND

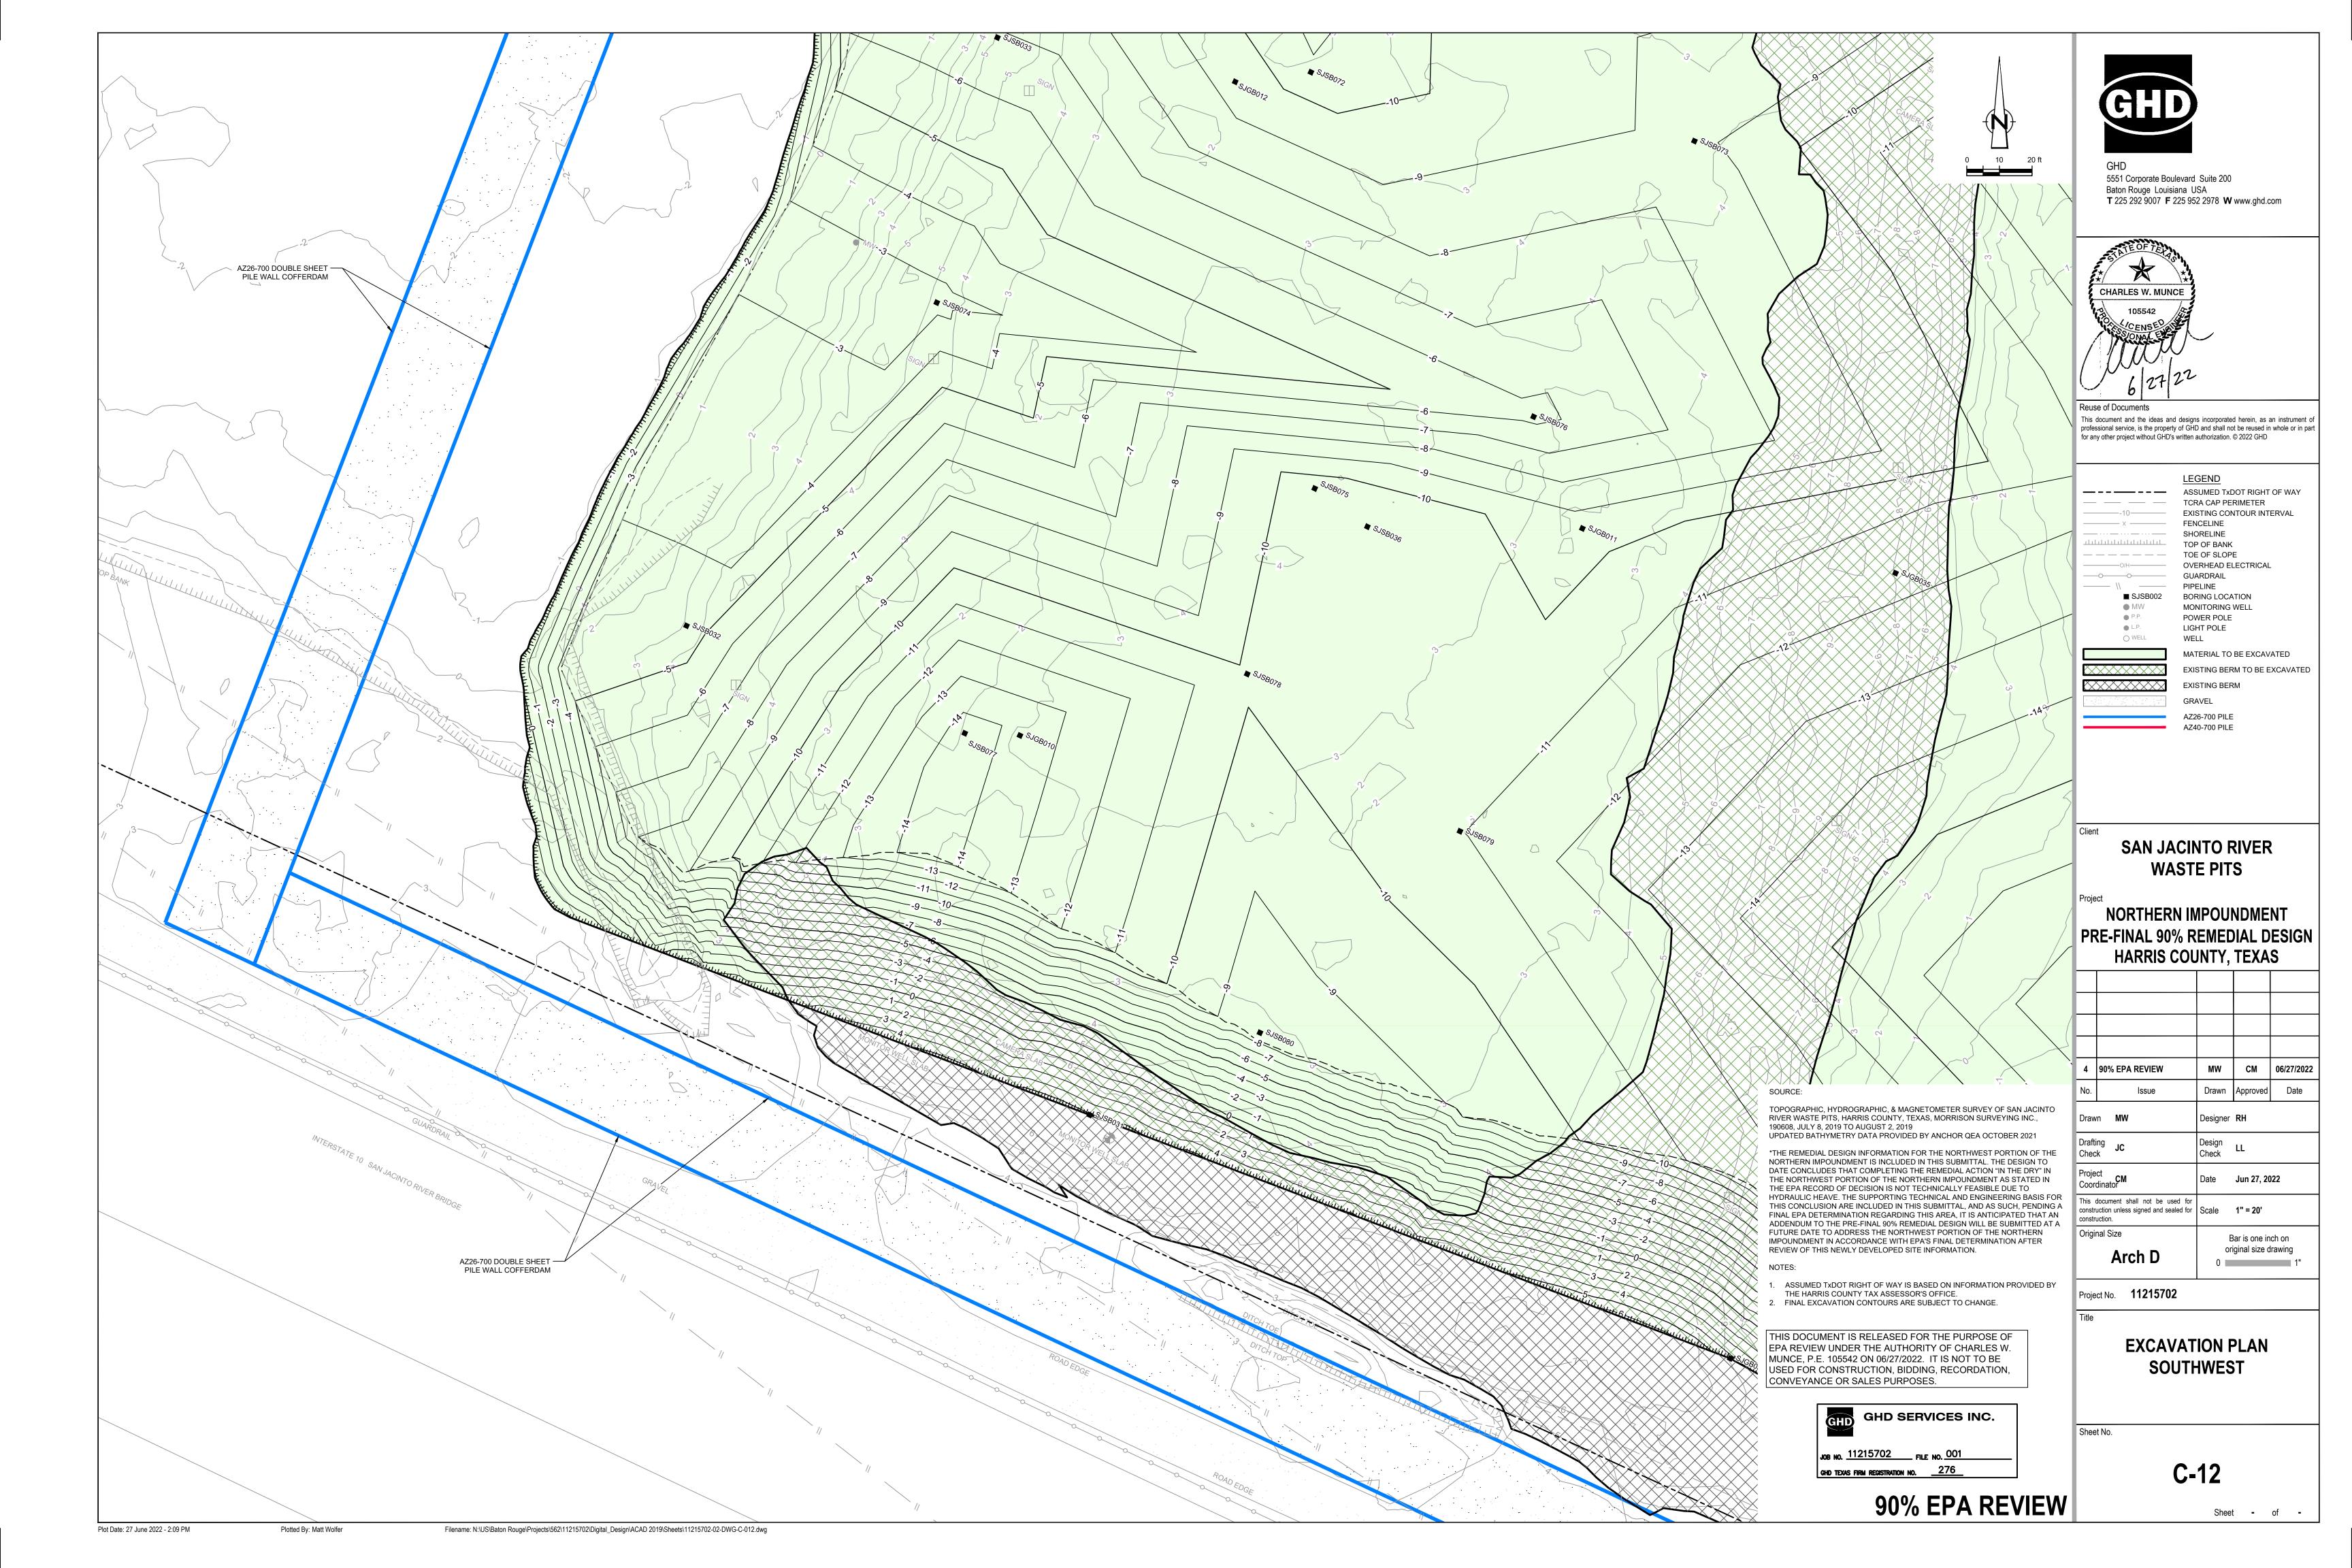MATERIAL T

Client


MATERIAL TO BE EXCAVATED

EXISTING BERM TO BE EXCAVATED

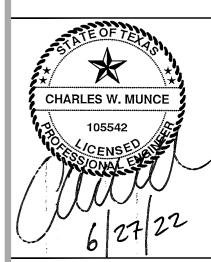BMP SOIL BUTTRESS

SAN JACINTO RIVER WASTE PITS

NORTHERN IMPOUNDMENT
PRE-FINAL 90% REMEDIAL DESIGN
HARRIS COUNTY, TEXAS

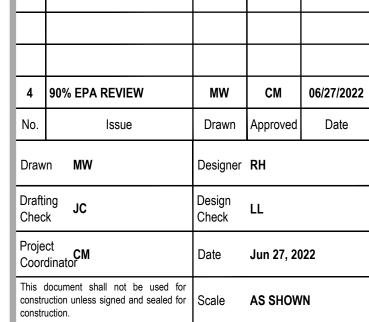

Original Size

Arch D

Bar is one inch on original size drawing 0

Project No. **11215702**

Title

EXCAVATION SECTION 1 OF 6

Sheet No.


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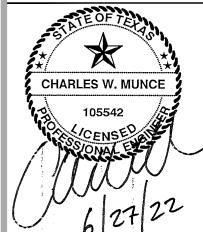
Plotted By: Matt Wolfer

Filename: N:\US\Baton Rouge\Projects\562\11215702\Digital_Design\ACAD 2019\Sheets\11215702-02-DWG-C-013.dwg



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LEGEND


MATERIAL T

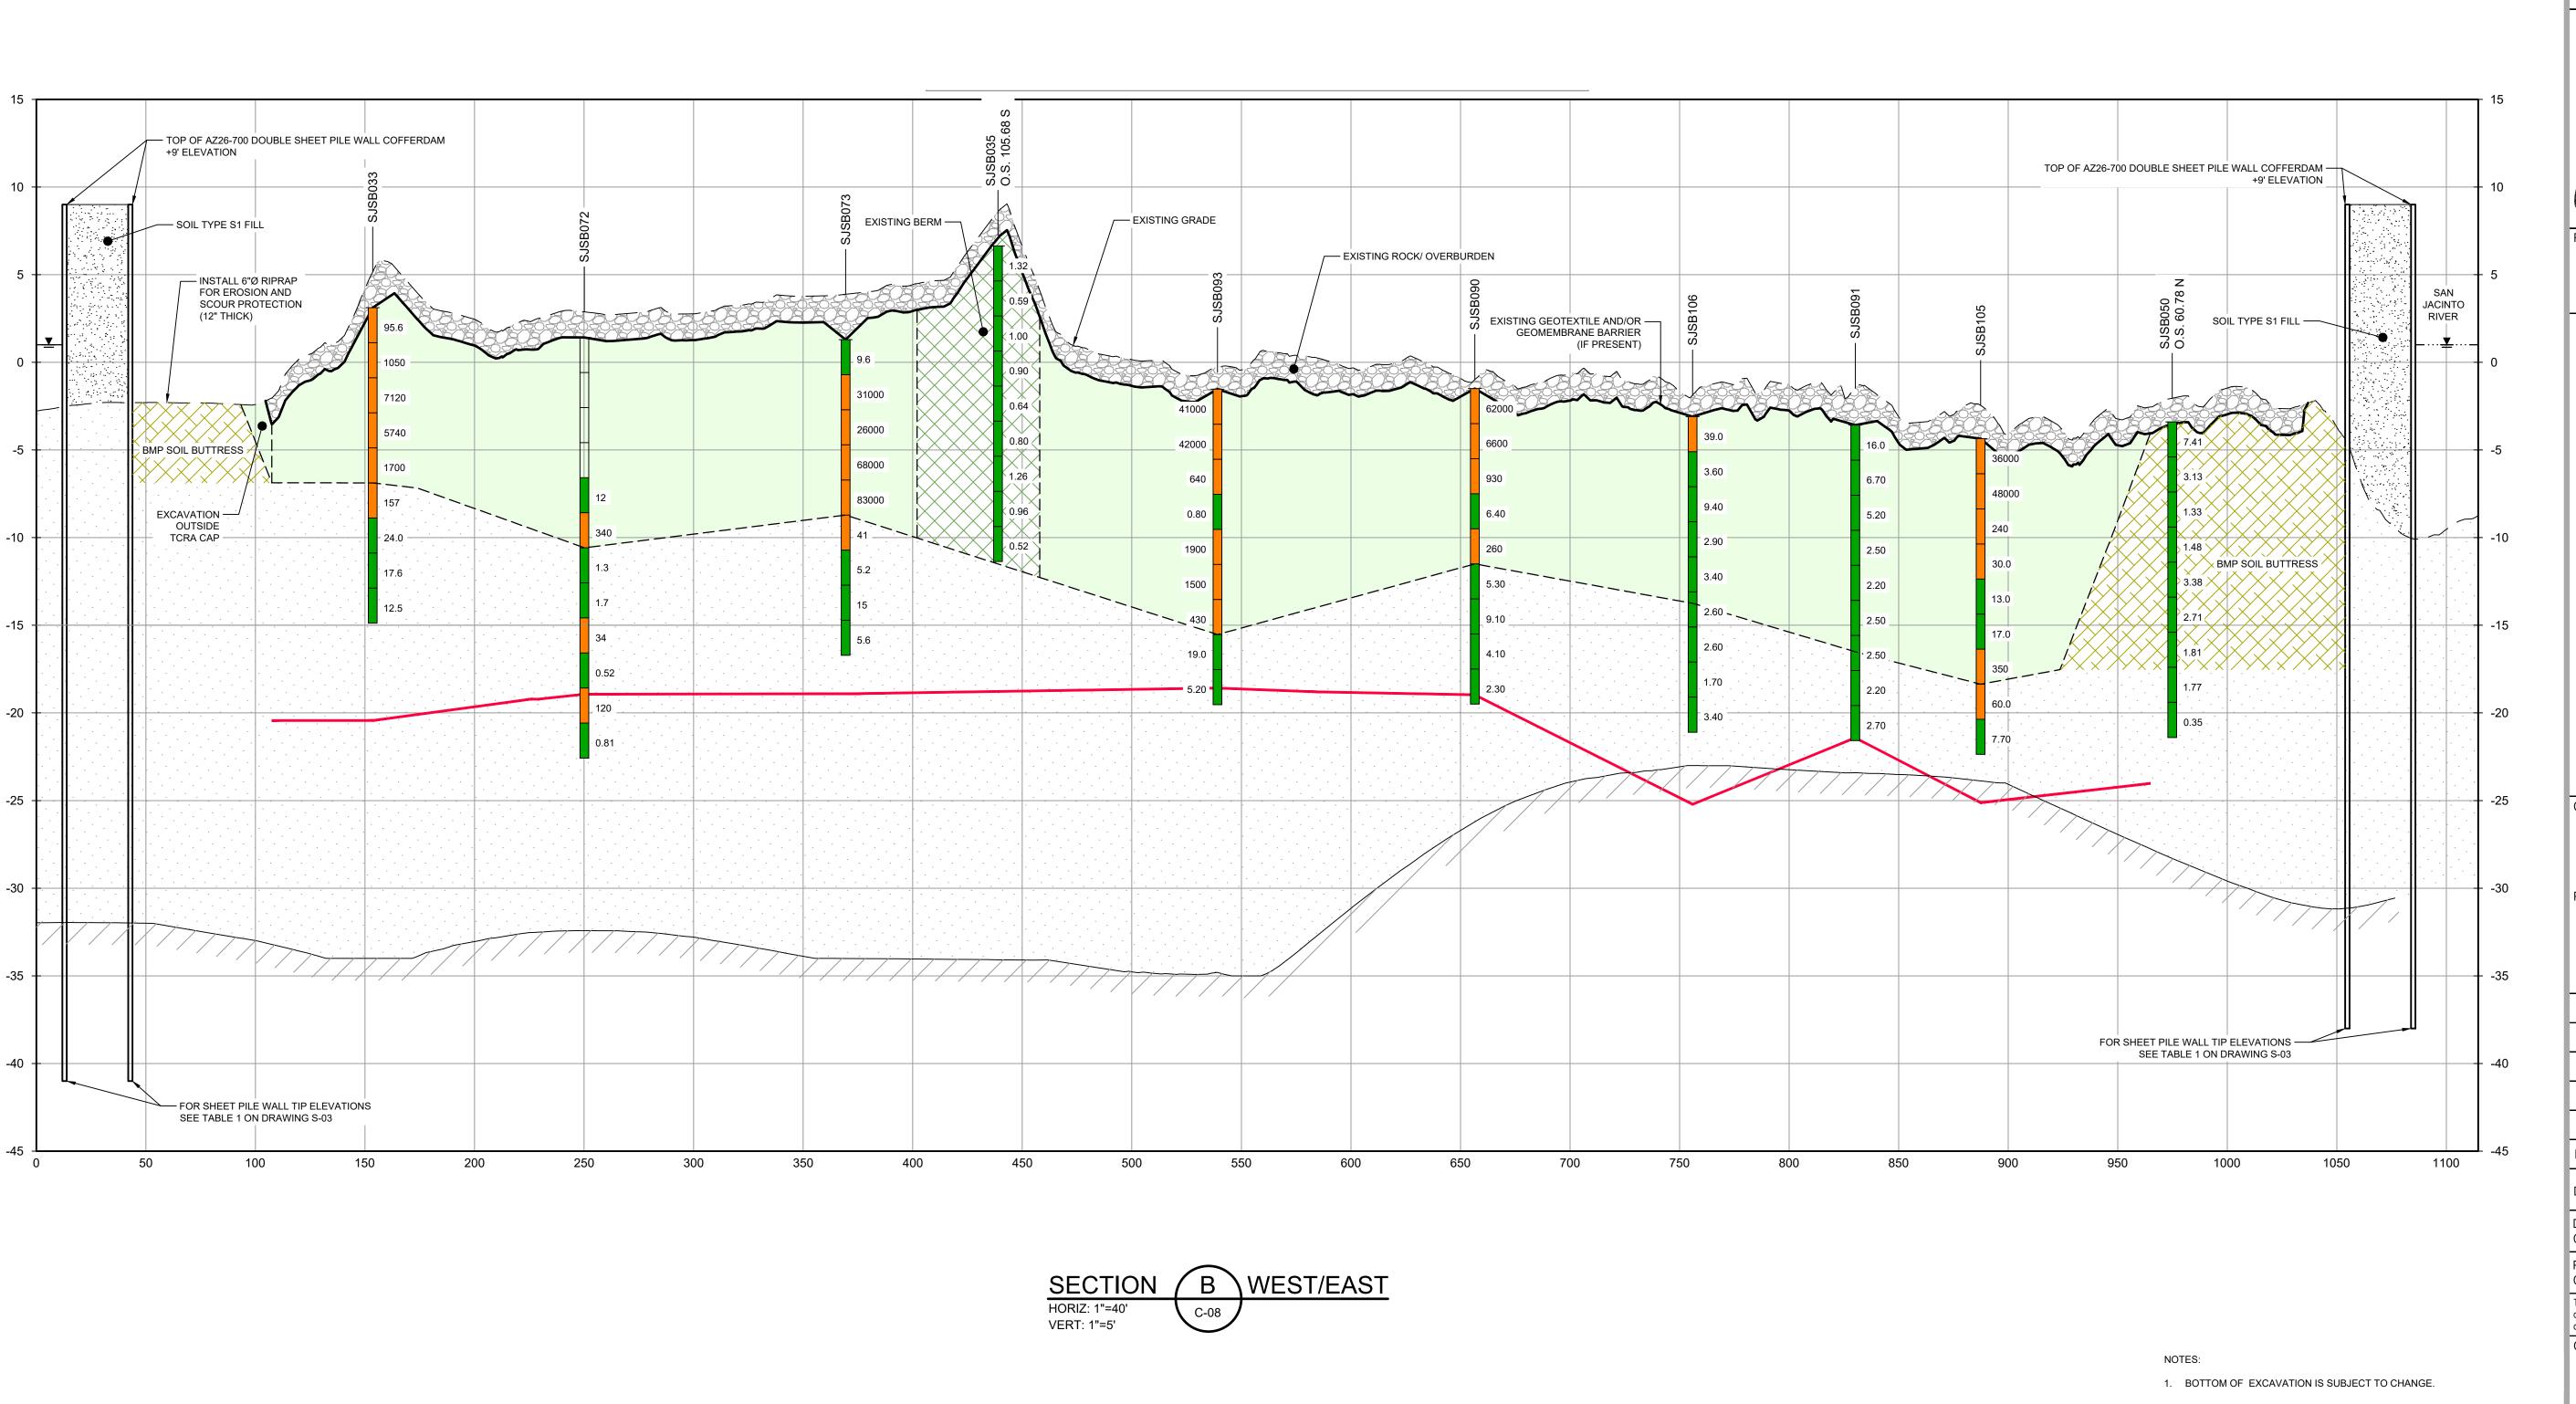EXISTING BE

MATERIAL TO BE EXCAVATED
EXISTING BERM TO BE EXCAVATED
BMP SOIL BUTTRESS

SAN JACINTO RIVER WASTE PITS

NORTHERN IMPOUNDMENT
PRE-FINAL 90% REMEDIAL DESIGN
HARRIS COUNTY, TEXAS

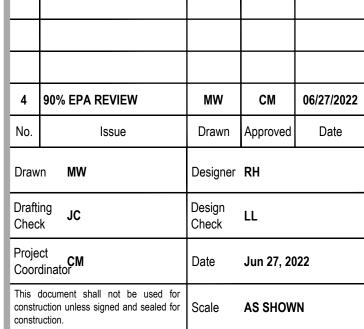

Original Size

Arch D

Bar is one inch on original size drawing

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Project No. **11215702**

EXCAVAT

EXCAVATION SECTION 2 OF 6

Sheet No.

C-14

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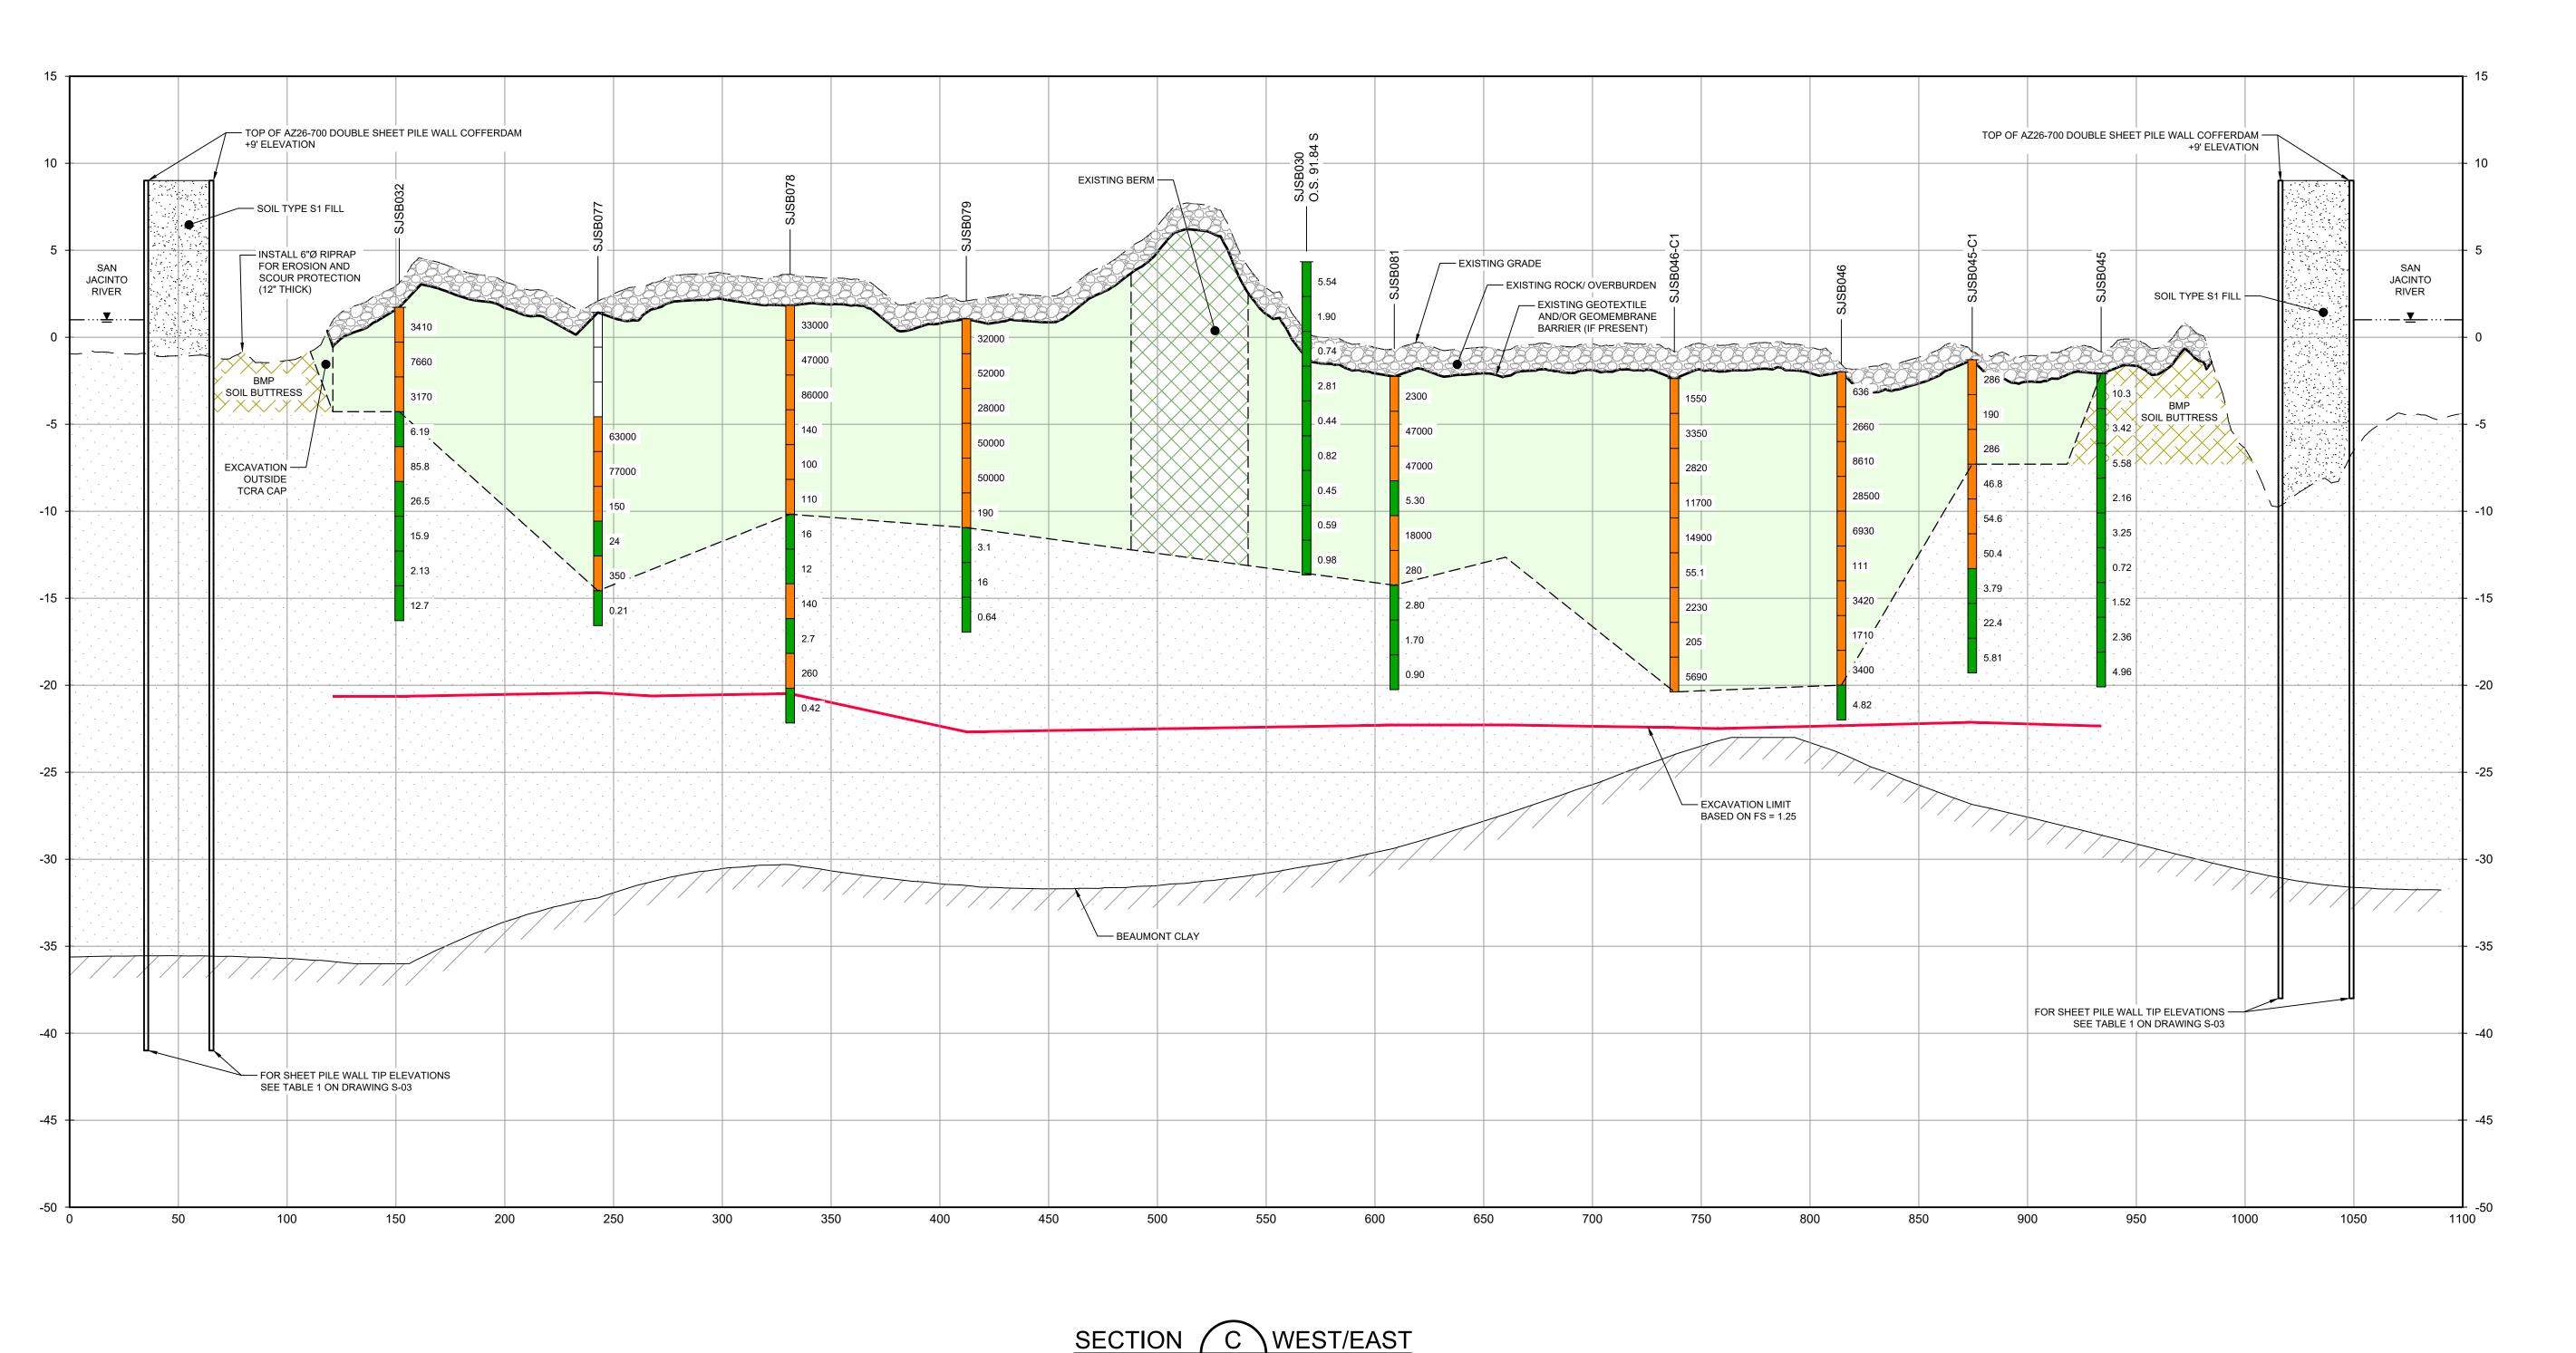
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Plotted By: Matt Wolfer

Filename: N:\US\Baton Rouge\Projects\562\11215702\Digital_Design\ACAD 2019\Sheets\11215702-02-DWG-C-013.dwg



HORIZ: 1"=40'

VERT: 1"=5'

C-08

NOTES:

1. BOTTOM OF EXCAVATION IS SUBJECT TO CHANGE.


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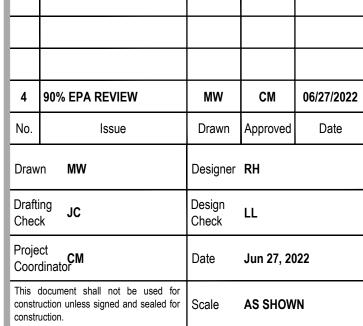
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<u>LEGEND</u>

MATERIAL TO BE EXCAVATED EXISTING BERM TO BE EXCAVATED BMP SOIL BUTTRESS

SAN JACINTO RIVER WASTE PITS

NORTHERN IMPOUNDMENT PRE-FINAL 90% REMEDIAL DESIGN HARRIS COUNTY, TEXAS

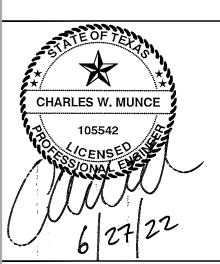


Original Size Bar is one inch on original size drawing Arch D 0 ______1"

Project No. **11215702**

EXCAVATION SECTION 3 OF 6

Sheet No.

C-15

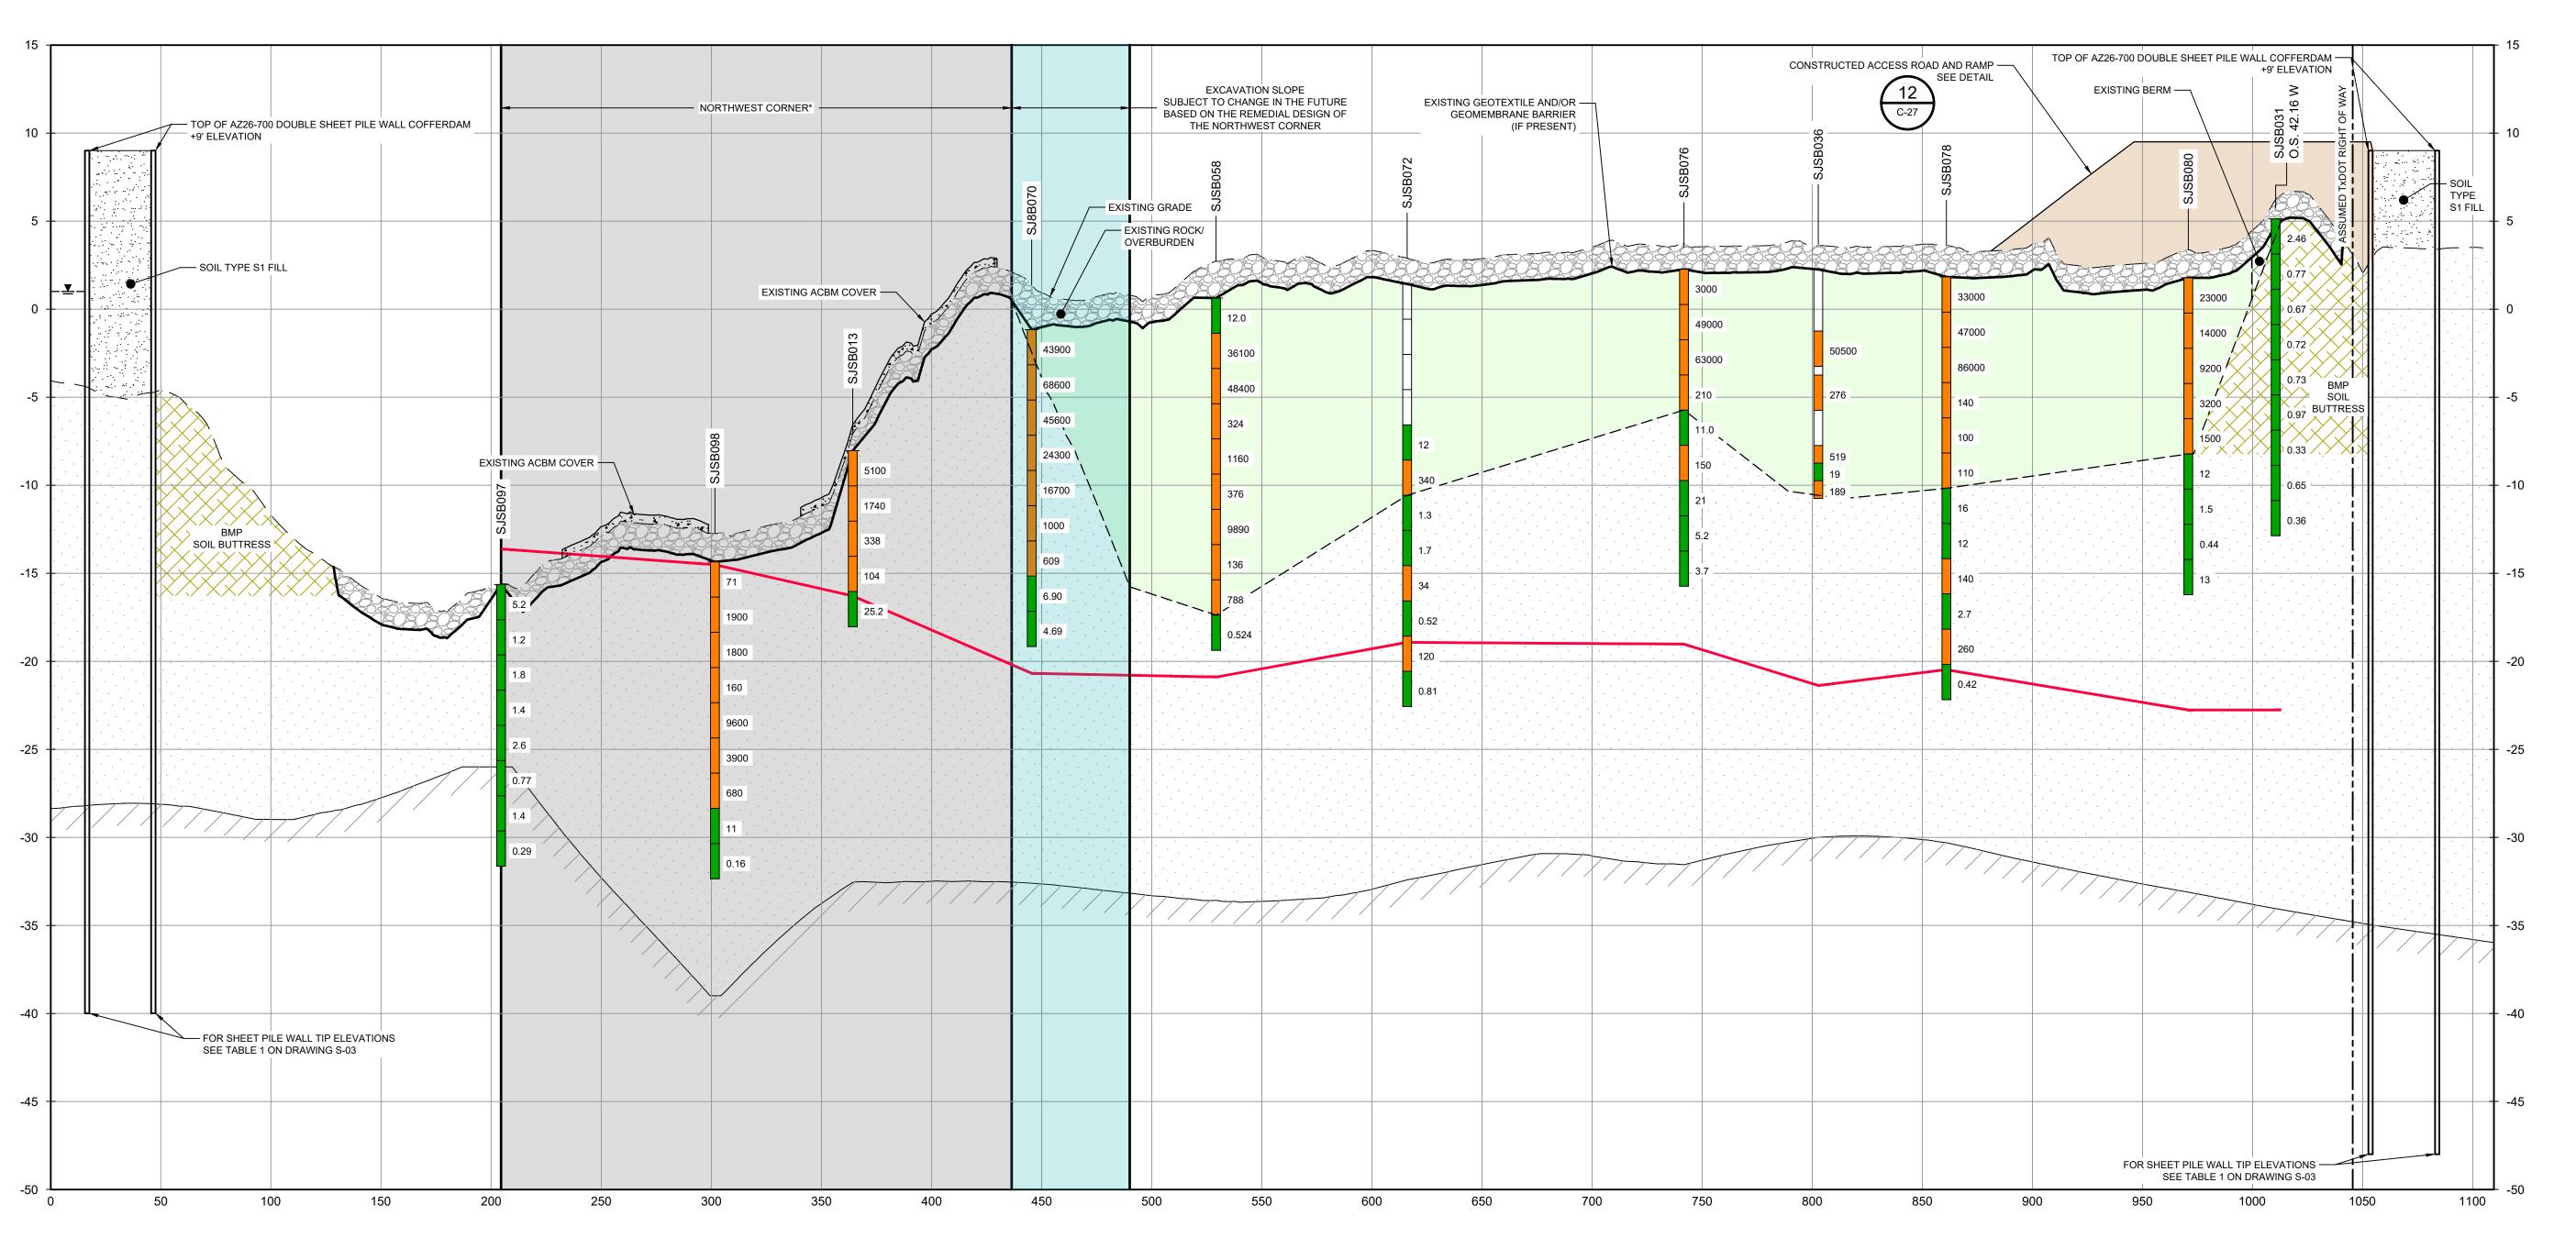

D NORTH/SOUTH C-08 VERT: 1"=5'

*THE REMEDIAL DESIGN INFORMATION FOR THE NORTHWEST PORTION OF THE NORTHERN IMPOUNDMENT IS INCLUDED IN THIS SUBMITTAL. THE DESIGN TO DATE CONCLUDES THAT COMPLETING THE REMEDIAL ACTION "IN THE DRY" IN THE NORTHWEST PORTION OF THE NORTHERN IMPOUNDMENT AS STATED IN THE EPA RECORD OF DECISION IS NOT TECHNICALLY FEASIBLE DUE TO HYDRAULIC HEAVE. THE SUPPORTING TECHNICAL AND ENGINEERING BASIS FOR THIS CONCLUSION ARE INCLUDED IN THIS SUBMITTAL, AND AS SUCH, PENDING A FINAL EPA DETERMINATION REGARDING THIS AREA, IT IS ANTICIPATED THAT AN ADDENDUM TO THE PRE-FINAL 90% REMEDIAL DESIGN WILL BE SUBMITTED AT A ADDRESS THE NORTHWEST PORTION OF THE NORTHERN


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NOTES:

- 1. ASSUMED TXDOT RIGHT OF WAY IS BASED ON INFORMATION PROVIDED BY THE HARRIS COUNTY TAX ASSESSOR'S OFFICE.

 2. BOTTOM OF EXCAVATION IS SUBJECT TO CHANGE.


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LEGEND

MATERIAL TO BE EXCAVATED EXISTING BERM TO BE EXCAVATED BMP SOIL BUTTRESS PLANNED IMPROVEMENTS FOR NORTHERN IMPOUNDMENT ACCESS

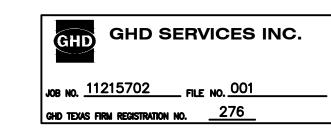SAN JACINTO RIVER WASTE PITS

NORTHERN IMPOUNDMENT PRE-FINAL 90% REMEDIAL DESIGN HARRIS COUNTY, TEXAS

4	90% EPA REVIEW	MW	СМ	06/27
No.	Issue	Drawn	Approved	Da
Draw	n MW	Designer	RH	
Drafti Chec		Design Check	LL	
Proje	ct CM	Date	Jun 27, 20)22

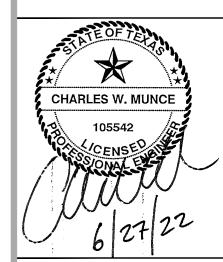
Original Size Bar is one inch on original size drawing Arch D 0 ______ 1"

Project No. **11215702**

EXCAVATION SECTION 4 OF 6

Sheet No.

C-16

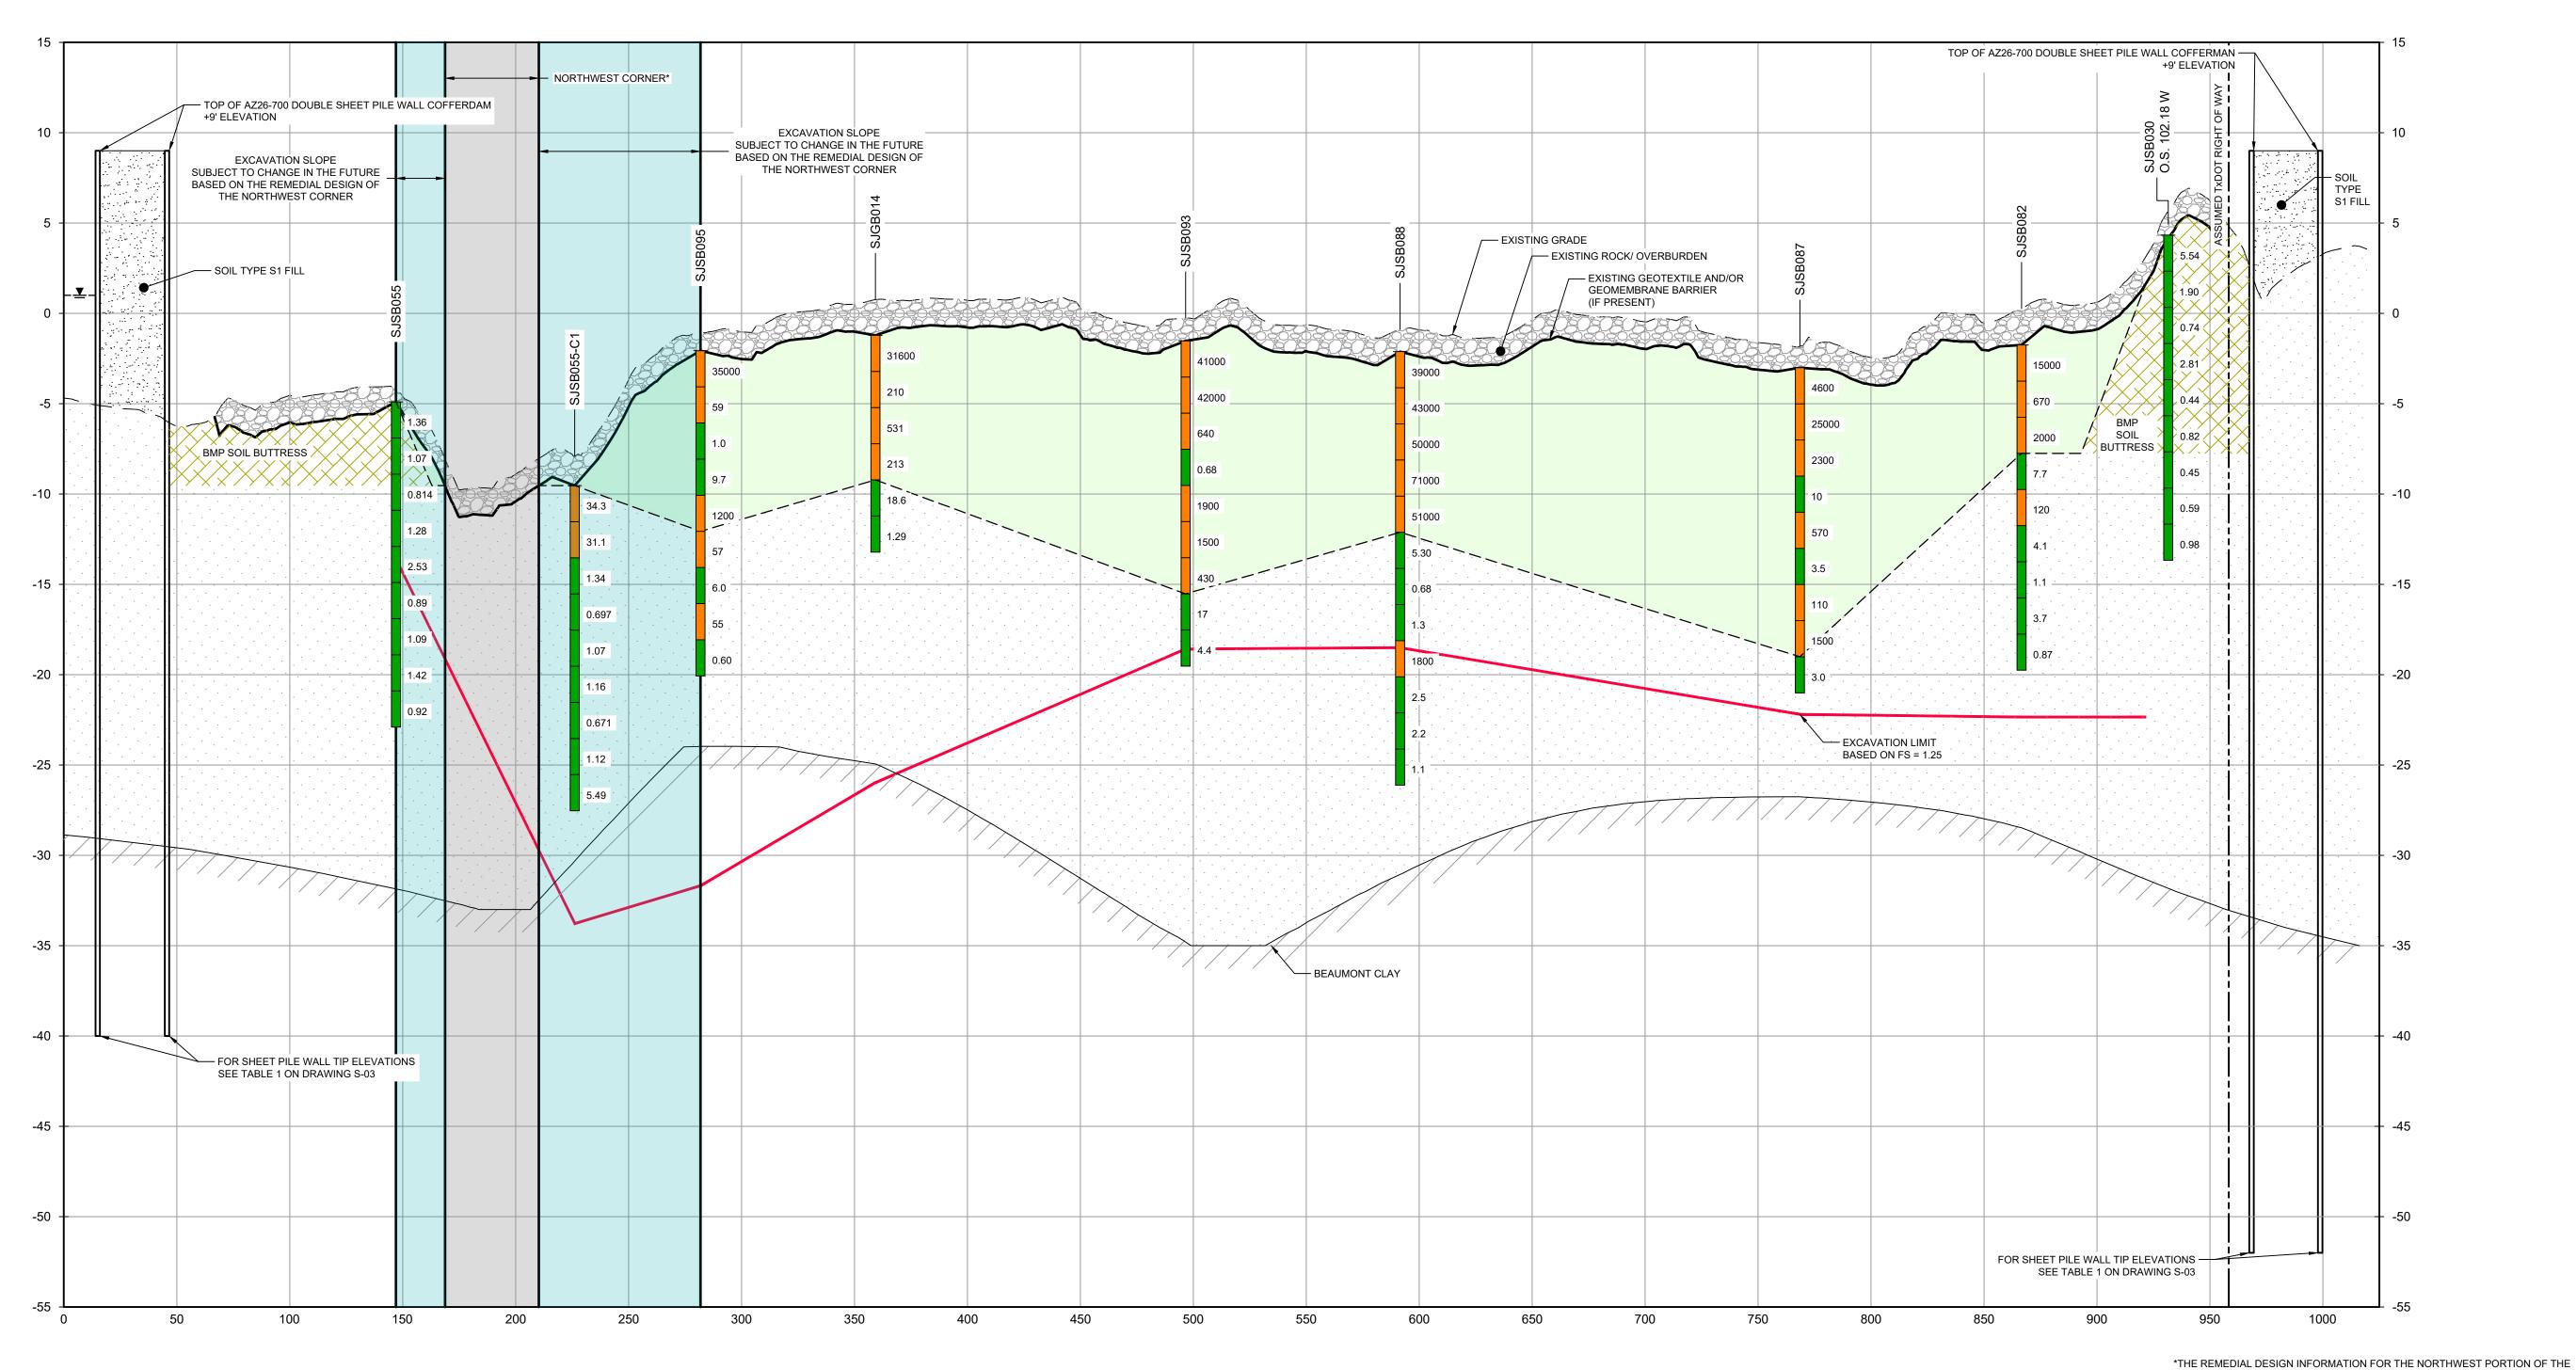

E NORTH/SOUTH C-08 VERT: 1"=5'

NORTHERN IMPOUNDMENT IS INCLUDED IN THIS SUBMITTAL. THE DESIGN TO DATE CONCLUDES THAT COMPLETING THE REMEDIAL ACTION "IN THE DRY" IN THE NORTHWEST PORTION OF THE NORTHERN IMPOUNDMENT AS STATED IN THE EPA RECORD OF DECISION IS NOT TECHNICALLY FEASIBLE DUE TO HYDRAULIC HEAVE. THE SUPPORTING TECHNICAL AND ENGINEERING BASIS FOR THIS CONCLUSION ARE INCLUDED IN THIS SUBMITTAL, AND AS SUCH, PENDING A FINAL EPA DETERMINATION REGARDING THIS AREA, IT IS ANTICIPATED THAT AN ADDENDUM TO THE PRE-FINAL 90% REMEDIAL DESIGN WILL BE SUBMITTED AT A FUTURE DATE TO ADDRESS THE NORTHWEST PORTION OF THE NORTHERN IMPOUNDMENT IN ACCORDANCE WITH EPA'S FINAL DETERMINATION AFTER REVIEW OF THIS NEWLY DEVELOPED SITE INFORMATION.

NOTES:

- 1. ASSUMED TXDOT RIGHT OF WAY IS BASED ON INFORMATION PROVIDED BY THE HARRIS COUNTY TAX ASSESSOR'S OFFICE. 2. BOTTOM OF EXCAVATION IS SUBJECT TO CHANGE.
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MUNCE, P.E. 105542 ON 06/27/2022. IT IS NOT TO BE

CONVEYANCE OR SALES PURPOSES.


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GHD SERVICES INC. JOB NO. 11215702 FILE NO. 001

90% EPA REVIEW



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LEGEND

MATERIAL TO BE EXCAVATED EXISTING BERM TO BE EXCAVATED BMP SOIL BUTTRESS PLANNED IMPROVEMENTS FOR NORTHERN IMPOUNDMENT ACCESS

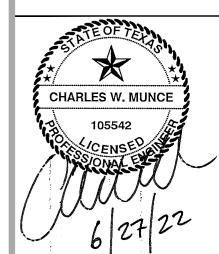SAN JACINTO RIVER

WASTE PITS

NORTHERN IMPOUNDMENT PRE-FINAL 90% REMEDIAL DESIGN HARRIS COUNTY, TEXAS

ı					
	4	90% EPA REVIEW	MW	СМ	06/27/2
ı	No.	Issue	Drawn	Approved	Dat
	Draw	n MW	Designer	RH	
	Drafti Chec	· .II.	Design Check	LL	
2	Project CM Coordinator		Date	Jun 27, 20)22
	This document shall not be used for construction unless signed and sealed for construction.		Scale	AS SHOW	/N


Original Size Bar is one inch on original size drawing Arch D 0 ______ 1"

Project No. **11215702**

EXCAVATION SECTION 5 OF 6

Sheet No.

C-17

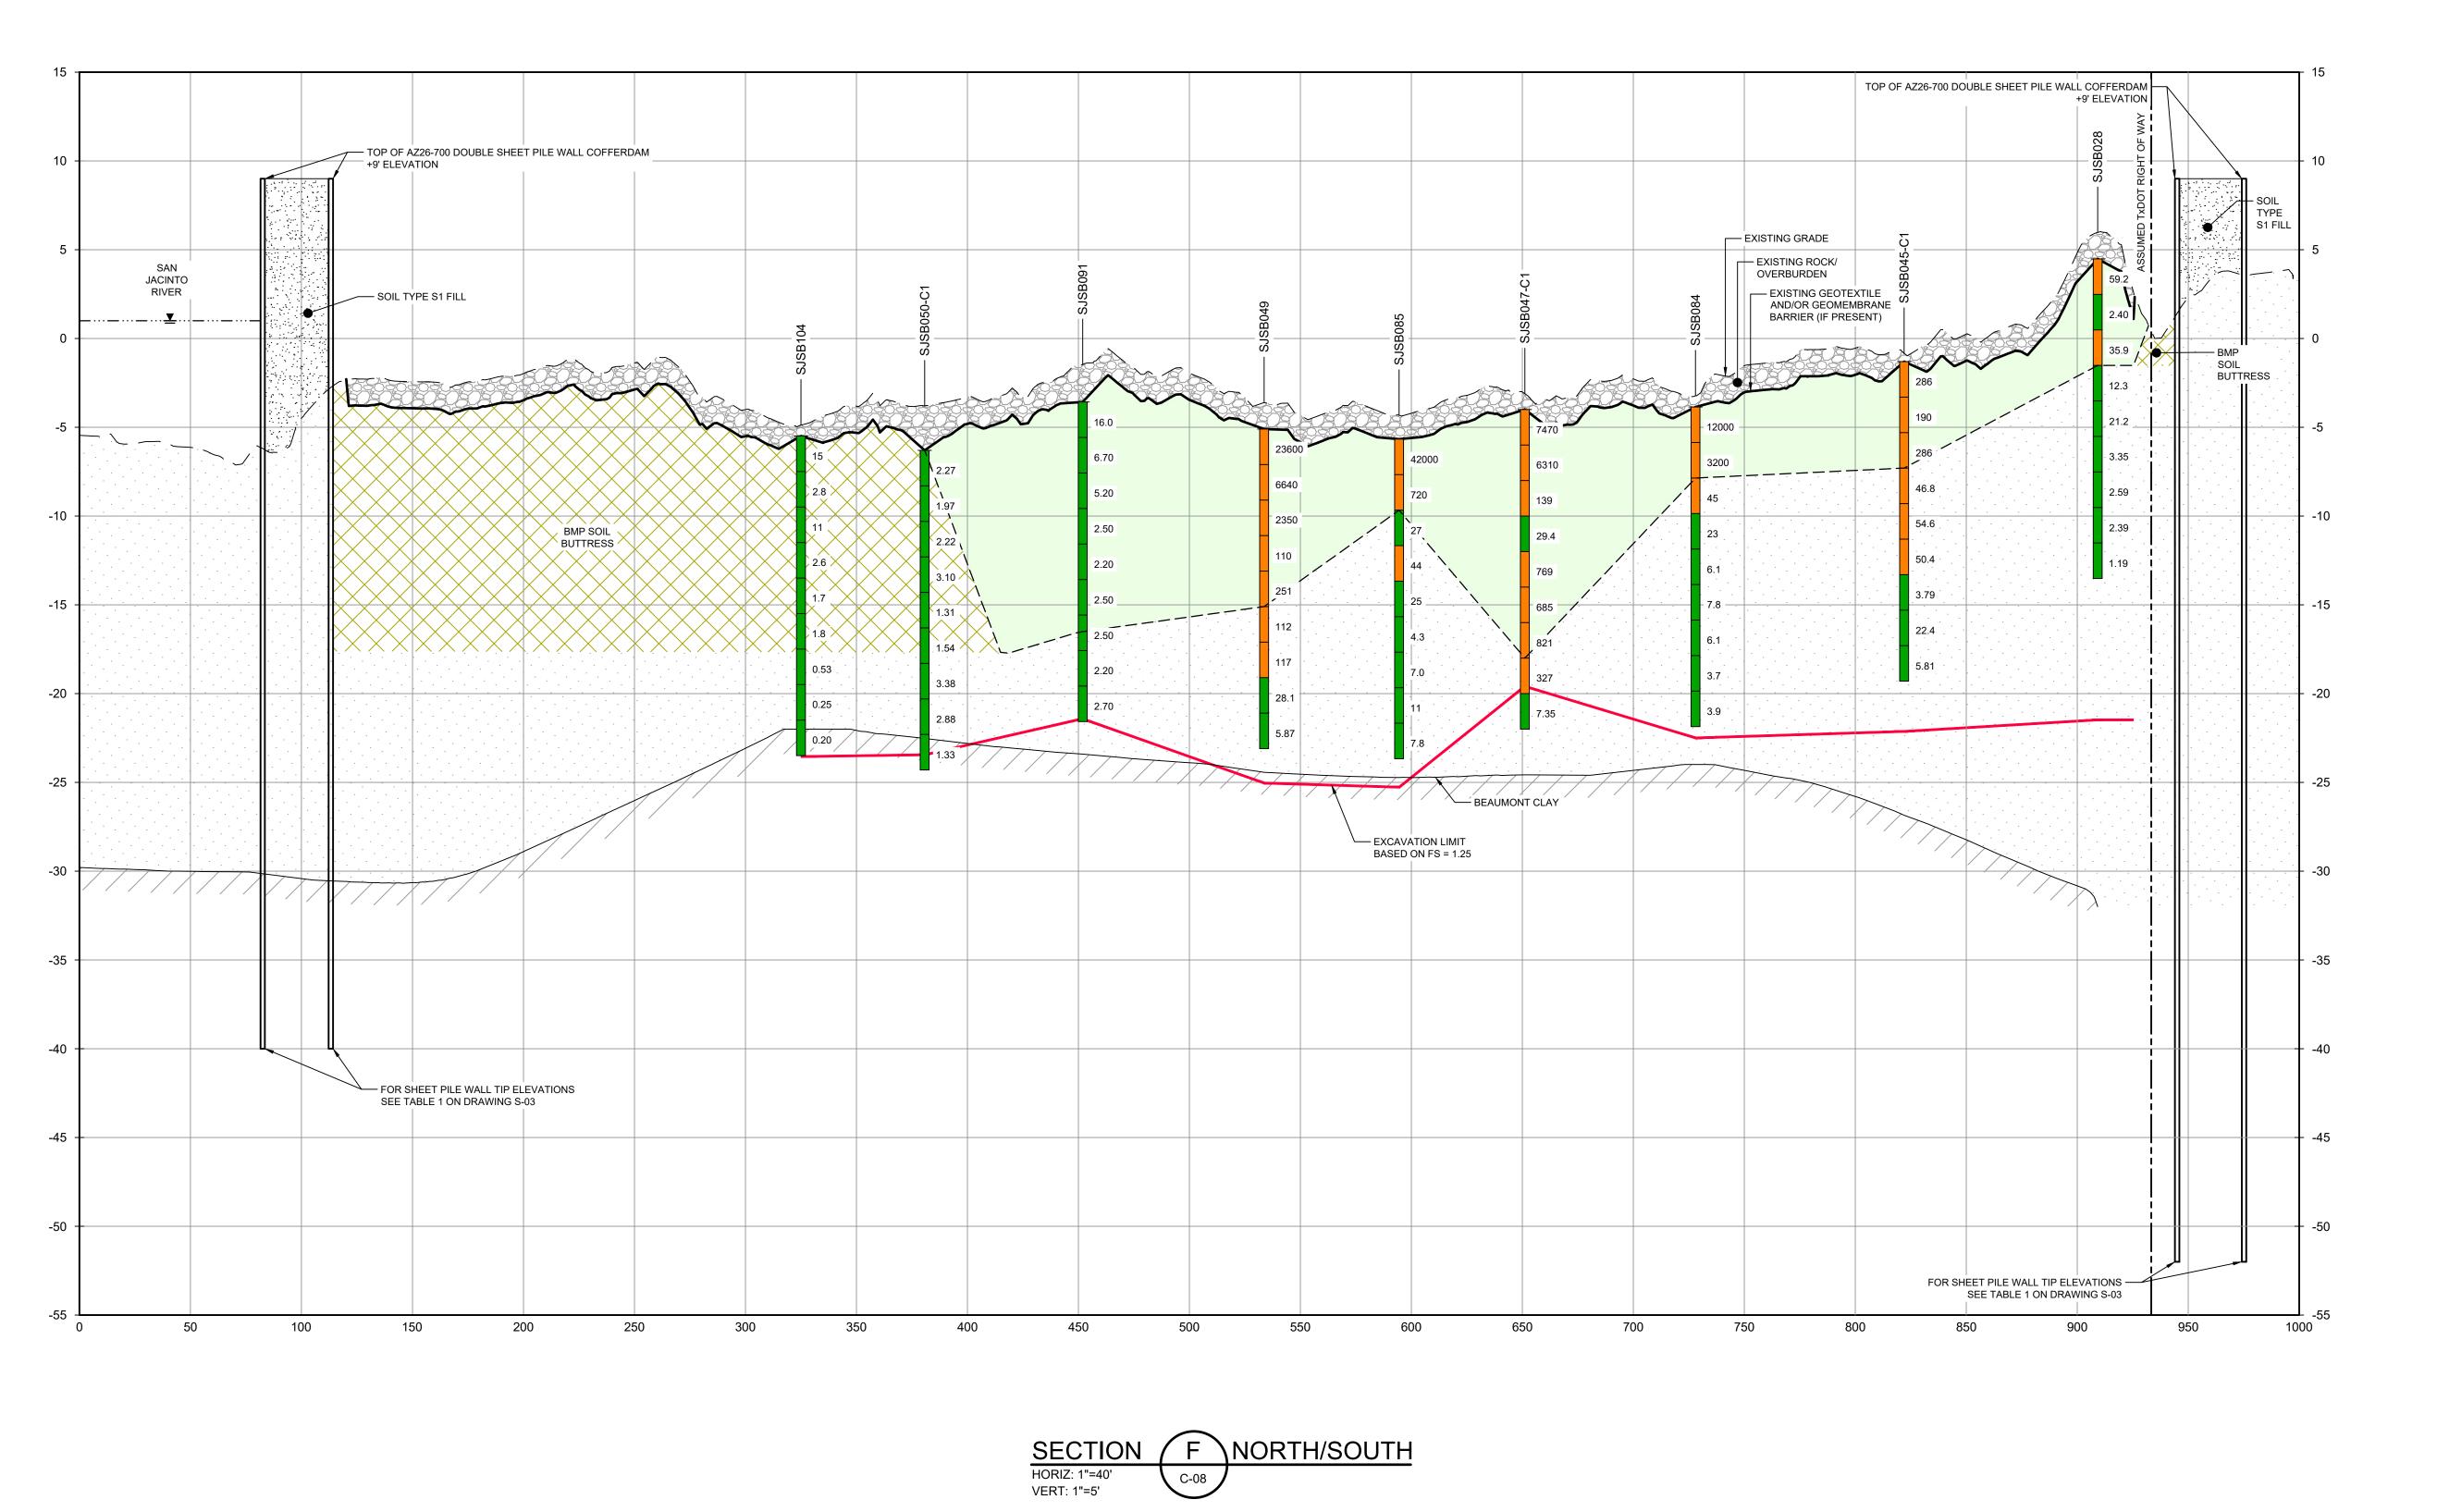

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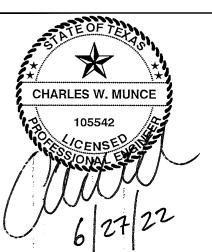
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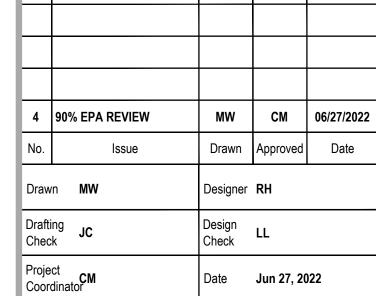
<u>LEGEND</u>

MATERIAL TO BE EXCAVATED BMP SOIL BUTTRESS

SAN JACINTO RIVER WASTE PITS

Client

NORTHERN IMPOUNDMENT PRE-FINAL 90% REMEDIAL DESIGN HARRIS COUNTY, TEXAS



Original Size Bar is one inch on original size drawing Arch D 0 ______1"

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Scale AS SHOWN

Project No. **11215702**

EXCAVATION SECTION 6 OF 6

Sheet No.


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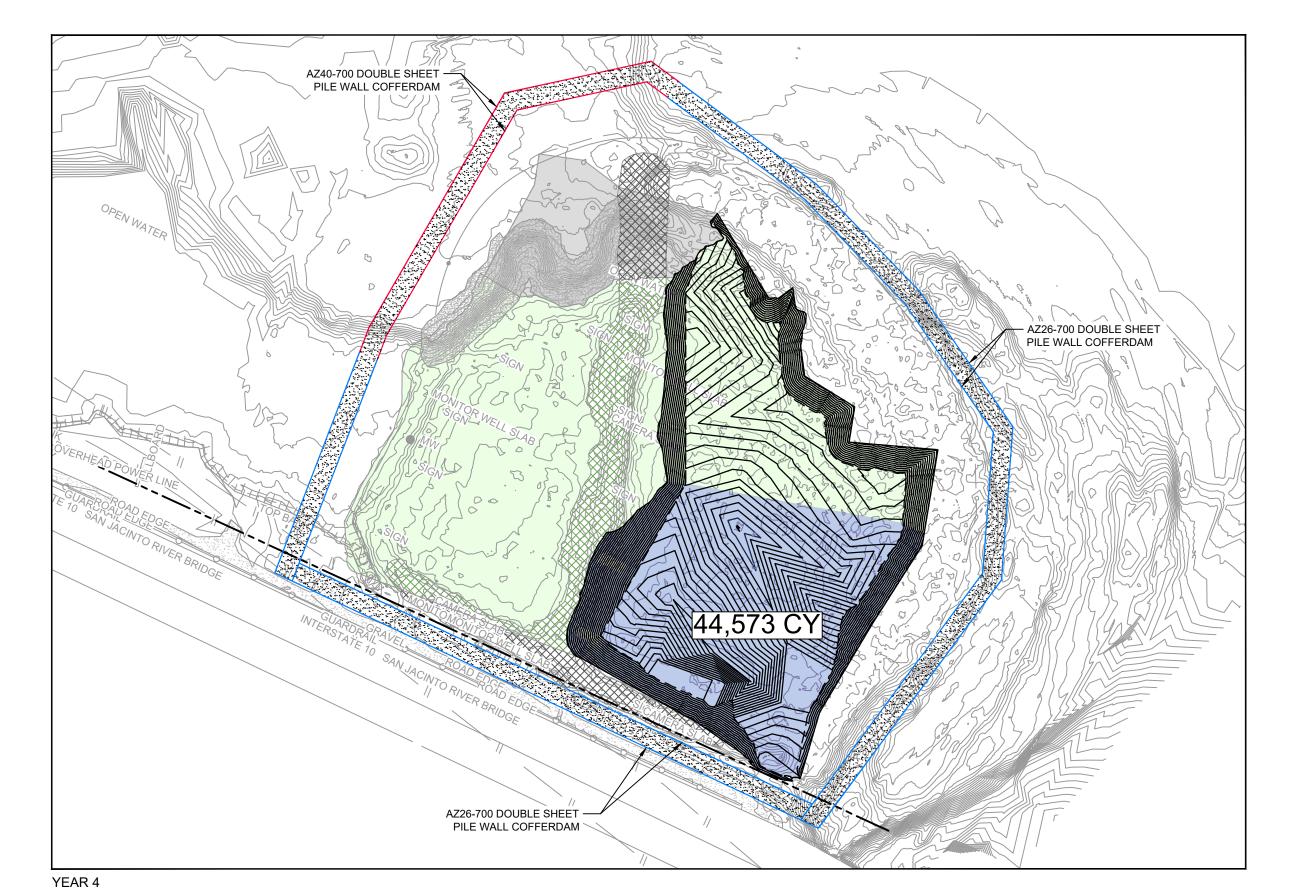
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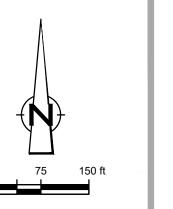
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Plotted By: Matt Wolfer


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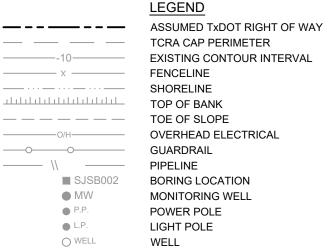






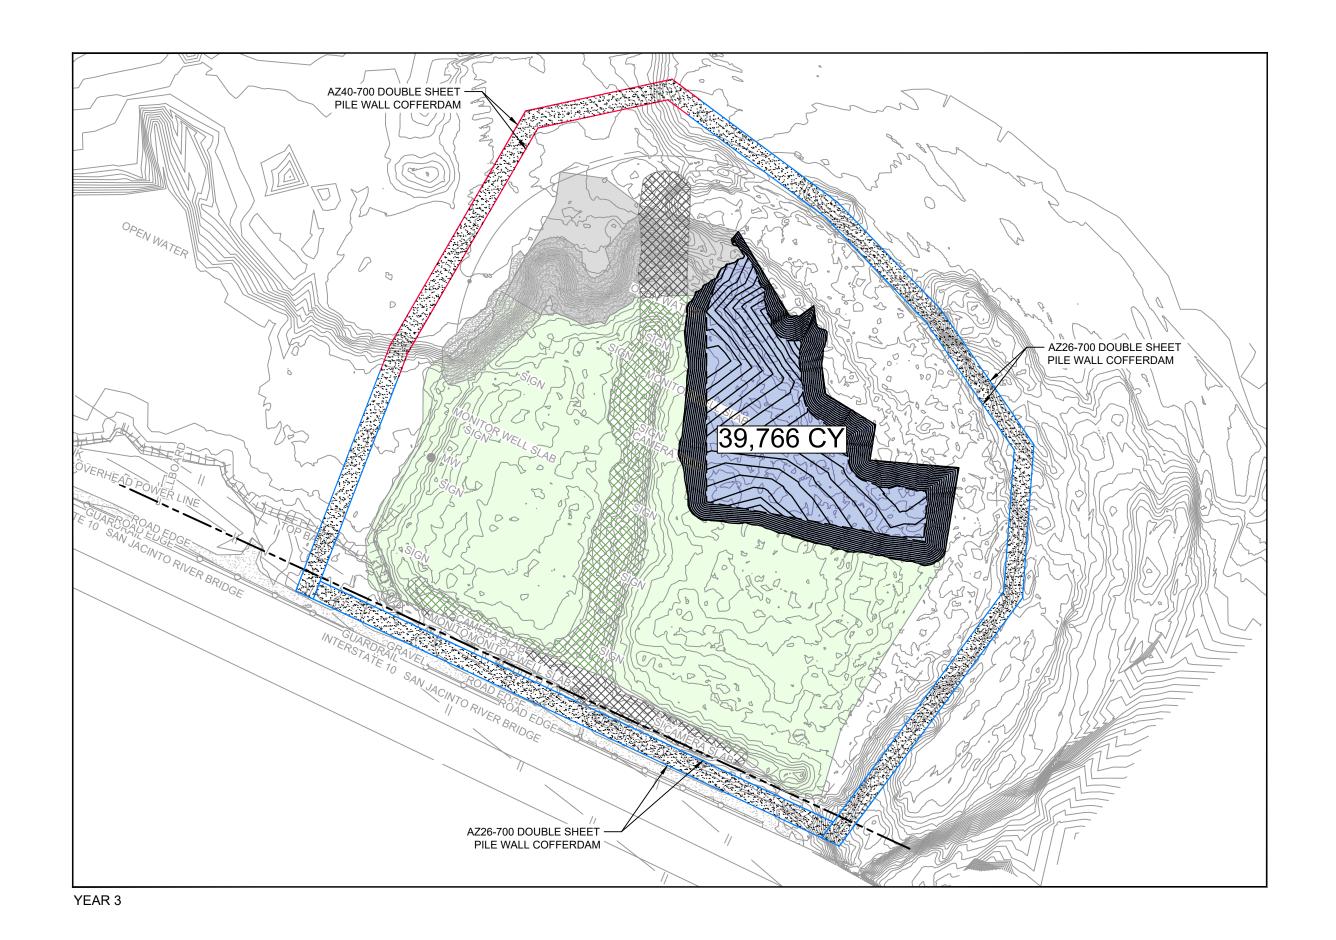

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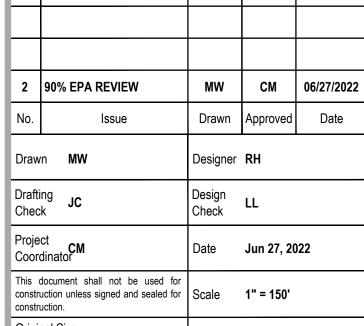
EXISTING BERM TO EXCAVATED EXISTING BERM NORTHWEST CORNER* CONCRETE GRAVEL

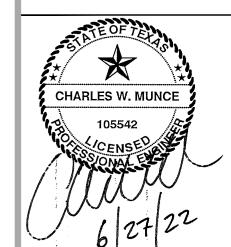MATERIAL TO BE EXCAVATED

AZ26-700 PILE AZ40-700 PILE PHASE OF EXCAVATION

SAN JACINTO RIVER WASTE PITS

NORTHERN IMPOUNDMENT PRE-FINAL 90% REMEDIAL DESIGN HARRIS COUNTY, TEXAS



Original Size Arch D

Bar is one inch on original size drawing

Project No. **11215702**

TYPICAL SEASONAL EXCAVATION

SEQUENCING

Sheet No.

C-19

AZ40-700 DOUBLE SHEET — PILE WALL COFFERDAM AZ26-700 DOUBLE SHEET PILE WALL COFFERDAM AZ26-700 DOUBLE SHEET — PILE WALL COFFERDAM

TOPOGRAPHIC, HYDROGRAPHIC, & MAGNETOMETER SURVEY OF SAN JACINTO RIVER WASTE PITS, HARRIS COUNTY, TEXAS, MORRISON SURVEYING INC., 190608, JULY 8, 2019 TO AUGUST 2, 2019 UPDATED BATHYMETRY DATA PROVIDED BY ANCHOR QEA OCTOBER 2021

YEAR 6

- 1. ASSUMED TXDOT RIGHT OF WAY IS BASED ON INFORMATION PROVIDED BY THE HARRIS COUNTY TAX ASSESSOR'S OFFICE.
- 2. TYPICAL EXCAVATION SEQUENCING ASSUMES BMP INSTALLATION AND SITE PREPARATION WILL BE COMPLETED IN YEAR 1, REMEDIATION OF THE NORTHWEST CORNER IN YEAR 2, AND BMP REMOVAL AND SITE RESTORATION WILL BE COMPLETED IN YEAR 7.
- SEASONAL EXCAVATION AREAS, VOLUMES, AND SEQUENCING ARE APPROXIMATE AND SUBJECT TO CHANGE.

*THE REMEDIAL DESIGN INFORMATION FOR THE NORTHWEST PORTION OF THE NORTHERN IMPOUNDMENT IS INCLUDED IN THIS SUBMITTAL. THE DESIGN TO DATE CONCLUDES THAT COMPLETING THE REMEDIAL ACTION "IN THE DRY" IN THE NORTHWEST PORTION OF THE NORTHERN IMPOUNDMENT AS STATED IN THE EPA RECORD OF DECISION IS NOT TECHNICALLY FEASIBLE DUE TO HYDRAULIC HEAVE. THE SUPPORTING TECHNICAL AND ENGINEERING BASIS FOR THIS CONCLUSION ARE INCLUDED IN THIS SUBMITTAL, AND AS SUCH, PENDING A FINAL EPA DETERMINATION REGARDING THIS AREA, IT IS ANTICIPATED THAT AN ADDENDUM TO THE PRE-FINAL 90% REMEDIAL DESIGN WILL BE SUBMITTED AT A FUTURE DATE TO ADDRESS THE NORTHWEST PORTION OF THE NORTHERN IMPOUNDMENT IN ACCORDANCE WITH EPA'S FINAL DETERMINATION AFTER REVIEW OF THIS NEWLY DEVELOPED SITE INFORMATION.

AZ26-700 DOUBLE SHEET — PILE WALL COFFERDAM

AZ40-700 DOUBLE SHEET -

PILE WALL COFFERDAM


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GHD SERVICES INC. JOB NO. 11215702 FILE NO. 001


AZ26-700 DOUBLE SHEET PILE WALL COFFERDAM

90% EPA REVIEW

YEAR 5

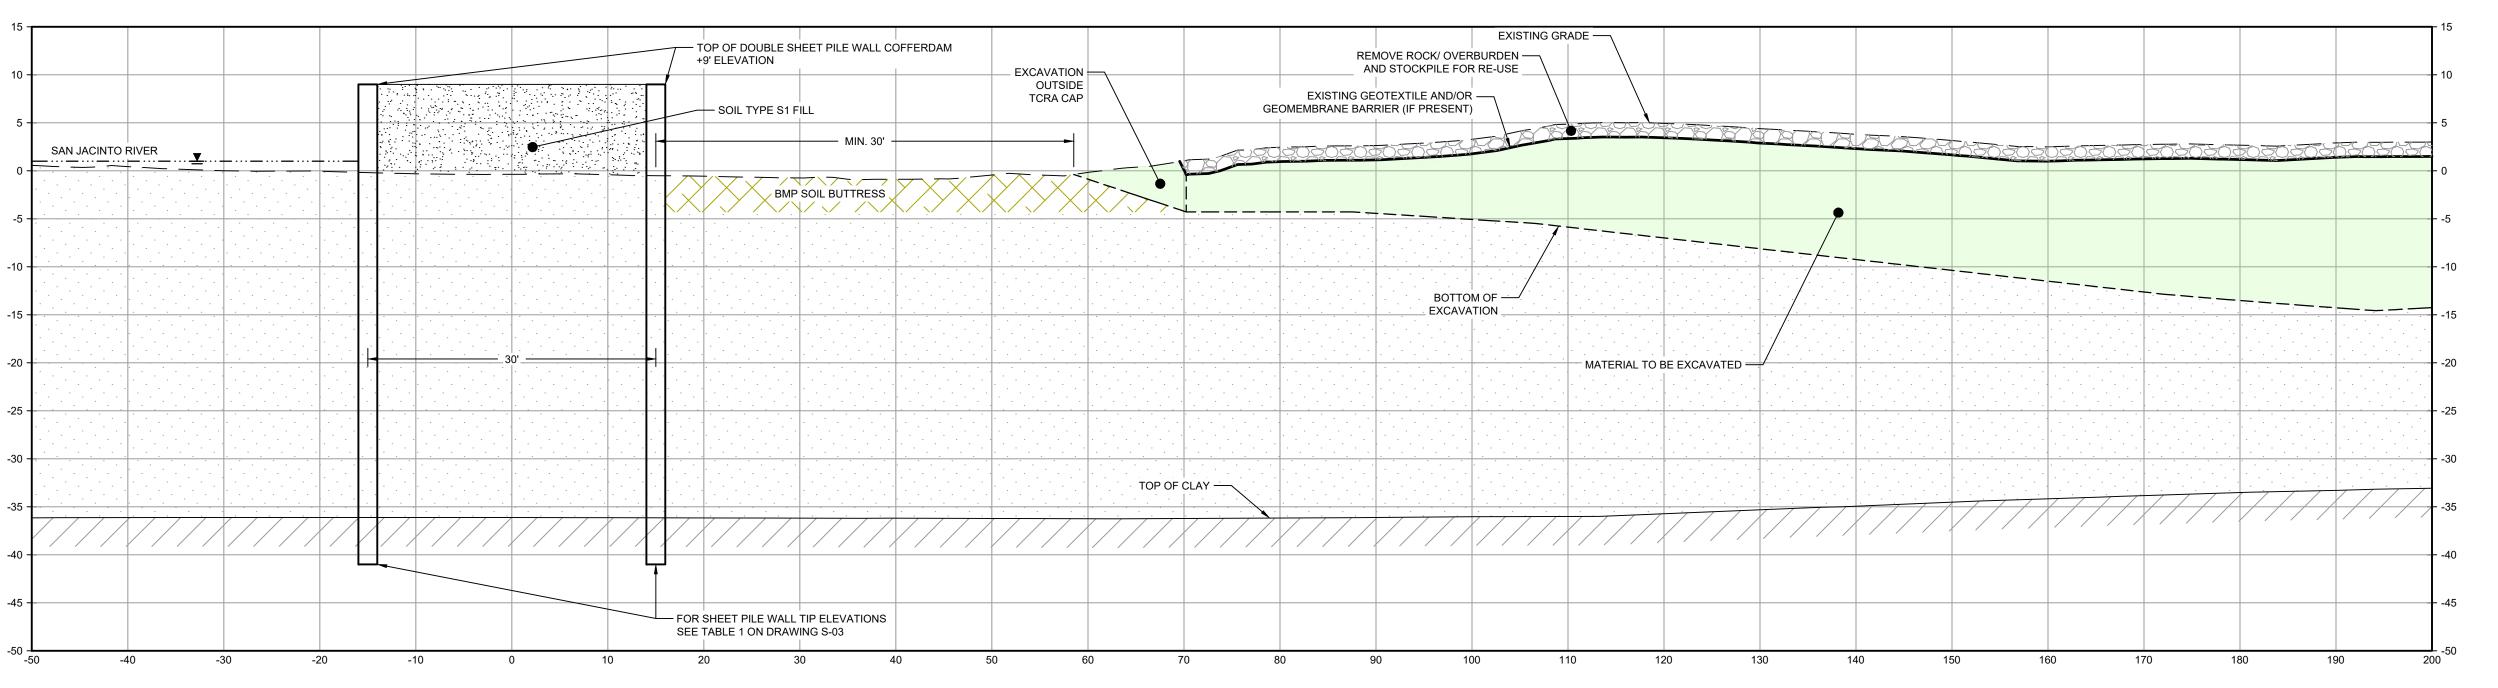

1. INSTALL PILE WALL COFFERDAM AROUND PERIMETER OF EXCAVATION AND DEWATER.

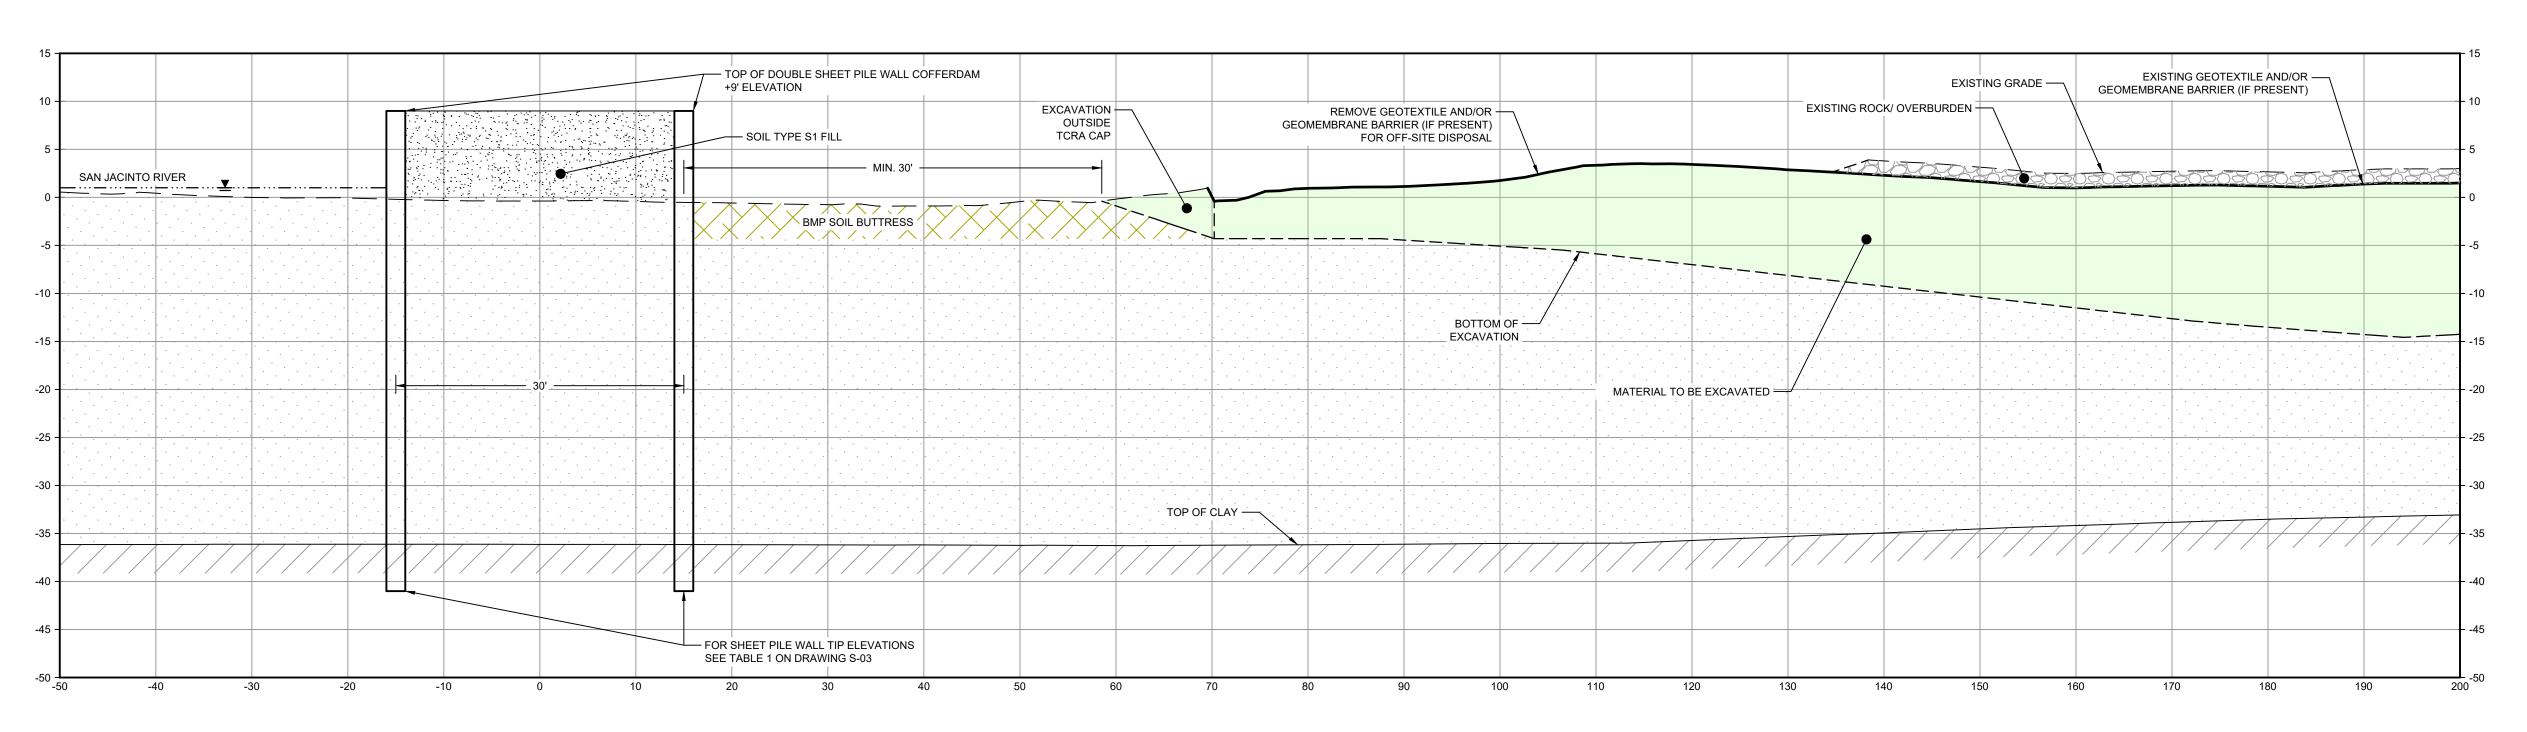

NOTES:

REMOVE ROCK LAYER TO BE STOCKPILED ON SITE. REUSED AS TEMPORARY COVER AT END OF SEASONAL EXCAVATION.

PHASE 2

1. BOTTOM OF EXCAVATION IS SUBJECT TO CHANGE.


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LEGEND

MATERIAL TO BE EXCAVATED BMP SOIL BUTTRESS

SAN JACINTO RIVER WASTE PITS

NORTHERN IMPOUNDMENT PRE-FINAL 90% REMEDIAL DESIGN HARRIS COUNTY, TEXAS

MW 2 90% EPA REVIEW CM 06/27/2022 Issue Drawn Designer RH Drafting JC Check Project **CM** Coordinator Date Jun 27, 2022
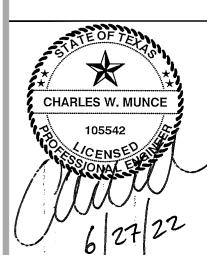
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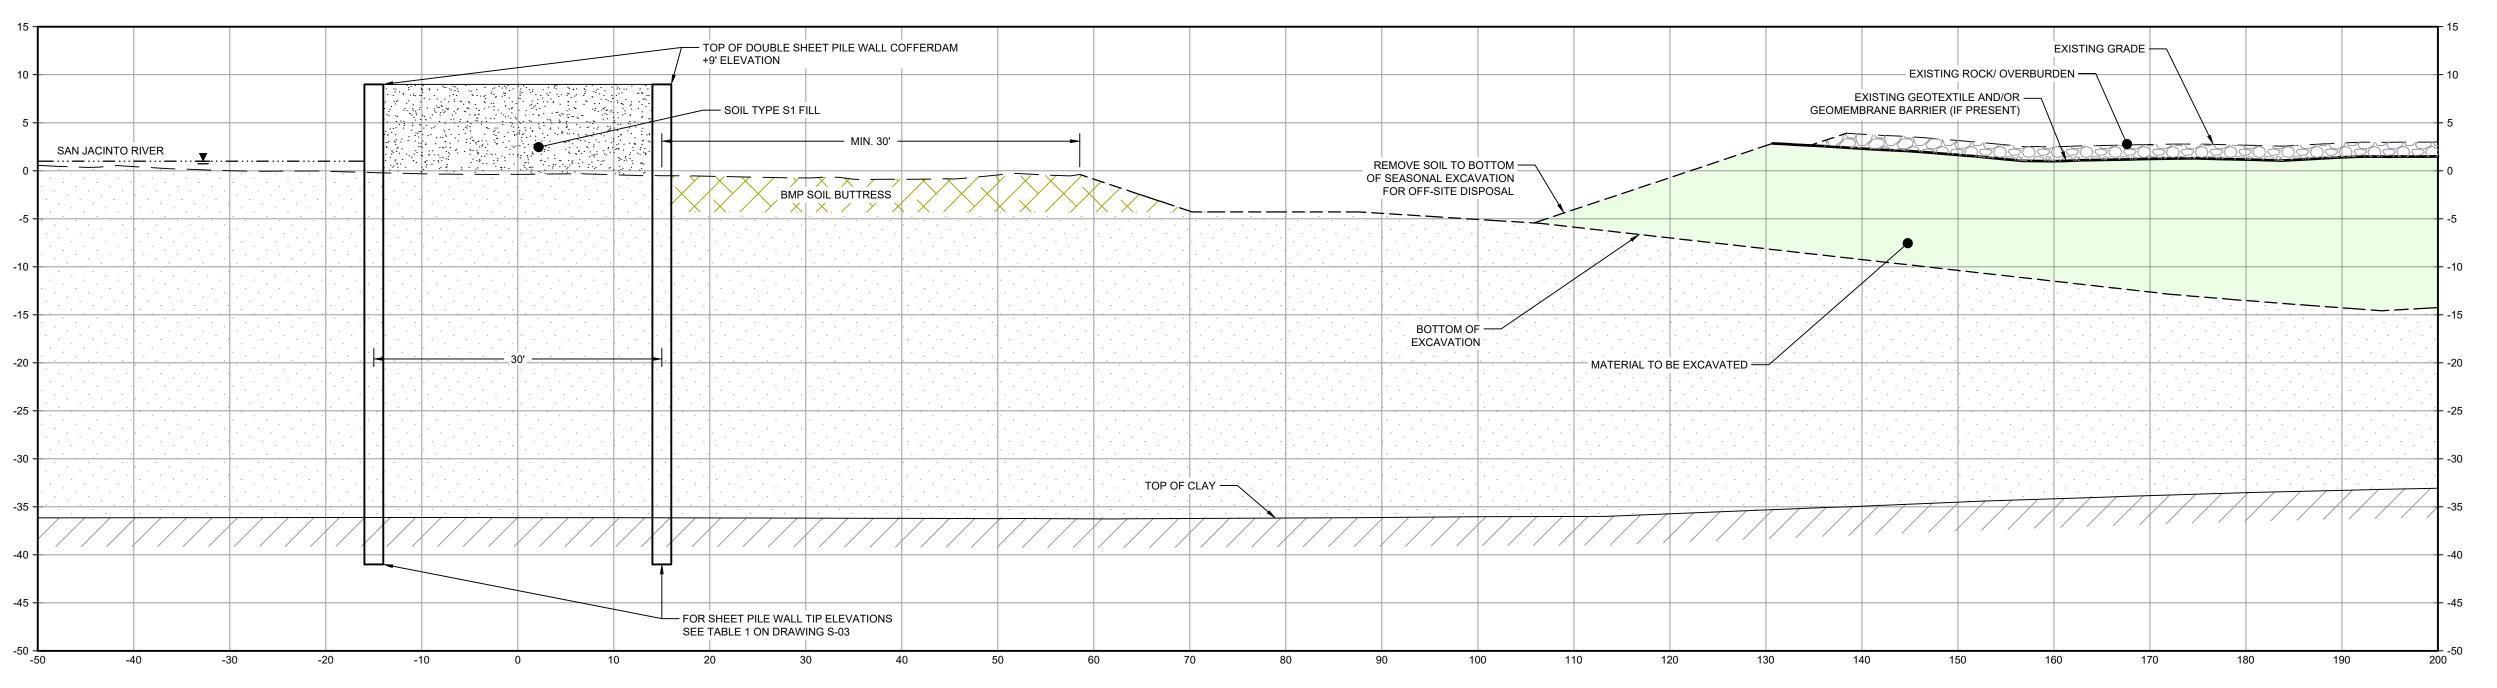
Bar is one inch on original size drawing Arch D 0 ______ 1"

Project No. **11215702**

TYPICAL EXCAVATION **SEQUENCING** 1 OF 2


Sheet No.

C-20



NOTES:

1. REMOVE GEOMEMBRANE, EXCAVATE MATERIAL AND DISPOSE OF OFFSITE.

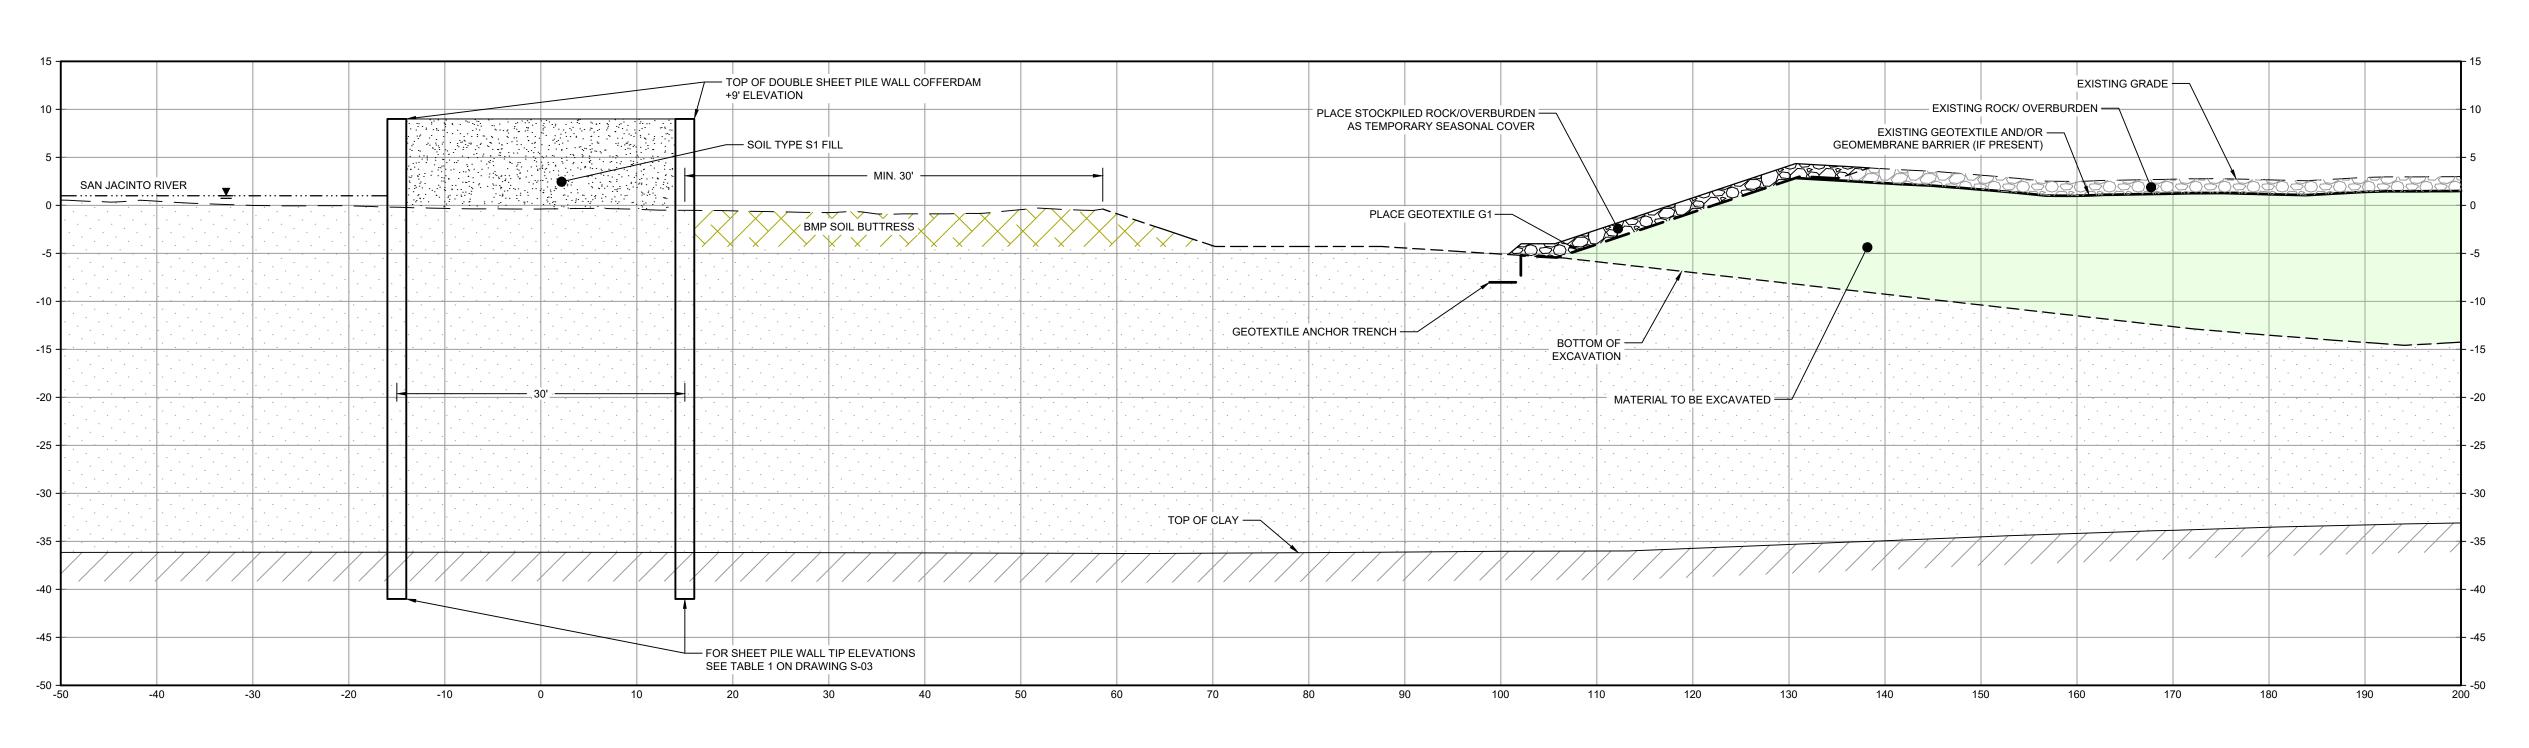

PHASE 4

1. BOTTOM OF EXCAVATION IS SUBJECT TO CHANGE.


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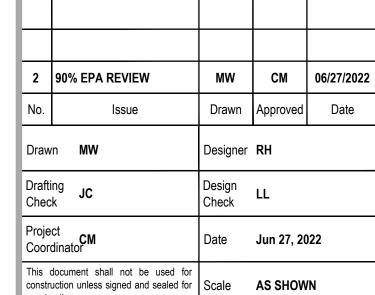
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BMP SOIL BUTTRESS

LEGEND MATERIAL TO BE EXCAVATED

SAN JACINTO RIVER WASTE PITS

NORTHERN IMPOUNDMENT PRE-FINAL 90% REMEDIAL DESIGN HARRIS COUNTY, TEXAS

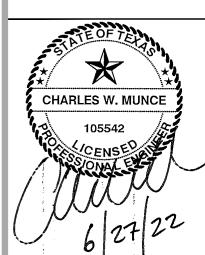

Original Size

original size drawing Arch D

Bar is one inch on

Sheet - of -

Project No. **11215702**

TYPICAL EXCAVATION **SEQUENCING**

2 OF 2


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C-21

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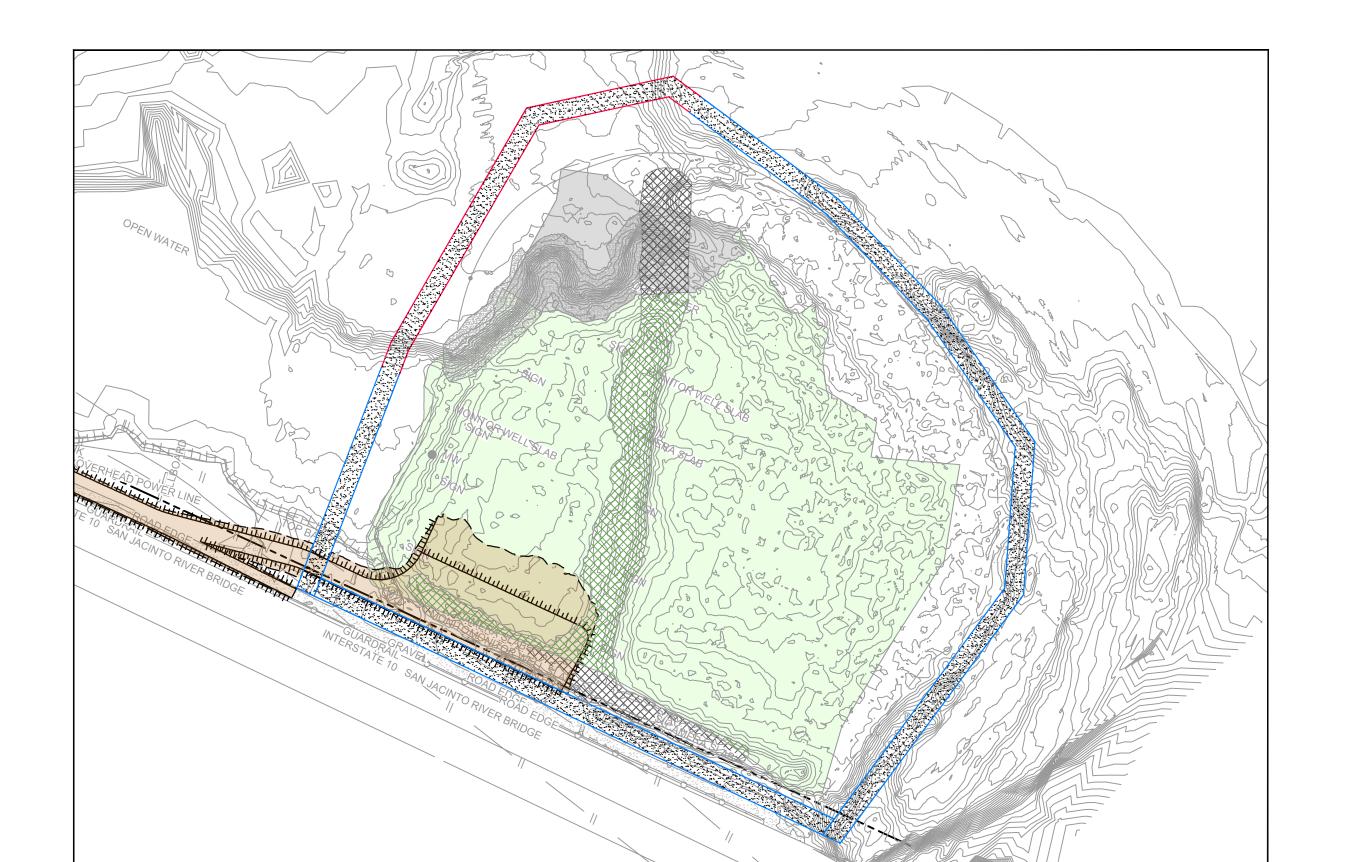
Plotted By: Matt Wolfer


Filename: N:\US\Baton Rouge\Projects\562\11215702\Digital_Design\ACAD 2019\Sheets\11215702-02-DWG-C-028.dwg



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2	90% EPA REVIEW	MW	СМ	06/27/2022
No.	Issue	Drawn	Approved	Date
Draw	n MW	Designer	RH	
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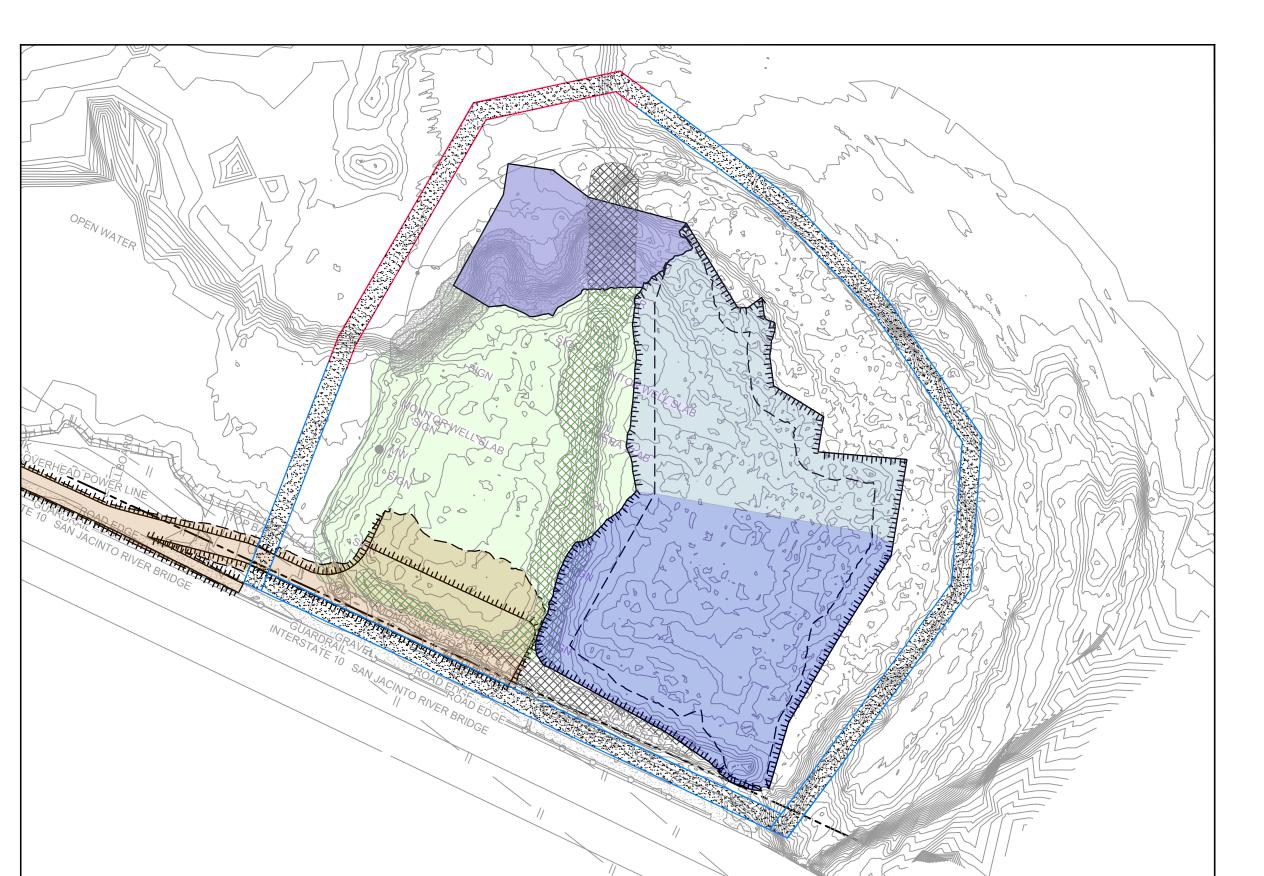


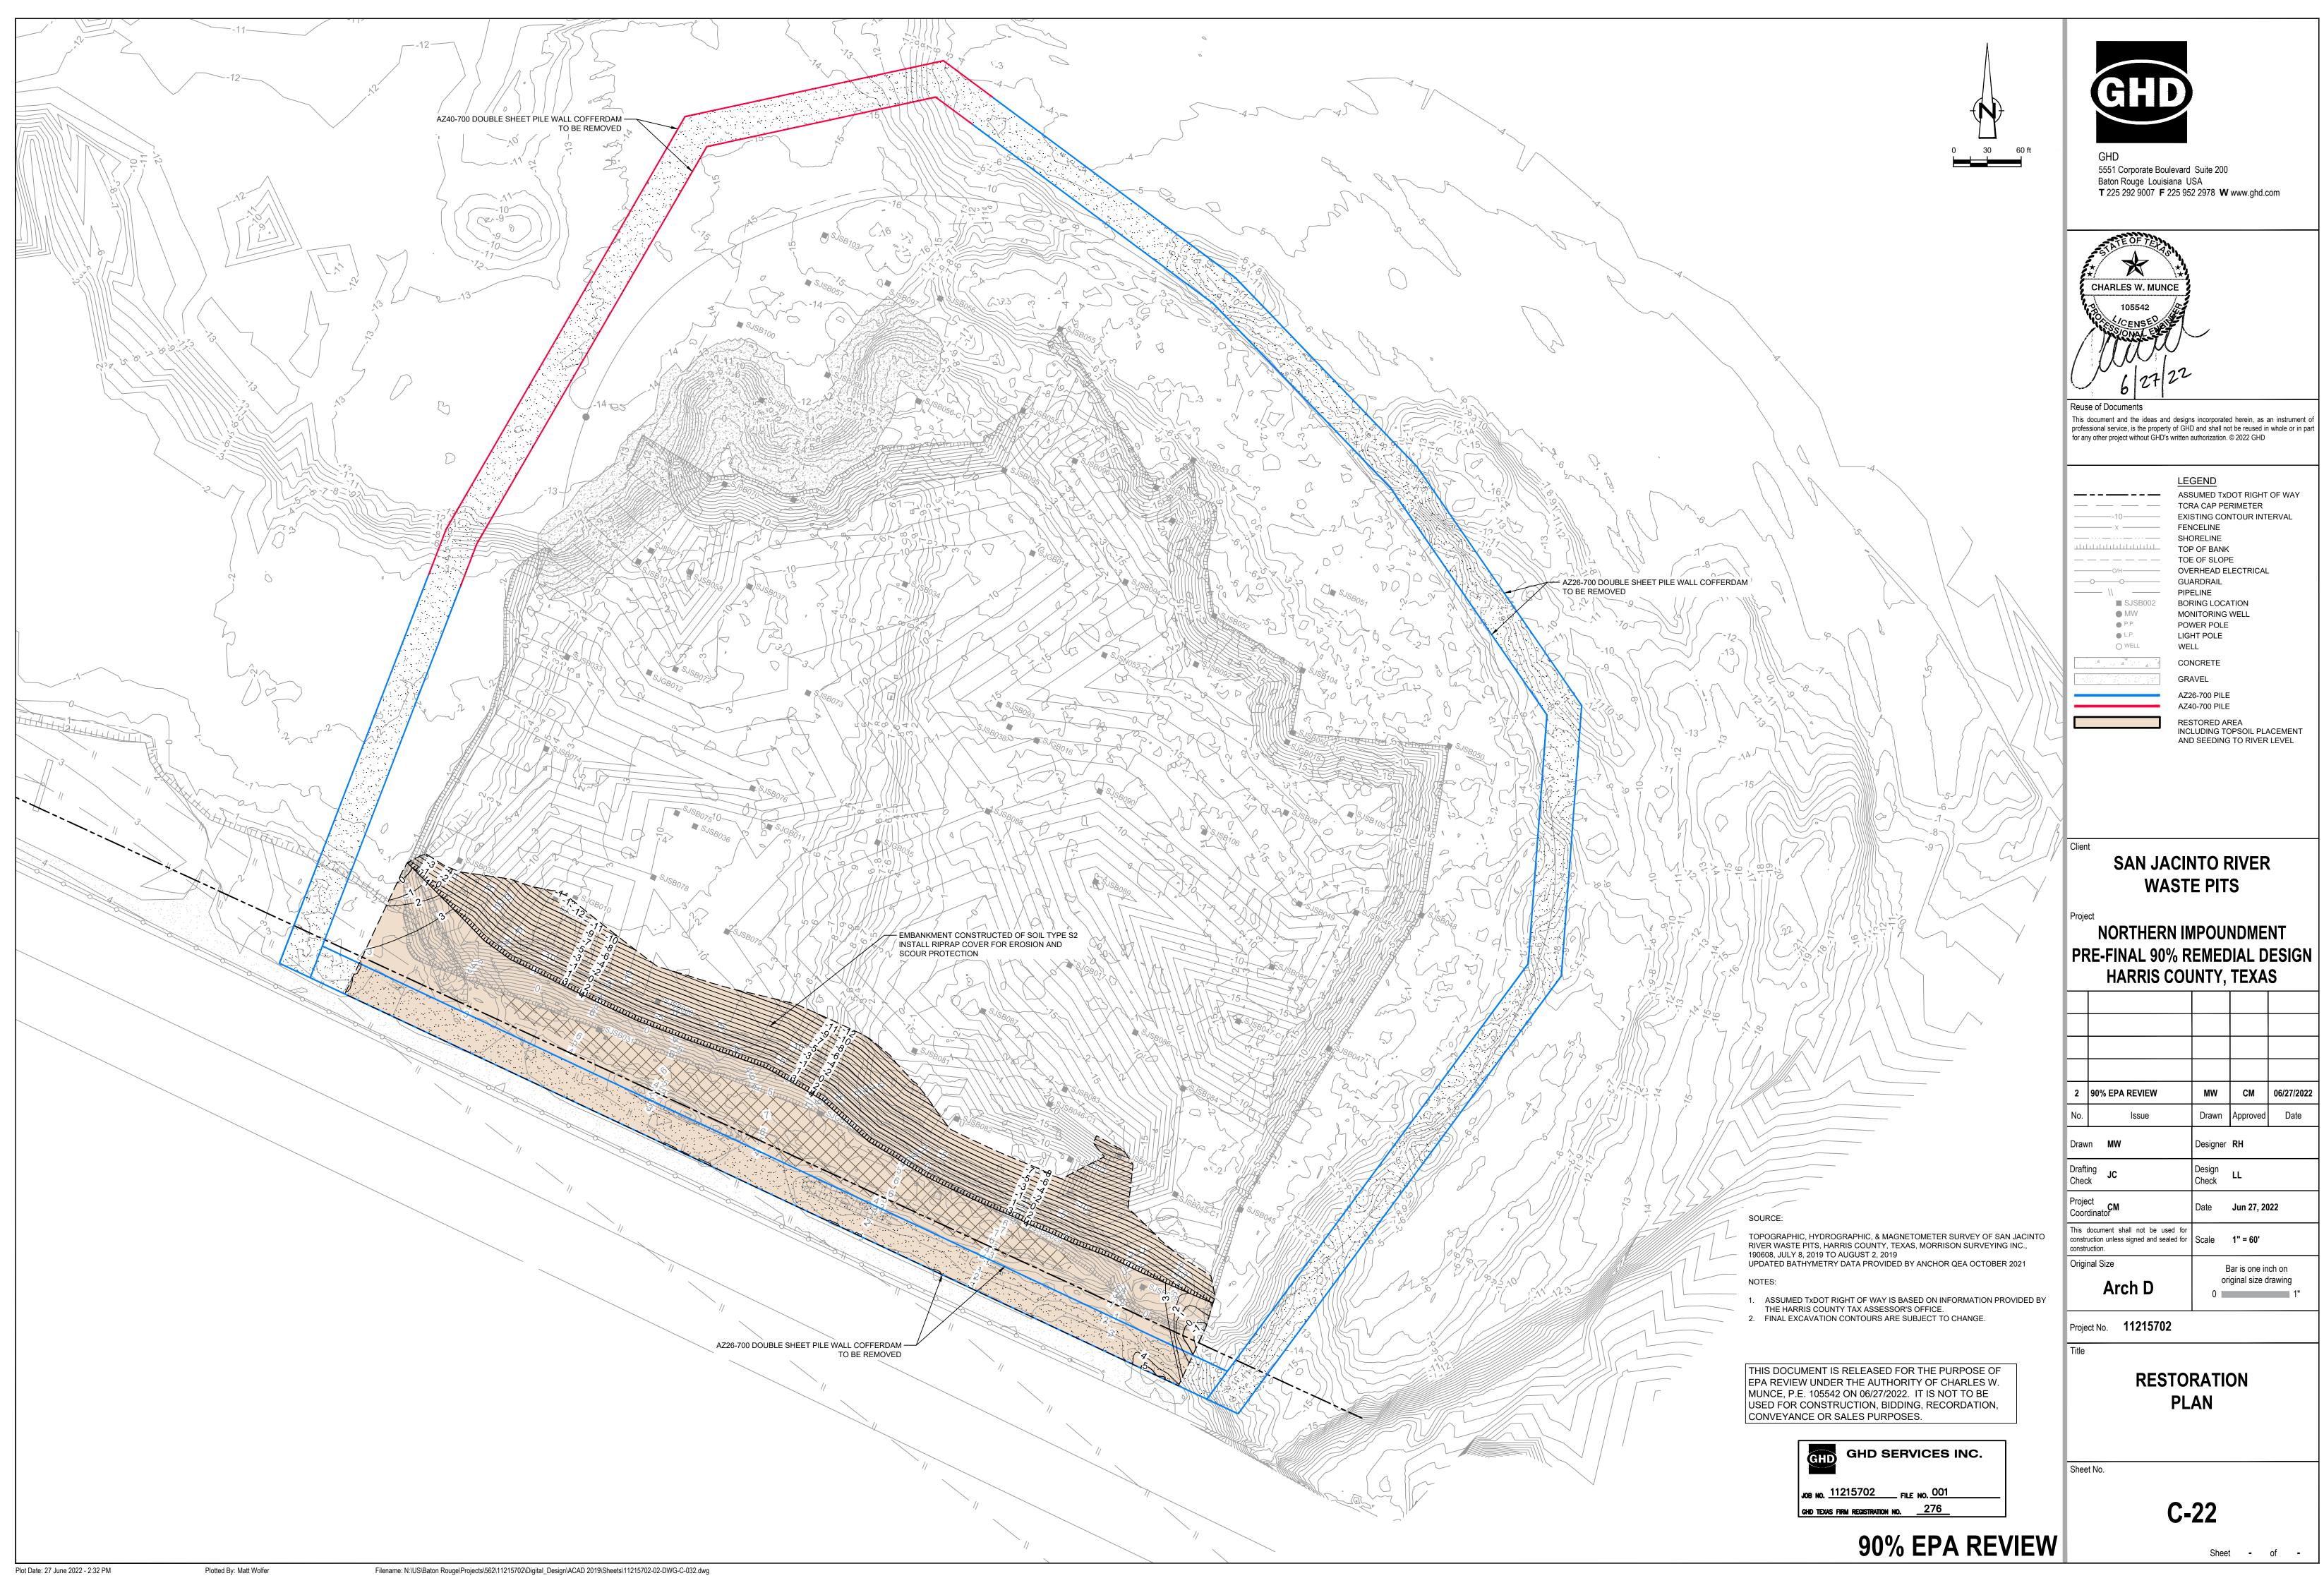



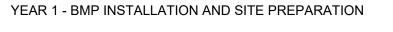

YEAR 2 - EXCAVATION SEASON 1



YEAR 4 - EXCAVATION SEASON 3

TOPOGRAPHIC, HYDROGRAPHIC, & MAGNETOMETER SURVEY OF SAN JACINTO RIVER WASTE PITS, HARRIS COUNTY, TEXAS, MORRISON SURVEYING INC., 190608, JULY 8, 2019 TO AUGUST 2, 2019 UPDATED BATHYMETRY DATA PROVIDED BY ANCHOR QEA OCTOBER

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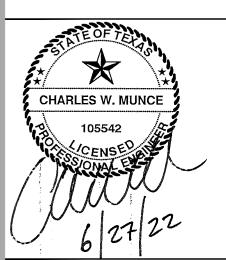
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	LEGEND
	ASSUMED TXDOT RIGHT OF V
	TCRA CAP PERIMETER
-10	EXISTING CONTOUR INTERVA
X	FENCELINE
	SHORELINE
	TOP OF BANK
— — O/H — — —	TOE OF SLOPE
	OVERHEAD ELECTRICAL
	GUARDRAIL
//	PIPELINE
- 0.100000	DODING LOCATION

BORING LOCATION MONITORING WELL POWER POLE LIGHT POLE MATERIAL TO BE EXCAVATED

EXISTING BERM TO EXCAVATED EXISTING BERM NORTHWEST CORNER*

CONCRETE AZ26-700 PILE AZ40-700 PILE PHASE OF EXCAVATION

SAN JACINTO RIVER WASTE PITS

NORTHERN IMPOUNDMENT PRE-FINAL 90% REMEDIAL DESIGN HARRIS COUNTY, TEXAS

2	90% EPA REVIEW	MW	СМ	06/27/2
No.	Issue	Drawn	Approved	Dat
Drawn MW		Designer	RH	
Drafting JC Check		Design Check	LL	
Project CM Coordinator		Date	Jun 27, 20)22
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Arch D

Project No. **11215702**

Original Size

TYPICAL CONSTRUCTION SEQUENCING

Bar is one inch on original size drawing

1 OF 2


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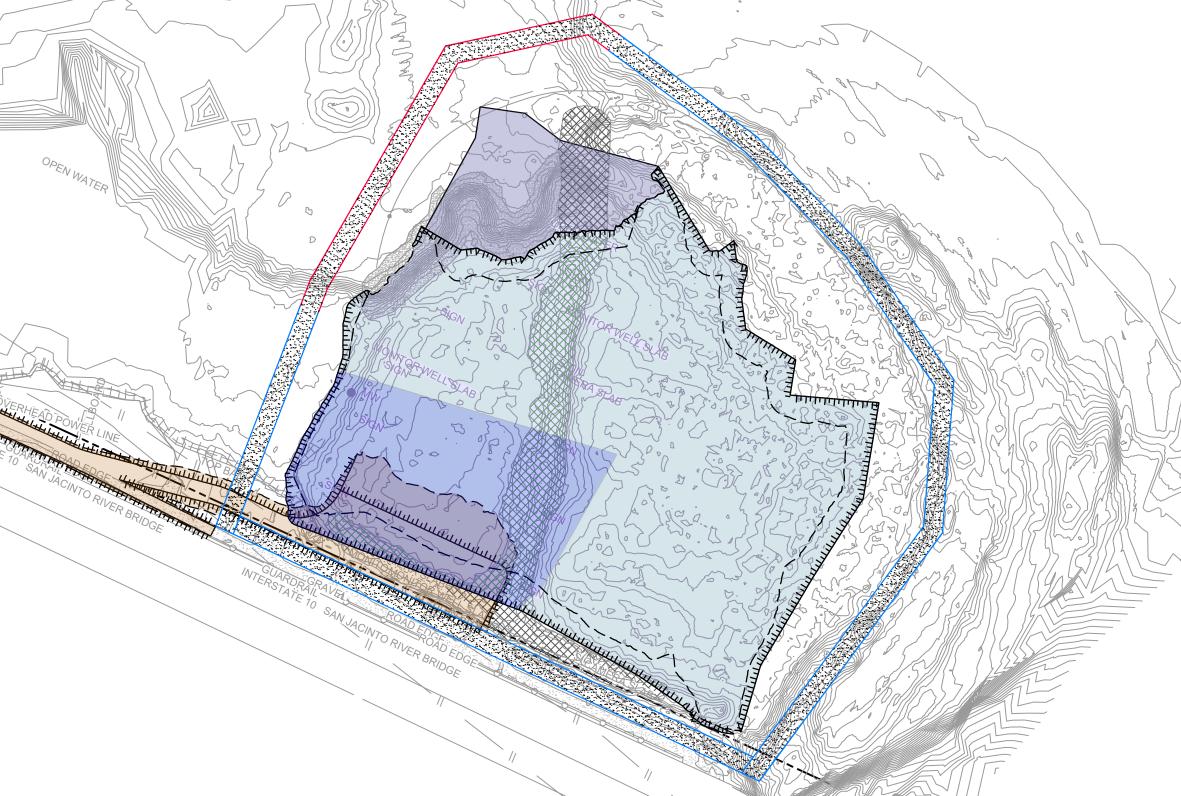
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Plot Date: 27 June 2022 - 2:40 PM

Plotted By: Matt Wolfer


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	LEGEND
	ASSUMED TXDOT RIGHT OF WAY
	TCRA CAP PERIMETER
-10	EXISTING CONTOUR INTERVAL
X	FENCELINE
	SHORELINE
	TOP OF BANK
	TOE OF SLOPE
O/H	OVERHEAD ELECTRICAL
-	GUARDRAIL
\\	PIPELINE
SJSB002	BORING LOCATION
MW	MONITORING WELL
P.P.	POWER POLE
■ L.P.	LIGHT POLE
- 111	

MATERIAL TO BE EXCAVATED

EXISTING BERM TO EXCAVATED EXISTING BERM NORTHWEST CORNER* CONCRETE

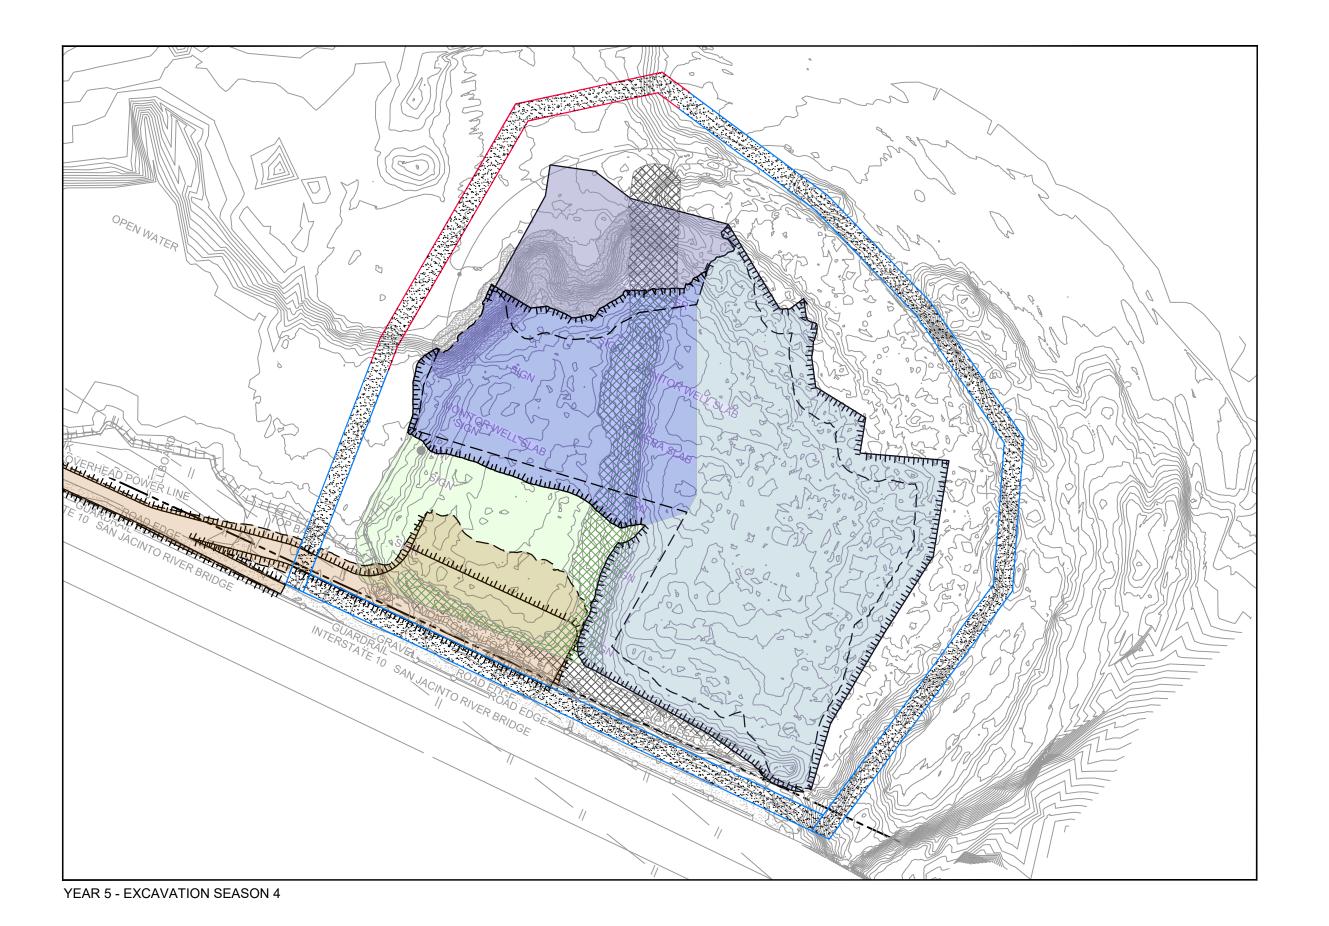AZ26-700 PILE AZ40-700 PILE PHASE OF EXCAVATION

SAN JACINTO RIVER WASTE PITS

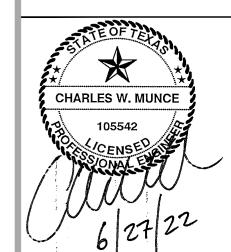NORTHERN IMPOUNDMENT PRE-FINAL 90% REMEDIAL DESIGN HARRIS COUNTY, TEXAS

2	90% EPA REVIEW	MW	СМ	06/27/202
10.	Issue	Drawn	Approved	Date
raw	n MW	Designer	RH	
rafti hec	· .l(.	Design Check	LL	
roje oor	ct dinator	Date	Jun 27, 20)22
his document shall not be used for onstruction unless signed and sealed for onstruction.		Scale	1" = 150'	

Original Size Arch D

original size drawing


Bar is one inch on

Project No. **11215702**

TYPICAL CONSTRUCTION SEQUENCING 2 OF 2

Sheet No.

C-24

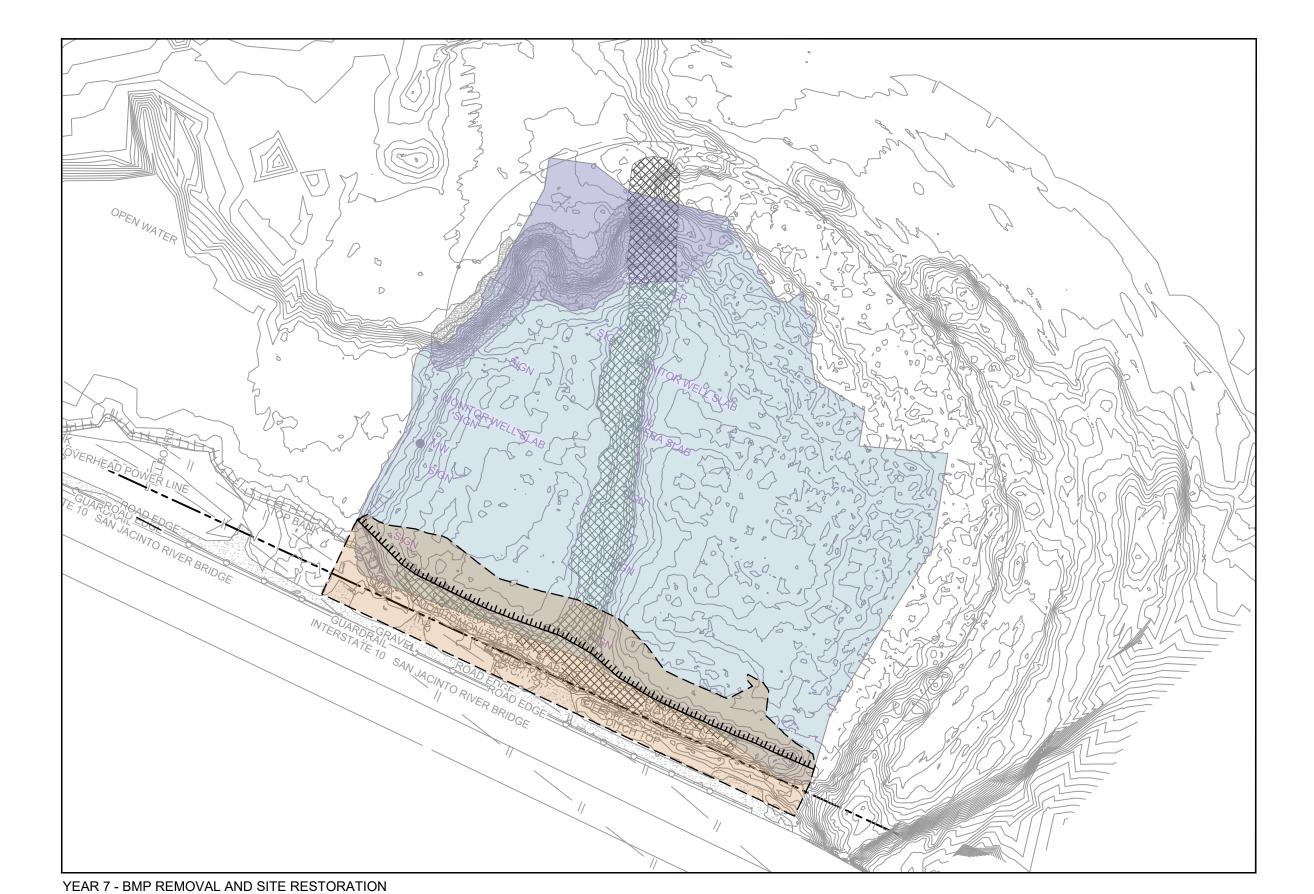

TOPOGRAPHIC, HYDROGRAPHIC, & MAGNETOMETER SURVEY OF SAN JACINTO RIVER WASTE PITS, HARRIS COUNTY, TEXAS, MORRISON SURVEYING INC., 190608, JULY 8, 2019 TO AUGUST 2, 2019 UPDATED BATHYMETRY DATA PROVIDED BY ANCHOR QEA OCTOBER

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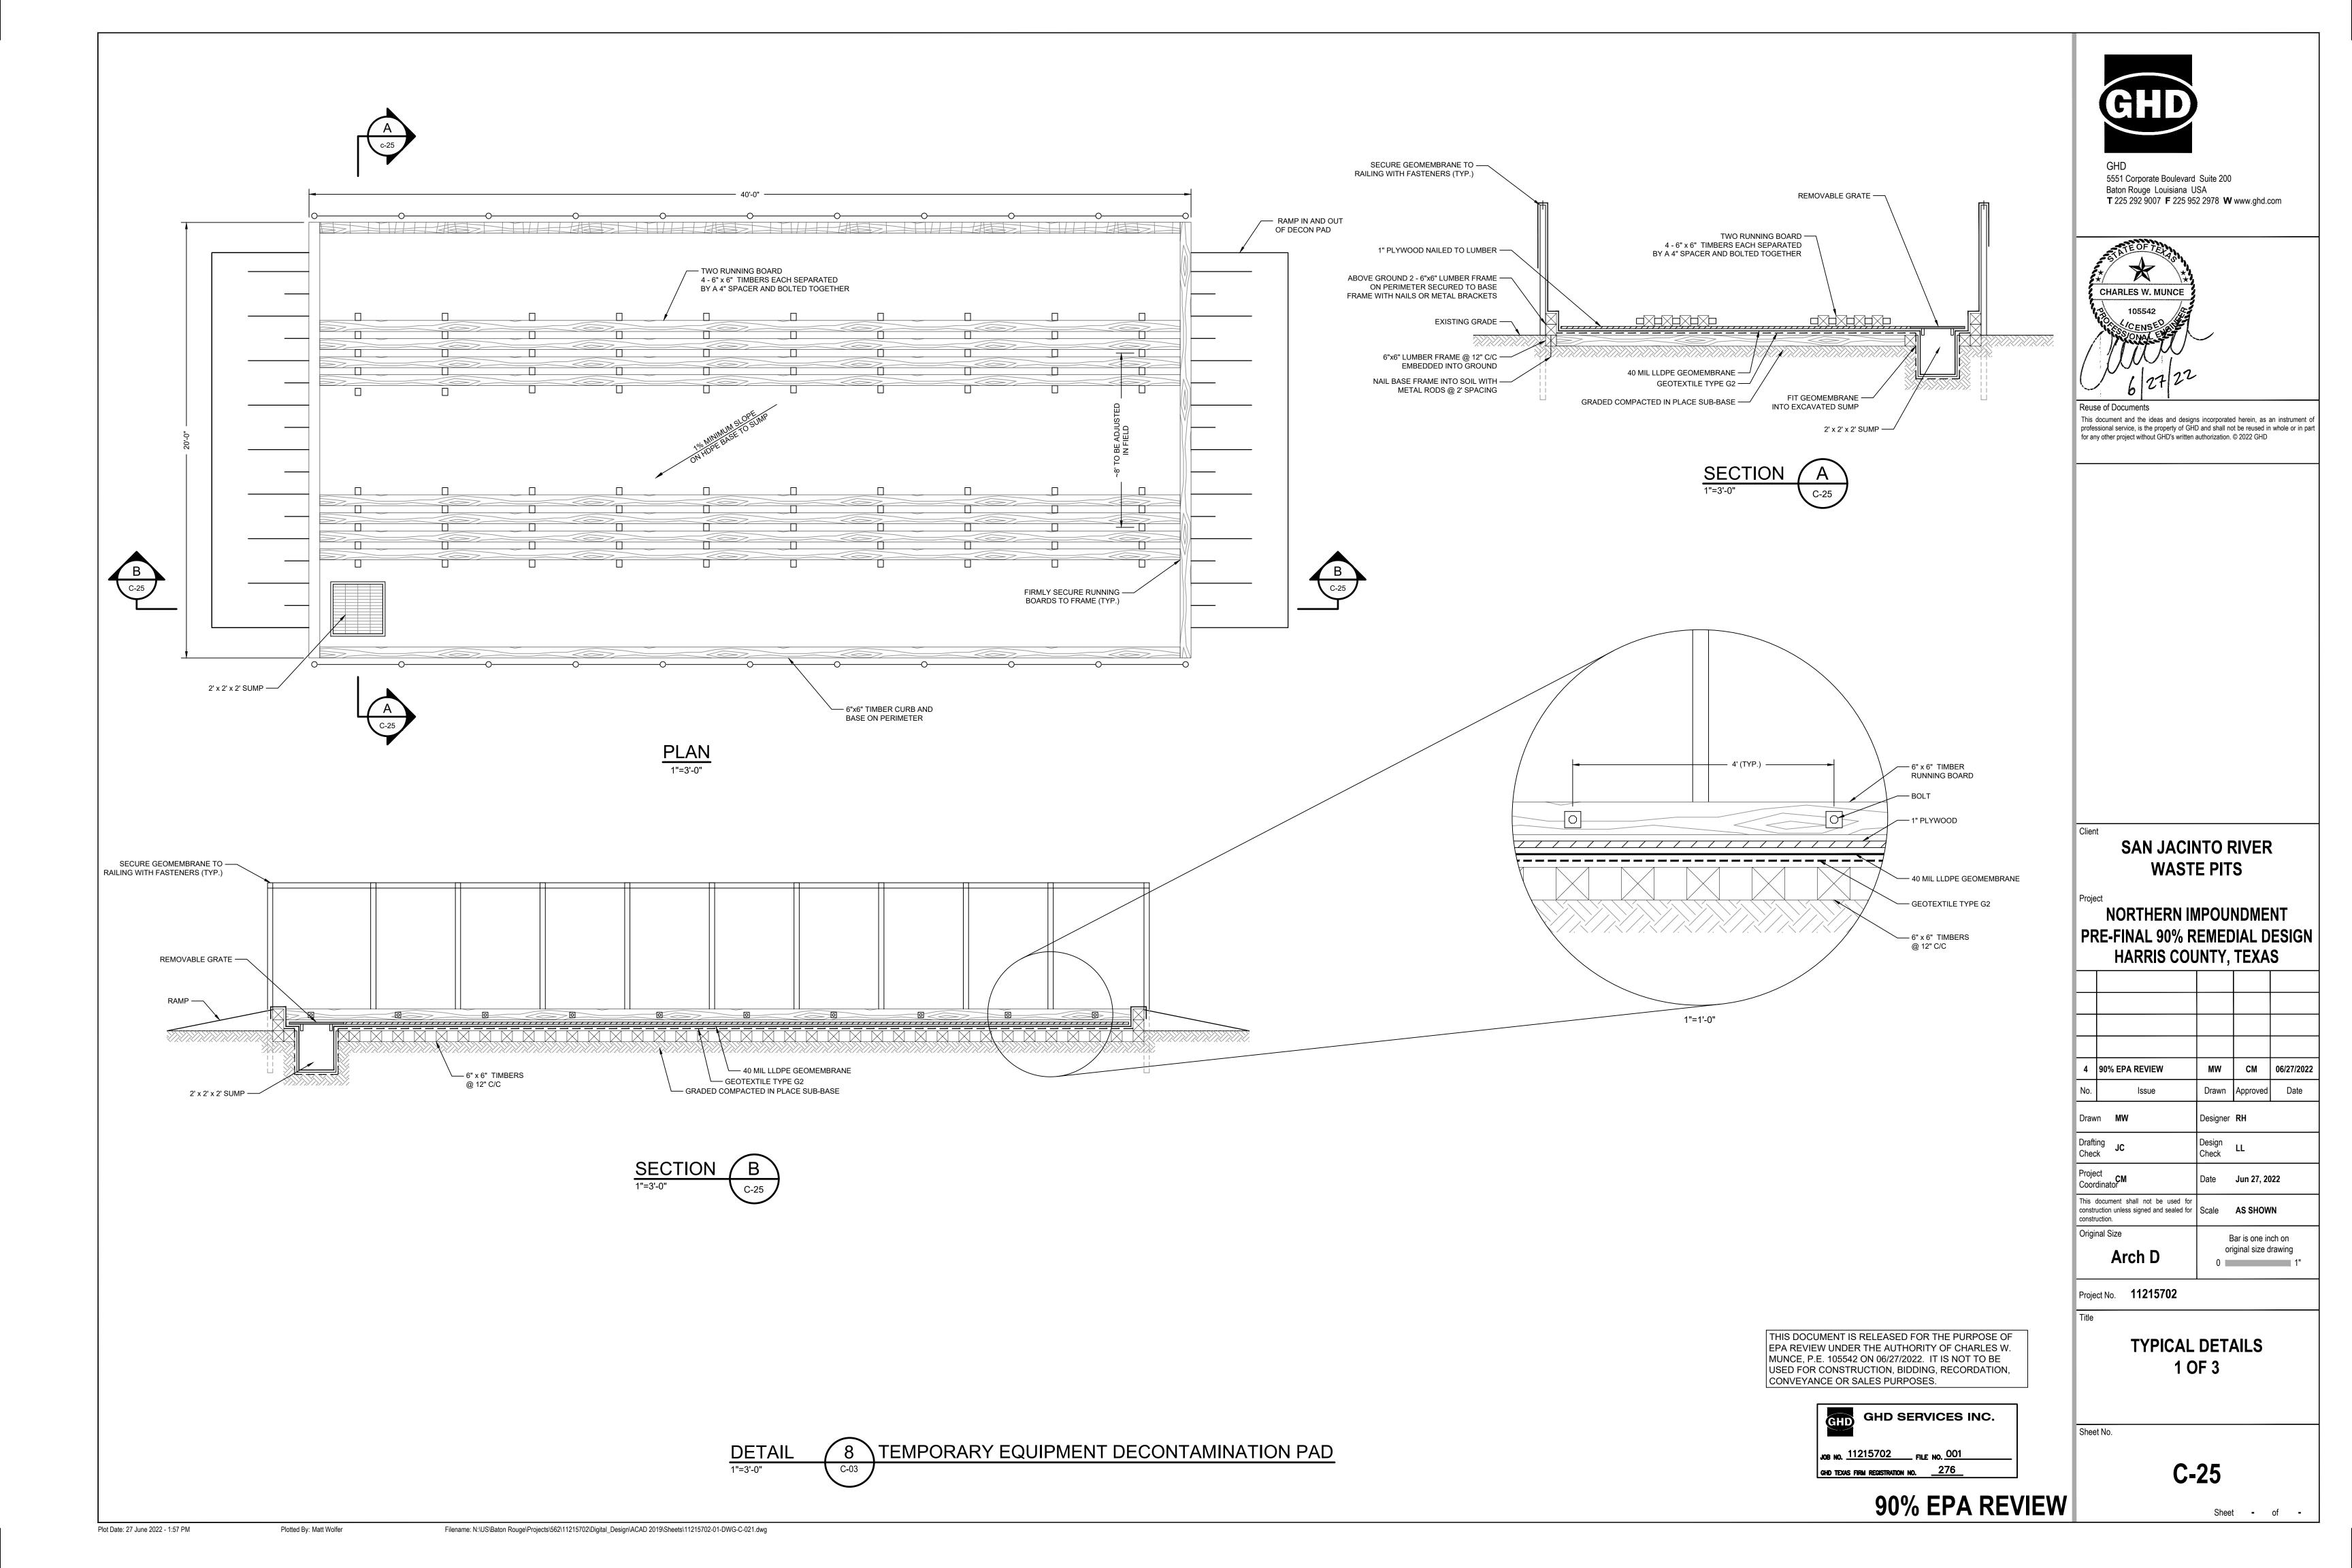
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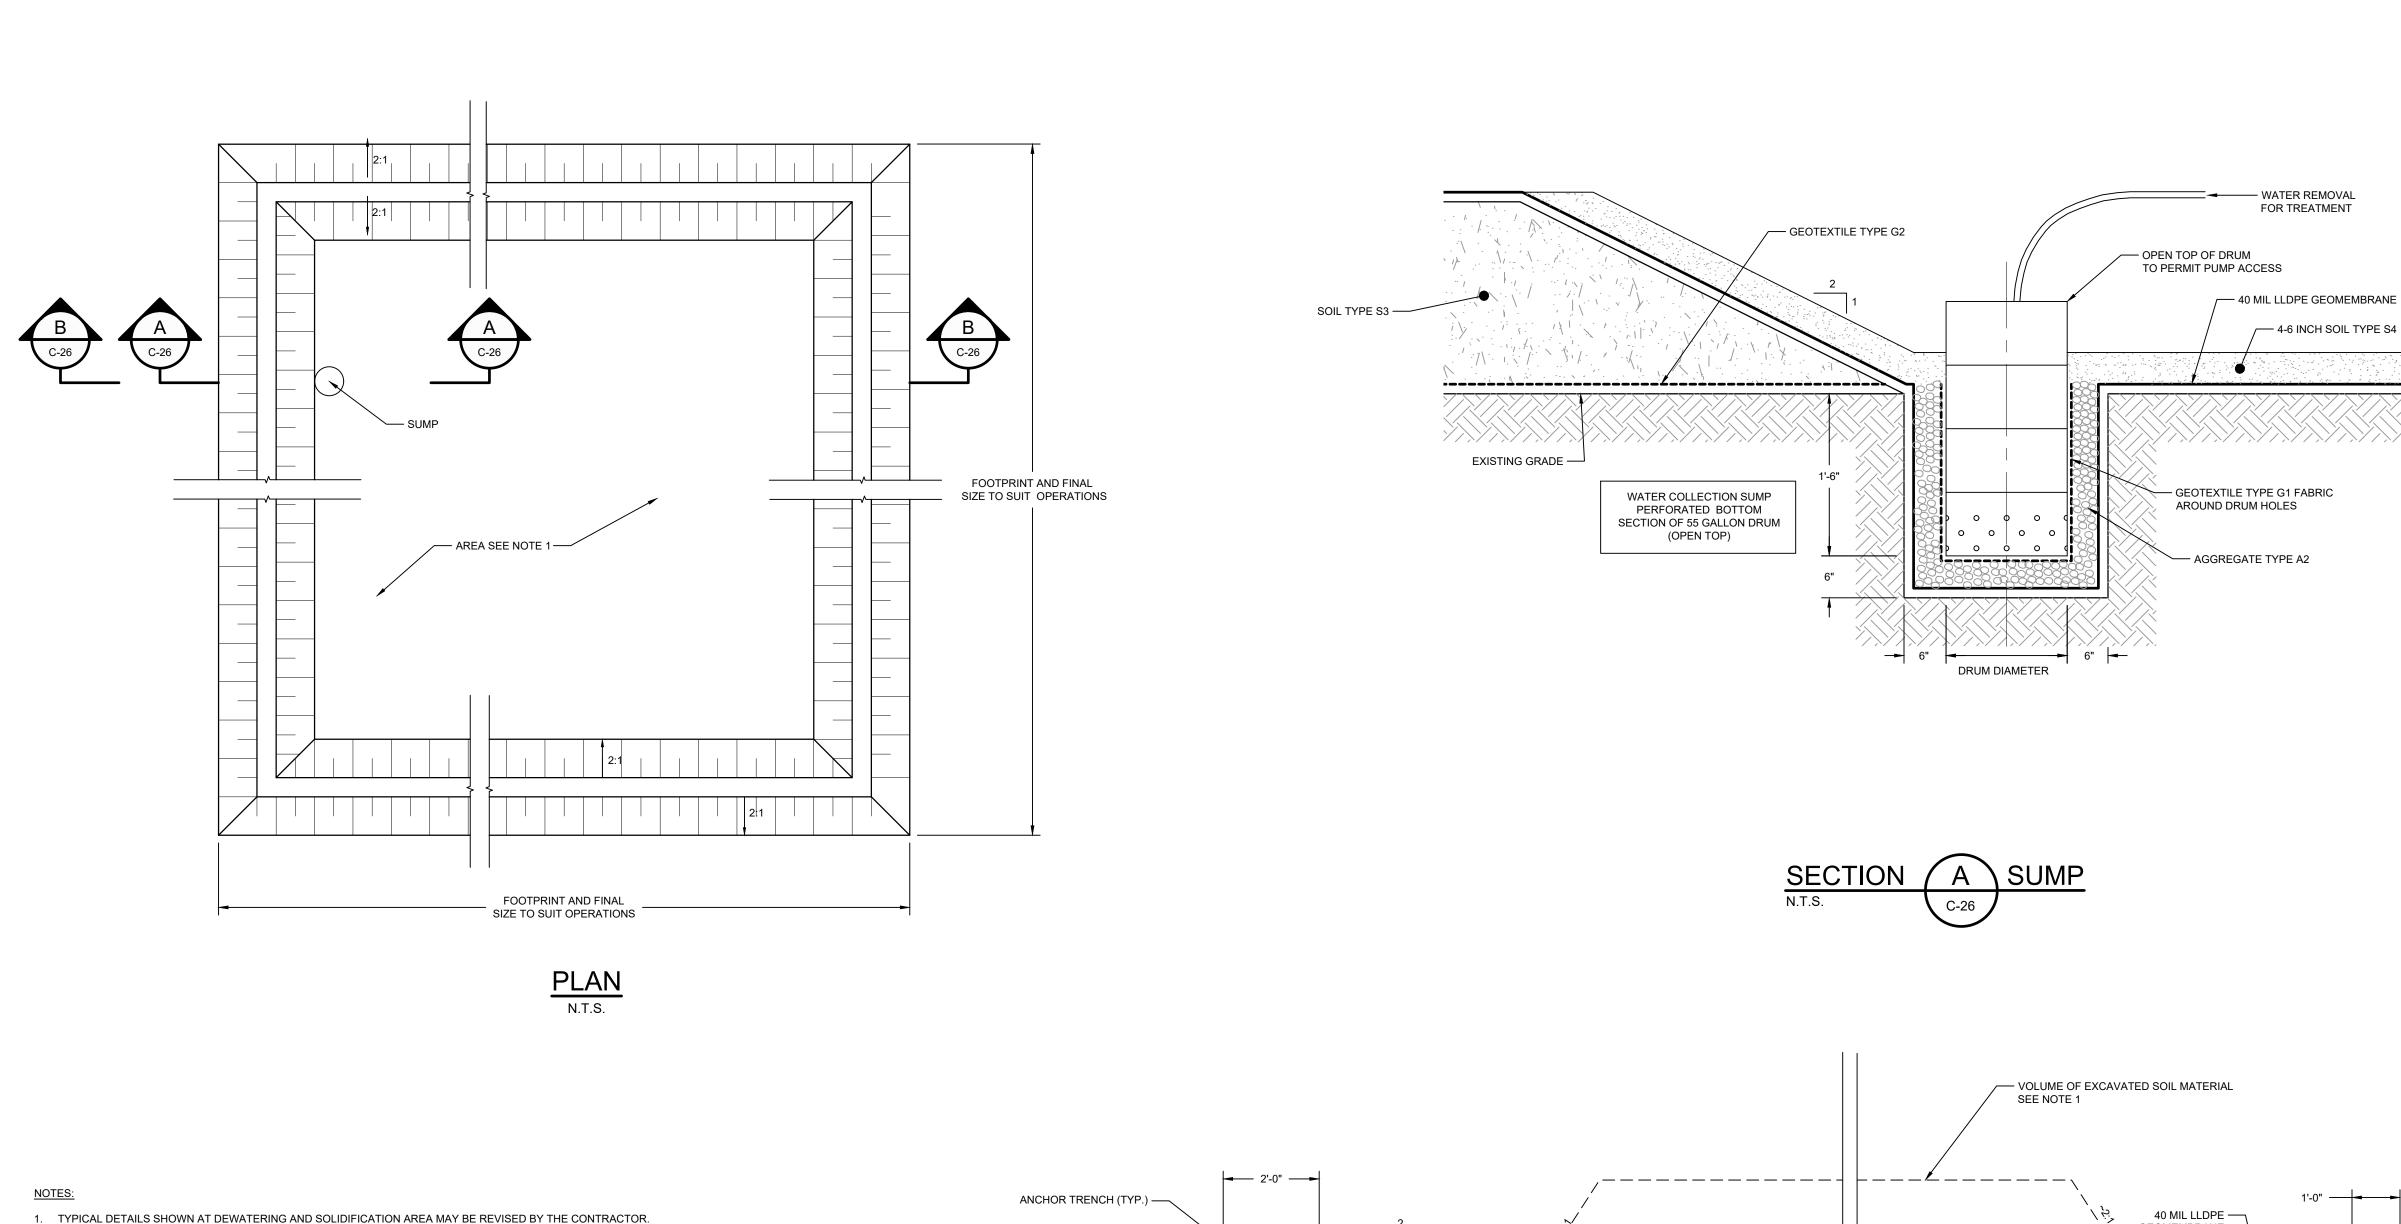
YEAR 6 - EXCAVATION SEASON 5

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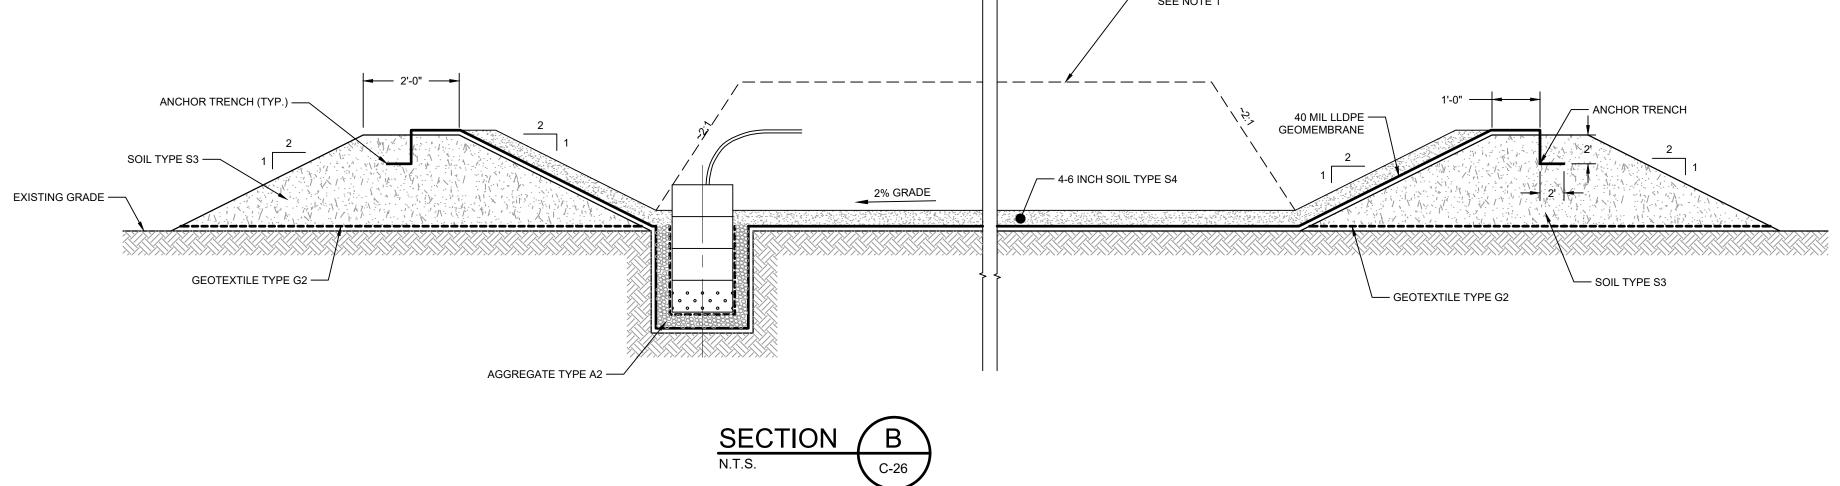


Plot Date: 27 June 2022 - 2:41 PM





1. TYPICAL DETAILS SHOWN AT DEWATERING AND SOLIDIFICATION AREA MAY BE REVISED BY THE CONTRACTOR. CONTRACTOR'S REVISED DETAILS SHALL BE SUBMITTED FOR REVIEW PRIOR TO CONSTRUCTION.



9 TEMPORARY DEWATERING FACILITY


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Client **SAN JACINTO RIVER WASTE PITS**

NORTHERN IMPOUNDMENT PRE-FINAL 90% REMEDIAL DESIGN HARRIS COUNTY, TEXAS

4	90% EPA REVIEW	MW	СМ	06/2
No.	Issue	Drawn	Approved	D
Draw	n MW	Designer	RH	
Drafting JC Check		Design Check	LL	
Project CM Coordinator		Date	Jun 27, 20)22
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Project No. **11215702**

Arch D

Original Size

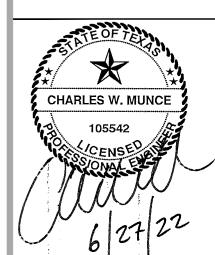
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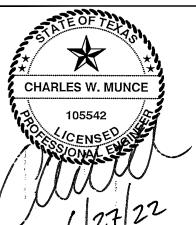
Bar is one inch on original size drawing

2 OF 3

Sheet No.

C-26



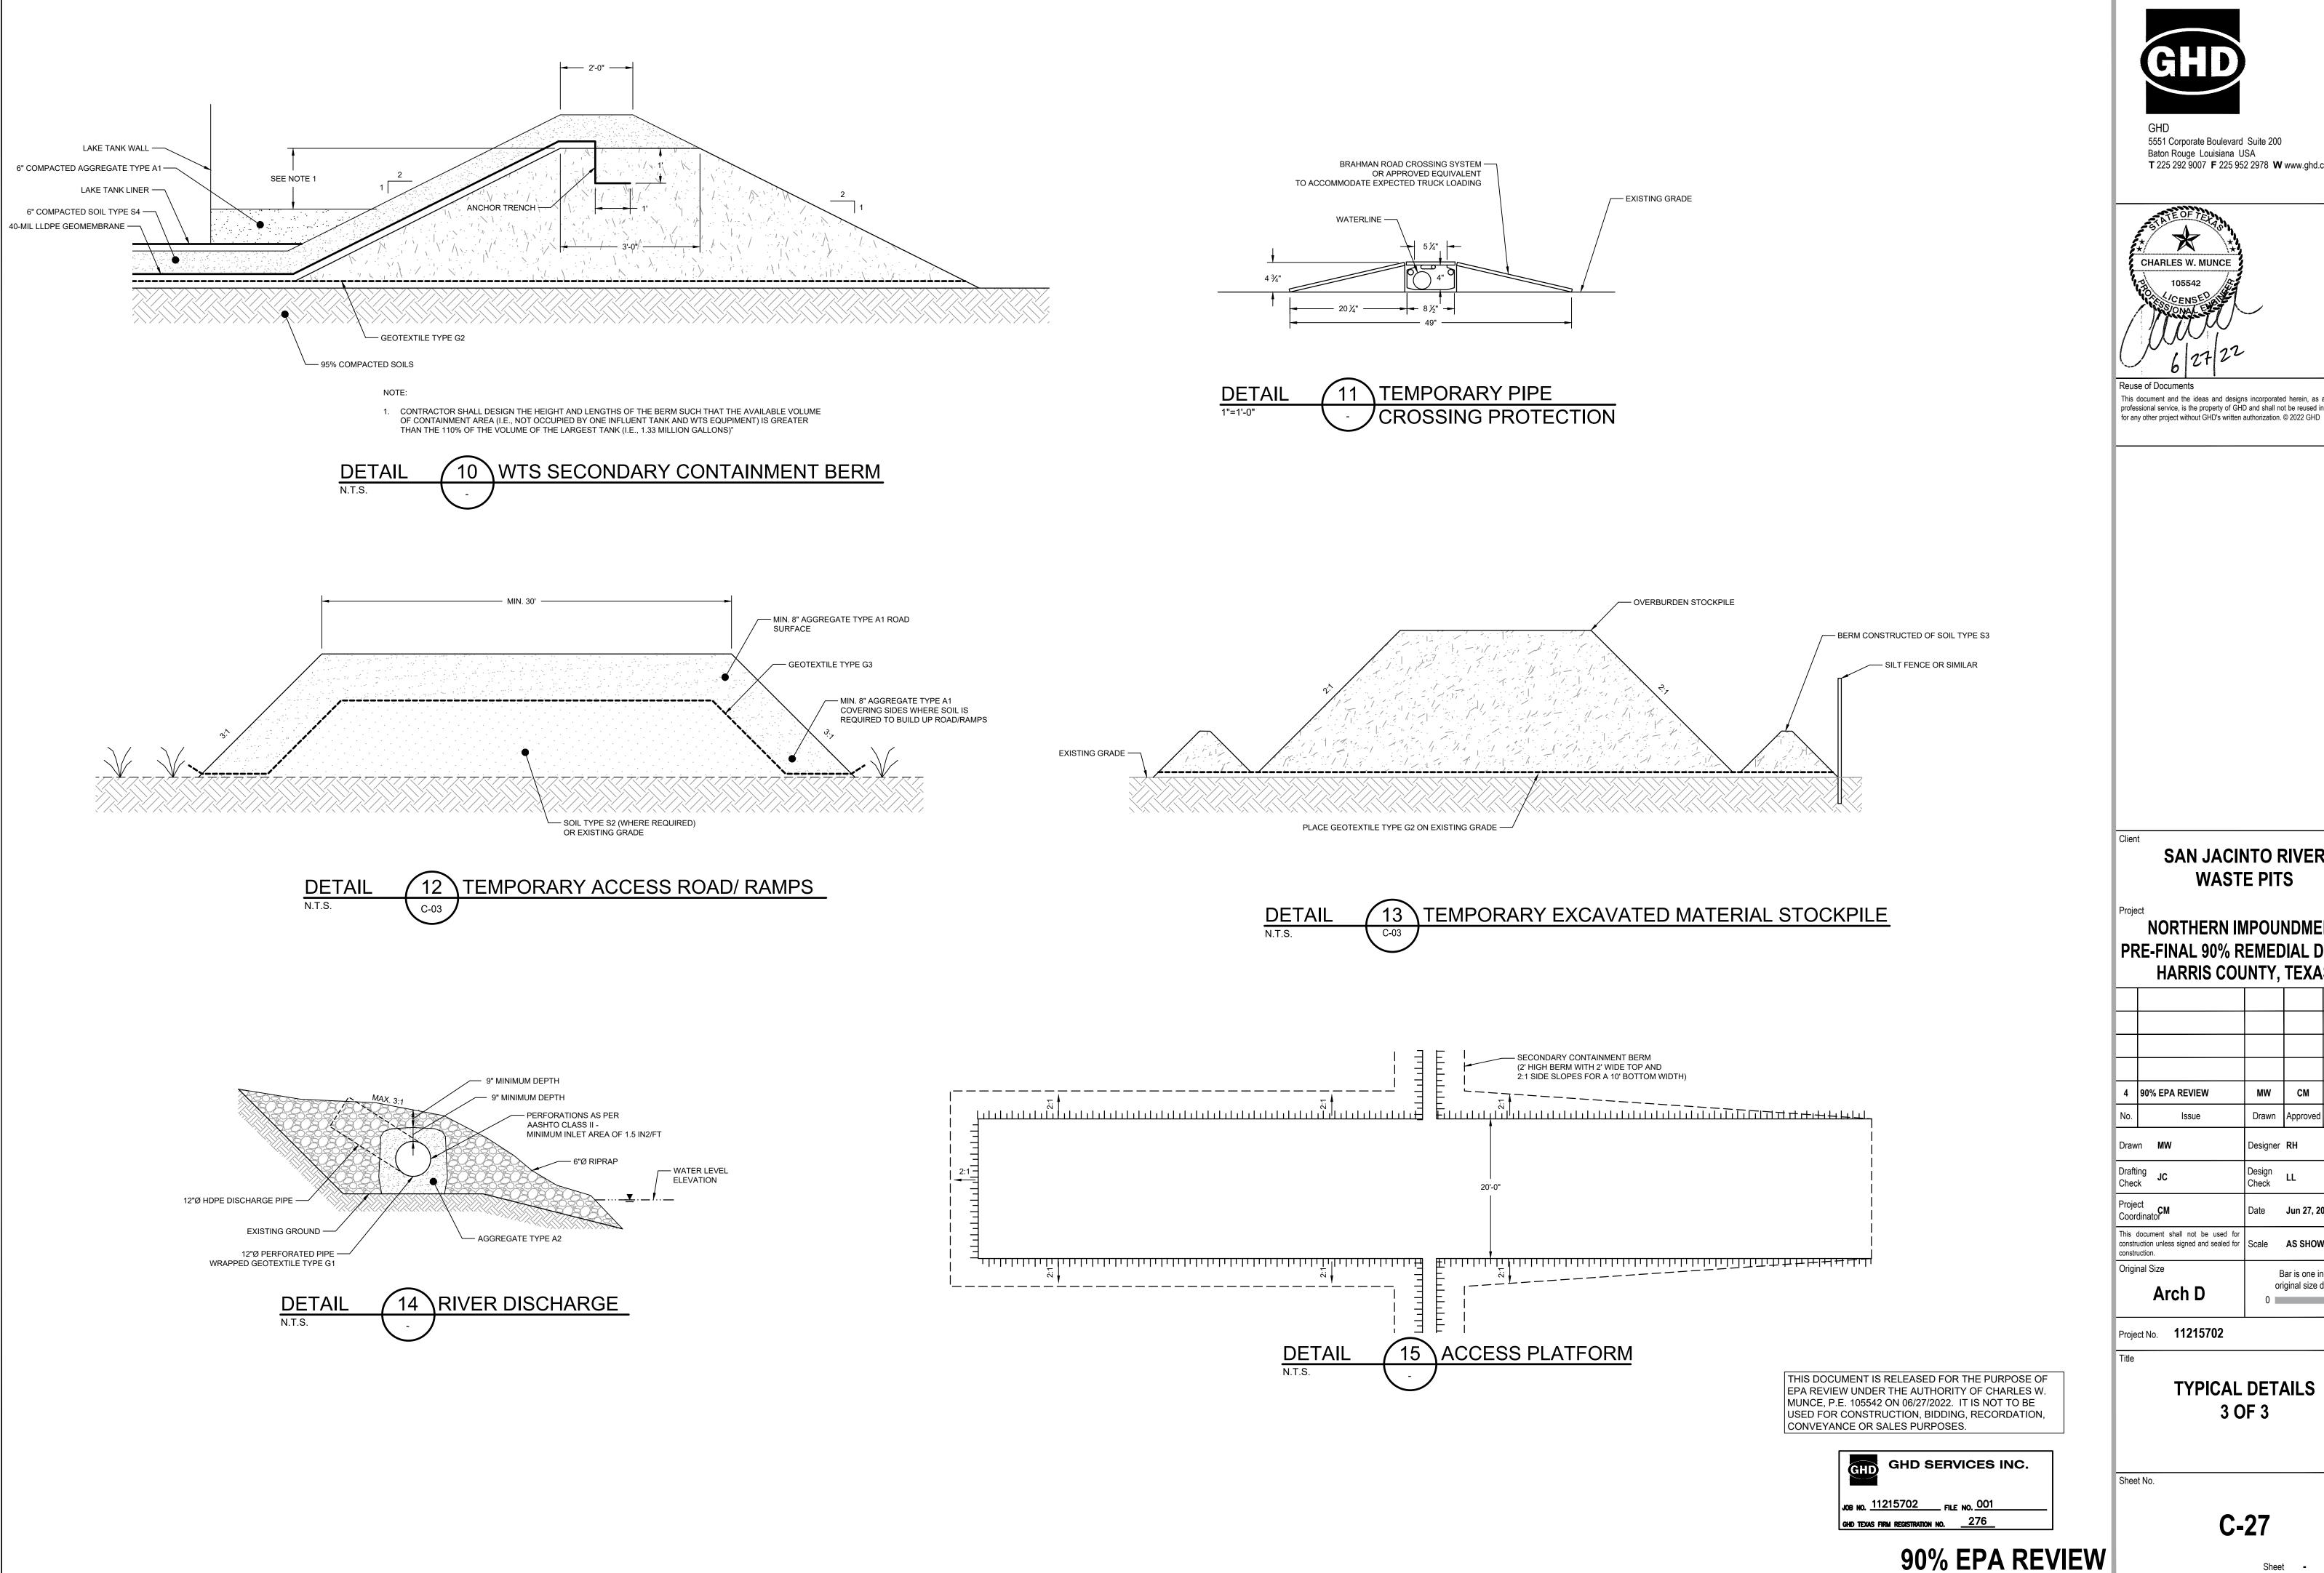

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> **SAN JACINTO RIVER WASTE PITS**

NORTHERN IMPOUNDMENT PRE-FINAL 90% REMEDIAL DESIGN HARRIS COUNTY, TEXAS


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No.	Issue	Drawn	Approved	Date
Draw	n MW	Designer	RH	
Drafti Chec	• .I(.	Design Check	LL	
Project CM Coordinator		Date	Jun 27, 20)22
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original size drawing

TYPICAL DETAILS 3 OF 3

> **C-27** Sheet - of -

Bar is one inch on

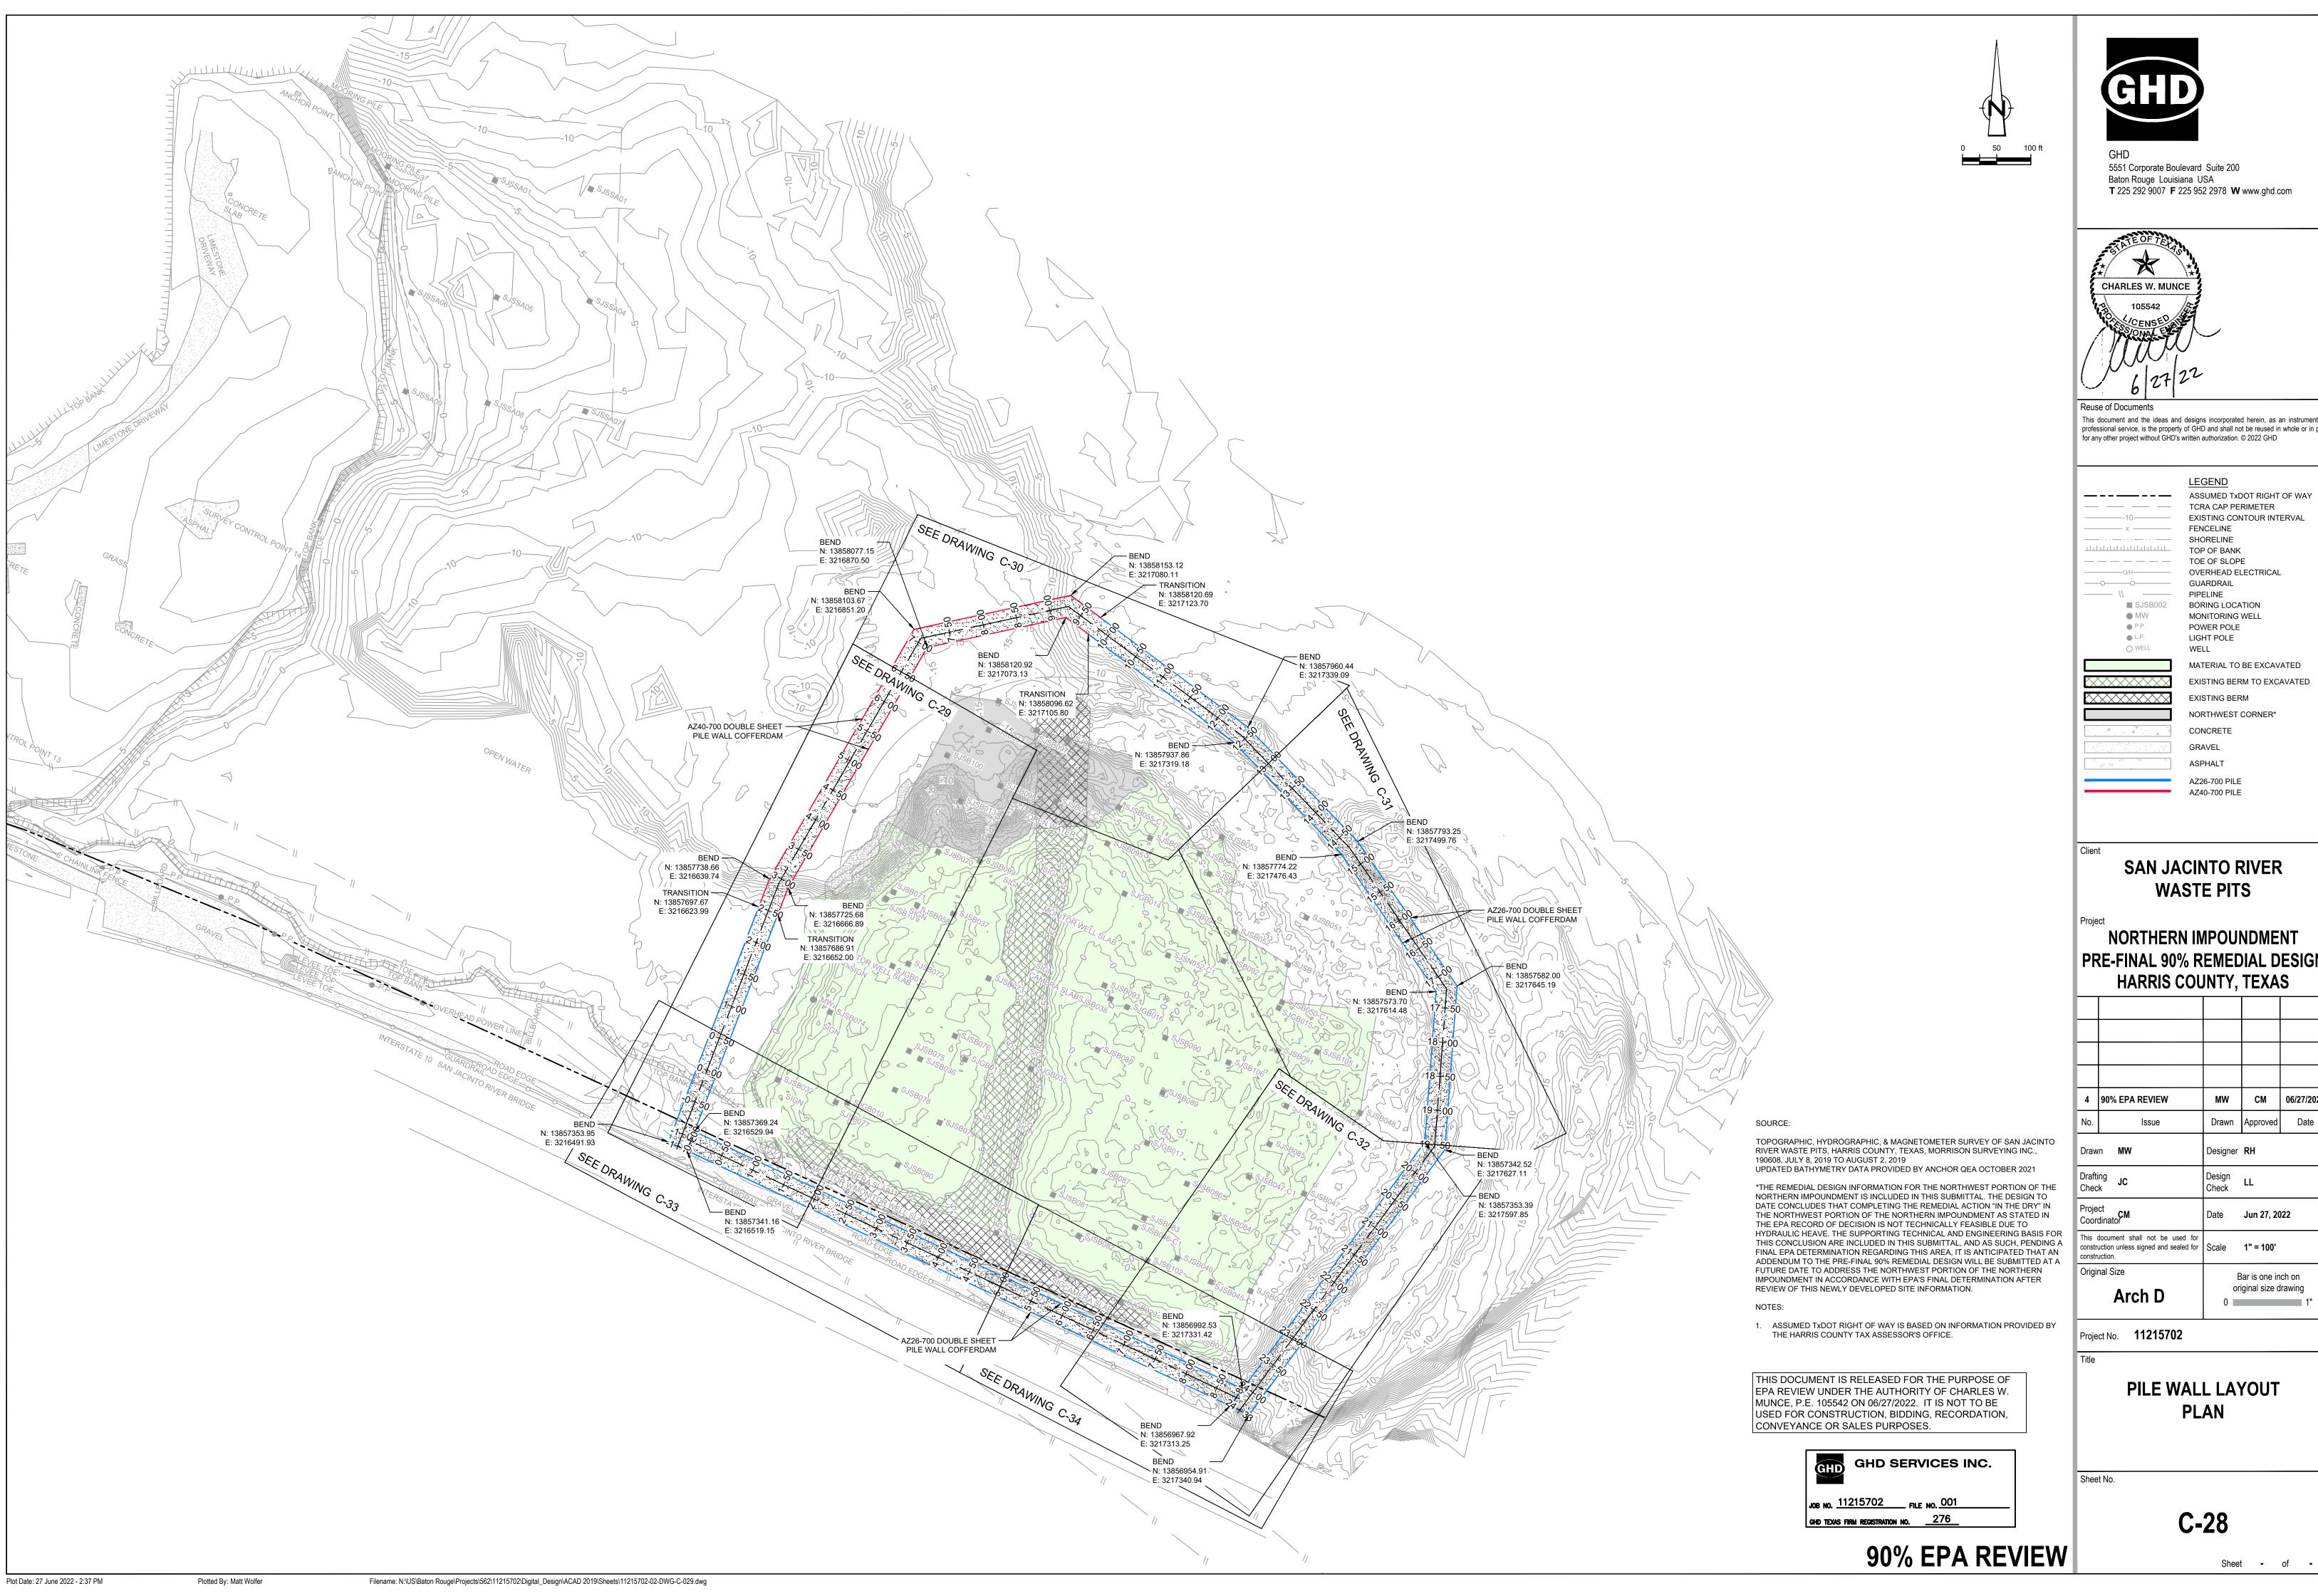



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PRE-FINAL 90% REMEDIAL DESIGN

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1					
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1					
1	4	90% EPA REVIEW	MW	СМ	06/27/2022
1	No.	Issue	Drawn	Approved	Date
ı	Draw	n MW	Designer	RH	
ı	Drafti Chec		Design Check	LL	
ı	Proje Coor	ct CM dinator	Date	Jun 27, 20)22

original size drawing



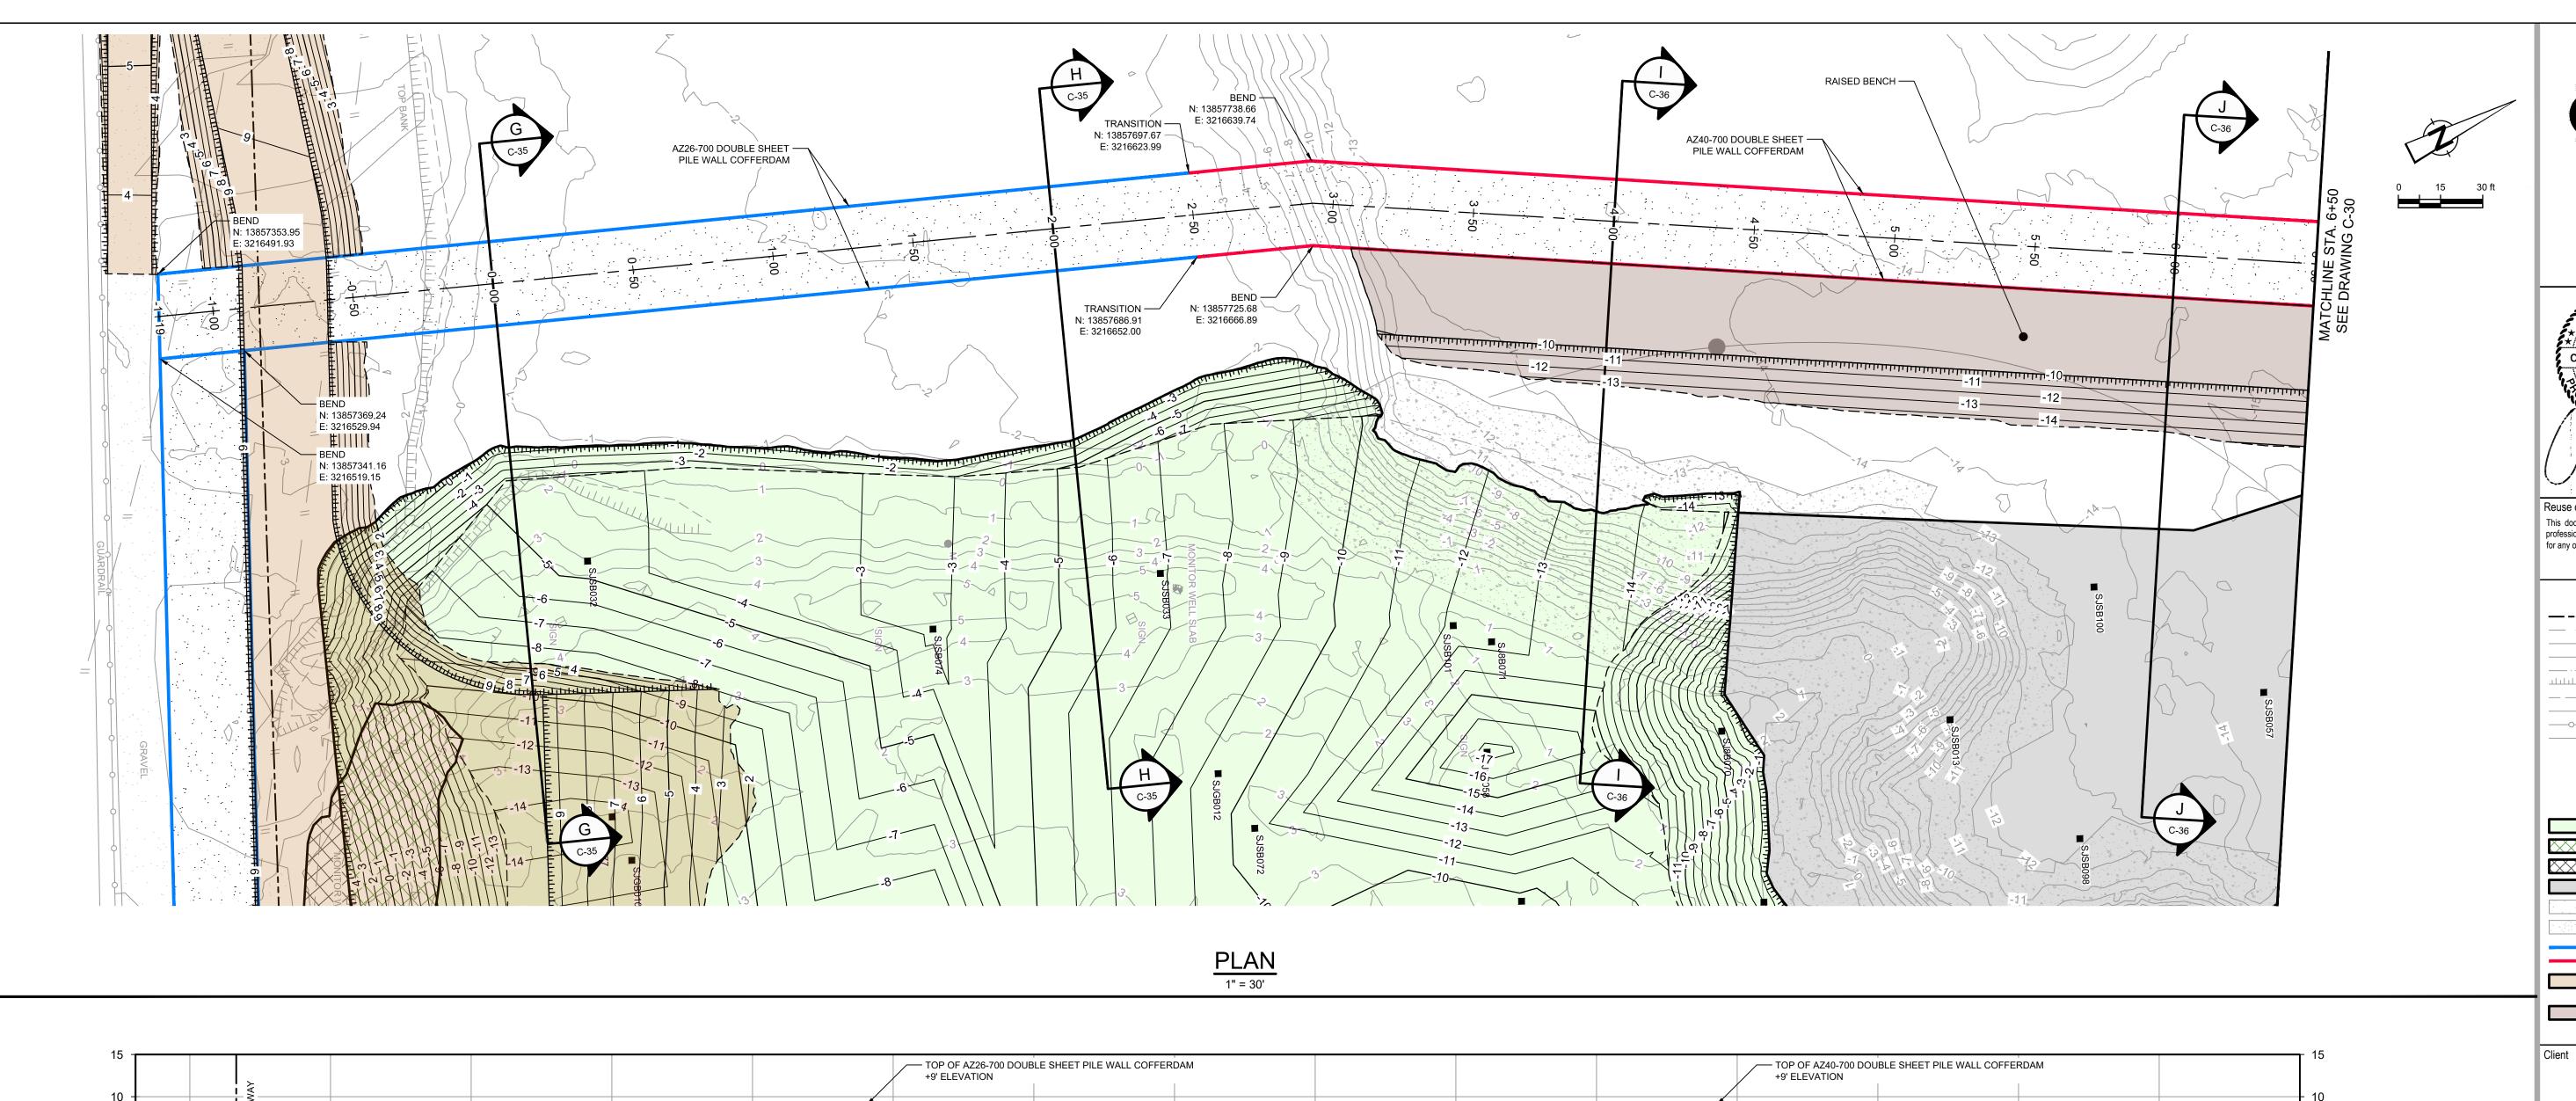

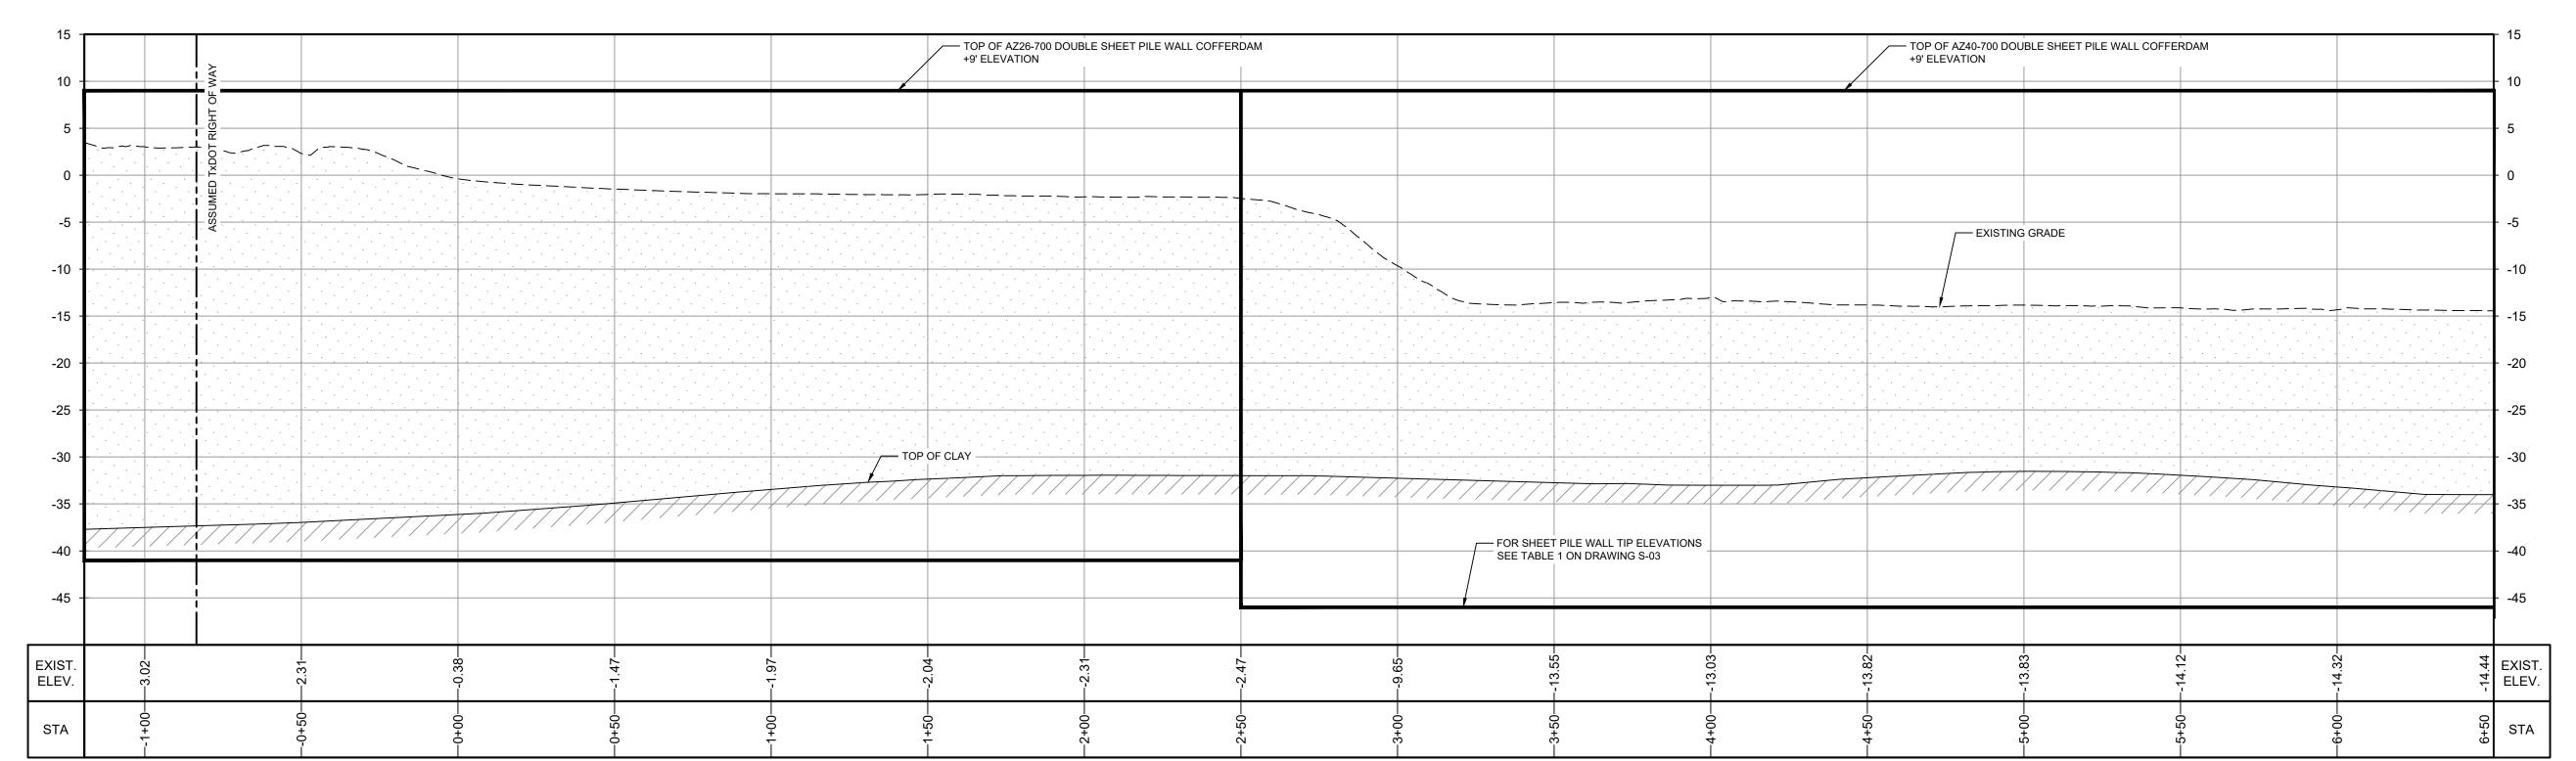SOURCE:

TOPOGRAPHIC, HYDROGRAPHIC, & MAGNETOMETER SURVEY OF SAN JACINTO RIVER WASTE PITS, HARRIS COUNTY, TEXAS, MORRISON SURVEYING INC., 190608, JULY 8, 2019 TO AUGUST 2, 2019 UPDATED BATHYMETRY DATA PROVIDED BY ANCHOR QEA OCTOBER 2021

1. ASSUMED TXDOT RIGHT OF WAY IS BASED ON INFORMATION PROVIDED BY THE HARRIS COUNTY TAX ASSESSOR'S OFFICE. 2. FINAL EXCAVATION CONTOURS ARE SUBJECT TO CHANGE.

PROFILE HORIZ: 1" = 30' VERT: 1" = 10'

*THE REMEDIAL DESIGN INFORMATION FOR THE NORTHWEST PORTION OF THE NORTHERN IMPOUNDMENT IS INCLUDED IN THIS SUBMITTAL. THE DESIGN TO DATE CONCLUDES THAT COMPLETING THE REMEDIAL ACTION "IN THE DRY" IN THE NORTHWEST PORTION OF THE NORTHERN IMPOUNDMENT AS STATED IN THE EPA RECORD OF DECISION IS NOT TECHNICALLY FEASIBLE DUE TO HYDRAULIC HEAVE. THE SUPPORTING TECHNICAL AND ENGINEERING BASIS FOR THIS CONCLUSION ARE INCLUDED IN THIS SUBMITTAL, AND AS SUCH, PENDING A FINAL EPA DETERMINATION REGARDING THIS AREA, IT IS ANTICIPATED THAT AN ADDENDUM TO THE PRE-FINAL 90% REMEDIAL DESIGN WILL BE SUBMITTED AT A FUTURE DATE TO ADDRESS THE NORTHWEST PORTION OF THE NORTHERN IMPOUNDMENT IN ACCORDANCE WITH EPA'S FINAL DETERMINATION AFTER REVIEW OF THIS NEWLY DEVELOPED SITE INFORMATION.


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	LEGEND
	ASSUMED TXDOT RIGHT OF WAY
	TCRA CAP PERIMETER
-10	EXISTING CONTOUR INTERVAL
X	FENCELINE
	SHORELINE
	TOP OF BANK
	TOE OF SLOPE
O/H	OVERHEAD ELECTRICAL
-	GUARDRAIL
//	PIPELINE
■ SJSB002	BORING LOCATION
MVV	MONITORING WELL
● P.P.	POWER POLE
● L.P.	LIGHT POLE
O WELL	WELL
	MATERIAL TO BE EXCAVATED
	EXISTING BERM TO EXCAVATED
	EXISTING BERM


EXISTING BERM NORTHWEST CORNER* CONCRETE GRAVEL

AZ26-700 PILE AZ40-700 PILE PLANNED IMPROVEMENTS FOR NORTHERN IMPOUNDMENT ACCESS

RAISED BENCH

SAN JACINTO RIVER WASTE PITS

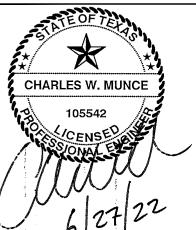NORTHERN IMPOUNDMENT PRE-FINAL 90% REMEDIAL DESIGN HARRIS COUNTY, TEXAS

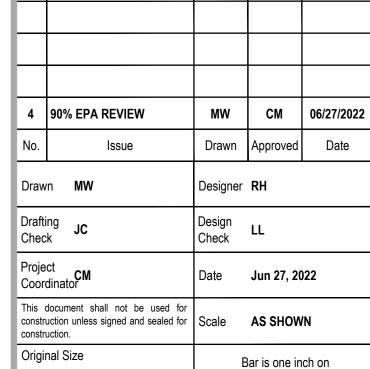

Arch D

Project No. **11215702**

DOUBLE PILE WALL PLAN AND PROFILE 1 OF 4

original size drawing

0 1"


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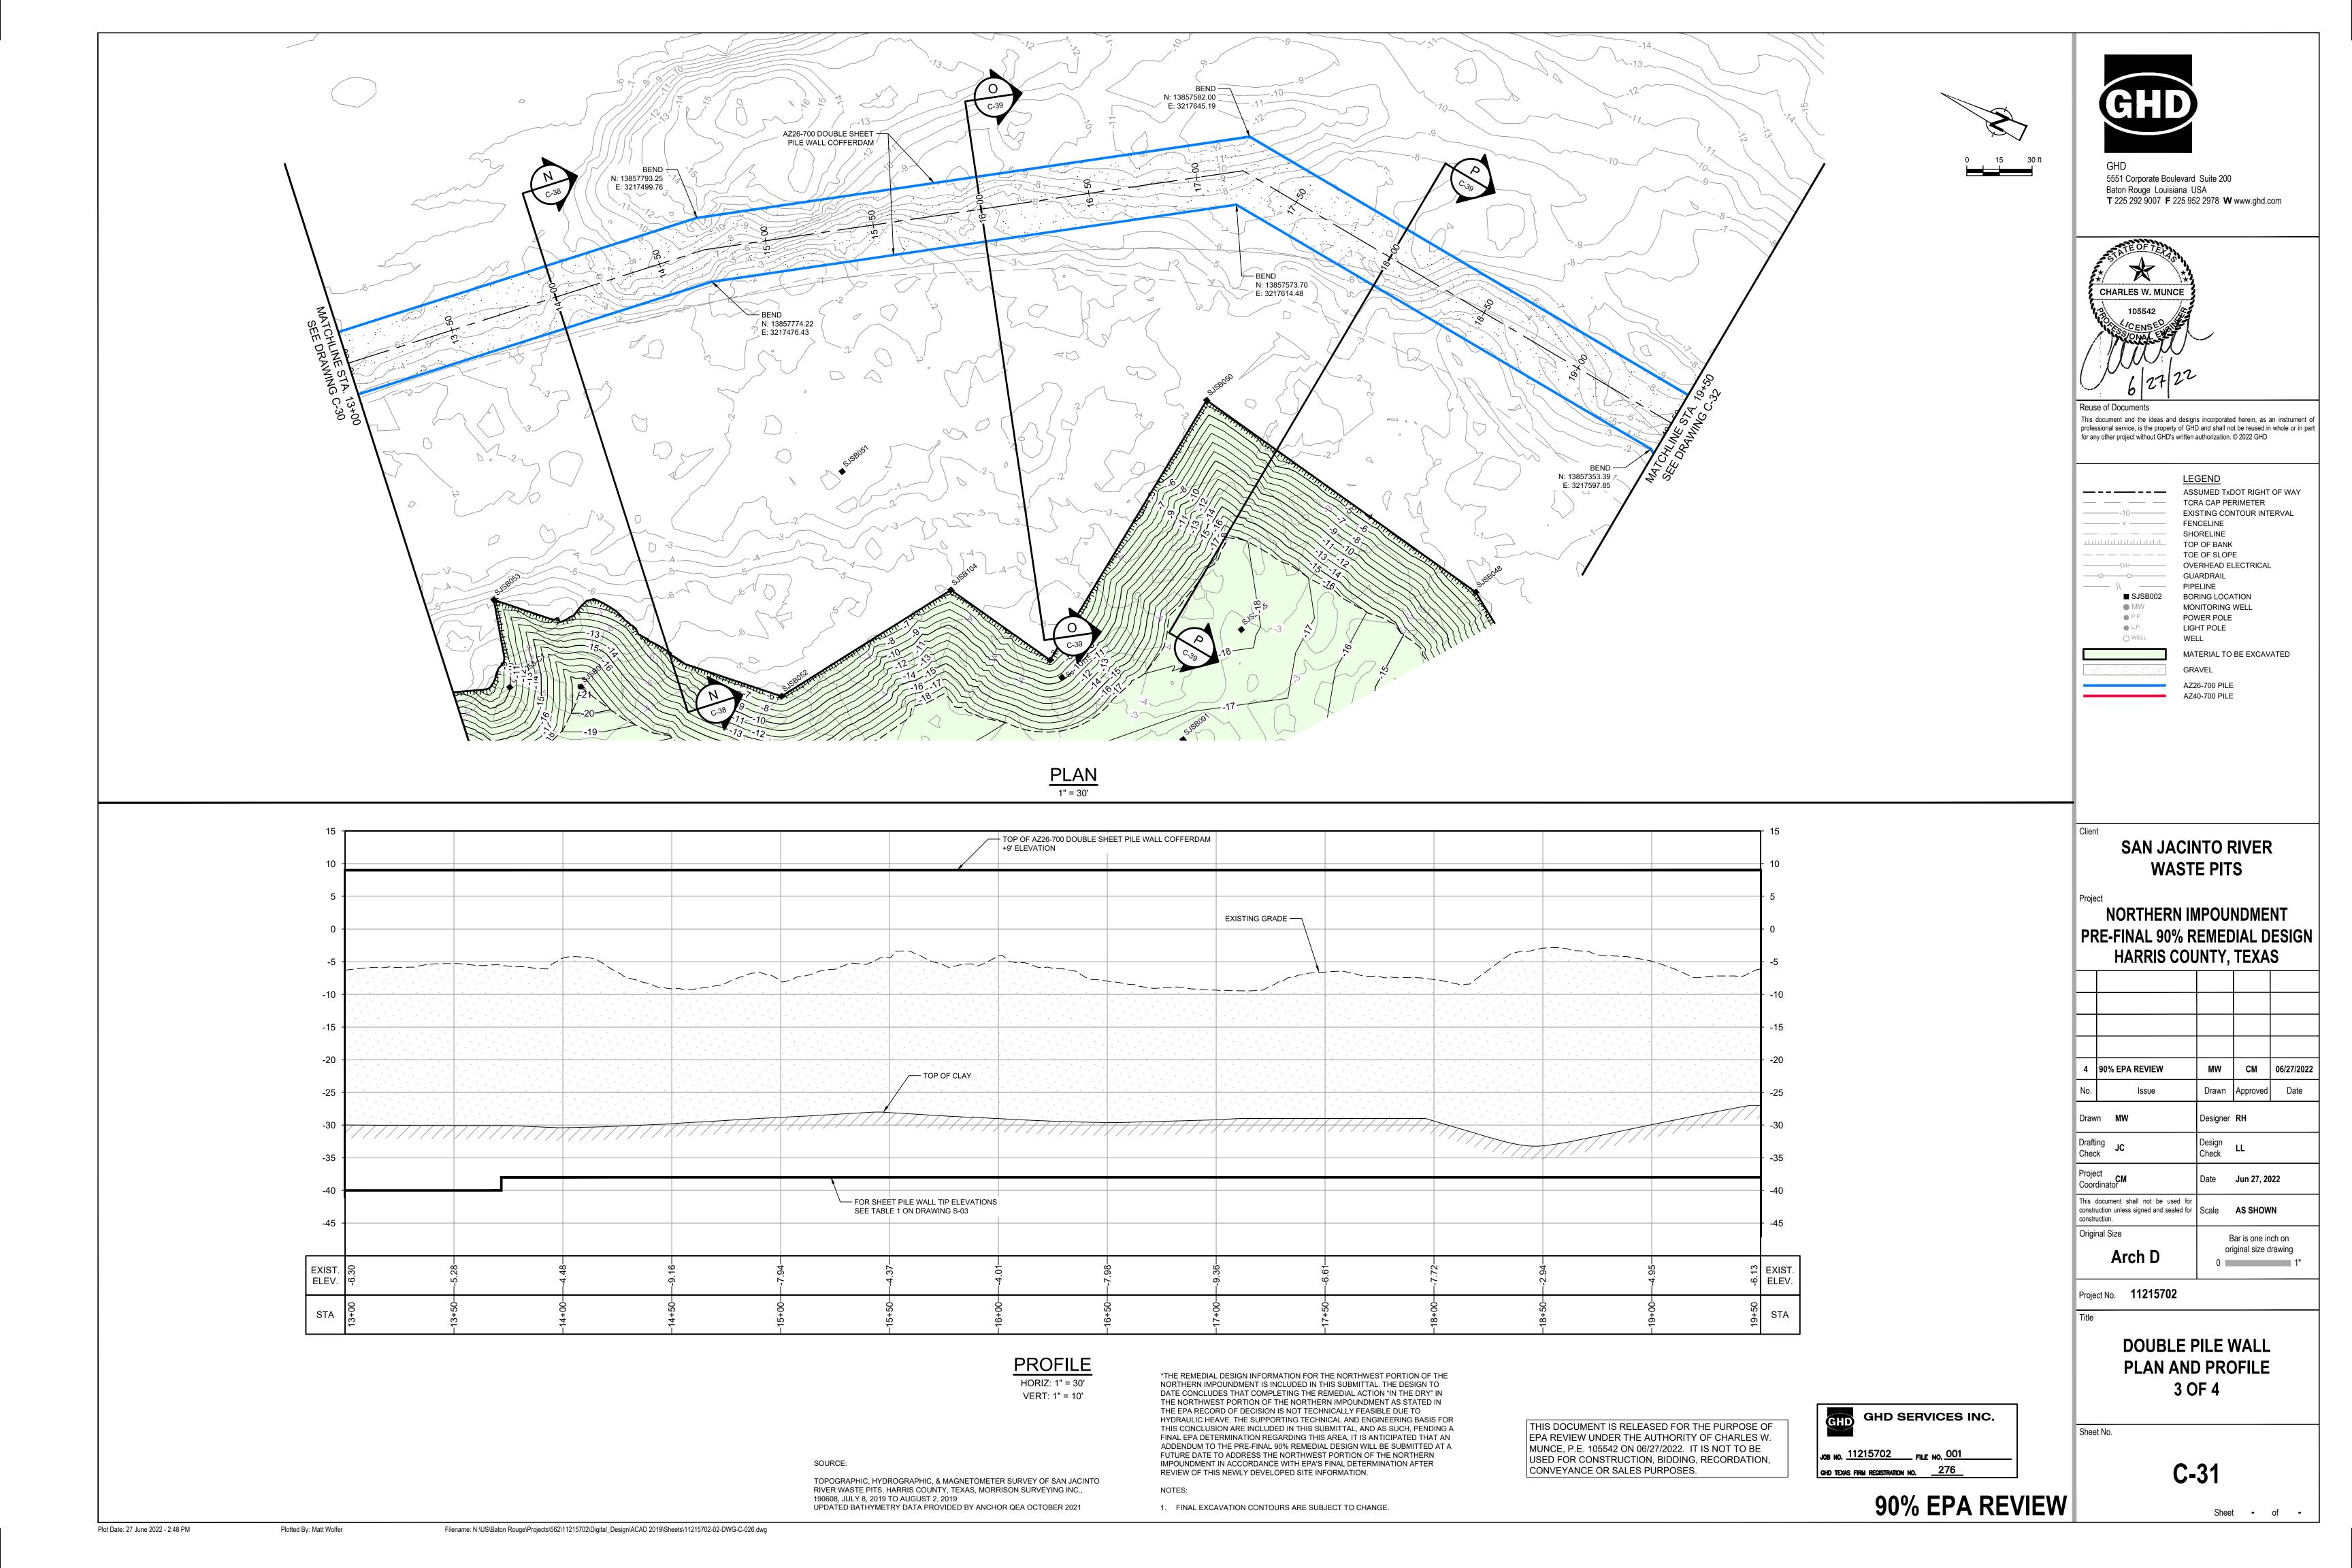
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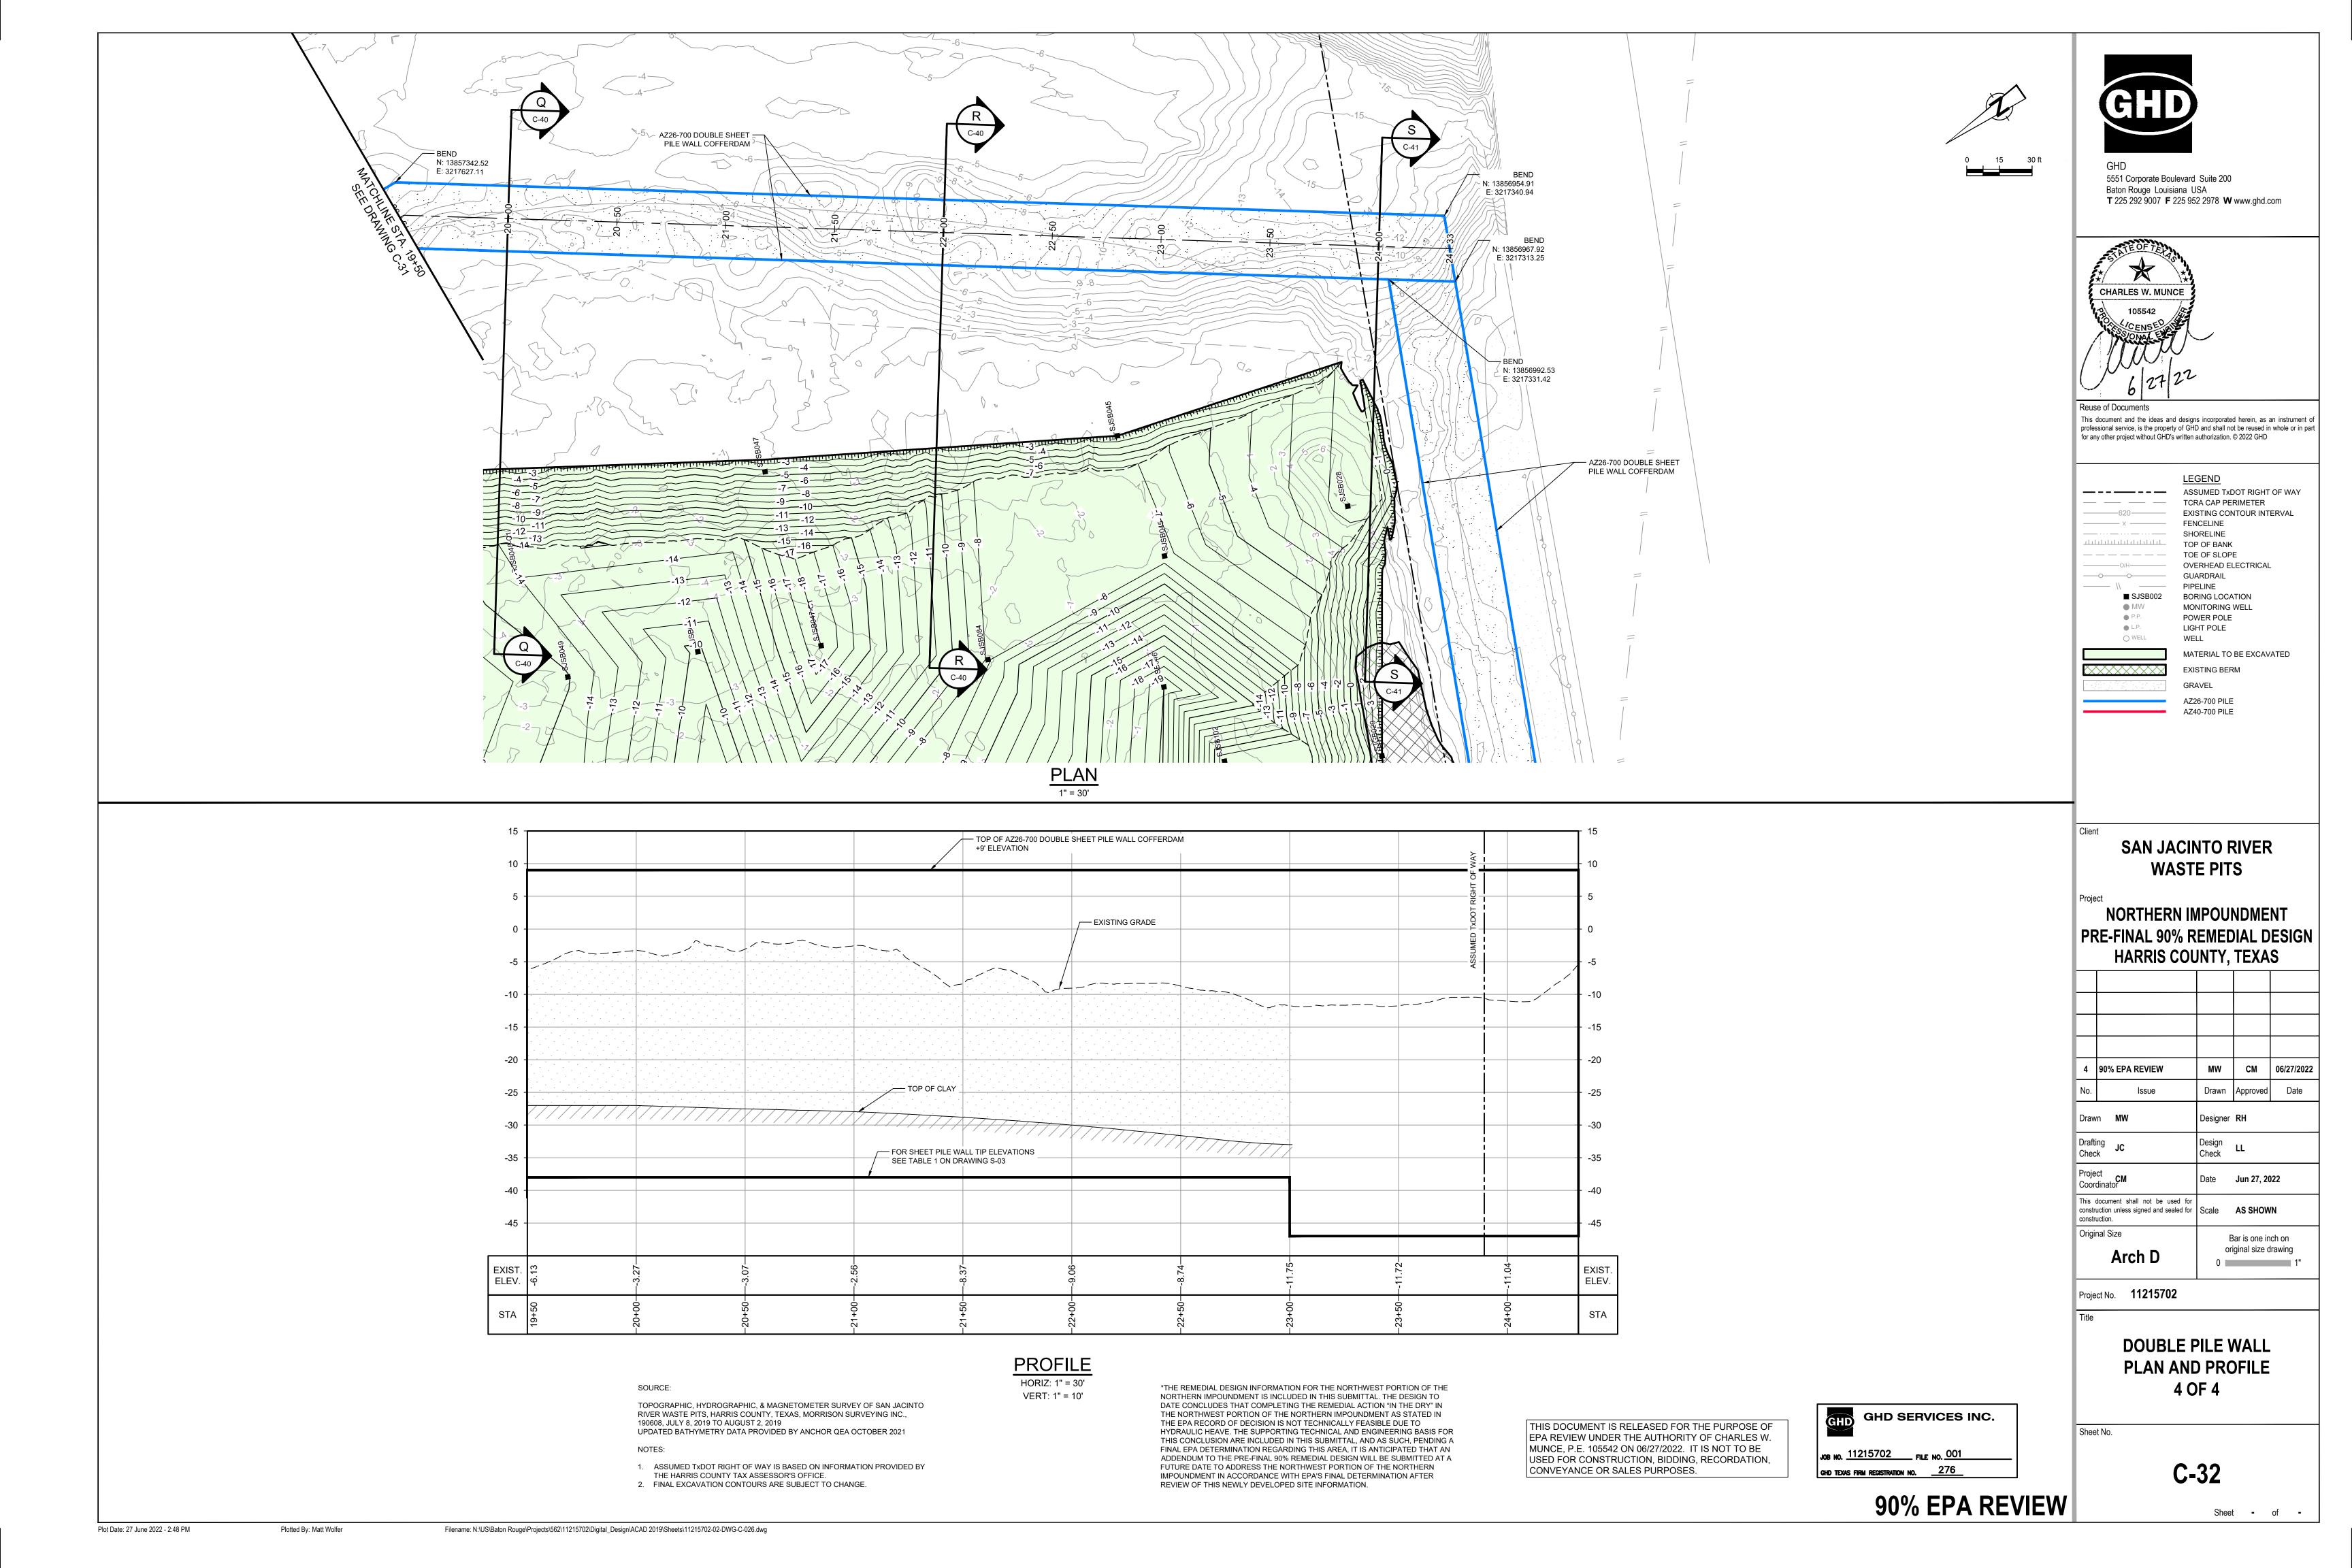
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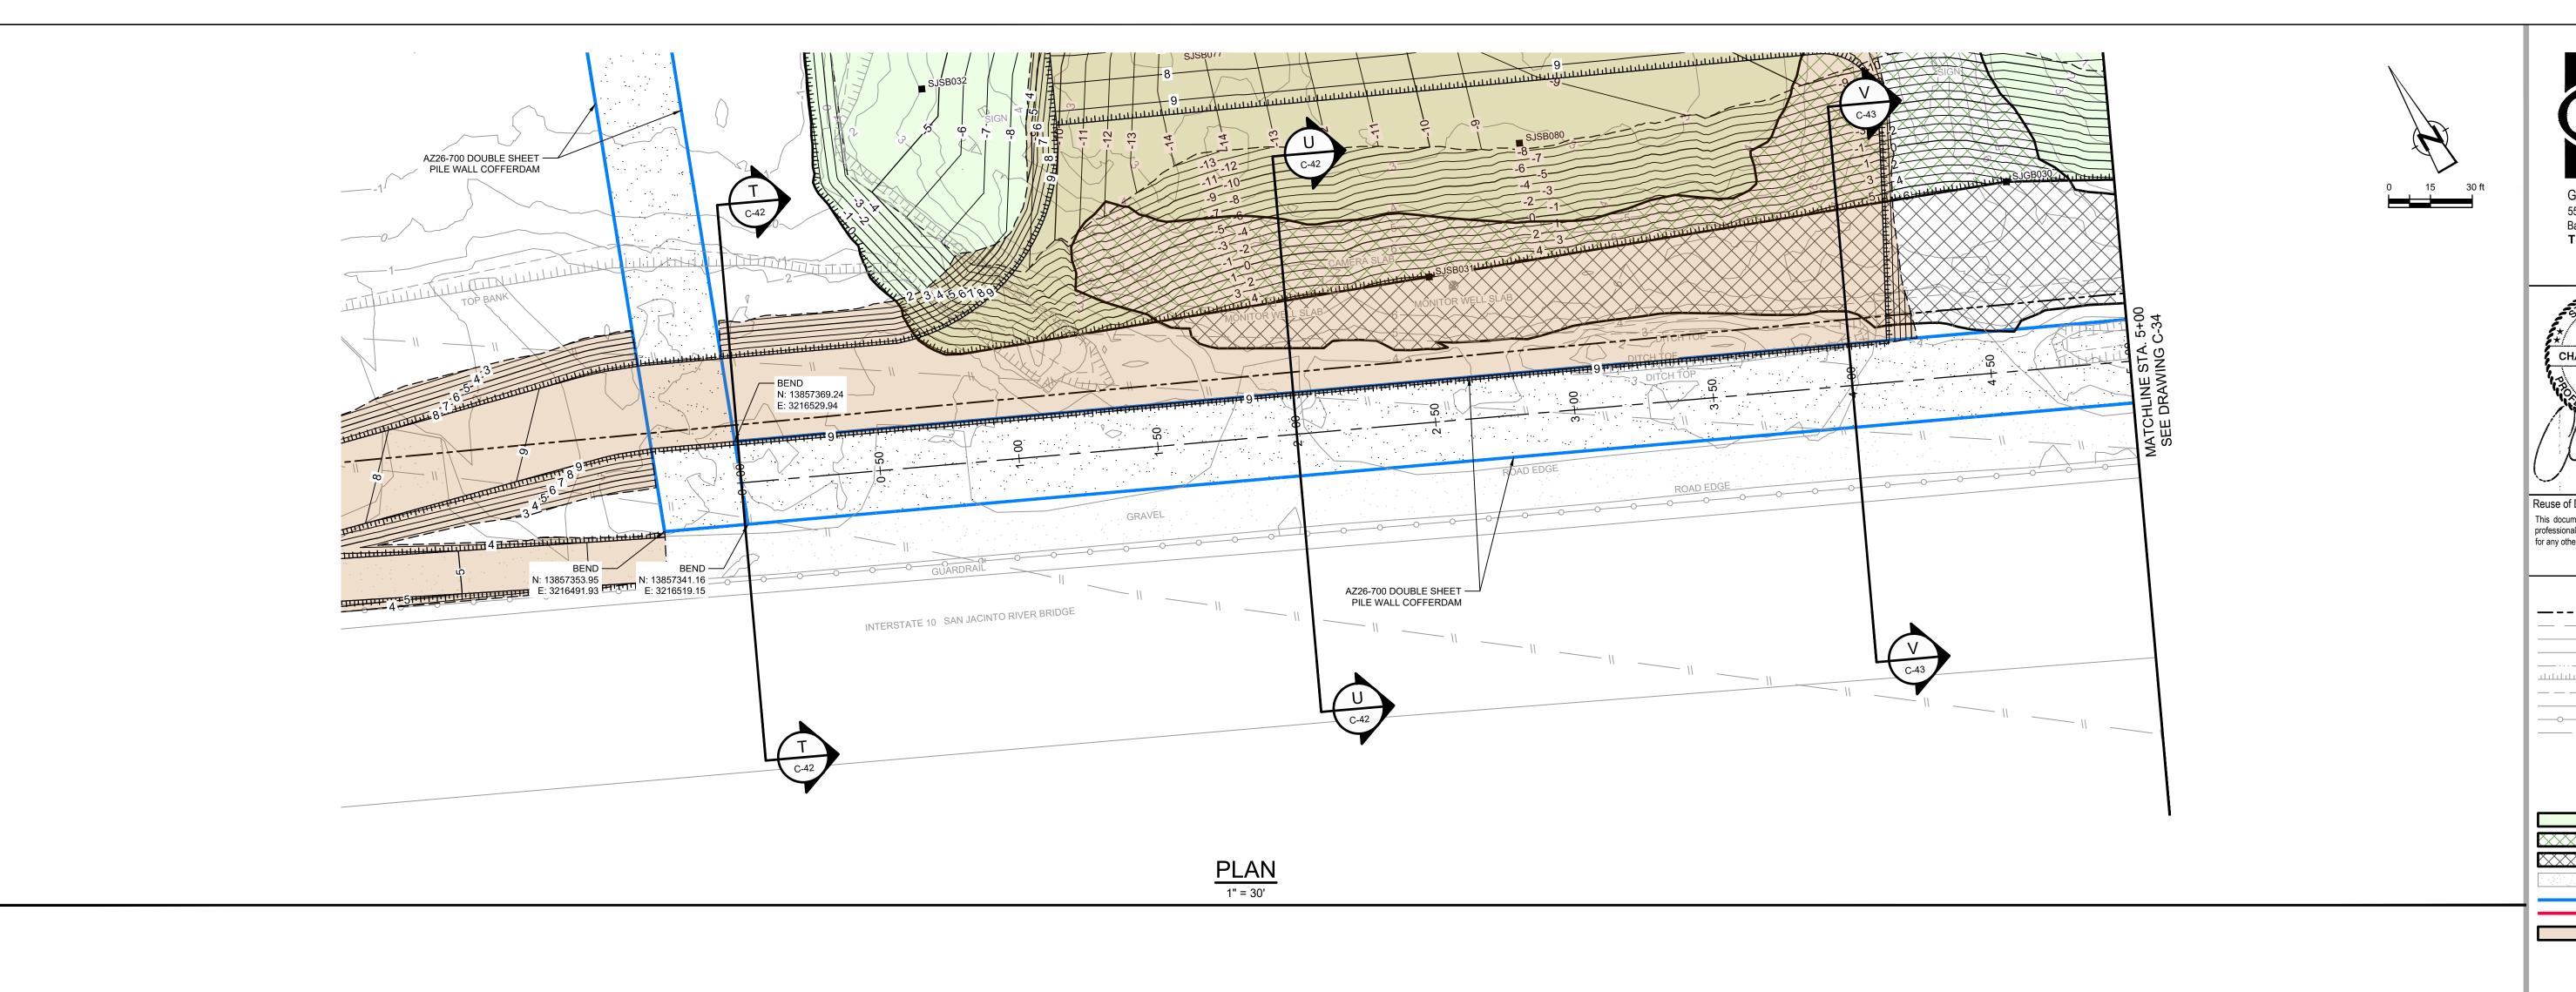
Plotted By: Matt Wolfer


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PROFILE HORIZ: 1" = 30'

VERT: 1" = 10'


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TOPOGRAPHIC, HYDROGRAPHIC, & MAGNETOMETER SURVEY OF SAN JACINTO RIVER WASTE PITS, HARRIS COUNTY, TEXAS, MORRISON SURVEYING INC., 190608, JULY 8, 2019 TO AUGUST 2, 2019 UPDATED BATHYMETRY DATA PROVIDED BY ANCHOR QEA OCTOBER 2021

- 1. ASSUMED TXDOT RIGHT OF WAY IS BASED ON INFORMATION PROVIDED BY
- THE HARRIS COUNTY TAX ASSESSOR'S OFFICE.

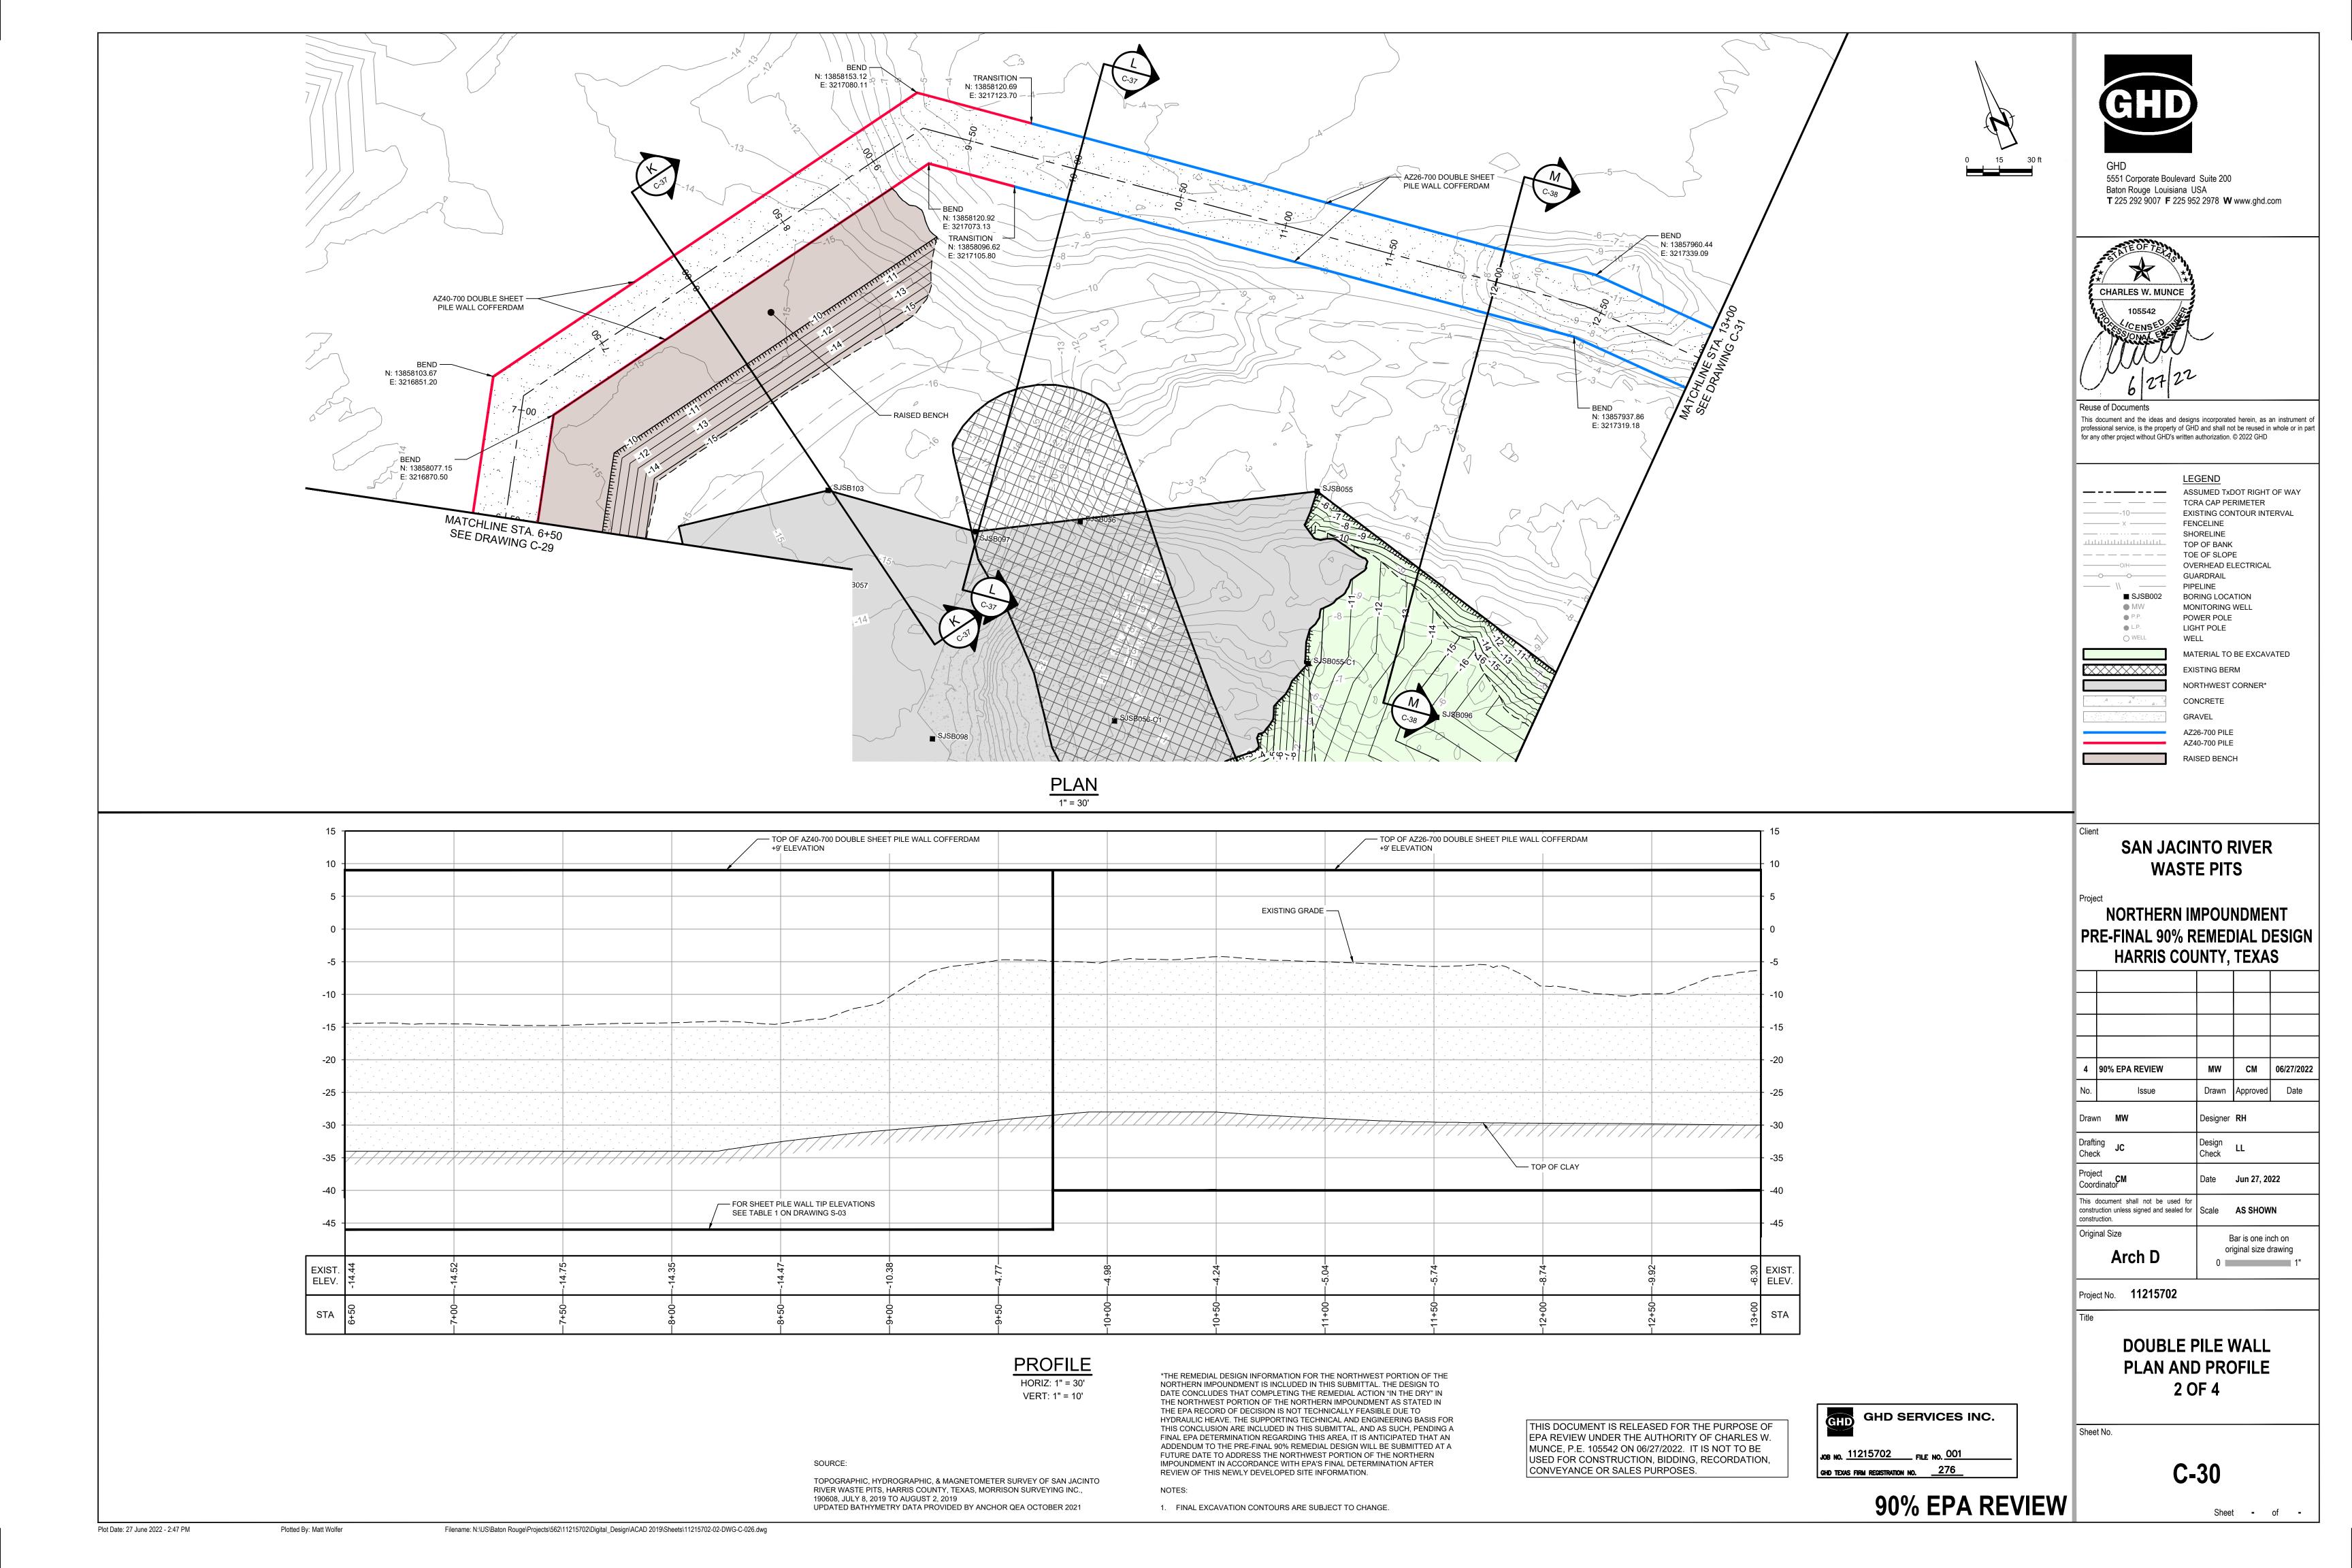
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	LEGEND
	ASSUMED TXDOT RIGHT OF WAY
	TCRA CAP PERIMETER
-10	EXISTING CONTOUR INTERVAL
x	FENCELINE
	SHORELINE
	TOP OF BANK
	TOE OF SLOPE
O/H	OVERHEAD ELECTRICAL
O	GUARDRAIL
\\	PIPELINE
■ SJSB002	BORING LOCATION
MW	MONITORING WELL
P.P.	POWER POLE
■ L.P.	LIGHT POLE
O WELL	WELL

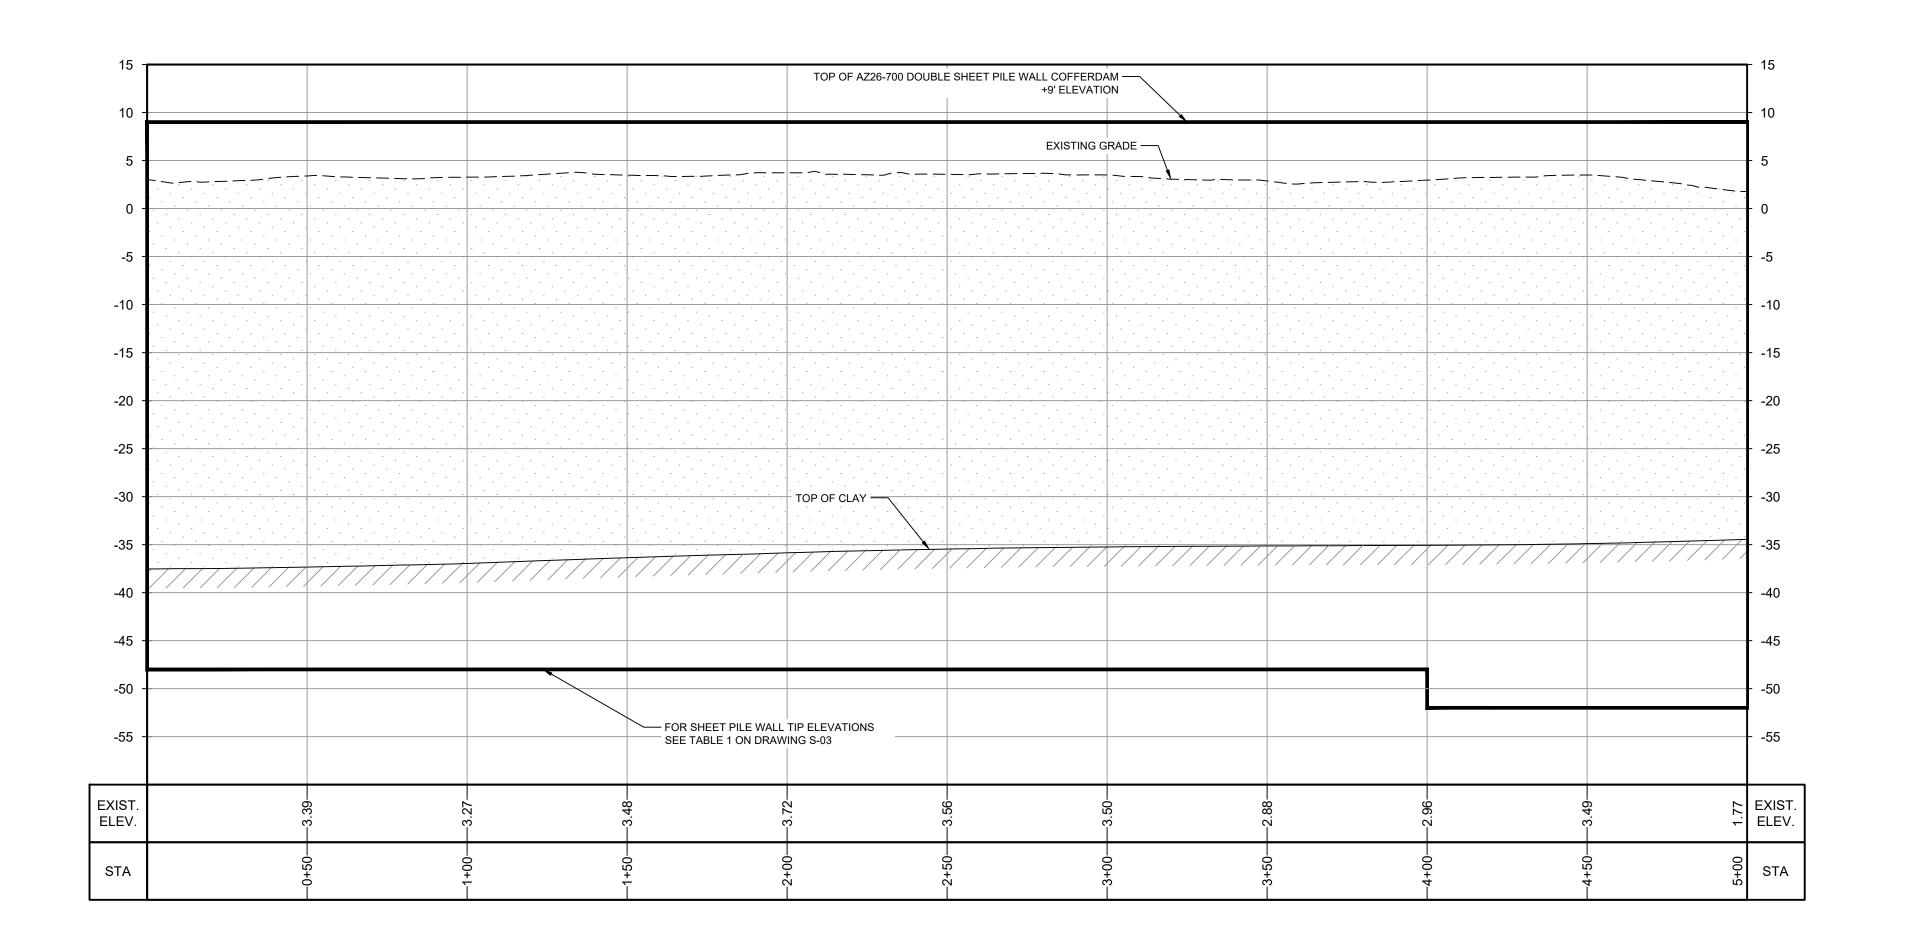MATERIAL TO BE EXCAVATED EXISTING BERM TO EXCAVATED EXISTING BERM

> GRAVEL AZ26-700 PILE AZ40-700 PILE PLANNED IMPROVEMENTS FOR NORTHERN IMPOUNDMENT ACCESS

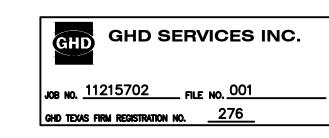SAN JACINTO RIVER WASTE PITS

NORTHERN IMPOUNDMENT PRE-FINAL 90% REMEDIAL DESIGN HARRIS COUNTY, TEXAS

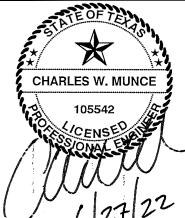4	90% EPA REVIEW	MW	СМ	06/27
No.	Issue	Drawn	Approved	Da
Drawn MW		Designer RH		
Drafting JC Check		Design Check	LL	
Project CM Coordinator		Date	Jun 27, 2022	
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Original Size Bar is one inch on original size drawing Arch D 0 ______ 1"

Project No. **11215702**

SOUTH WALL PLAN AND PROFILE 1 OF 2


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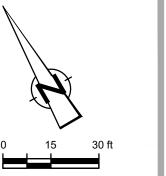
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Sheet - of -


90% EPA REVIEW

Plot Date: 27 June 2022 - 2:42 PM






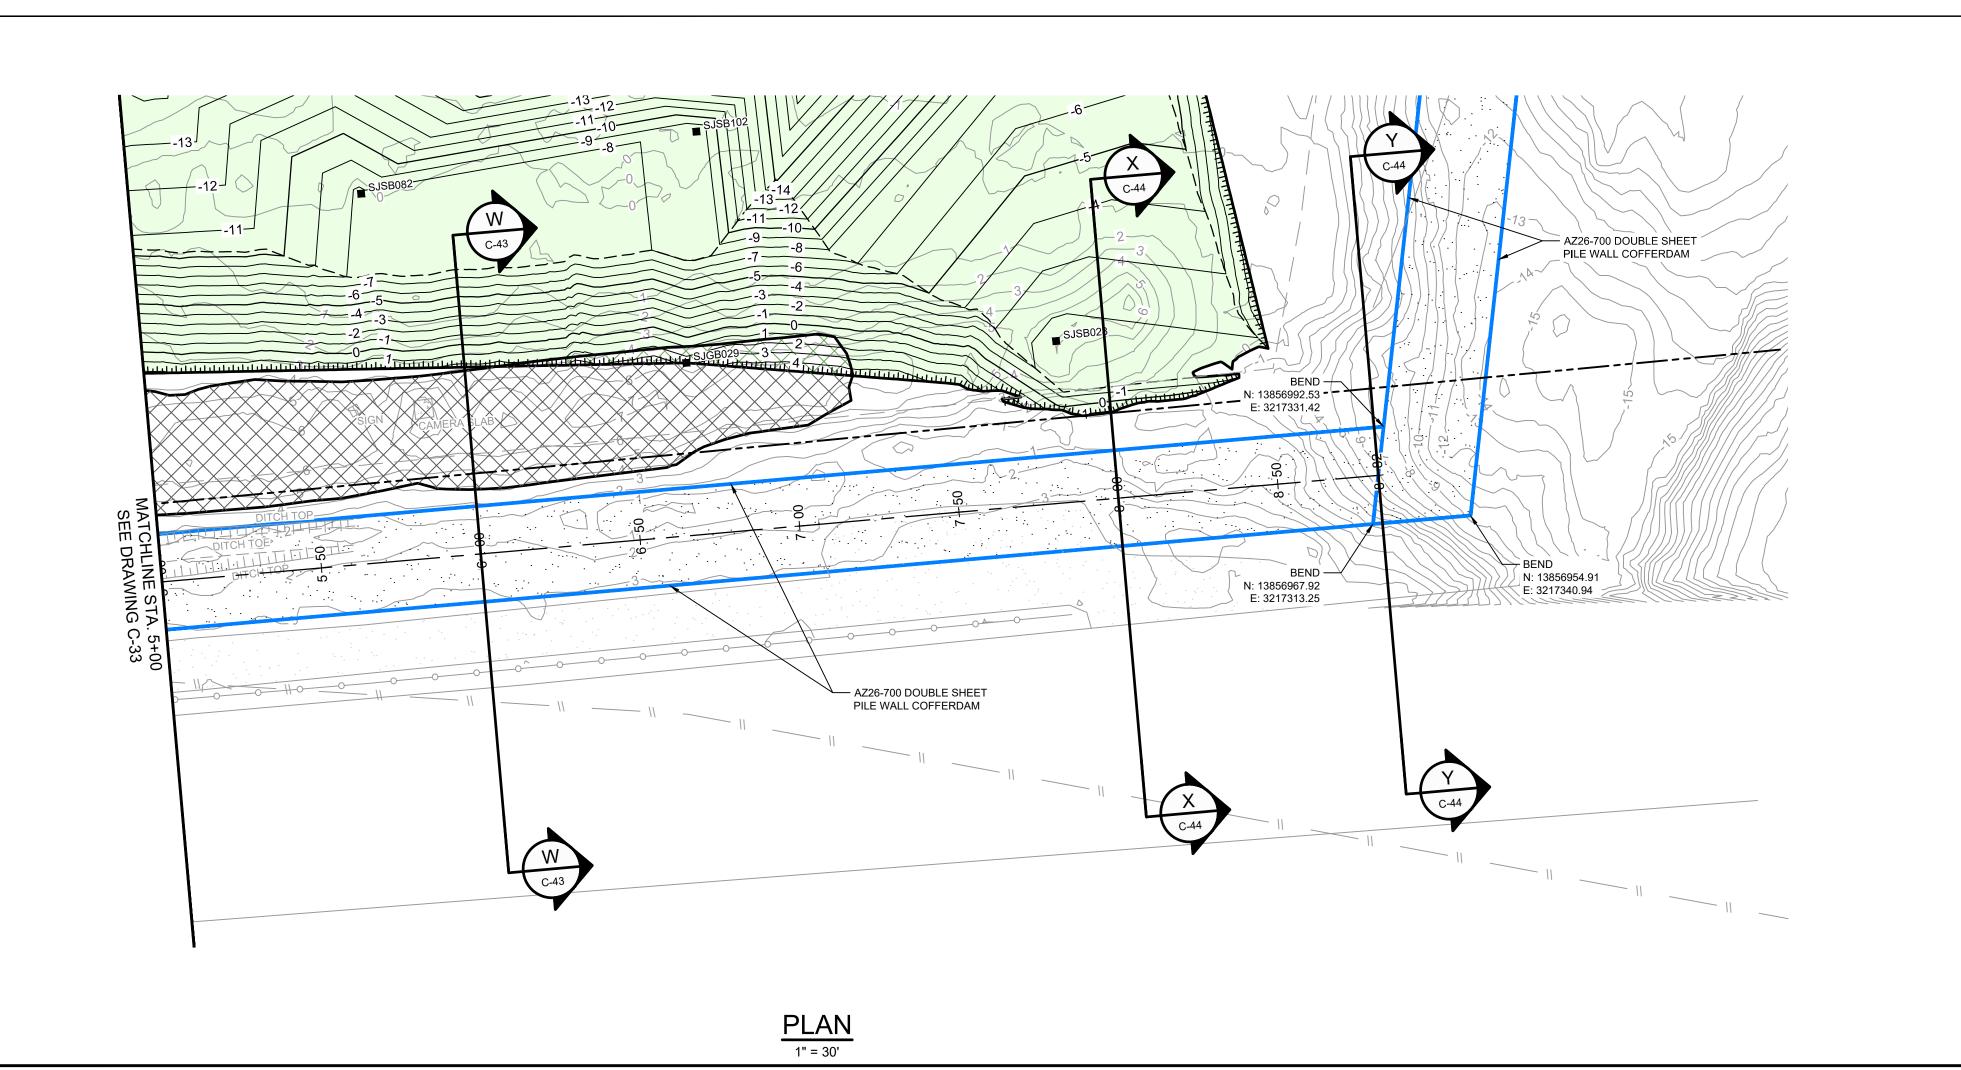

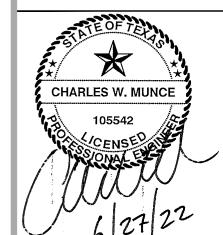

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MONITORING WELL POWER POLE LIGHT POLE WELL


MATERIAL TO BE EXCAVATED EXISTING BERM TO EXCAVATED **EXISTING BERM**

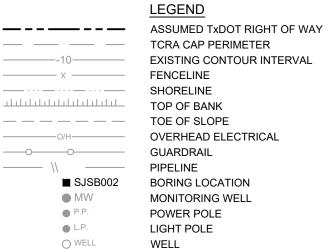AZ26-700 PILE AZ40-700 PILE

GRAVEL

SAN JACINTO RIVER WASTE PITS

NORTHERN IMPOUNDMENT PRE-FINAL 90% REMEDIAL DESIGN HARRIS COUNTY, TEXAS

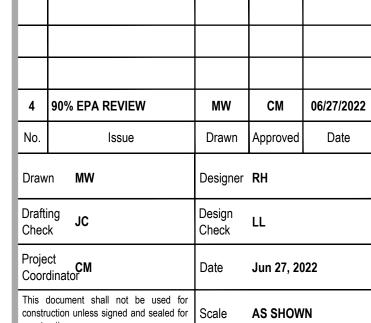

Original Size

Bar is one inch on original size drawing Arch D 0 ______ 1"

Project No. **11215702**

construction.

SOUTH WALL PLAN AND PROFILE 2 OF 2

Sheet No.

C-34

Sheet - of -

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TOPOGRAPHIC, HYDROGRAPHIC, & MAGNETOMETER SURVEY OF SAN JACINTO RIVER WASTE PITS, HARRIS COUNTY, TEXAS, MORRISON SURVEYING INC.,

1. ASSUMED TXDOT RIGHT OF WAY IS BASED ON INFORMATION PROVIDED BY

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UPDATED BATHYMETRY DATA PROVIDED BY ANCHOR QEA OCTOBER 2021

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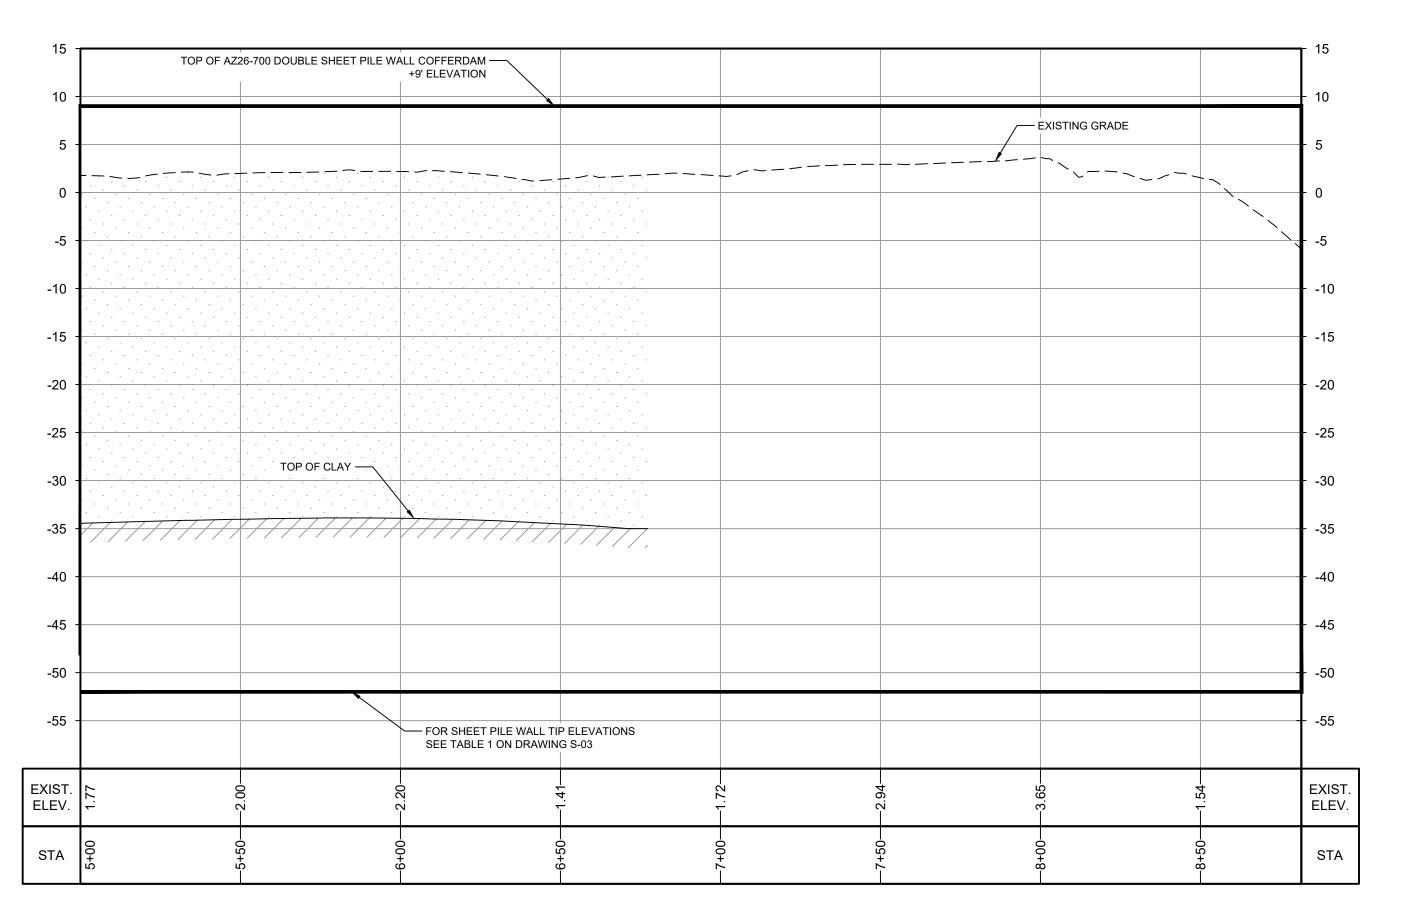
USED FOR CONSTRUCTION, BIDDING, RECORDATION,

JOB NO. 11215702 FILE NO. 001

CONVEYANCE OR SALES PURPOSES.

SOURCE:

190608, JULY 8, 2019 TO AUGUST 2, 2019




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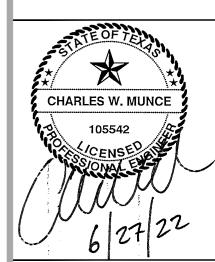
Plotted By: Matt Wolfer

Filename: N:\US\Baton Rouge\Projects\562\11215702\Digital_Design\ACAD 2019\Sheets\11215702-02-DWG-C-027.dwg



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LEGEND

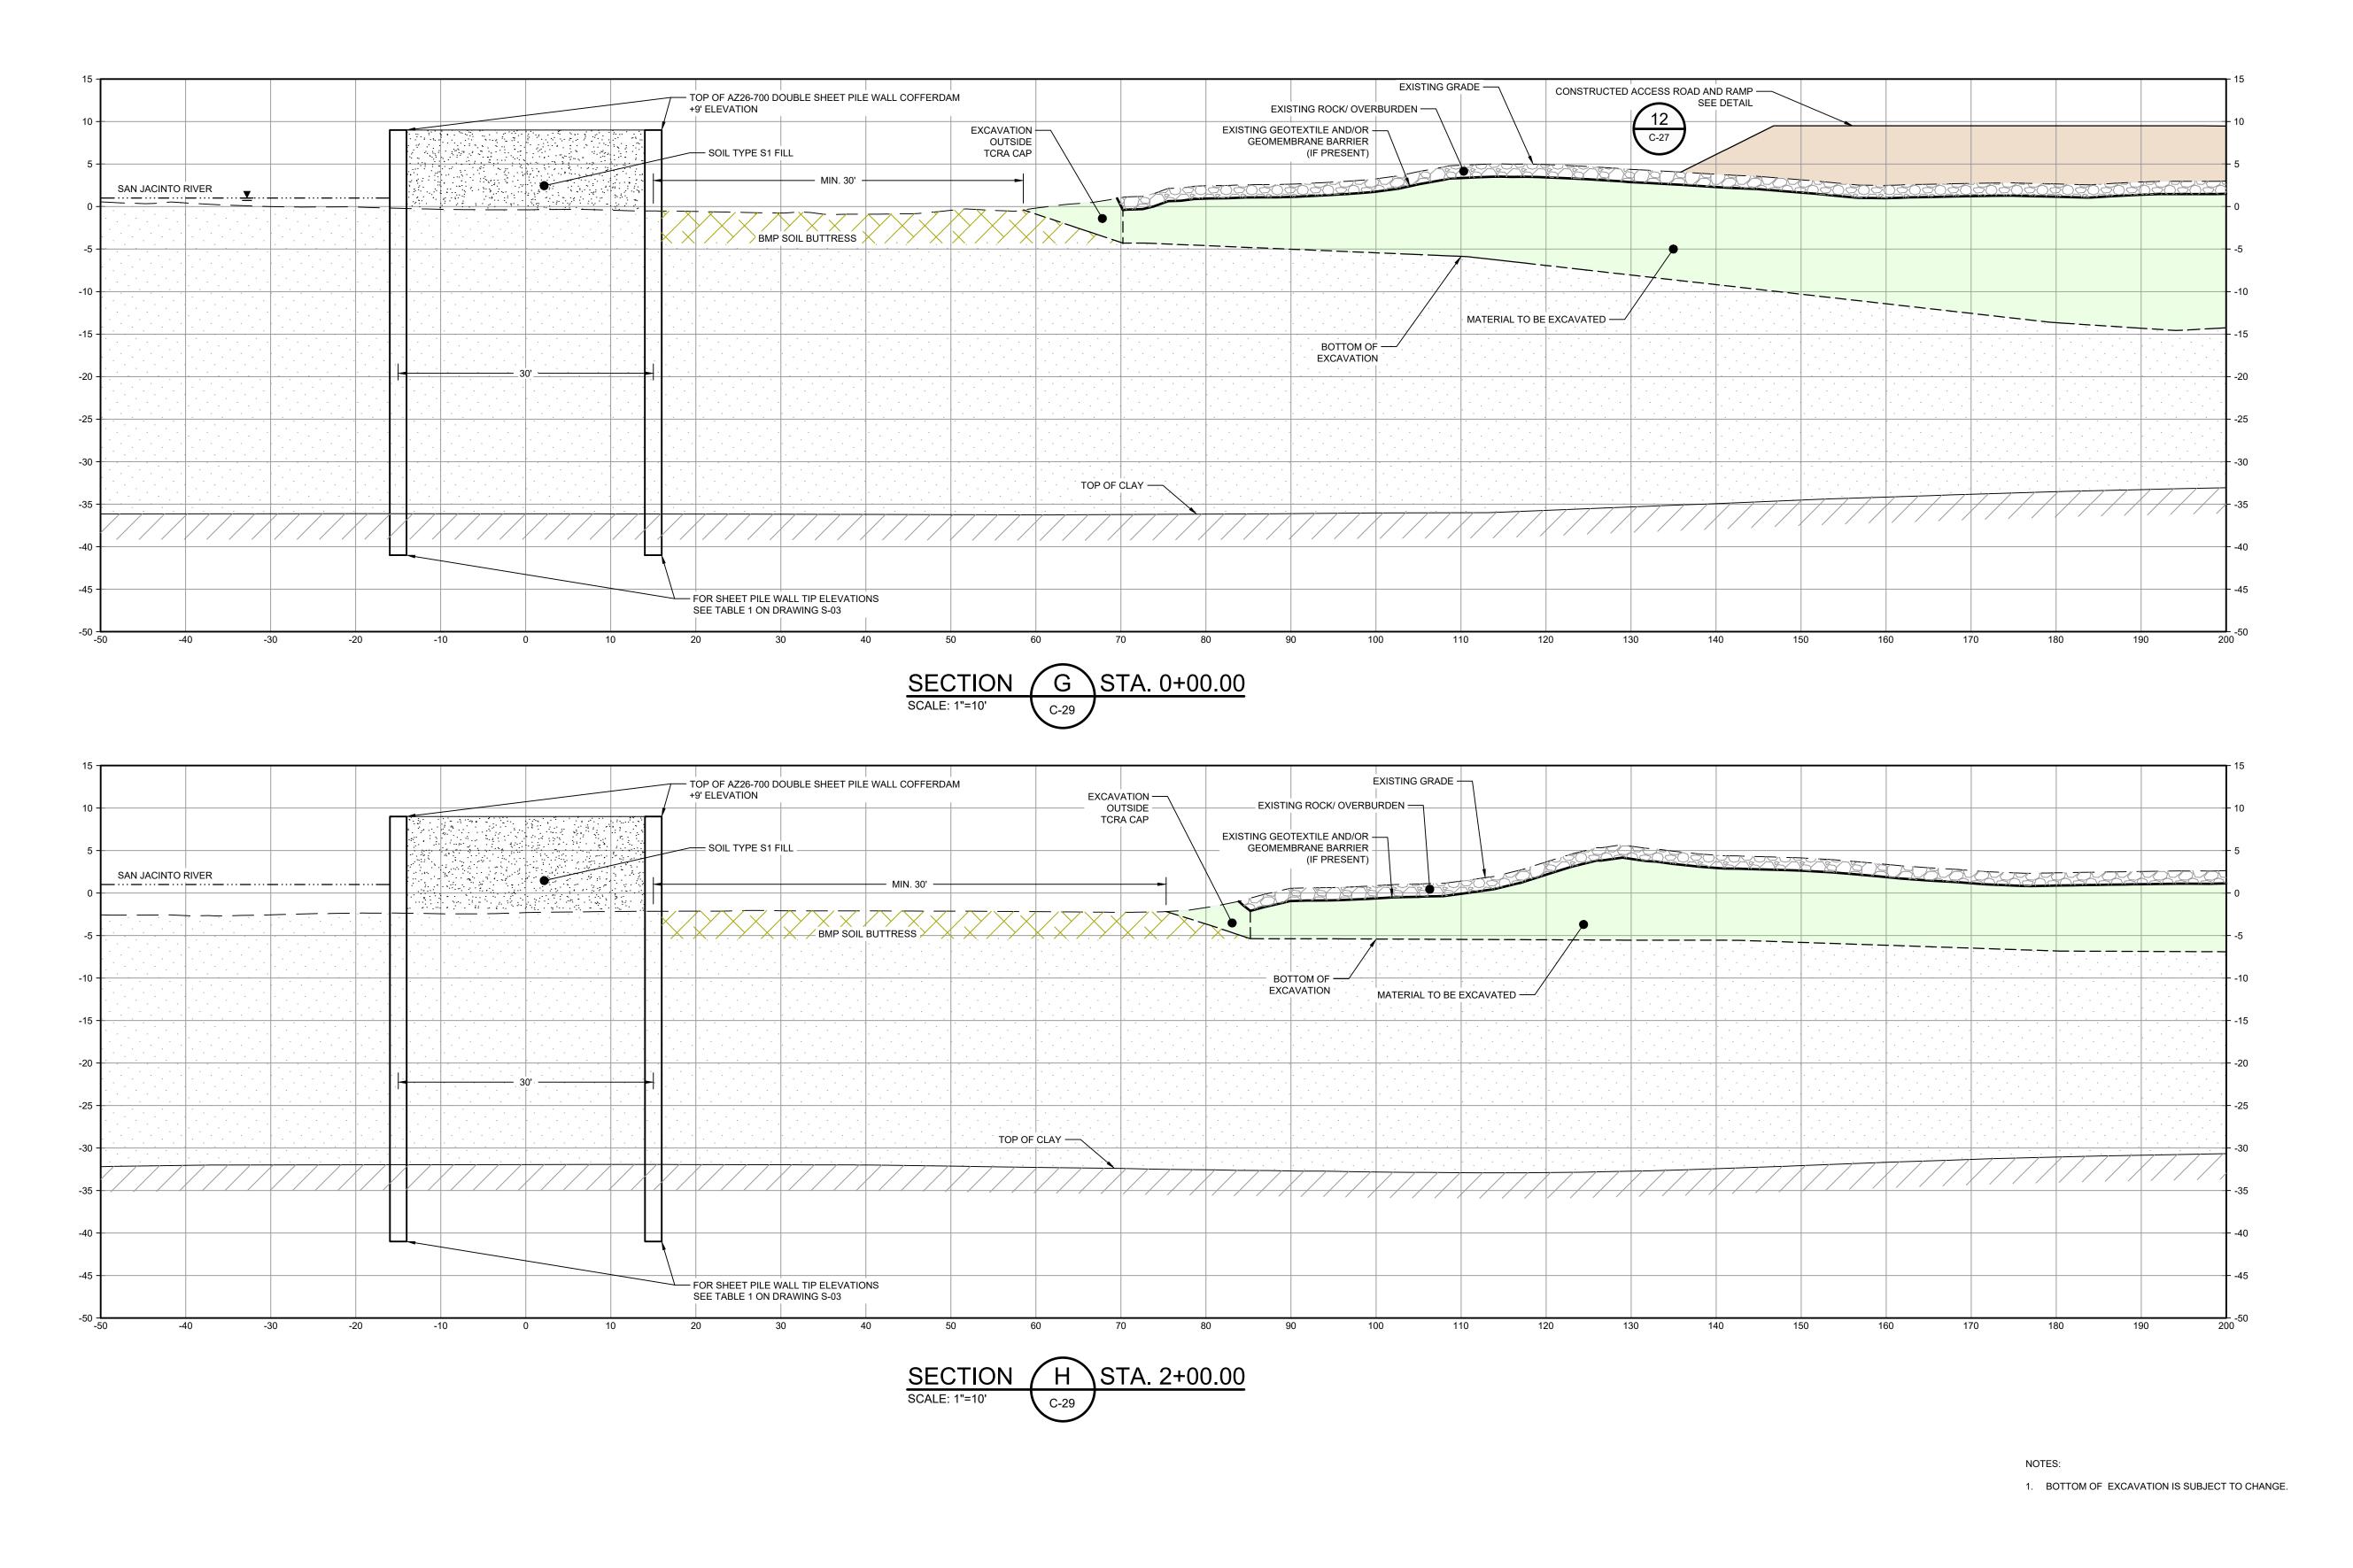MATERIAL T

BMP SOIL BI

MATERIAL TO BE EXCAVATED

BMP SOIL BUTTRESS

PLANNED IMPROVEMENTS FOR
NORTHERN IMPOUNDMENT ACCESS

SAN JACINTO RIVER WASTE PITS

NORTHERN IMPOUNDMENT
PRE-FINAL 90% REMEDIAL DESIGN
HARRIS COUNTY, TEXAS

2 90% EPA REVIEW MW CM 06/27/2022

No. Issue Drawn Approved Date

Drawn MW Designer RH

Drafting Check Design Check LL

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Original Size

Bar is one in original size.

Arch D

Bar is one inch on original size drawing

0

11

Date Jun 27, 2022

Project No. **11215702**

Project CM Coordinator

Title

DOUBLE PILE WALL SECTIONS
1 OF 7


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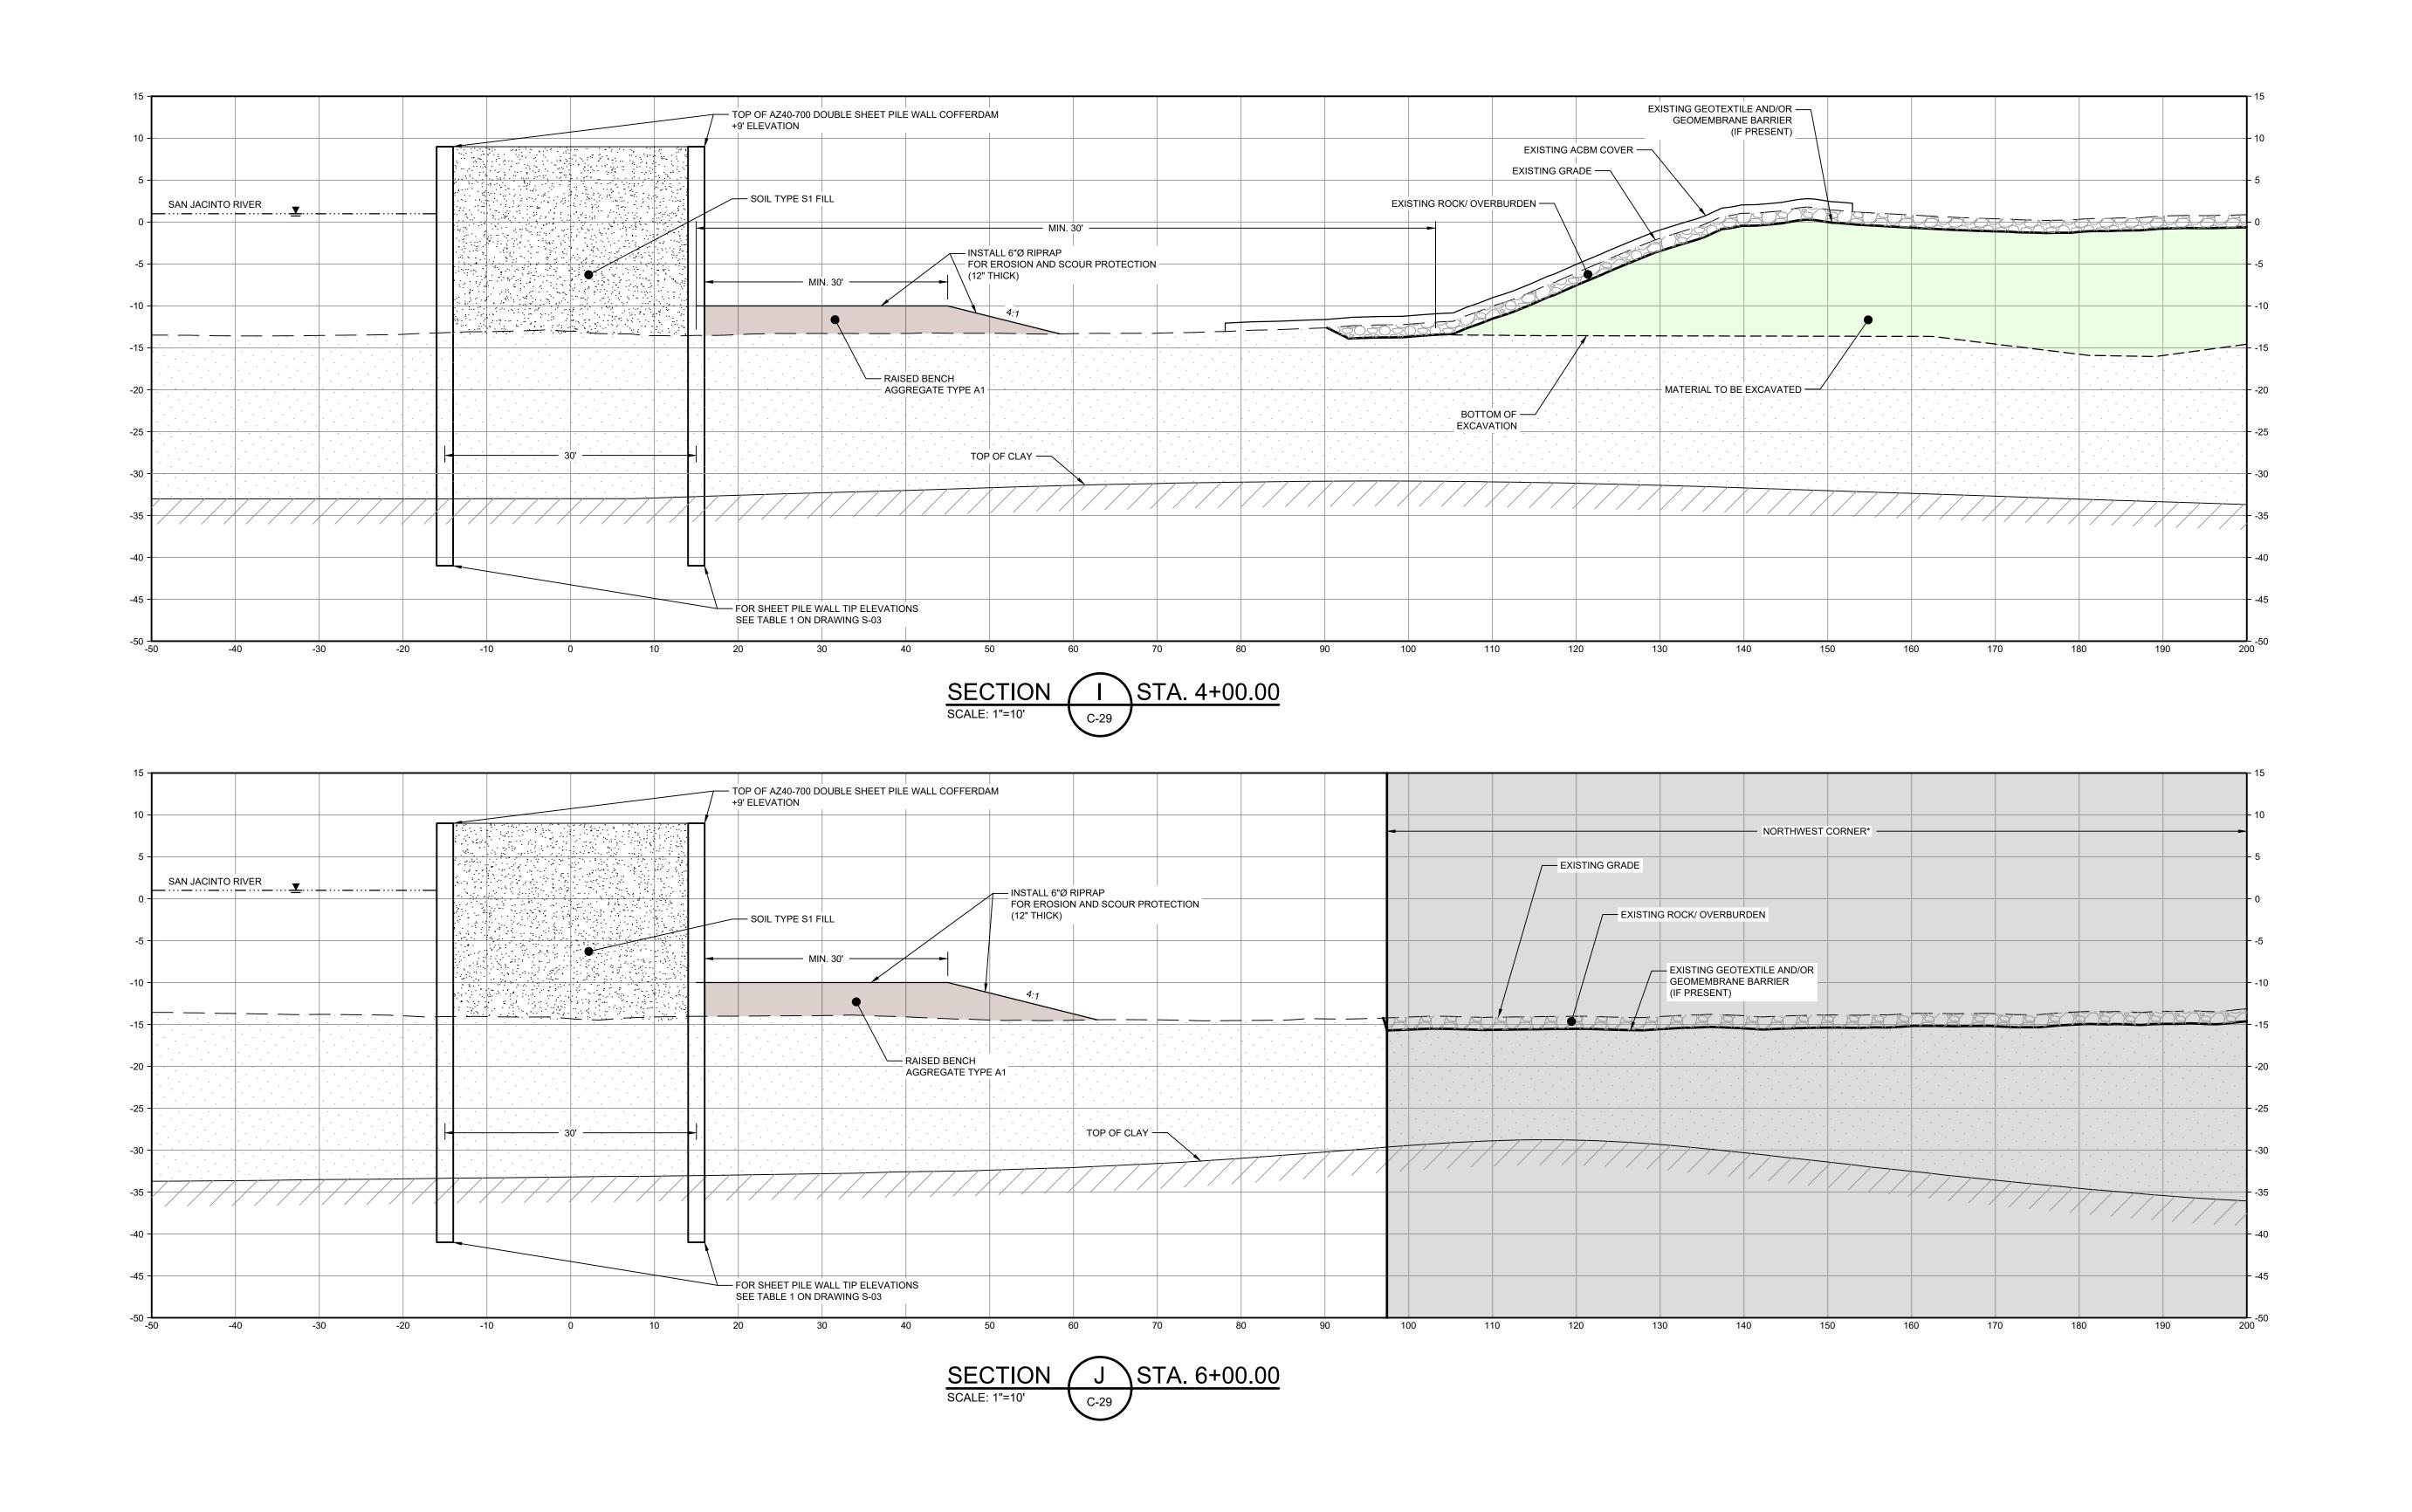
C-35

Sheet - of -

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NOTES:

1. BOTTOM OF EXCAVATION IS SUBJECT TO CHANGE.


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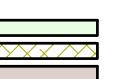

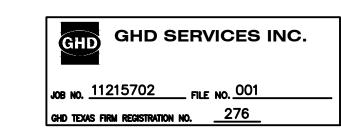
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MATERIAL T

MATERIAL TO BE EXCAVATED
BMP SOIL BUTTRESS
RAISED BENCH

SAN JACINTO RIVER
WASTE PITS

NORTHERN IMPOUNDMENT
PRE-FINAL 90% REMEDIAL DESIGN
HARRIS COUNTY, TEXAS

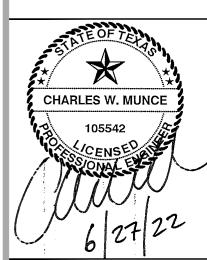2 90% EPA REVIEW MW CM 06/27/2022

No. Issue Drawn Approved Date

Drawn MW Designer RH

Drafting Check

Check

Design Check

Check

Date

Date

Jun 27, 2022

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Original Size

Arch D

Arch D

original size drawing

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1"

Bar is one inch on

Project No. **11215702**


Title

DOUBLE PILE WALL SECTIONS 2 OF 7

Sheet No.

C-36

C-36Sheet - of -

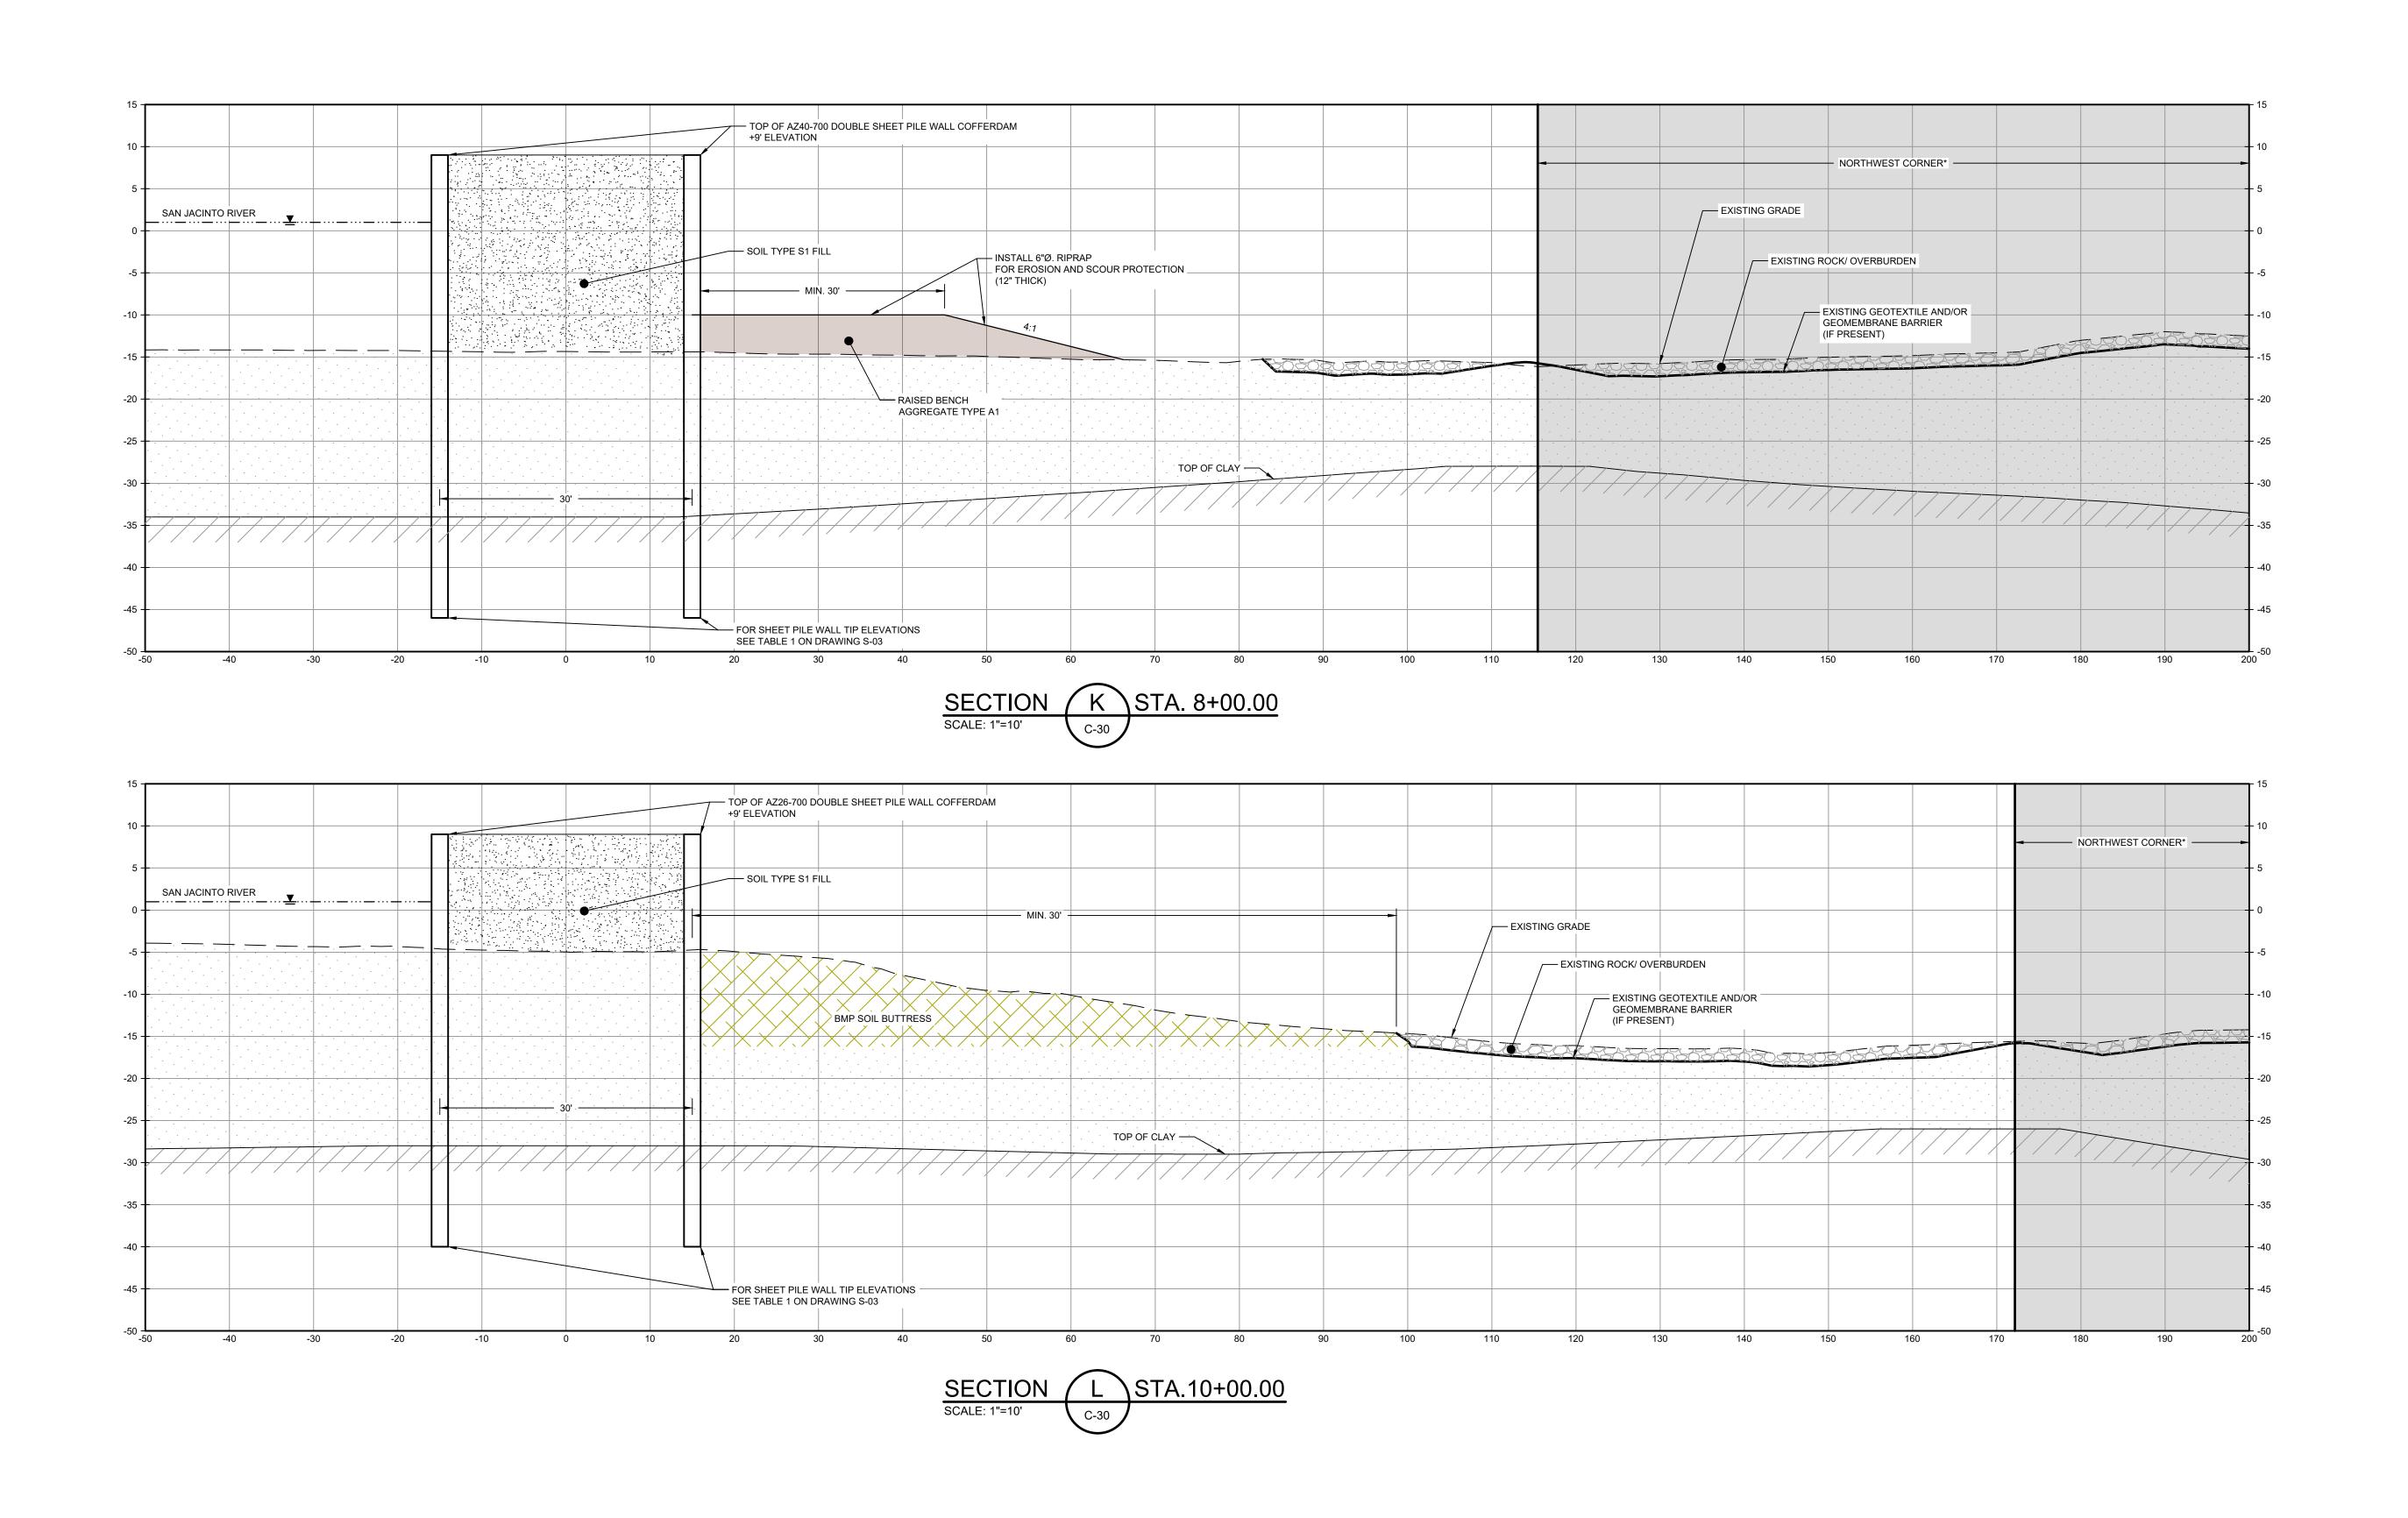

*THE REMEDIAL DESIGN INFORMATION FOR THE NORTHWEST PORTION OF THE NORTHERN IMPOUNDMENT IS INCLUDED IN THIS SUBMITTAL. THE DESIGN TO DATE CONCLUDES THAT COMPLETING THE REMEDIAL ACTION "IN THE DRY" IN THE NORTHWEST PORTION OF THE NORTHERN IMPOUNDMENT AS STATED IN THE EPA RECORD OF DECISION IS NOT TECHNICALLY FEASIBLE DUE TO HYDRAULIC HEAVE. THE SUPPORTING TECHNICAL AND ENGINEERING BASIS FOR THIS CONCLUSION ARE INCLUDED IN THIS SUBMITTAL, AND AS SUCH, PENDING A FINAL EPA DETERMINATION REGARDING THIS AREA, IT IS ANTICIPATED THAT AN ADDENDUM TO THE PRE-FINAL 90% REMEDIAL DESIGN WILL BE SUBMITTED AT A FUTURE DATE TO ADDRESS THE NORTHWEST PORTION OF THE NORTHERN IMPOUNDMENT IN ACCORDANCE WITH EPA'S FINAL DETERMINATION AFTER REVIEW OF THIS NEWLY DEVELOPED SITE INFORMATION.

NOTES:

BOTTOM OF EXCAVATION IS SUBJECT TO CHANGE.


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<u>LEGEND</u>

MATERIAL TO BE EXCAVATED
BMP SOIL BUTTRESS
RAISED BENCH

SAN JACINTO RIVER
WASTE PITS

NORTHERN IMPOUNDMENT
PRE-FINAL 90% REMEDIAL DESIGN
HARRIS COUNTY, TEXAS

2	90% EPA REVIEW	MW	СМ	06/27/202
No.	Issue	Drawn	Approved	Date
Draw	n MW	Designer	RH	

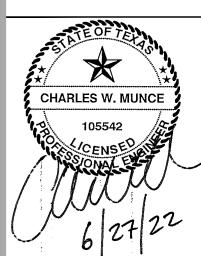Drawn MW

Designer RH

Drafting Check
Check

Project CM Coordinator

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Designer RH

Designer RH

Designer RH

Date Jun 27, 2022

Original Size

Arch D

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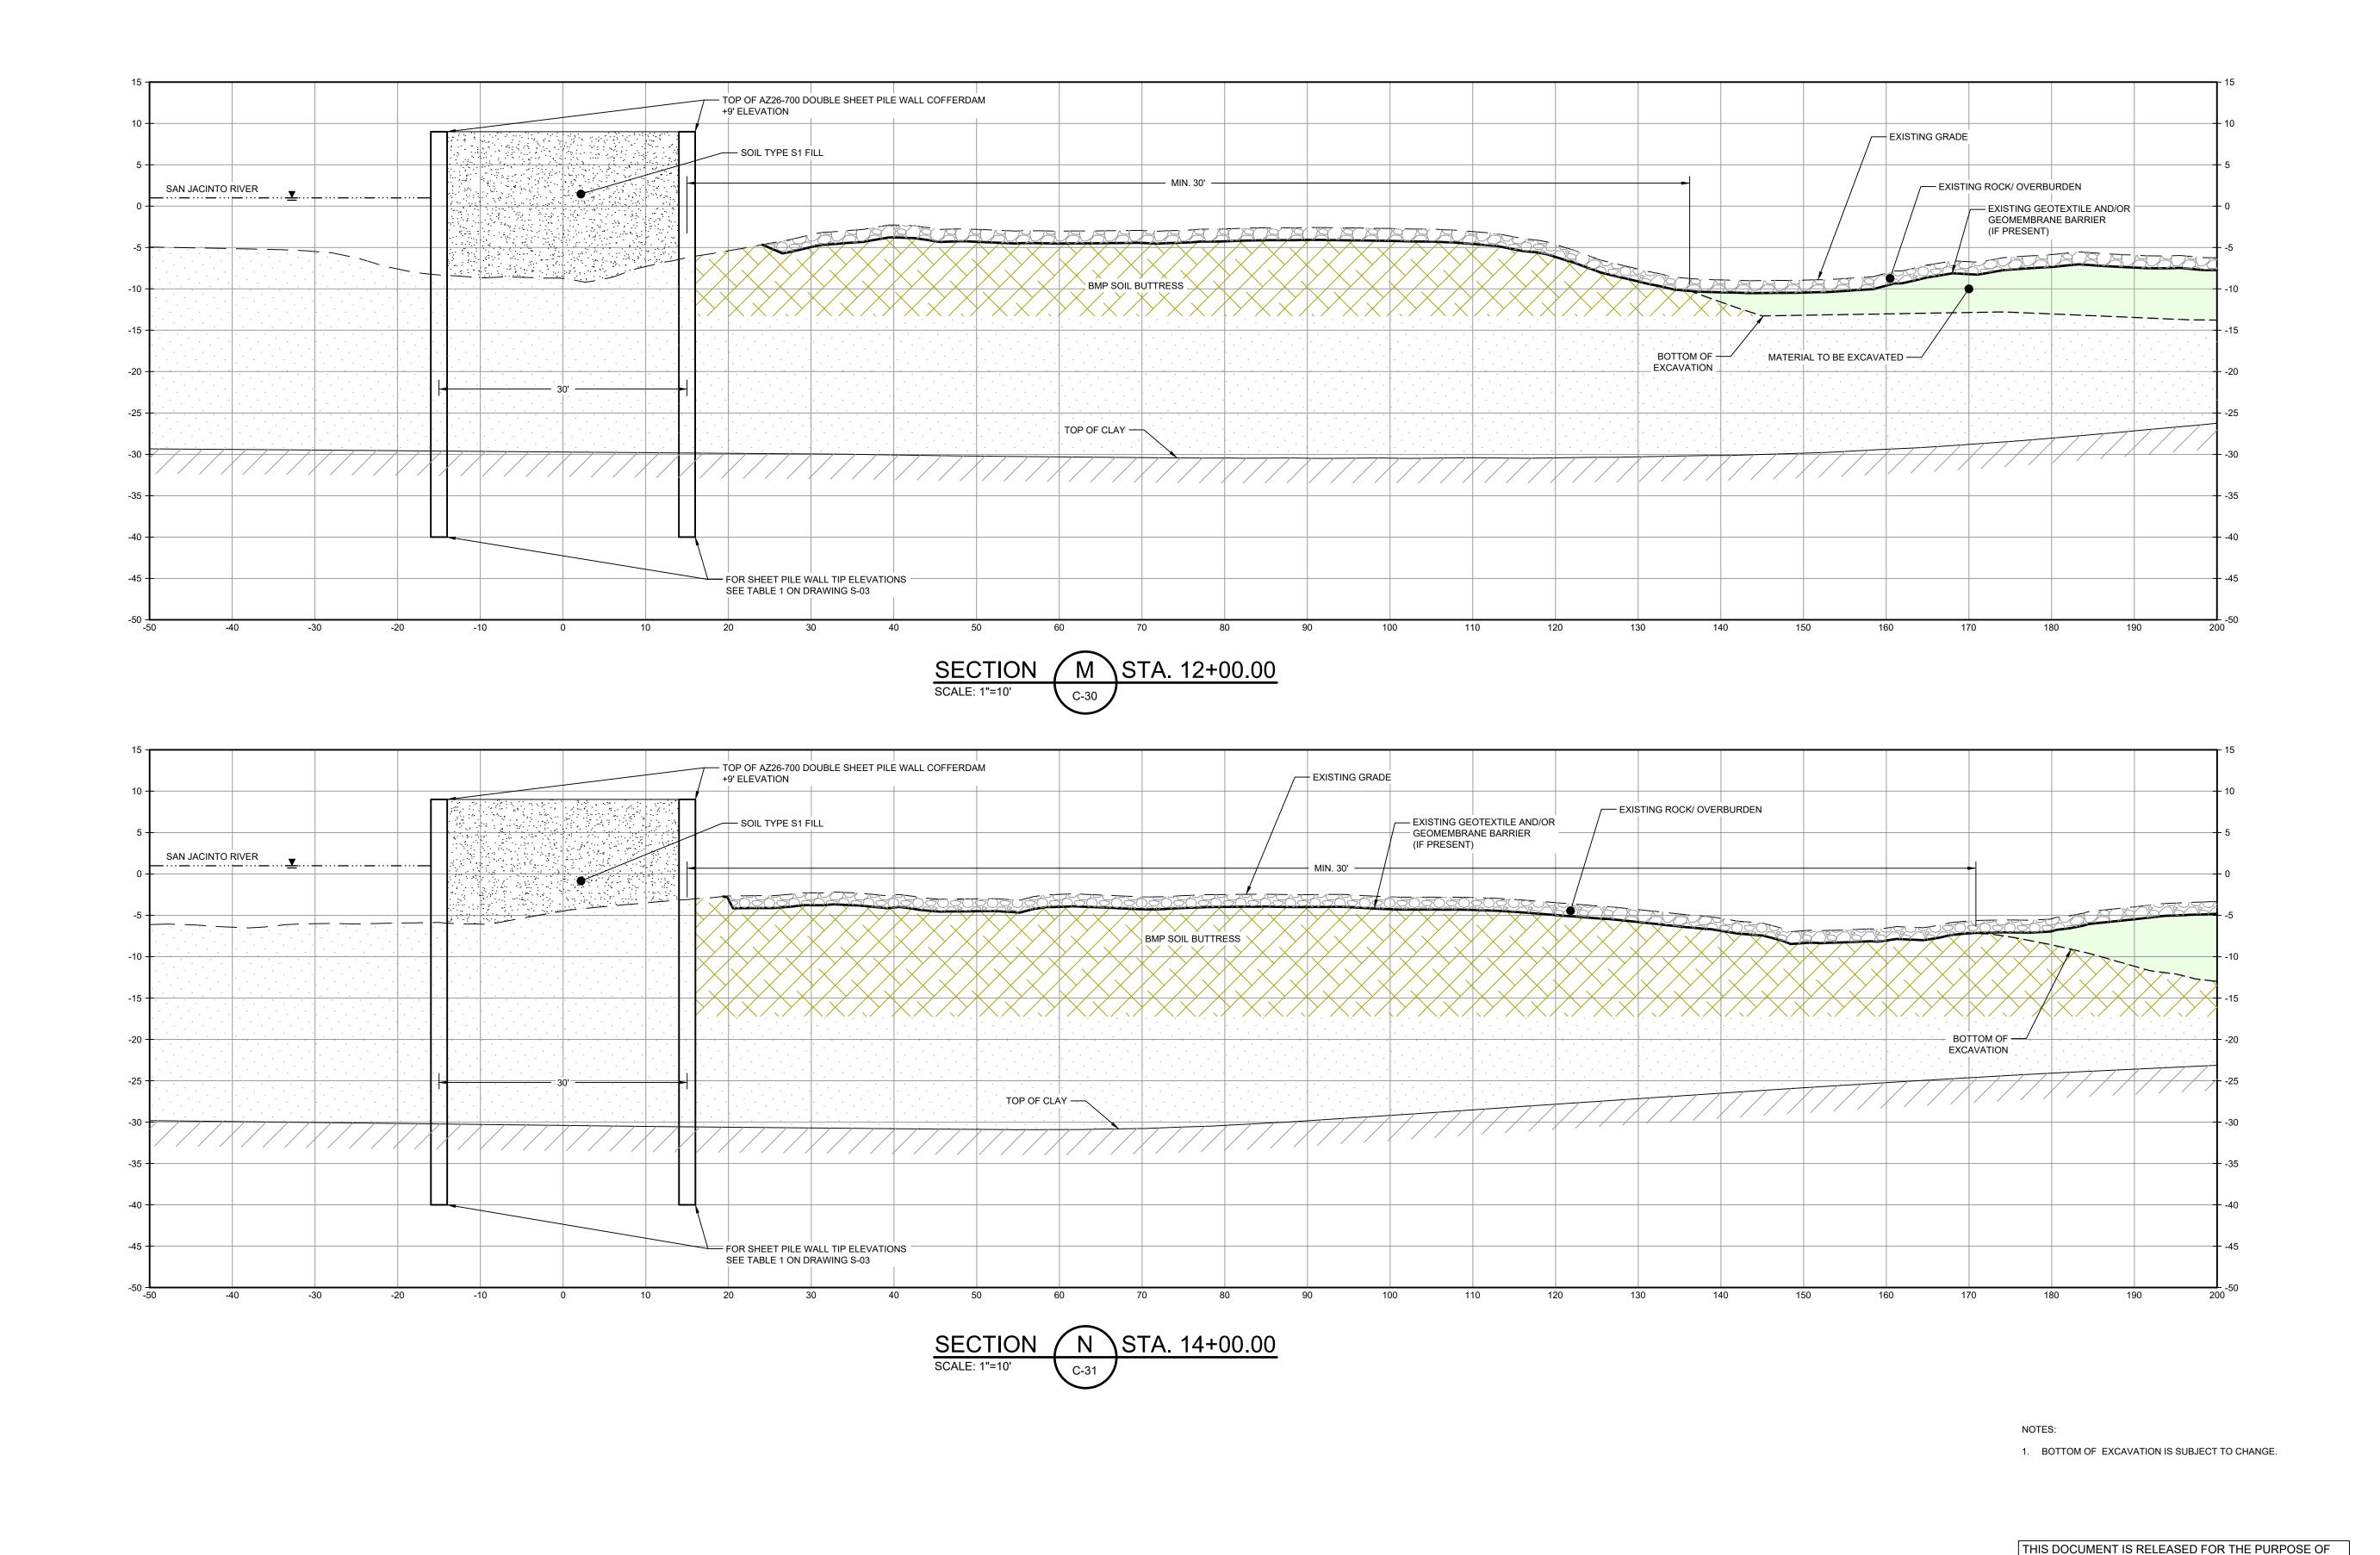
Project No. **11215702**


Title

DOUBLE PILE WALL SECTIONS
3 OF 7

Sheet No.

C-37



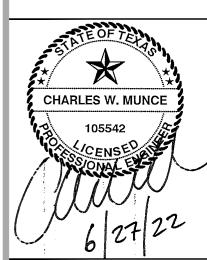

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MATERIAL TO BE EXCAVATED BMP SOIL BUTTRESS

SAN JACINTO RIVER WASTE PITS

NORTHERN IMPOUNDMENT PRE-FINAL 90% REMEDIAL DESIGN HARRIS COUNTY, TEXAS

MW 2 90% EPA REVIEW CM 06/27/2022 Drawn Issue Designer RH Drawn **MW**

Drafting JC Check Project CM Coordinator Date Jun 27, 2022

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Original Size

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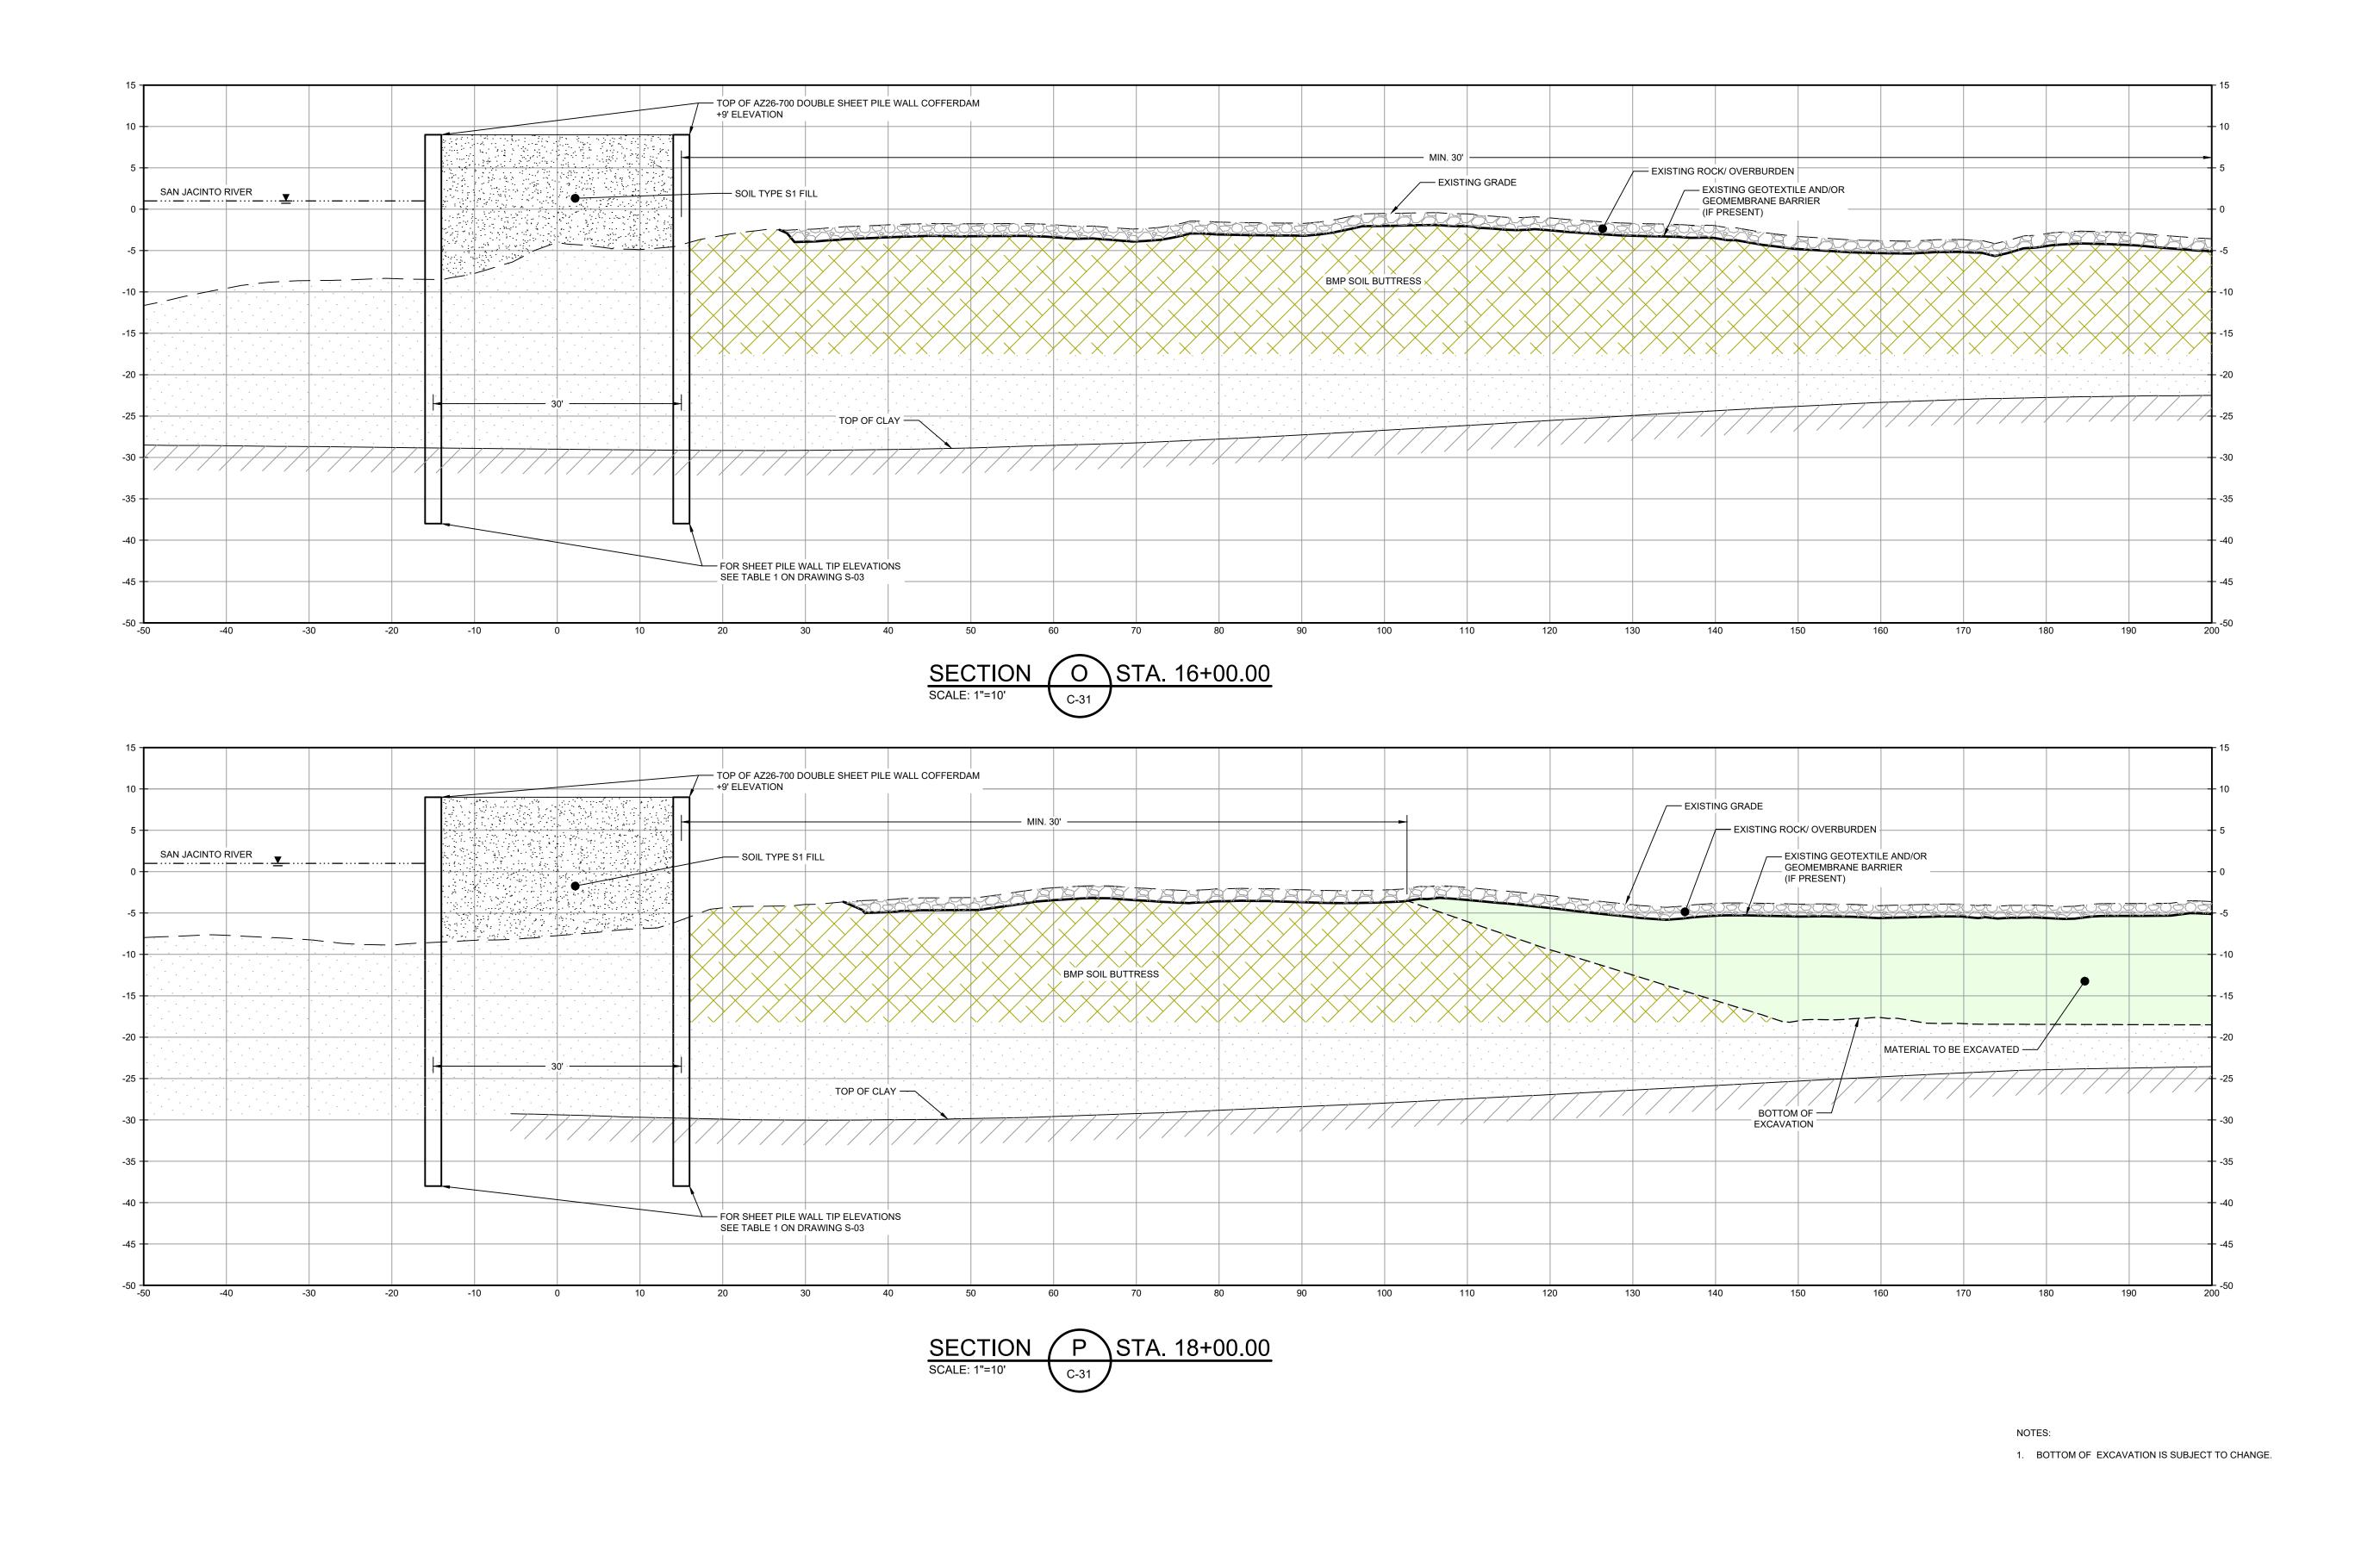
DOUBLE PILE WALL SECTIONS 4 OF 7


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Sheet - of -

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MATERIAL TO BE EXCAVATED BMP SOIL BUTTRESS

Client

SAN JACINTO RIVER WASTE PITS

NORTHERN IMPOUNDMENT PRE-FINAL 90% REMEDIAL DESIGN HARRIS COUNTY, TEXAS

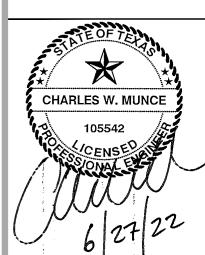MW 2 90% EPA REVIEW CM 06/27/2022 Drawn Issue Drawn **MW** Designer RH

Drafting JC Check Project CM Coordinator Date Jun 27, 2022 This document shall not be used for construction unless signed and sealed for Scale 1" = 10'

Original Size

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Project No. **11215702**

DOUBLE PILE WALL SECTIONS 5 OF 7

Sheet No.

C-39

Sheet - of -

90% EPA REVIEW

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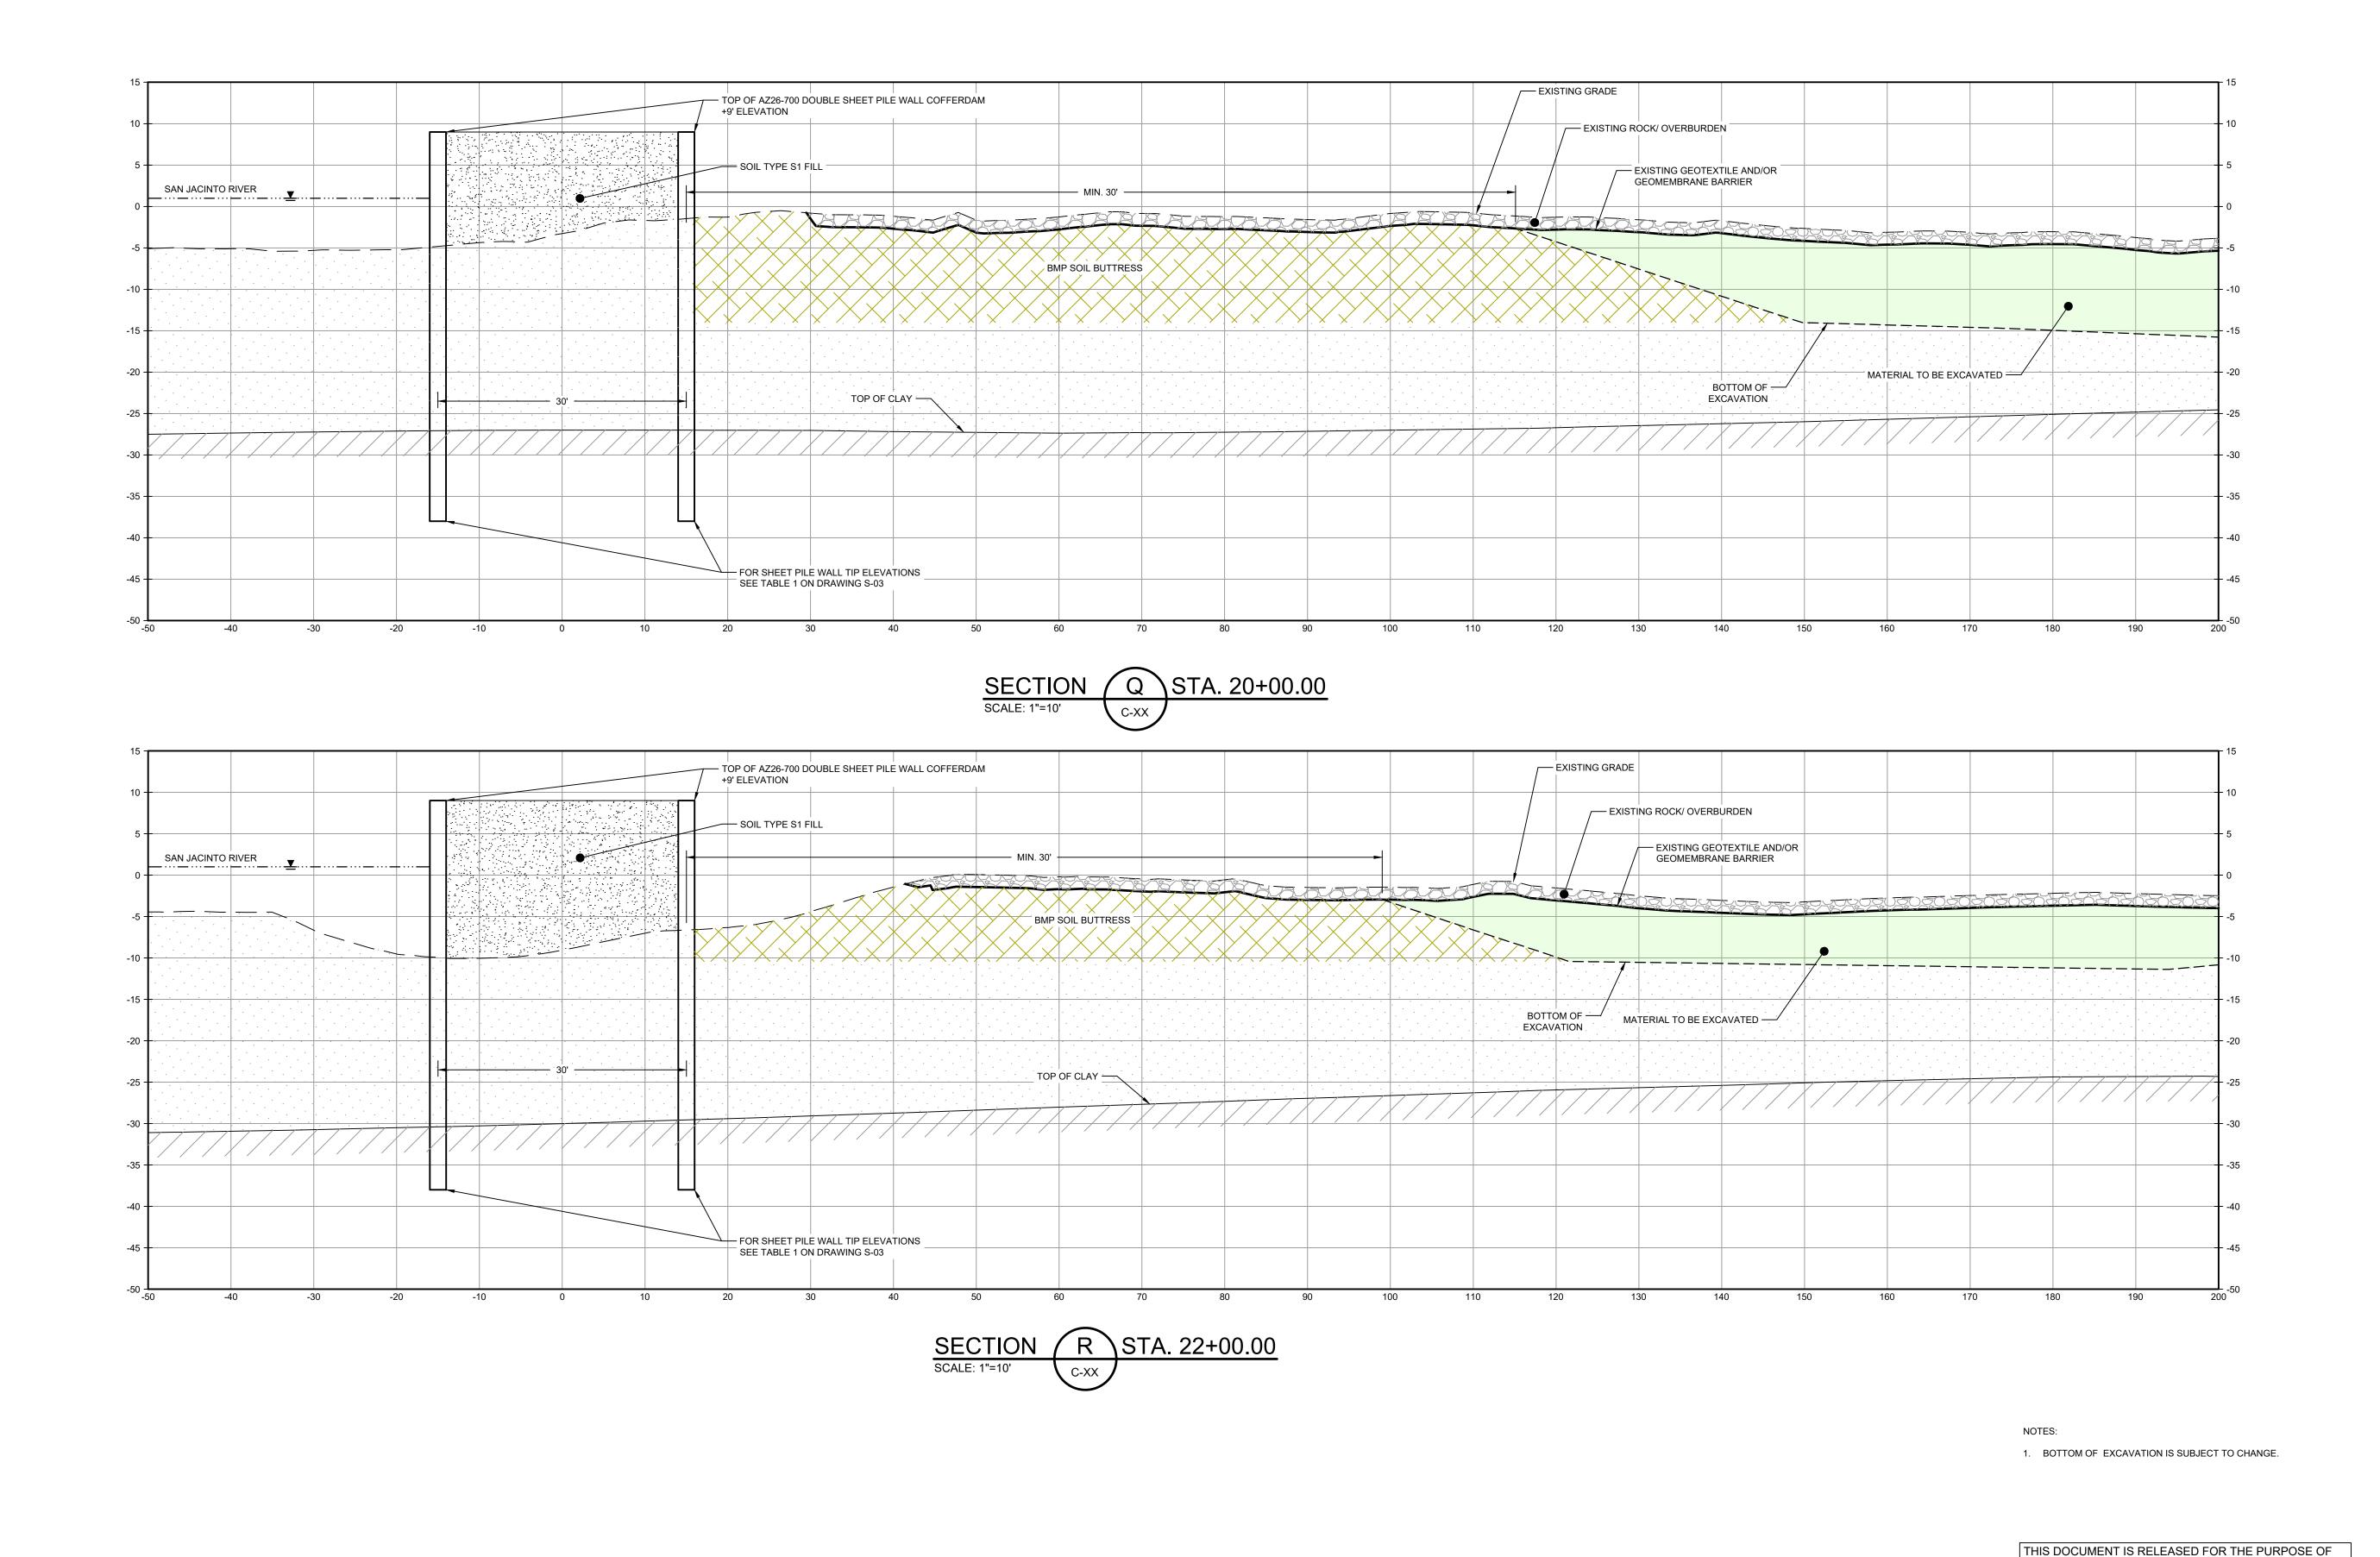
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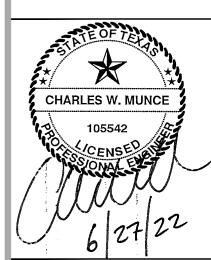
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JOB NO. 11215702 FILE NO. 001

GHD SERVICES INC.

CONVEYANCE OR SALES PURPOSES.






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LEGEND

MATERIAL TO BE EXCAVATED BMP SOIL BUTTRESS

SAN JACINTO RIVER WASTE PITS

NORTHERN IMPOUNDMENT PRE-FINAL 90% REMEDIAL DESIGN HARRIS COUNTY, TEXAS

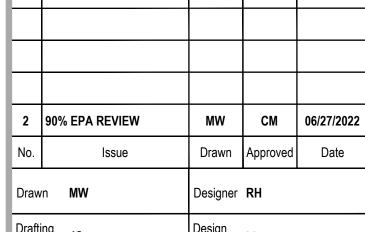

Drafting JC Check Project CM Coordinator Date Jun 27, 2022 This document shall not be used for construction unless signed and sealed for Scale 1" = 10'

Original Size

Bar is one inch on original size drawing Arch D

Project No. **11215702**

DOUBLE PILE WALL SECTIONS 6 OF 7

Sheet No.

C-40

Sheet - of -

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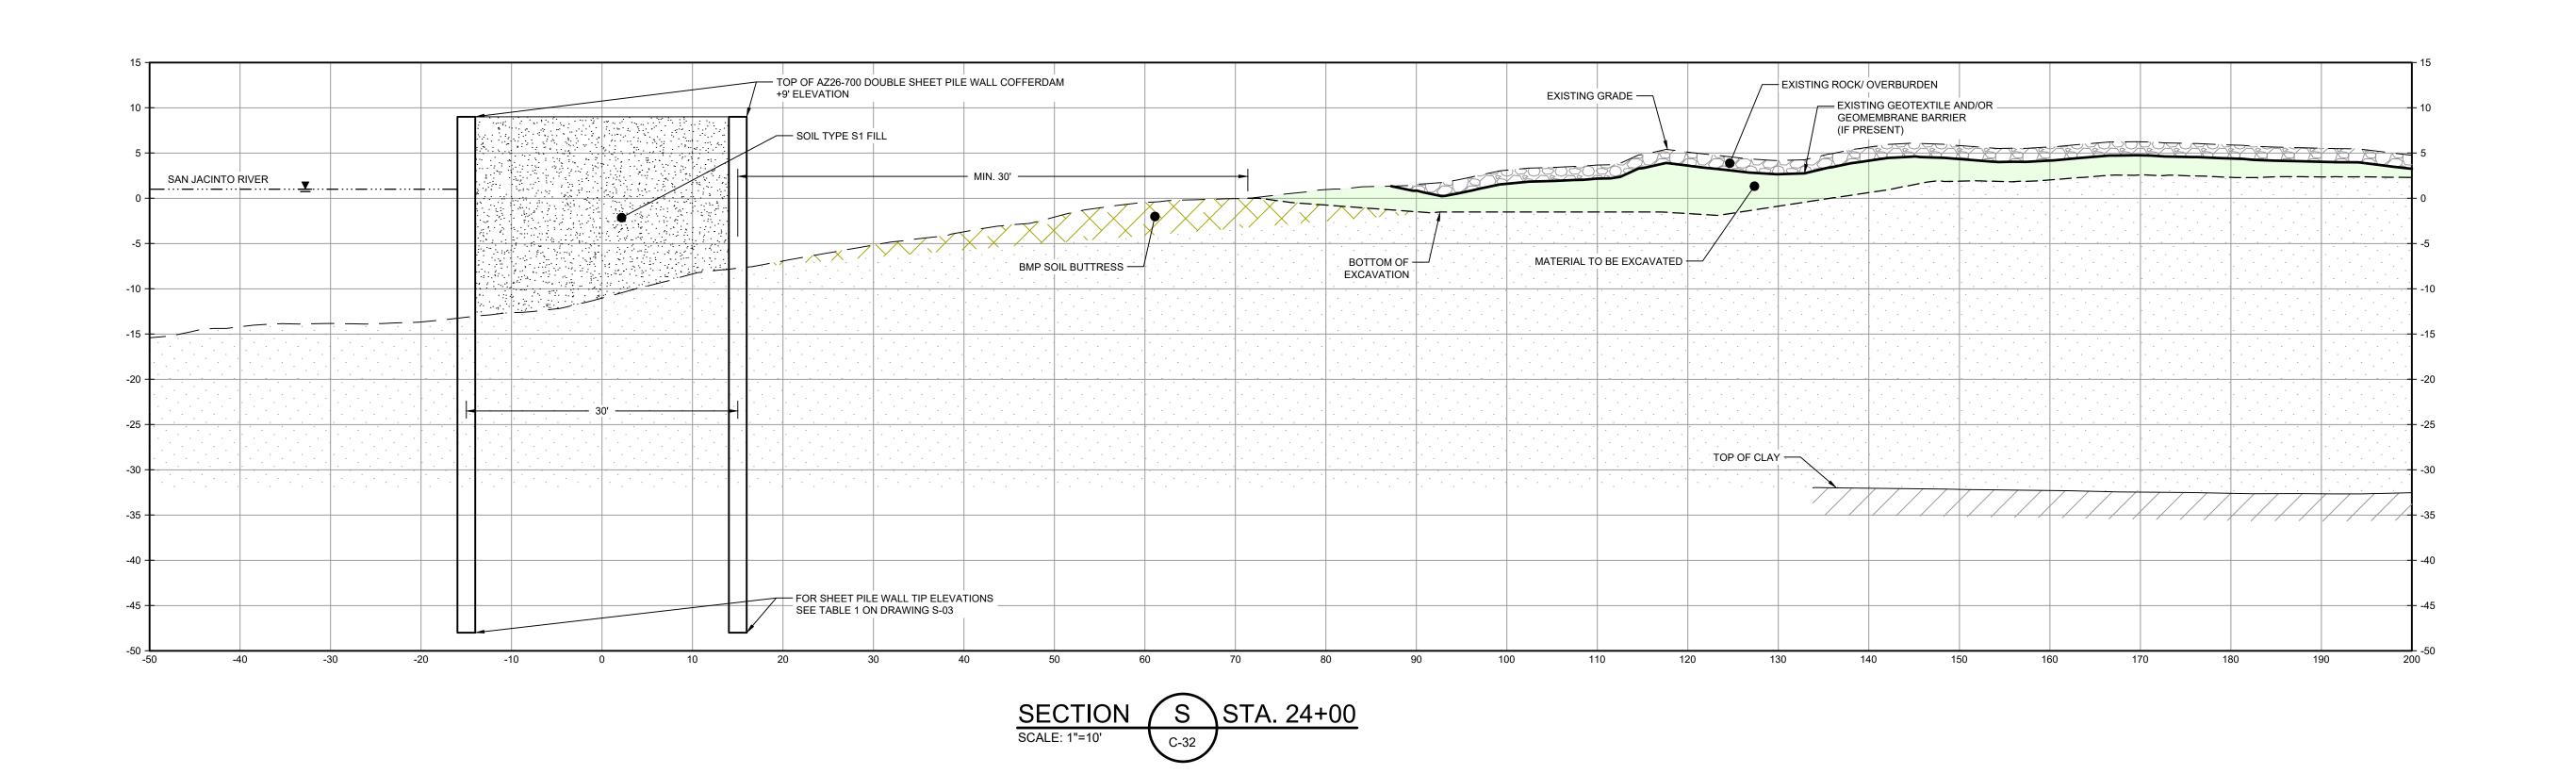
JOB NO. 11215702 FILE NO. 001

GHD SERVICES INC.

CONVEYANCE OR SALES PURPOSES.

Plotted By: Matt Wolfer

Filename: N:\US\Baton Rouge\Projects\562\11215702\Digital_Design\ACAD 2019\Sheets\11215702-02-DWG-C-024.dwg



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MATERIAL TO BE EXCAVATED

BMP SOIL BUTTRESS

SAN JACINTO RIVER WASTE PITS

NORTHERN IMPOUNDMENT
PRE-FINAL 90% REMEDIAL DESIGN
HARRIS COUNTY, TEXAS

2 90% EPA REVIEW MW CM 06/27/2022

No. Issue Drawn Approved Date

Drawn MW Designer RH

Drafting Check LL

Project CM Coordinator Date Jun 27, 2022

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Arch D

original size drawing

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Project No. **11215702**

Title

DOUBLE PILE WALL SECTIONS
7 OF 7

Sheet No.

C-41

Sheet - of -


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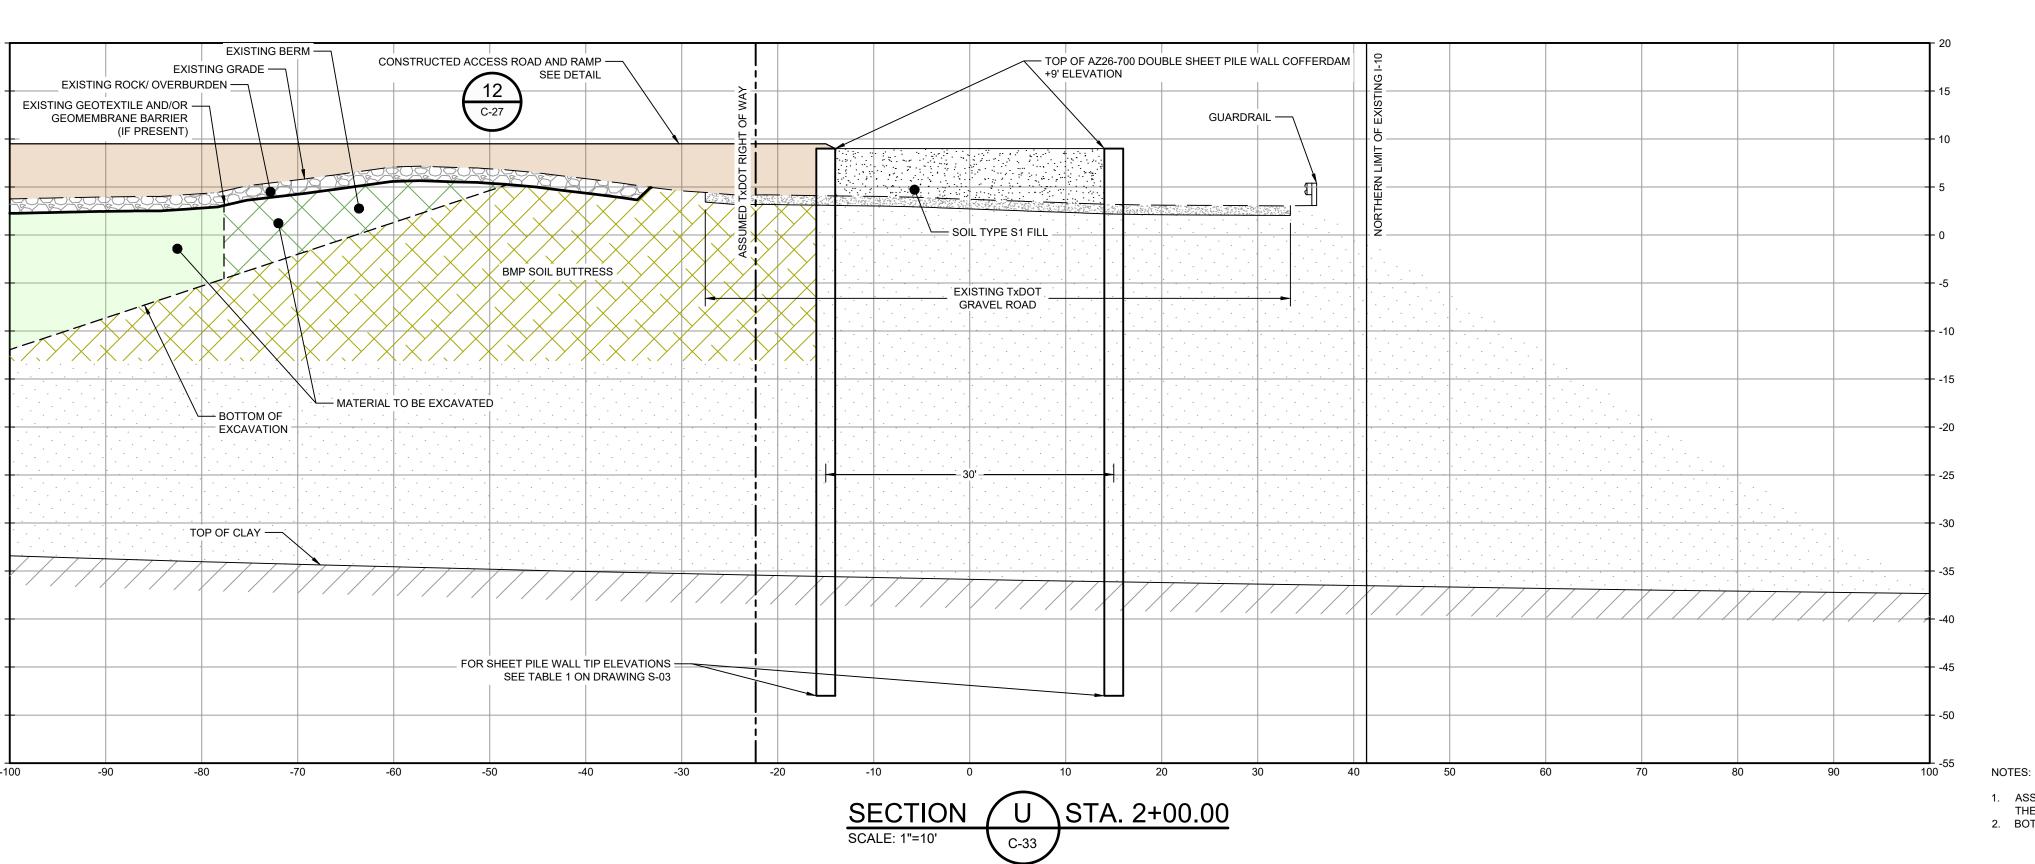
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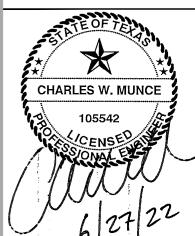
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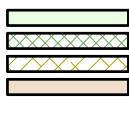




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> LEGEND MATERIAL TO BE EXCAVATED EXISTING BERM TO BE EXCAVATED BMP SOIL BUTTRESS



NORTHERN IMPOUNDMENT ACCESS

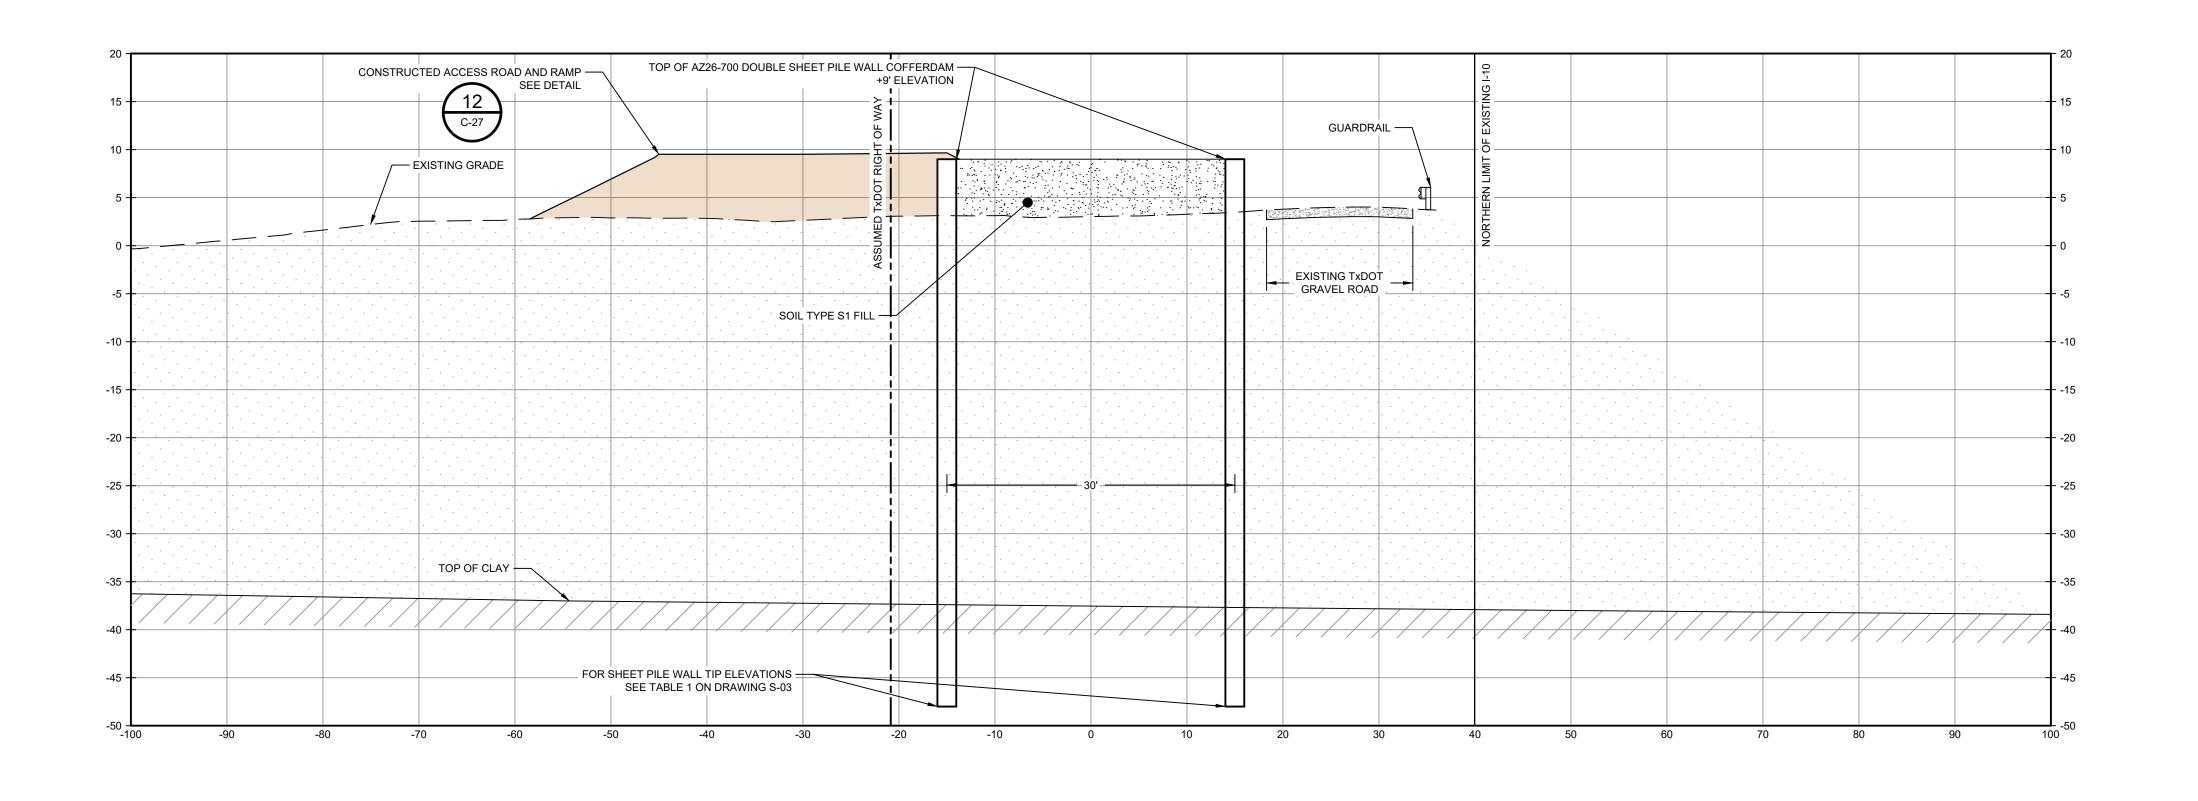PLANNED IMPROVEMENTS FOR

SAN JACINTO RIVER WASTE PITS

NORTHERN IMPOUNDMENT PRE-FINAL 90% REMEDIAL DESIGN HARRIS COUNTY, TEXAS

MW 2 90% EPA REVIEW CM 06/27/2022 Drawn Issue Drawn **MW** Designer RH Drafting JC Check Project CM Coordinator Date Jun 27, 2022 This document shall not be used for construction unless signed and sealed for Scale 1" = 10'

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Project No. **11215702**

SOUTH WALL SECTIONS 1 OF 3

Sheet No.

C-42

Sheet - of -

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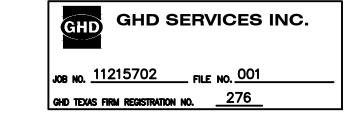
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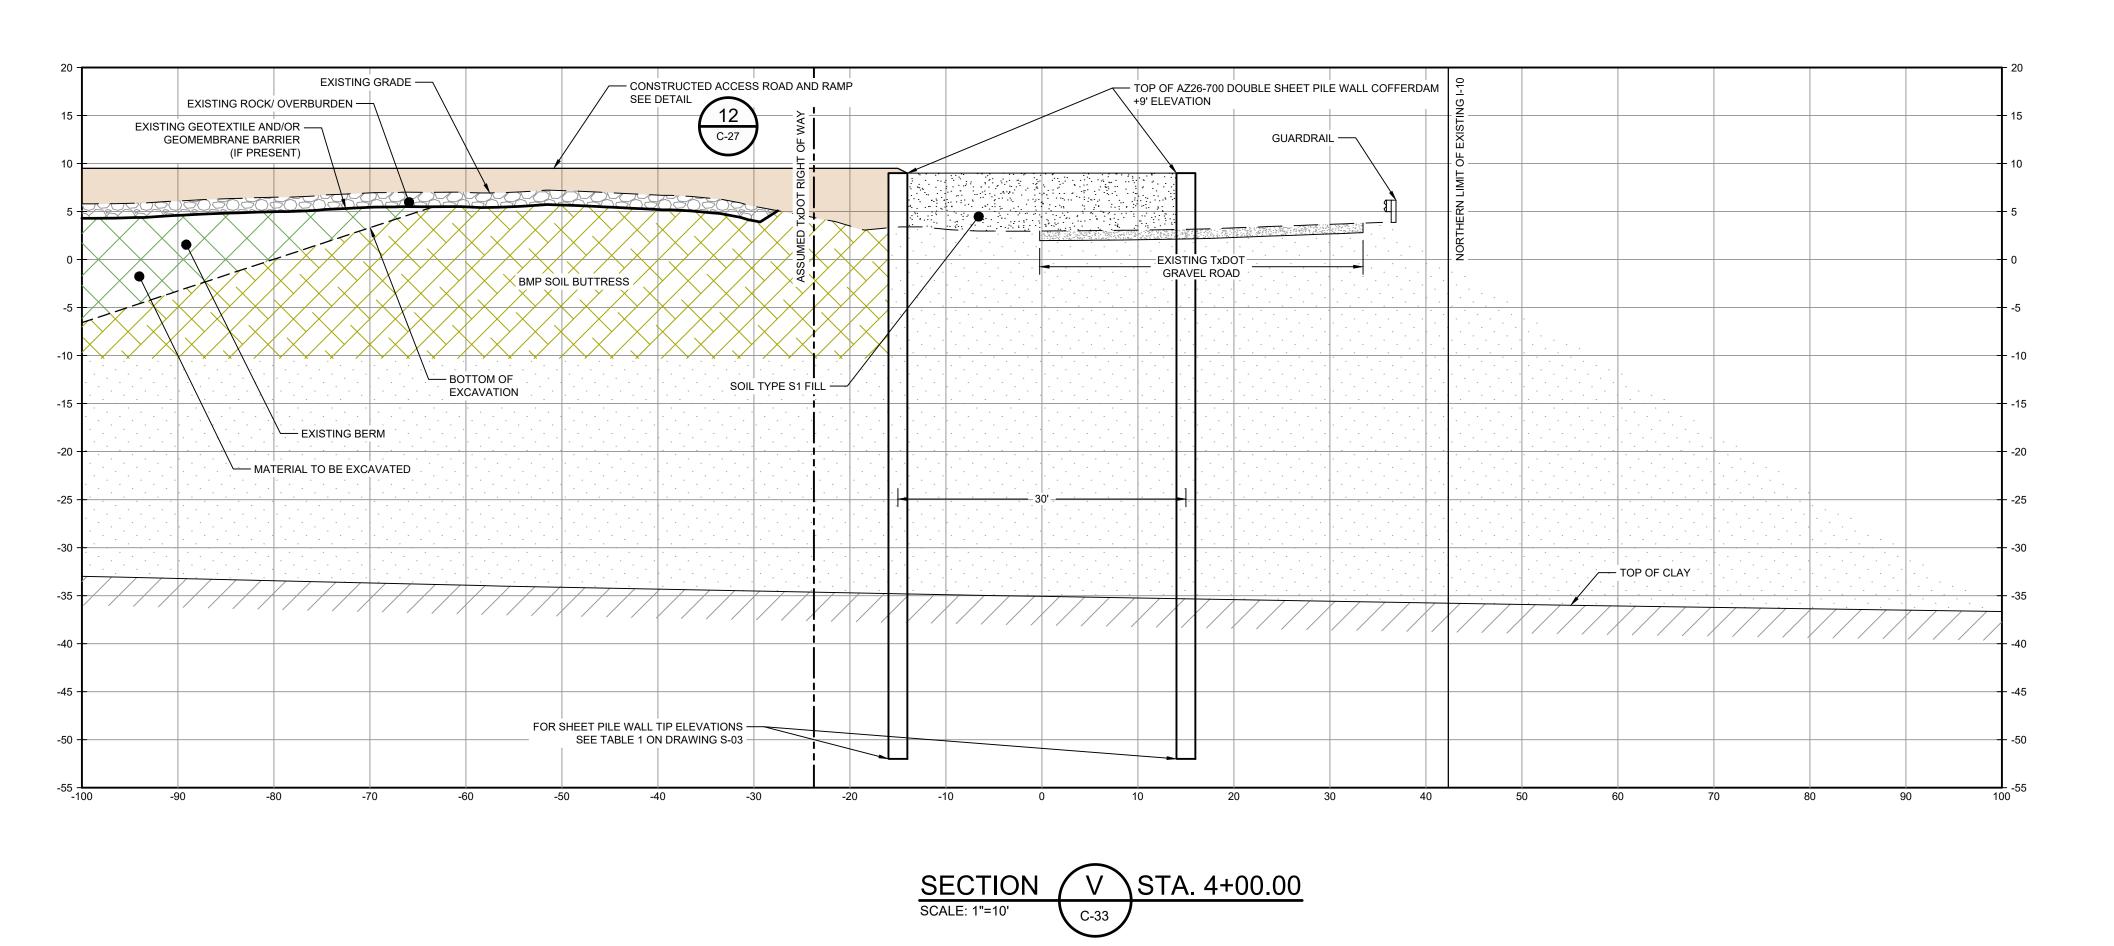
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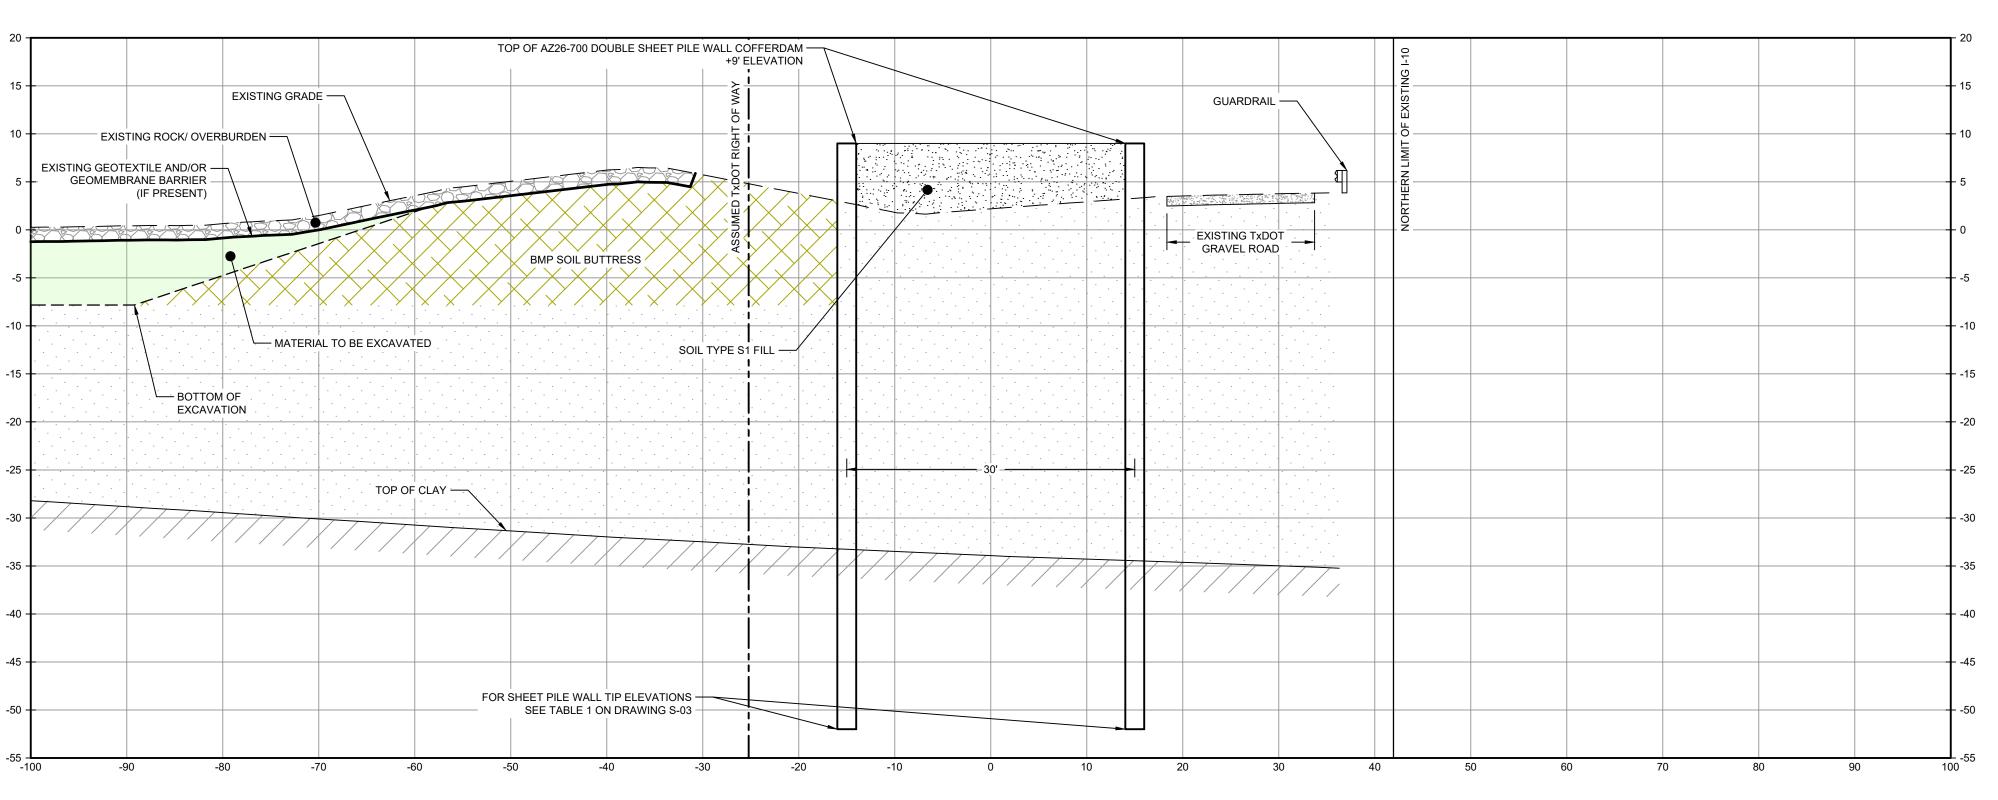
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Plot Date: 27 June 2022 - 2:51 PM





SECTION W STA. 6+00.00 C-34

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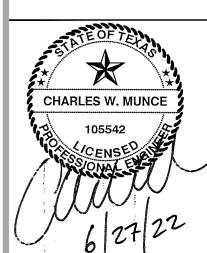
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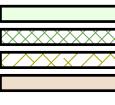
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EXISTING BERM TO BE EXCAVATED

BMP SOIL BUTTRESS

PLANNED IMPROVEMENTS FOR
NORTHERN IMPOUNDMENT ACCESS

Client SAN

SAN JACINTO RIVER WASTE PITS

NORTHERN IMPOUNDMENT
PRE-FINAL 90% REMEDIAL DESIGN
HARRIS COUNTY, TEXAS

2	90% EPA REVIEW	MW	СМ	06/27/202
No.	Issue	Drawn	Approved	Date
Draw	n MW	Designer	RH	
Drafti Chec	ing k	Design Check	LL	

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Scale 1" = 10'

Original Size

Arch D

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0 1"

Date **Jun 27, 2022**

Project No. **11215702**

Project CM Coordinator


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SOUTH WALL SECTIONS 2 OF 3

Sheet No.

C-43



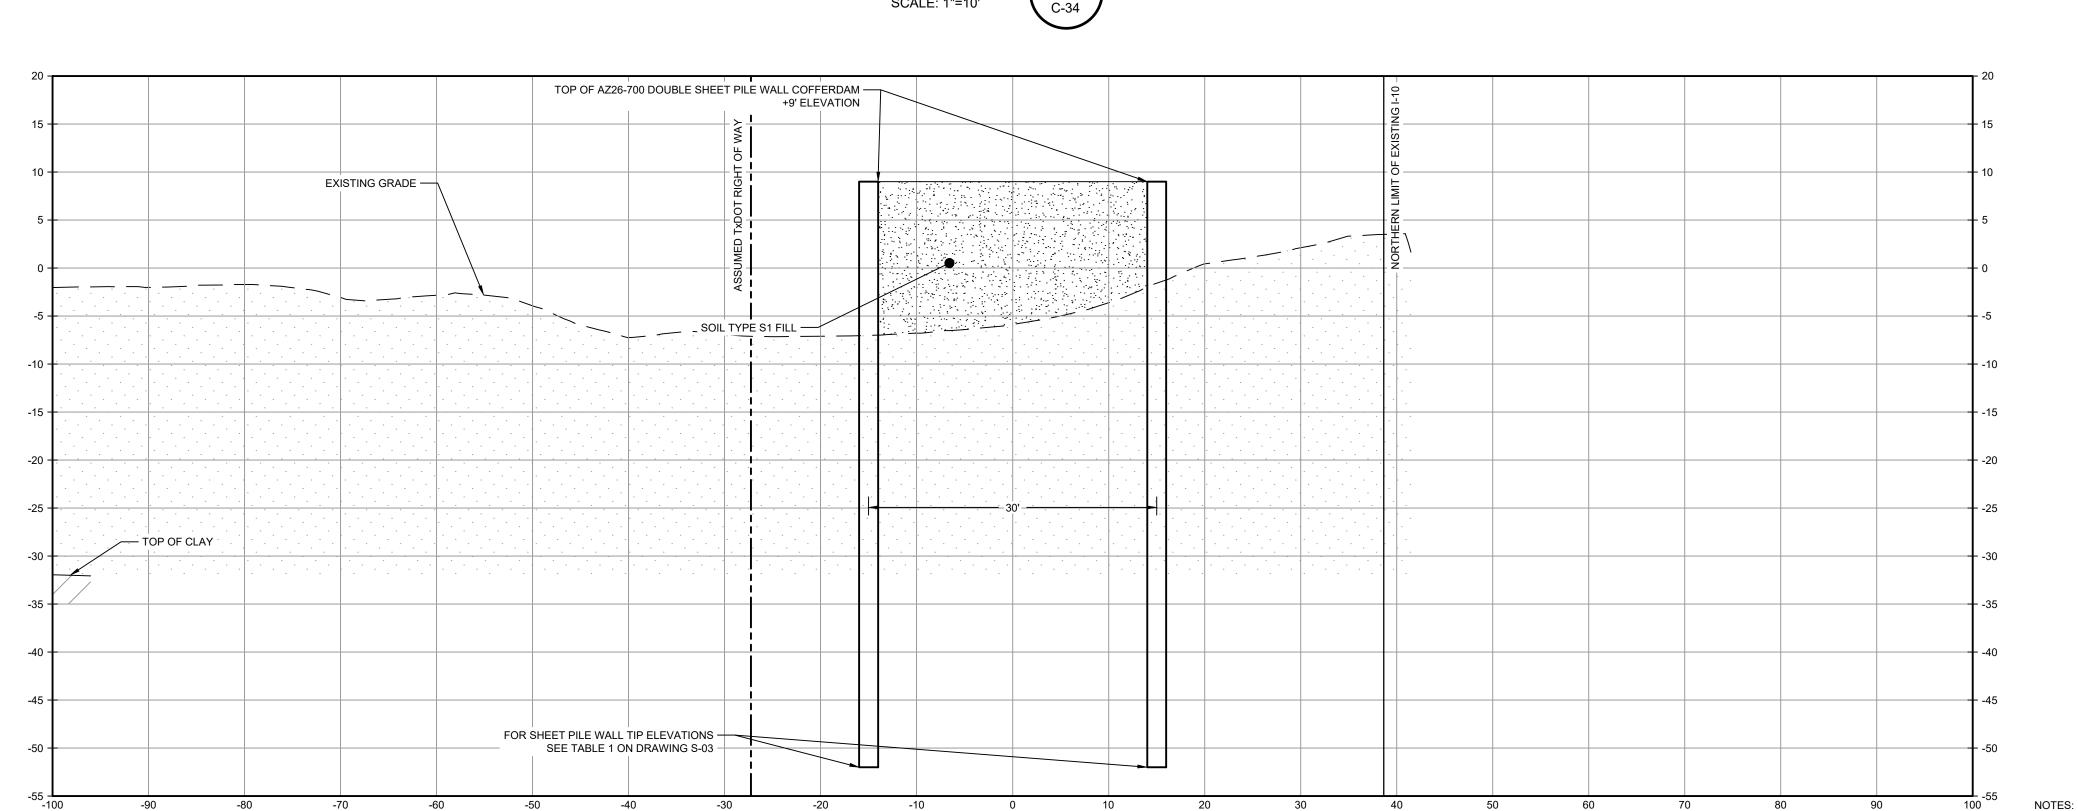

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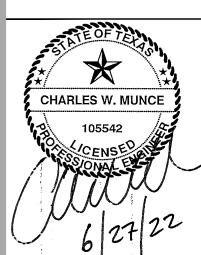
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LEGEND

MATERIAL TO BE EXCAVATED BMP SOIL BUTTRESS

Client **SAN JACINTO RIVER WASTE PITS**

NORTHERN IMPOUNDMENT PRE-FINAL 90% REMEDIAL DESIGN HARRIS COUNTY, TEXAS

MW CM 06/27/2022 2 90% EPA REVIEW Drawn Issue Designer RH Drawn **MW** Drafting JC Check Project CM Coordinator Date Jun 27, 2022

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Project No. **11215702**

SOUTH WALL SECTIONS 3 OF 3

Sheet No.

C-44

Sheet - of -

Plot Date: 27 June 2022 - 2:52 PM

Plotted By: Matt Wolfer

Filename: N:\US\Baton Rouge\Projects\562\11215702\Digital_Design\ACAD 2019\Sheets\11215702-02-DWG-C-024.dwg

GENERAL

- 1. VERIFY ALL DIMENSIONS AND EXISTING CONDITIONS BEFORE COMMENCING WORK. REPORT ANY DISCREPANCIES AND/OR INCONSISTENCIES TO THE OWNER FOR CLARIFICATION.
- 2. TEMPORARILY BRACE PILES AFTER DRIVING UNTIL TIE RODS ARE INSTALLED.

CODES AND GUIDELINES

- ASCE MINIMUM DESIGN LOADS AND ASSOCIATED CRITERIA FOR BUILDING AND OTHER
- USACE ENGINEERING MANUAL, DESIGN OF SHEET PILE WALLS BY UNITED STATES ARMY
- CORPS OF ENGINEERS, EM 1110 2 2504
- AMERICAN INSTITUTE OF STEEL CONTRACTORS, STEEL CONSTRUCTION MANUAL 15TH EDITION, AISC 360-16.
- USACE HURRICANE AND STORM DAMAGE RISK REDUCTION SYSTEM DESIGN GUIDELINES, UPDATED JUNE 2012.
- AMERICAN ASSOCIATION OF STATE HIGHWAY AND TRANSPORTATION OFFICIALS, LRFD BRIDGE DESIGN SPECIFICATIONS, 2012.

MATERIALS

- BARS AND C, MC, AND L SHAPES
 - ASTM A36, GALV, UNO ASTM A572, GRADE 60
- SHEET PILE ASTM A252, GRADE 3 MODIFIED TO
- PIPE PILES MEET ASTM A572 GRADE 55
- TIE ROD ASSEMBLY
 - THREADED BARS GRADE 150 KSI
 - **BEARING PLATE** ASTM A572/A588 GRADE 50 ASTM F436
 - HARDENED WASHER HEX NUT WITH JAM NUT ASTM 108/S576
- GALVANIZED BOLTS FOR SPLICE CONNECTIONS ASTM A325 WITH A563 NUTS AND HARDENED WASHER

STRUCTURAL STEEL AND MISCELLANEOUS METAL

- 1. WELDING SHALL CONFORM TO "STRUCTURAL WELDING CODE STEEL" (AWS D1.1).
- 2. PROVIDE 1" DIAMETER BLEED HOLES IN WALERS AT 10'-0" ON CENTER MAX, AVOID CONTACT WITH SPLICE PLATE CONNECTION.

CONSTRUCTION SEQUENCE

SECTION C1

- 1. INSTALL LEFT AND RIGHT SHEET PILE WALL
- 2. INSTALL FILL UP TO EL. +3 FT UNIFORMLY OVER MIN 10 DAYS
- 3. INSTALL TIE ROD AT ELEVATION NOTED ON SHEET S-03
- 4. INSTALL FILL UP TO EL. +9 FT UNIFORMLY OVER MIN 6 DAYS

SECTION C2

- 1. INSTALL LEFT AND RIGHT SHEET PILE WALL
- 2. INSTALL FILL UP TO EL. -7 FT UNIFORMLY OVER MIN 7 DAYS
- 3. INSTALL TIE ROD AT ELEVATION NOTED ON SHEET S-03
- 4. INSTALL FILL UP TO EL. -1 FT UNIFORMLY OVER MIN 7 DAYS
- 5. INSTALL FILL UP TO EL. +5 FT UNIFORMLY OVER MIN 7 DAYS
- 6. INSTALL FILL UP TO EL. +9 FT UNIFORMLY OVER MIN 7 DAYS
- 7. INSTALL 30 FT WIDE BERM, EL. +5 FT UNIFORMLY OVER 7 DAYS

SECTION C3

1. INSTALL LEFT AND RIGHT SHEET PILE WALL

- 2. INSTALL FILL UP TO EL. +0 FT UNIFORMLY OVER MIN 10 DAYS
- 3. INSTALL TIE ROD AT ELEVATION NOTED ON SHEET S-03 4. INSTALL FILL UP TO EL. +3 FT UNIFORMLY OVER MIN 3 DAYS
- 5. INSTALL FILL UP TO EL. +9 FT UNIFORMLY OVER MIN 10 DAYS

SECTION C4A

- 1. INSTALL LEFT AND RIGHT SHEET PILE WALL
- 2. INSTALL FILL UP TO EL. +0 FT UNIFORMLY OVER MIN 10 DAYS
- 3. INSTALL TIE ROD AT ELEVATION NOTED ON SHEET S-03 4. INSTALL FILL UP TO EL. +9 FT UNIFORMLY OVER MIN 6 DAYS

SECTION C4

- 1. INSTALL LEFT AND RIGHT SHEET PILE WALL
- 2. INSTALL FILL UP TO EL. -3 FT UNIFORMLY OVER MIN 10 DAYS
- 3. INSTALL TIE ROD AT ELEVATION NOTED ON SHEET S-03 4. INSTALL FILL UP TO EL. +9 FT UNIFORMLY OVER MIN 6 DAYS

SECTION C5

- 1. INSTALL LEFT AND RIGHT SHEET PILE WALL
- 2. INSTALL FILL UP TO EL. -1 FT UNIFORMLY OVER MIN 10 DAYS
- 3. INSTALL TIE ROD AT ELEVATION NOTED ON SHEET S-03 4. INSTALL FILL UP TO EL. +9 FT UNIFORMLY OVER MIN 6 DAYS

SECTION C6, C7

- 1. INSTALL LEFT AND RIGHT SHEET PILE WALL 2. CUT BETWEEN THE SHEET PILES TO ELEVATION 0 FT
- 3. INSTALL TIE RODS AT ELEVATION NOTED ON SHEET S-03 4. INSTALL FILL UP TO EL. +9 FT UNIFORMLY OVER MIN 6 DAYS

AFTER INSTALLATION OF THE DOUBLE WALL COFFERDAM

14 DAYS

3 DAYS

14 DAYS

- 1. MINIMUM TIME FOR DEWATERING TO EXISTING MUDLINE 4 DAYS
- 2. MINIMUM TIME FOR EXCAVATING TO 50% DEPTH 3. MINIMUM TIME TO DEWATER TO FINAL LEVEL 4. MINIMUM TIME FOR EXCAVATING TO 100% DEPTH

ABBREVIATIONS

ANGLE ASCE AMERICAN SOCIETY OF CIVIL ENGINEERS AMERICAN WELDING SOCIETY AWS

BEG BEGINNING BOW BOTTOM OF WALL CONST CONSTRUCTION

CONT CONTINUOUS OR CONTINUED DIA DIAMETER DWG DRAWING EA EACH **ELEVATION EASTING**

EXIST. **EXISTING** FG FINISH GRADE FOW FACE OF WALL FS FINISH SURFACE FT FEET HORIZ HORIZONTAL

INV INVERT JT JOINT LF LINEAR FEET LT LEFT MAX MAXIMUM MHW

MIN MINIMUM MISC. MISCELLANEOUS NORTHING

NTS NOT TO SCALE NAVD NORTH AMERICAN VERTICAL DATUM

MEAN HIGH WATER

ON CENTER PROF PROFILE PT POINT QTY QUANTITY RET RETAINING ROW RIGHT OF WAY RT RIGHT SHT SHEET STA STATION STD STANDARD T&B TOP AND BOTTOM TOW TOP OF WALL TYP TYPICAL UNK UNKNOWN

UNO UNLESS NOTED OTHERWISE USACE UNITED STATES ARMY CORPS OF ENGINEERS

VERT VERTICAL WIDTH WITH W/

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NORTHERN IMPOUNDMENT PRE-FINAL 90% REMEDIAL DESIGN HARRIS COUNTY, TEXAS

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No.	Issue	Drawn	Approved		
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Drafti Chec	9 10100	Design Check	sc		
Proje Coor	ct CM dinator	Date	Jun 24, 20)22	
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Arch D

construction. Original Size

> **STRUCTURAL NOTES**

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Sheet - of -

Sheet No.

S-01

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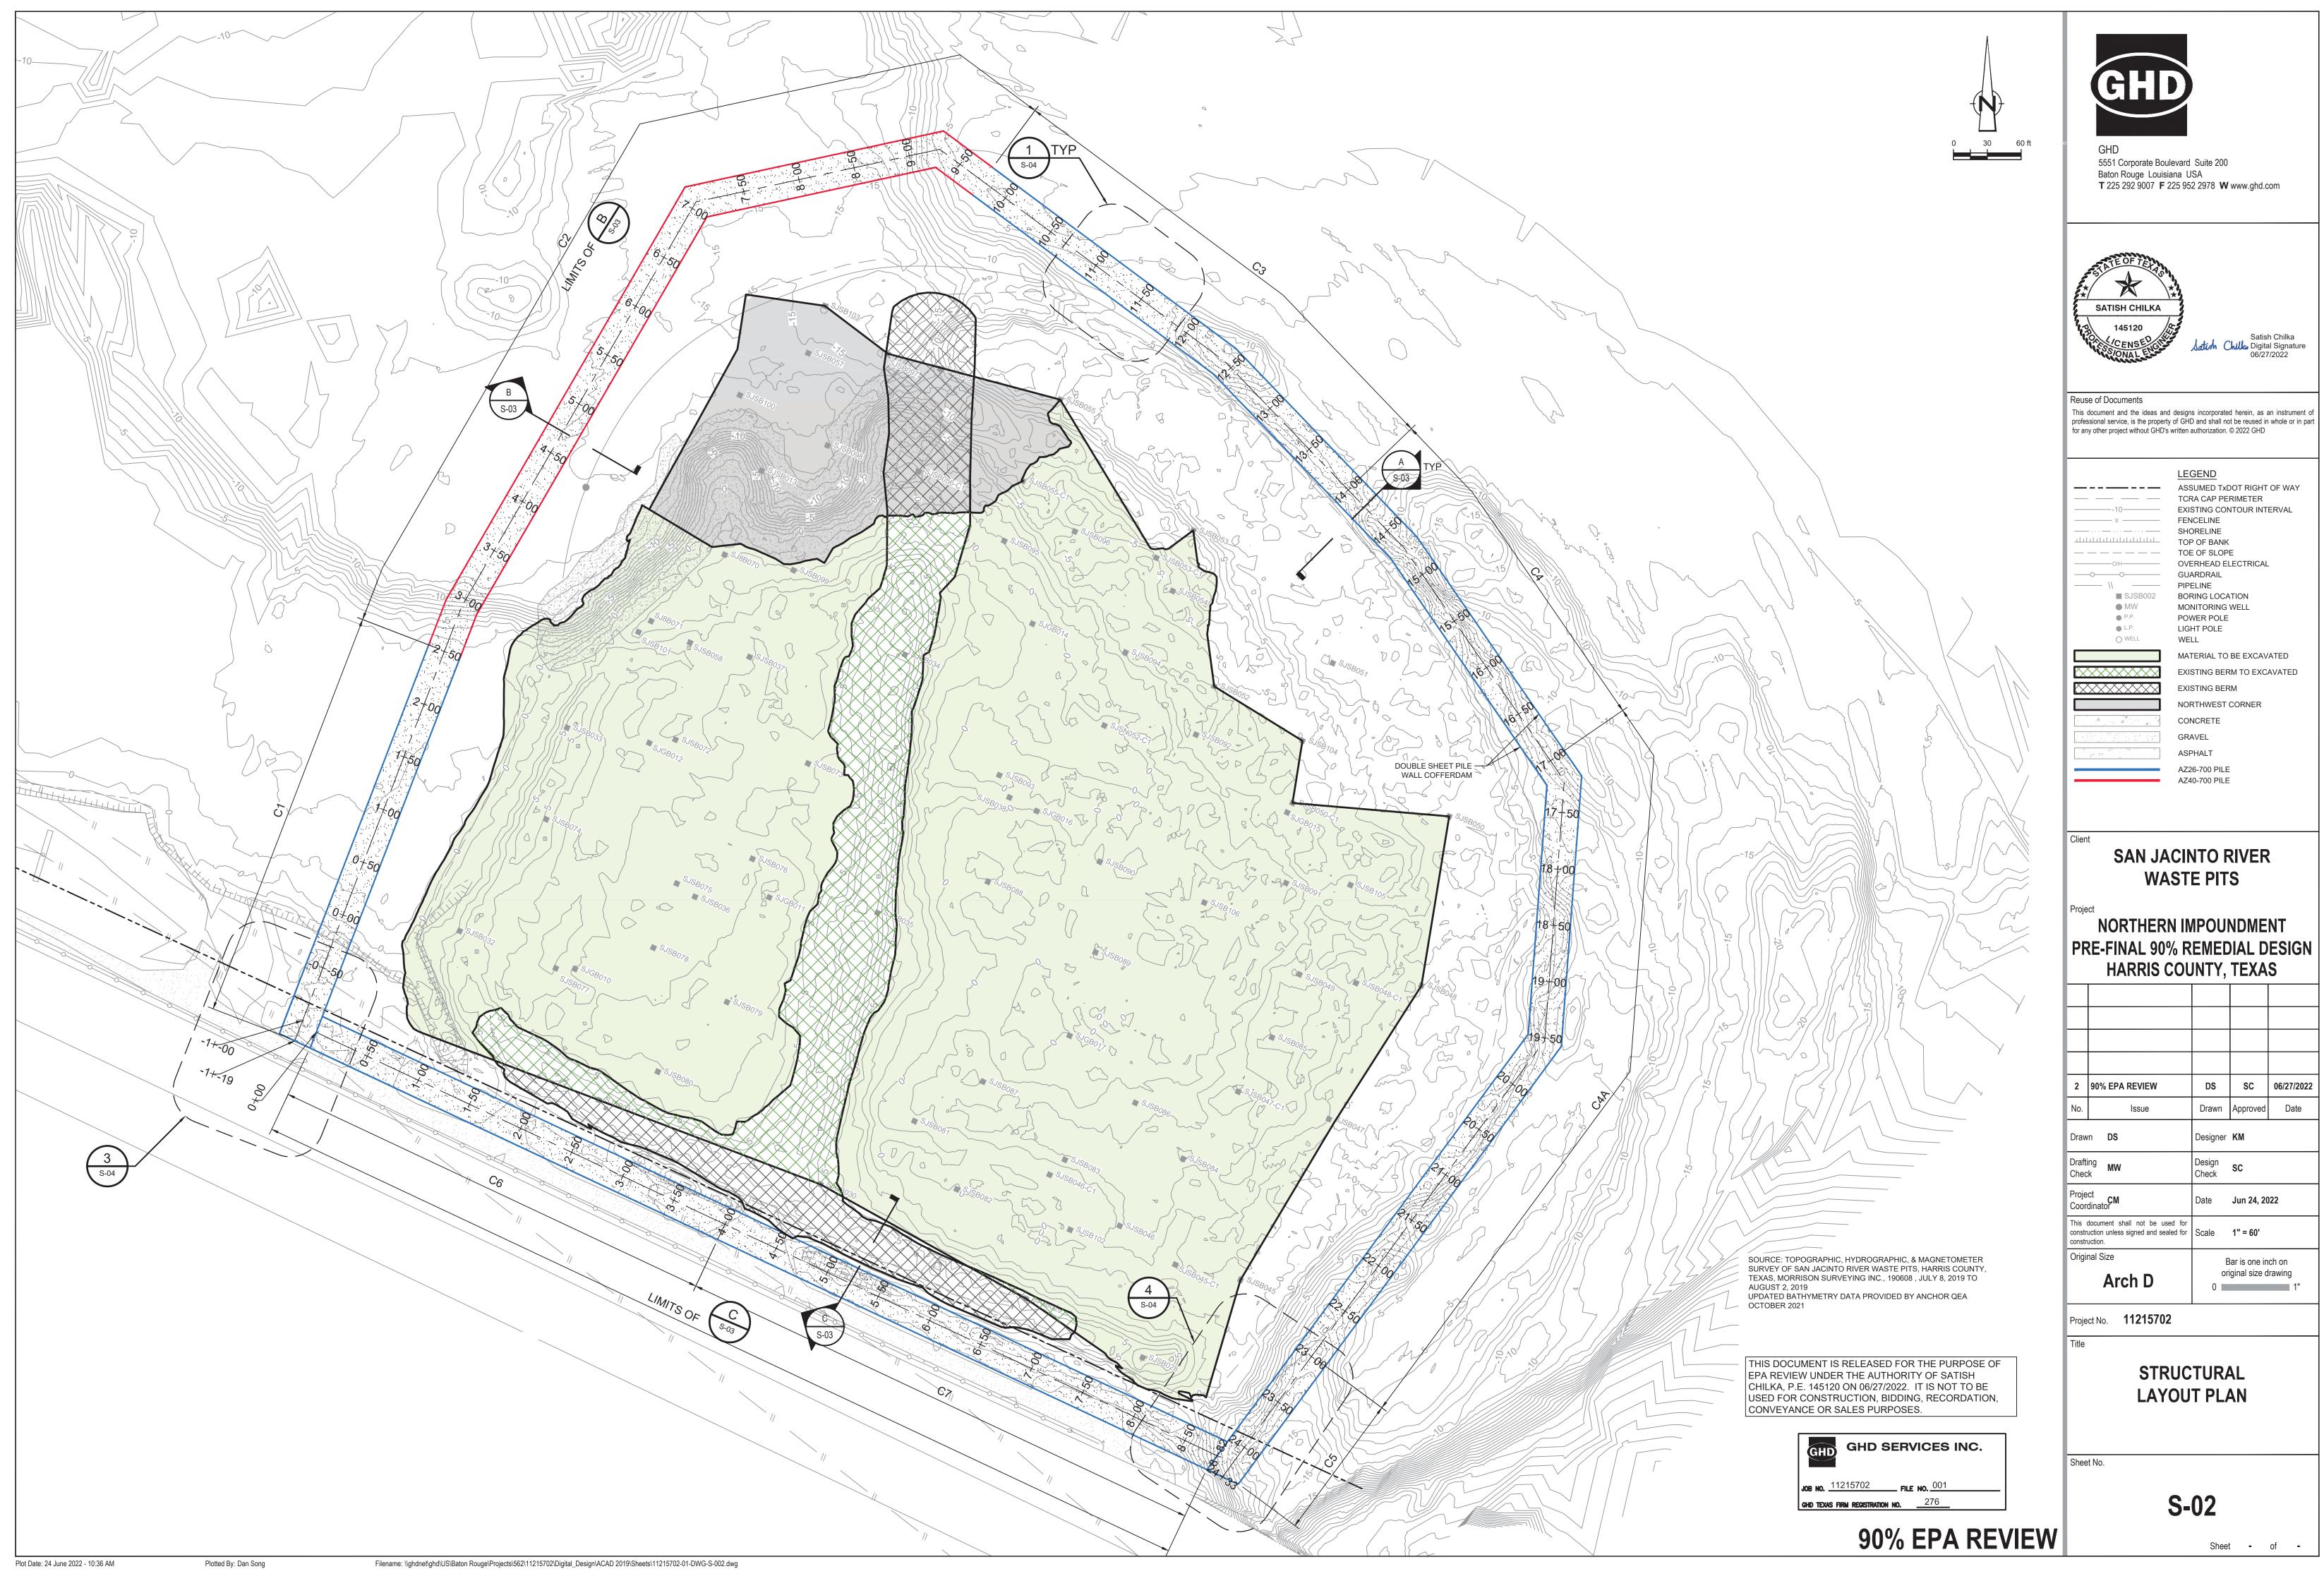
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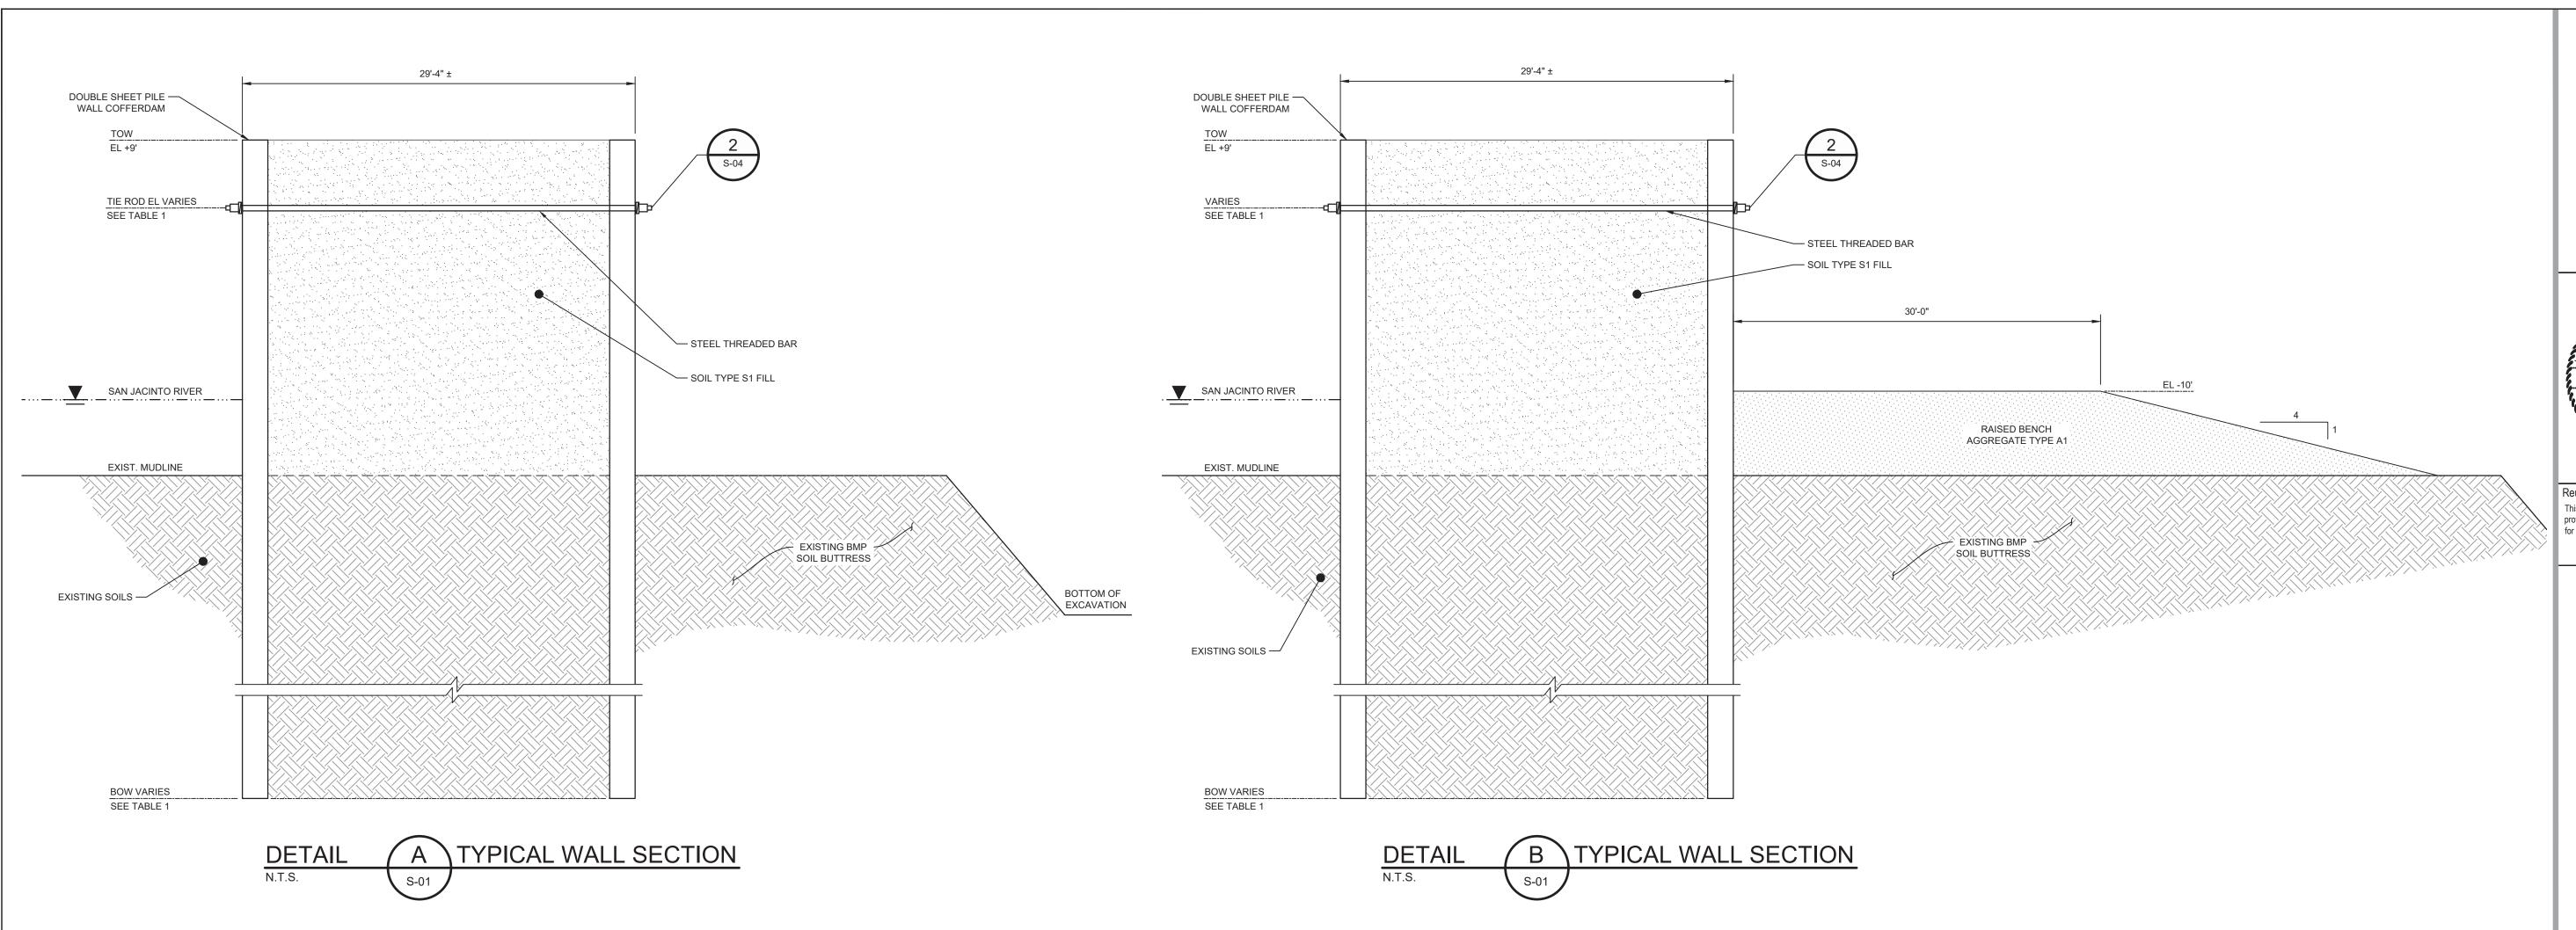
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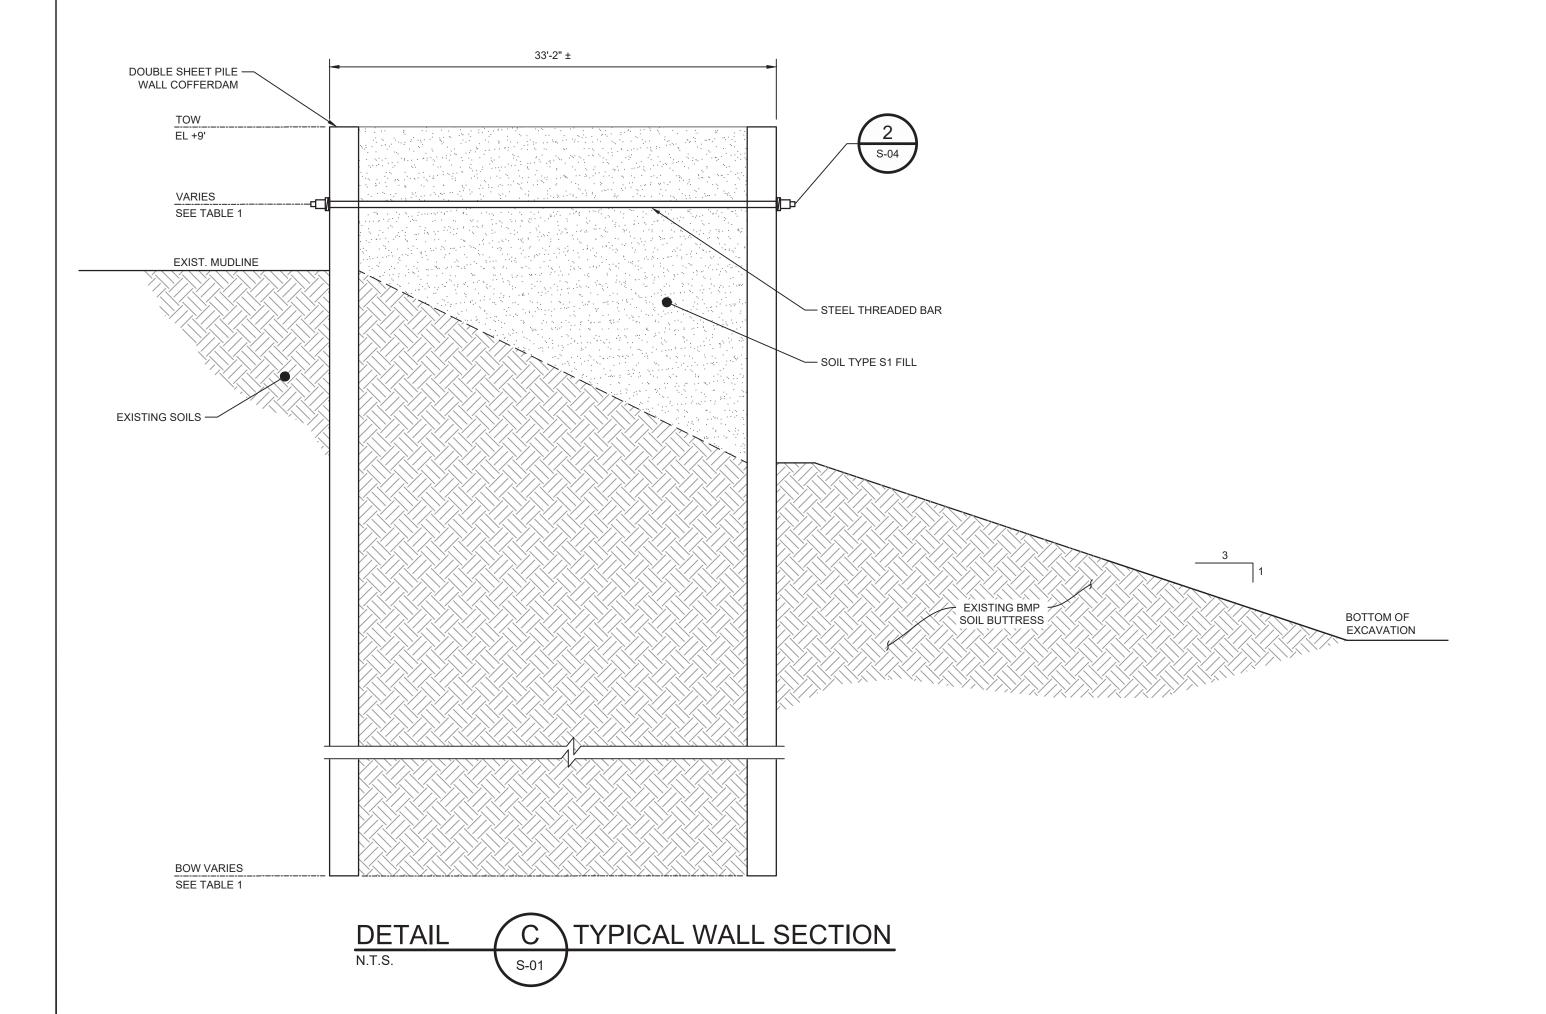
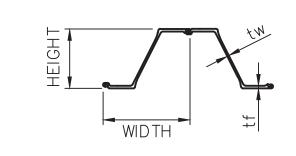


TABLE 1								
WALL SEGMENT	START STA	END STA	DETAIL	SHEET PILE SECTION	SHEET PILE LENGTH (FT)	TIE ROD NOMINAL DIAMETER (IN)	TIE ROD SPACING (FT)	TIE ROD EL (FT)
C1	-1+10	2+50	А	AZ26-700	50	2.25	5	3
C2	2+50	9+75	В	AZ40-700N	55	3.00	5	-5
C3	9+75	14+00	А	AZ26-700	50	2.25	5	0
C4	14+00	17+00	А	AZ26-700	50	2.25	5	0
C4A	17+00	23+00	А	AZ26-700	50	2.25	5	6
C5	23+00	24+33	А	AZ26-700	60	2.25	5	0
C6	0+00	4+00	С	AZ26-700	60	2.25	5	0
C7	4+00	8+82	С	AZ26-700	60	2.25	5	0

MINIMUM STEEL SHEET PILE										
		YIELD	WIDTH w	HEIGHT h	THICKN	IESS (IN)	WEIG	ЭНТ	ELASTIC	
SSP SECTION	ASTM	STRENGTH (KSI)	(IN)	(IN)	FLANGE tf	WEB tw	SINGLE PILE (LB/FT)	WALL AREA (LB/FT2)	MODULUS (IN3/FT)	
AZ26-700	A572	60	27.56	18.11	0.480	0.480	69.12	30.10	48.4	
AZ40-700N	A572	60	27.56	19.72	0.669	0.520	90.16	39.26	74.3	



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SAN JACINTO RIVER WASTE PITS

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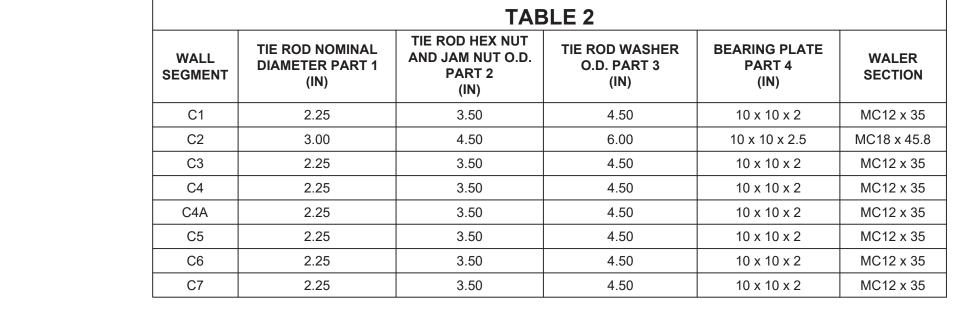
STRUCTURAL SECTIONS


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Plot Date: 24 June 2022 - 10:07 AM







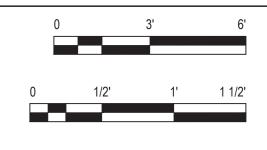

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PRE-FINAL 90% REMEDIAL DESIGN
HARRIS COUNTY, TEXAS

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No.	Issue	Drawn	Approved	Dat
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Arch D

Project No. **11215702**

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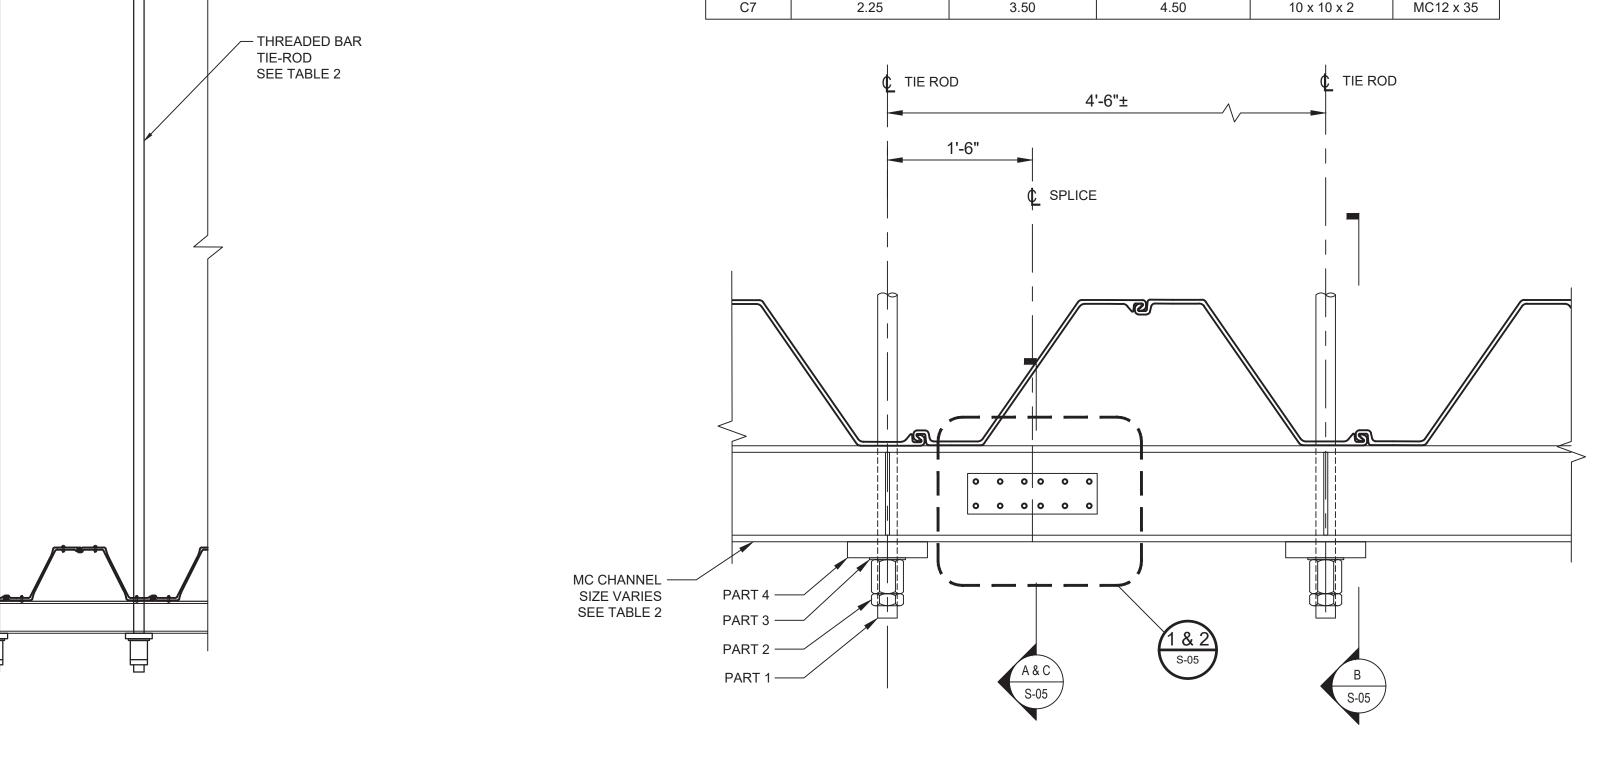
STRUCTURAL DETAILS 1 of 2

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S-04

S-04Sheet - of -

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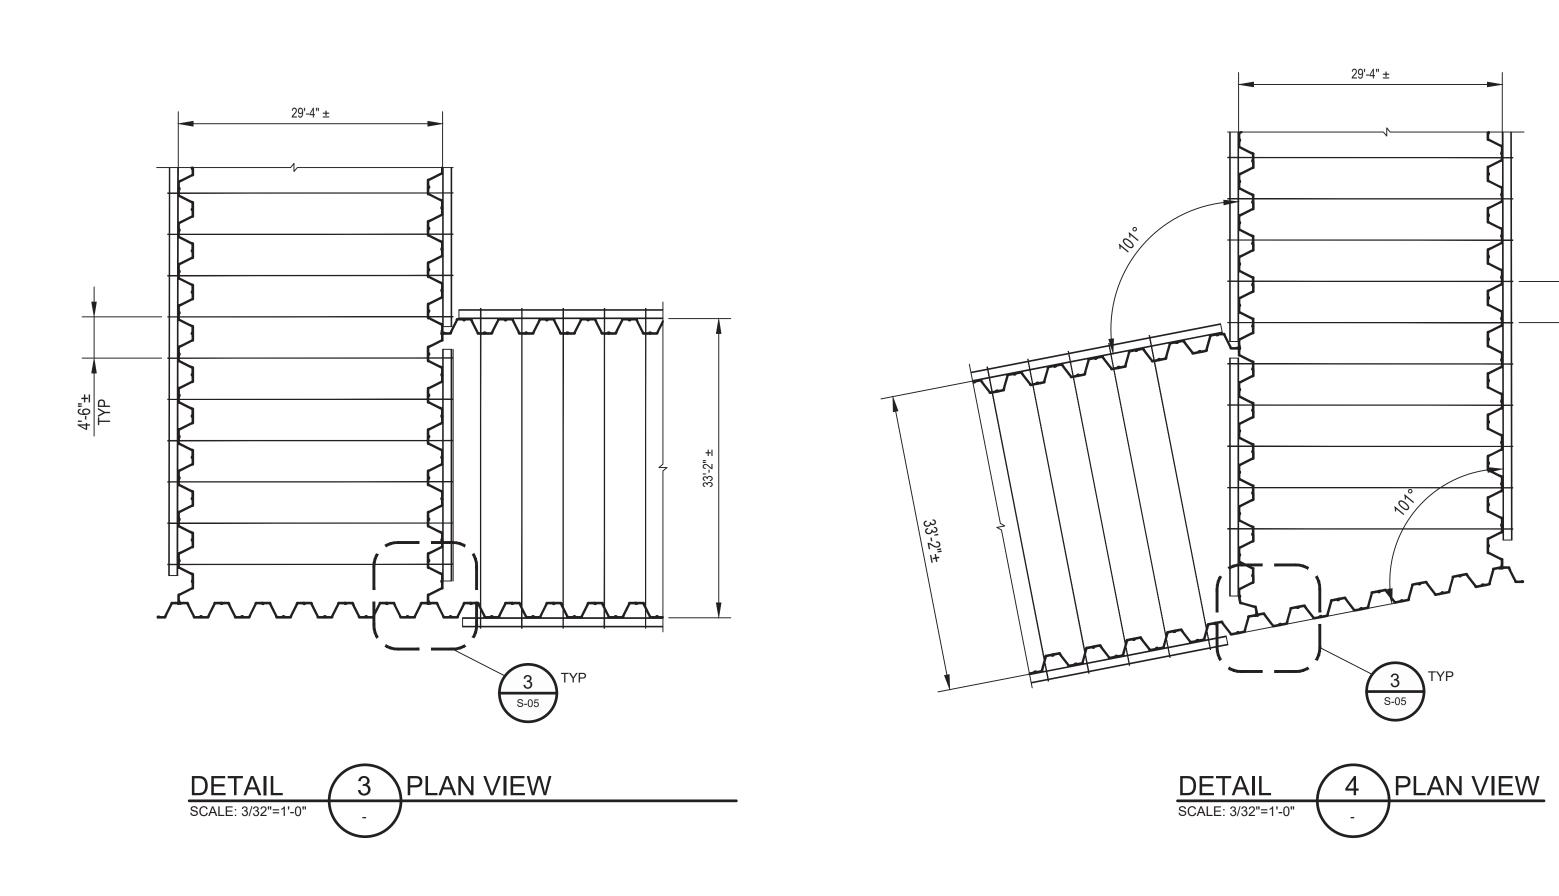


NOTE:

1. STAGGER WALER SPLICE ON INTERIOR AND EXTERIOR WALL BY 10'-0" +/
2. WELD 1/2" THICK STEEL PLATES BETWEEN T&B WALERS TO MAINTAIN SPACING

DETAIL 2 PLAN VIEW

SCALE: 1"=1'-0"




- MC CHANNEL SIZE

- SHEET PILE WALL COFFERDAM

VARIES SEE TABLE 2

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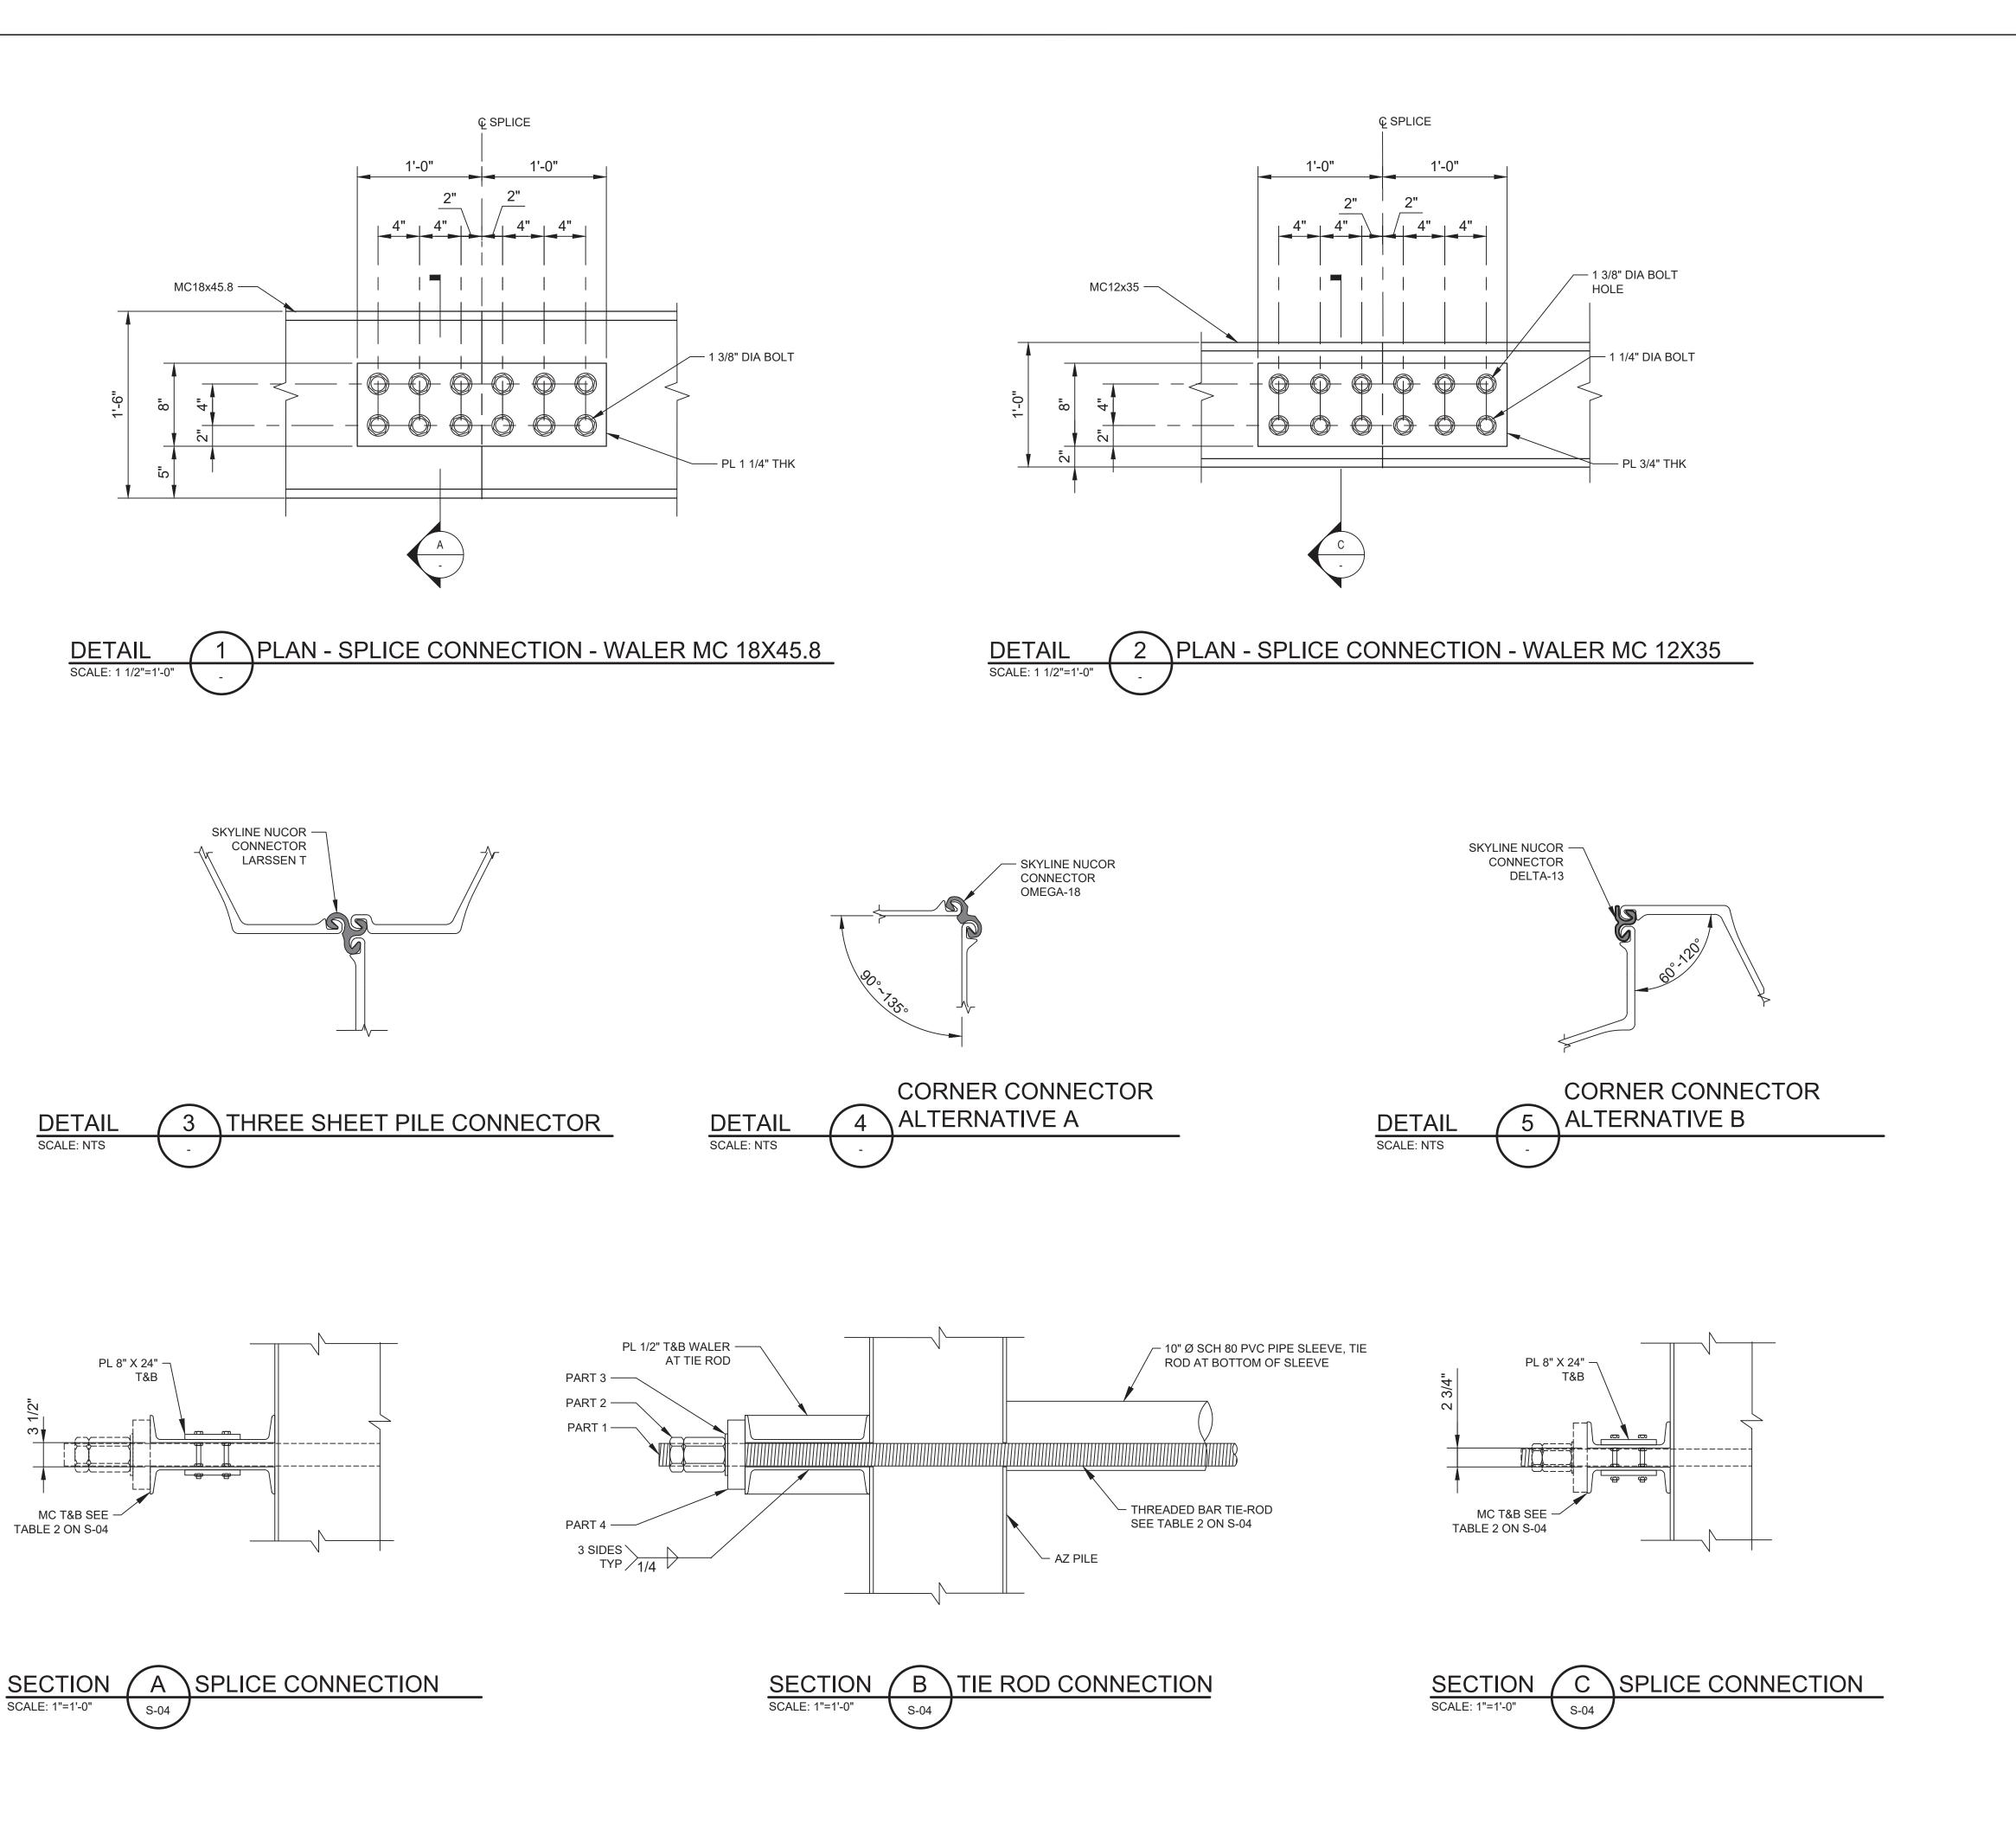
• • • • •

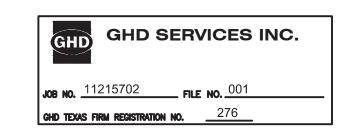SHEET PILE WALL -COFFERDAM

MC CHANNEL SIZE -VARIES SEE TABLE 2

SCALE: 1"=3'-0"

DETAIL 1 PLAN VIEW





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SAN JACINTO RIVER WASTE PITS

NORTHERN IMPOUNDMENT PRE-FINAL 90% REMEDIAL DESIGN HARRIS COUNTY, TEXAS

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		document shall not be used for uction unless signed and sealed for uction.	Scale	AS SHOW	'N

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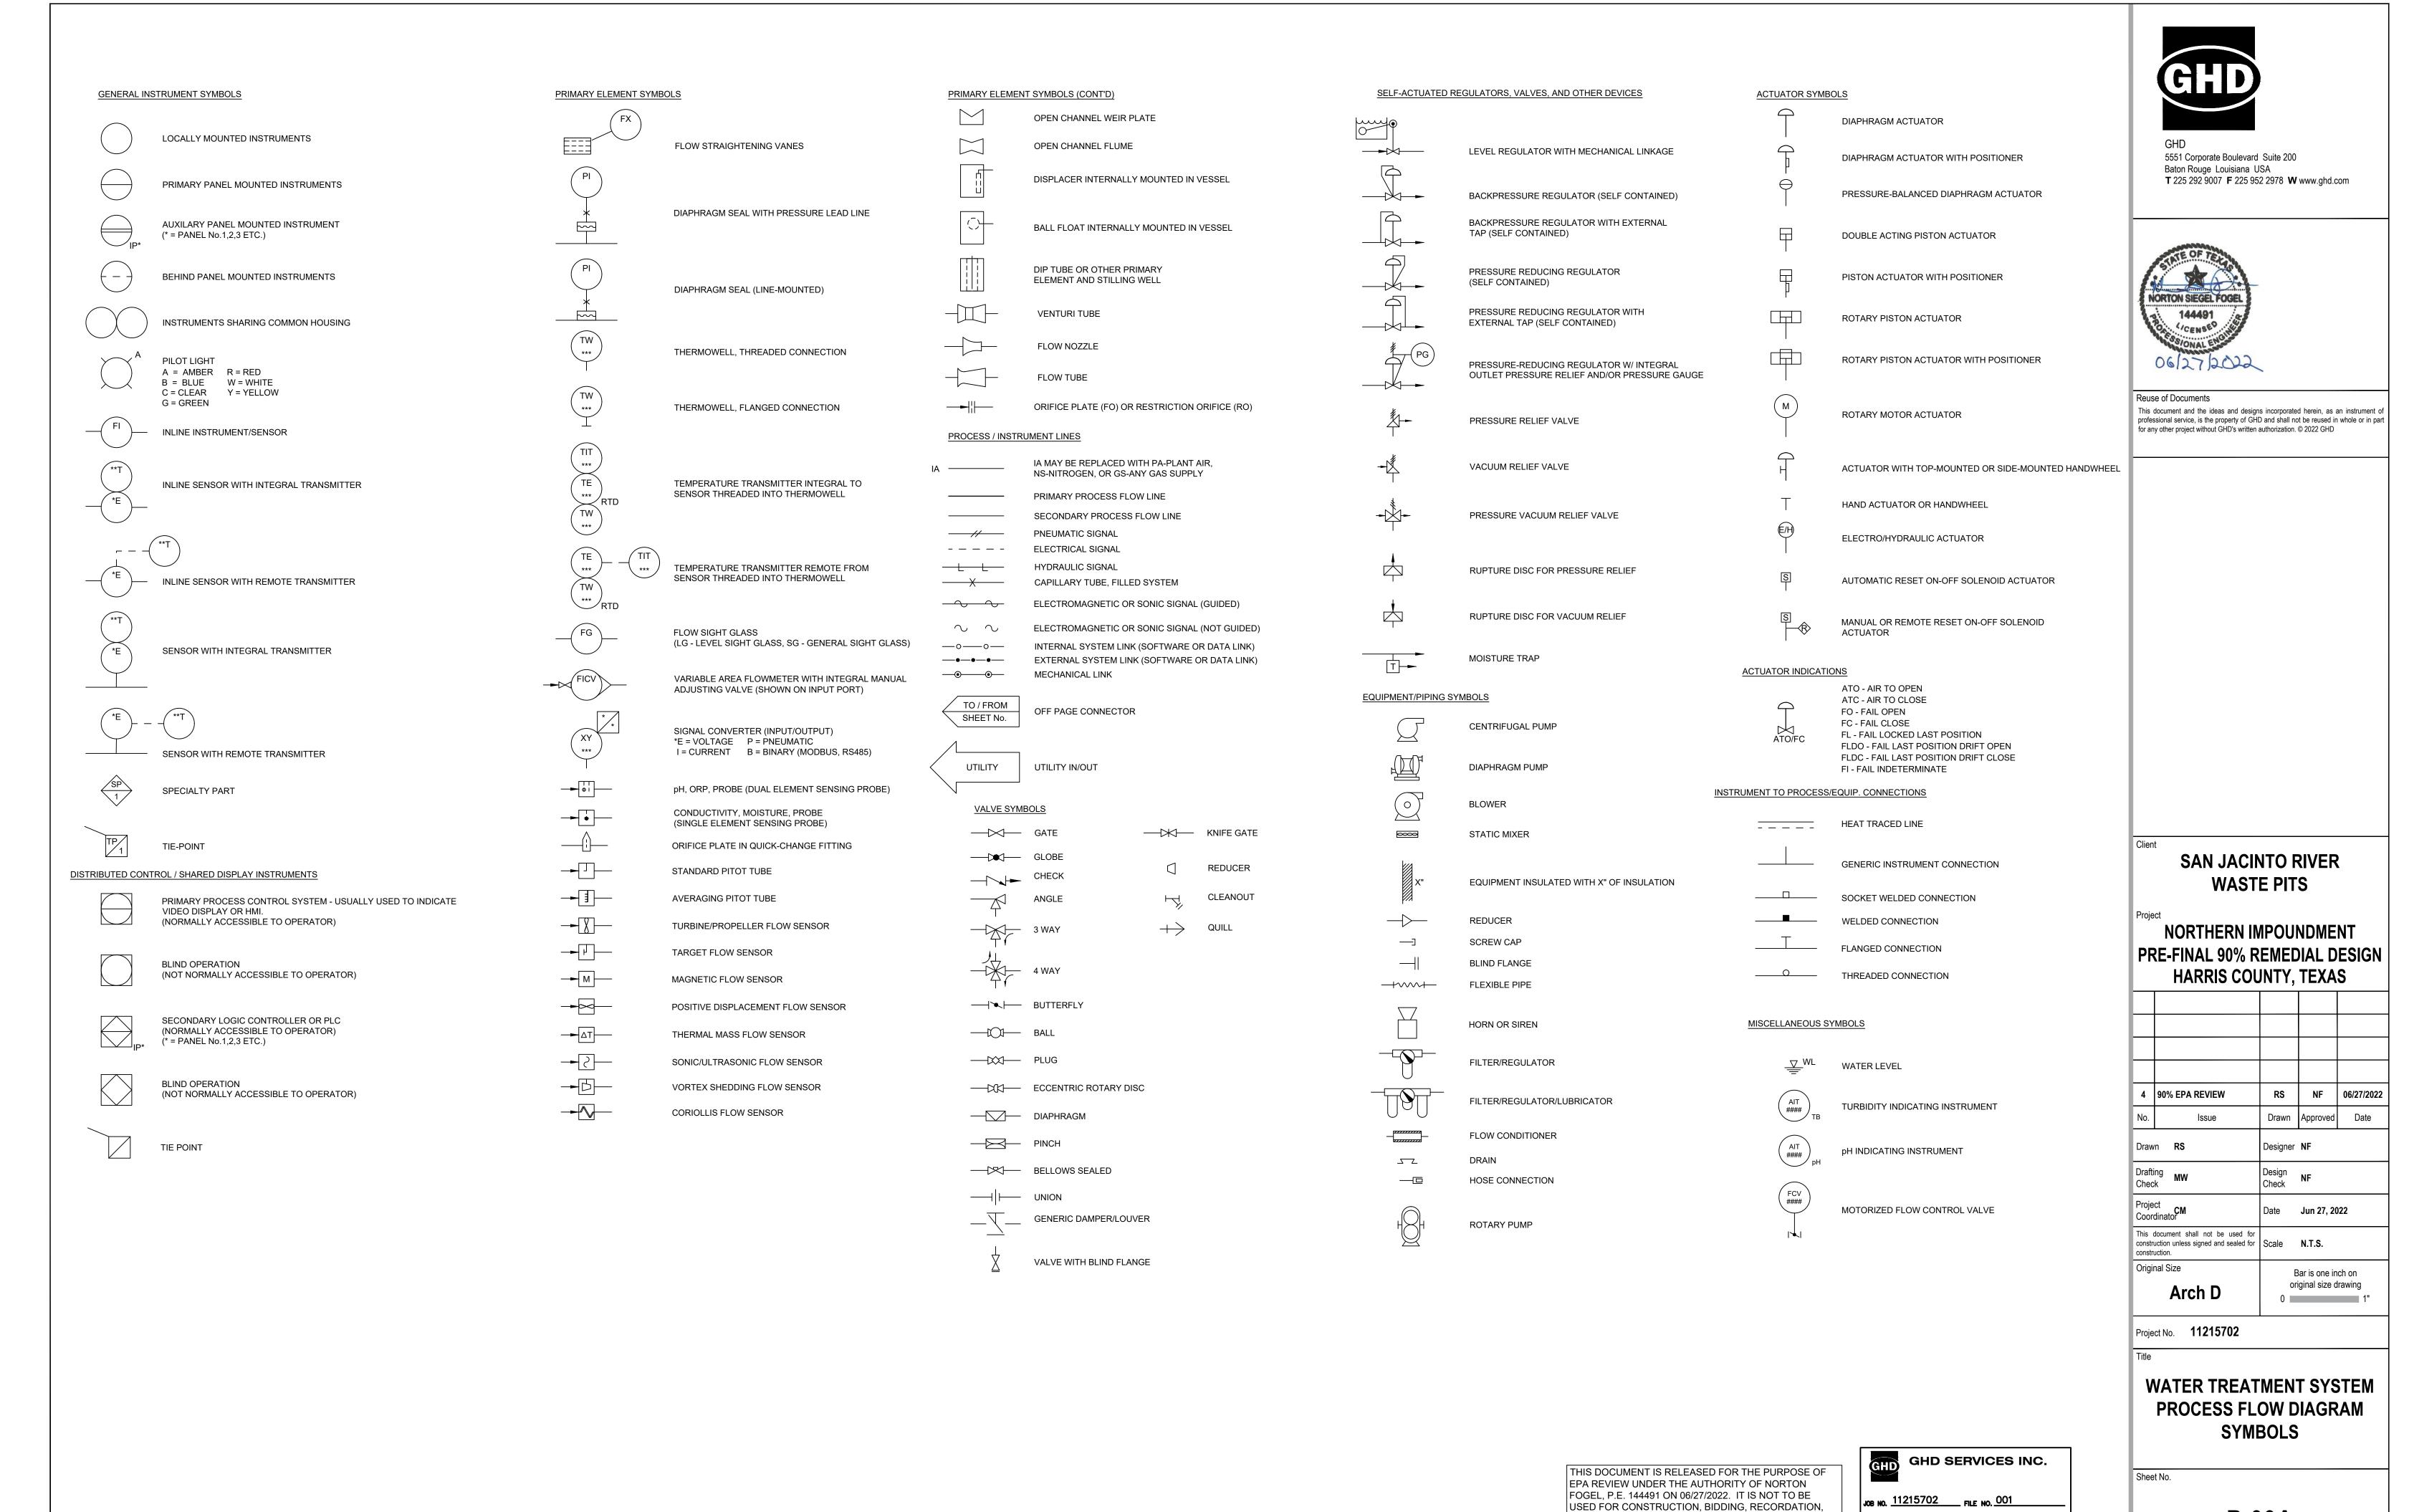
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P-00A

TYPICAL INTERNATIONAL SOCIETY OF AUTOMATION LETTER COMBINATIONS

			Cont	trollers	Self- Actuated	Readout [Devices		witches a		Т	ransmitter	S	Solenoids, Relays,			Well	Viewing		
First- Letters	Initiating or Measured Variable	Recording	gIndicatin	g Blind	Control Valves	Recording	Indicating	High **	Low	Comb	Recording	gIndicatin	g Blind	Computing Devices	Primary Element		or Probe	Device, Glass	Safety Device	Final Element
A	Analysis	ARC	AIC	AC		AR	Al	ASH	ASL	ASHL	ART	AIT	АТ	AY	AE	AP	AW			AV
В	Burner/Combustion	BRC	BIC	ВС		BR	ВІ	BSH	BSL	BSHL	BRT	BIT	ВТ	BY	BE		BW	BG		BZ
С	User's Choice																			
D	User's Choice																			
E	Voltage	ERC	EIC	EC		ER	EI	ESH	ESL	ESHL	ERT	EIT	ET	EY	EE					EZ
F	Flow Rate	FRC	FIC	FC	FCV,	FR	FI	FSH	FSL	FSHL	FRT	FIT	FT	FY	FE	FP		FG		FV
FQ	Flow Quantity	FQRC	FQIC		FICV	FQR	FQI	FQSH	FQSL			FQIT	FQT	FQY	FQE					FQV
FF	Flow Ratio	FFRC	FFIC	FFC		FFR	FFI	FFSH	FFSL						FE					FFV
G	User's Choice																			
н	Hand		HIC	HC						HS										HV
1	Current	IRC	IIC			IR	Ш	ISH	ISL	ISHL	IRT	IIT	IT	IY	ΙE					IZ
J	Power	JRC	JIC			JR	JI	JSH	JSL	JSHL	JRT	JIT	JT	JY	JE					JV
К	Time	KRC	KIC	KC	KCV	KR	KI	KSH	KSL	KSHL	KRT	KIT	KT	KY	KE					KV
L	Level	LRC	LIC	LC	LCV	LR	LI	LSH	LSL	LSHL	LRT	LIT	LT	LY	LE		LW	LG		LV
М	User's Choice																			
N	User's Choice																			
0	User's Choice																			
Р	Pressure/Vacuum	PRC	PIC	PC	PCV	PR	PI	PSH	PSL	PSHL	PRT	PIT	PT	PY	PE	PP			PSV,	PV
PD	Pressure, Differential	PDRC	PDIC	PDC	PDCV	PDR	PDI	PDSH	PDSL		PDRT	PDIT	PDT	PDY	PE	PP			PSE	PDV
Q	Quantity	QRC	QIC			QR	QI	QSH	QSL	QSHL	QRT	QIT	QT	QY	QE					QZ
R	Radiation	RRC	RIC	RC		RR	RI	RSH	RSL	RSHL	RRT	RIT	RT	RY	RE		RW			RZ
S	Speed/Frequency	SRC	SIC	SC	SCV	SR	SI	SSH	SSL	SSHL	SRT	SIT	ST	SY	SE					SV
Т	Temperature	TRC	TIC	TC	TCV	TR	TI	TSH	TSL	TSHL	TRT	TIT	TT	TY	TE	TP	TW		TSE	TV
TD	Temperature, Differential	TDRC	TDIC	TDC	TDCV	TDR	TDI	TDSH	TDSL		TDRT	TDIT	TDT	TDY	TE	TP	TW			TDV
U	Multivariable					UR	UI							UY						UV
V	Vibration/Machinery Analysis					VR	VI	VSH	VSL	VSHL	VRT	VIT	VT	VY	VE					VZ
W	Weight/Force	WRC	WIC	WC	WCV	WR	WI	WSH	WSL	WSHL	WRT	WIT	WT	WY	WE					WZ
WD	Weight/Force, Differential	WDRC	WDIC	WDC	WDCV	WDR	WDI	WDSH	WDSL		WDRT	WDIT	WDT	WDY	WE					WDZ
X	Unclassified																			
Y	Event/State/Presence		YIC	YC		YR	ΥI	YSH	YSL				ΥT	YY	YE					YZ
Z	Position/Dimension	ZRC	ZIC	ZC	ZCV	ZR	ZI	ZSH	ZSL	ZSHL	ZRT	ZIT	ZT	ZY	ZE					ZV
ZD	Gauging/Deviation	ZDRC	ZDIC	ZDC	ZDCV	ZDR	ZDI	ZDSH	ZDSL		ZDRT	ZDIT	ZDT	ZDY	ZDE					ZDV

NOTE: THIS TABLE IS NOT ALL-INCLUSIVE.

* A, ALARM, THE ANNUNCIATING DEVICE, MAY BE USED IN THE SAME FASHION AS S, SWITCH, THE ACTUATING DEVICE.

** THE LETTERS H AND L MAY BE OMITTED IN THE UNDEFINED CASE.

FO (RESTRICTION ORIFICE)

OTHER POSSIBLE COMBINATIONS:

LLH (LEVEL LIGHT HIGH)

FRK, HIK (CONTROL STATIONS LCL (LEVEL CONTROL LOW) KQI (RUNNING TIME INDICATOR) LCH (LEVEL CONTROL HIGH)

HMS (HAND MOMENTARY SWITCH)

ABBREVIATIONS:

INSTRUMENTS

NC - NORMALLY CLOSED HOA - HAND/OFF/AUTO LOR - LOCAL/OFF/REMOTE NO - NORMALLY OPEN OPN - OPEN ST - START / ENABLE CLS - CLOSE SP - STOP / DISABLE STPT - SETPOINT JOG - PUMP MOTOR ES - EMERGENCY STOP SA - SINGLE ACTING

DA - DOUBLE ACTING

PIPE FLUID SERVICE CODE INDEX SEE PIPING SPECIFICATIONS FOR DETAILS

PROCESS MEDIA CODE SERVICE CHLORINE LIQUID OR GAS COOLING TOWER WATER CTW1 CW3 PROCESS WATER CW4 CHILLED WATER NaOH7 CAUSTIC SODA SOLUTION GCO GLYCOL NITROGEN (DRY COMPRESSED GAS) STEAM CONDENSATE PROCESS VENT STORM SEWER PROCESS RELIEF GROUNDWATER DRAIN INSTRUMENT AIR VAPOR EXTRACTION NON POTABLE WATER H2SO4 SULFURIC ACID DOMESTIC WATER INF INFLUENT WATER (CONTACT WATER) EFF EFFLUENT WATER (TREATED WATER) SLG SLUDGE BACKWASH COAG COAGULANT POLY POLYMER ORGANOSULFIDE DEC DECANT WATER CONT WTS CONTAINMENT AREA DRAINAGE

IDENTIFICATION LETTERS

	FIRST-LETTER		SUCCEEDING-LETTERS		
	MEASURED OR INITIATING VARIABLE	MODIFIER	READOUT OR PASSIVE FUNCTION	OUTPUT FUNCTION	MODIFIER
Α	Analysis		Alarm		
В	Burner/Combustion		User's Choice	User's Choice	User's Choice
С	User's Choice	Conductivity		Control	
D	User's Choice	Differential, Density			
Е	Voltage		Sensor (Primary Element)		
F	Flow Rate	Ratio (Fraction)			
G	User's Choice		Glass, Viewing Device, Gauge		
Н	Hand				High
1	Current (Electrical)		Indicate		
J	Power	Scan			
K	Time, Time Schedule	Time Rate of Change		Control Station	
L	Level		Light		Low
М	User's Choice	Momentary, Moisture			Middle, Intermediate
Ν	User's Choice		User's Choice	User's Choice	User's Choice
0	User's Choice		Orifice, Restriction		
Р	Pressure, Vacuum		Point (Test) Connection		
Q	Quantity	Integrate, Totalize			
R	Radiation		Record		
S	Speed, Frequency	Safety		Switch	
Т	Temperature			Transmit	
U	Multivariable		Multifunction	Multifunction	Multifunction
V	Vibration, Machinery Analysis			Valve, Damper, Louver	
W	Weight, Force		Well		
Χ	Unclassified	X Axis	Unclassified	Unclassified	Unclassified
Υ	Event, State, or Presence	Y Axis		Relay, Compute, Convert	
Z	Position, Dimension	Z Axis		Driver, Actuator, Unclassified Final Control Element	

LINE DESIGNATION - NOMINAL DIAMETER (INCHES) - PIPE FLUID SERVICE CODE (SEE PIPE FLUID SERVICE CODE INDEX) - PIPE MATERIAL DESCRIPTION (SEE PIPE MATERIAL INDEX) PIPE LINE NUMBER - LAST 2 DIGITS OF PID NUMBER & - SEQUENTIAL LINE NUMBER PIPE INSULATION CODE (IF REQUIRED) (SEE PIPE INSULATION CODE INDEX)

<u>PIPE MATERIAL INDEX</u> SEE PIPING SPECIFICATIONS FOR DETAILS

2"-NaOH7-CS_PTFEL-02101-I(2")ET

MAT'L	DESCRIPTION	SPEC
CS_40	CARBON STEEL SCHEDULE 40 PIPE	
CS_80	CARBON STEEL SCHEDULE 80 PIPE	
316L_10	316L STAINLESS STEEL SCHEDULE 10 PIPE	
304_40	304 STAINLESS STEEL SCHEDULE 40 PIPE	
316L_ST	316L STAINLESS STEEL TUBING	
304_ST	304 STAINLESS STEEL TUBING	
CS_T	CARBON STEEL TUBING	
CU_T	COPPER TUBING	
PE_T	POLYETHYLENE TUBING	
CS_PTFEL	CARBON STEEL PTFE LINED PIPE	
CS-PFAL	CARBON STEEL PFA LINED PIPE	
CS-GL	CARBON STEEL GLASS LINED PIPE	
CPVC_80	CPVC SCHEDULE 80 PIPE	
PCV_80	PVC SCHEDULE 80 PIPE	
304_10	304 STAINLESS STEEL SCHEDULE 10 PIPE	
FRP	FIBERGLASS REINFORCED PIPE	
HDPE_11	HIGH-DENSITY POLYETHYLENE SDR-11	
FRH	FLEXIBLE RUBBER HOSE	
304L_ST	304L STAINLESS STEEL TUBING	
304L_10	304L STAINLESS STEEL SCHEDULE 10 PIPE	
304L_ST	TEFLON TUBING-CARRIER WITH CPVC CONTAINMENT PIPE	
HDPE_DW	HDPE DOUBLE WALLED PIPE SDR-11 CARRIER AND CONTAINMENT PIPE	
PTFE_CPVC	TEFLON TUBING - CARRIER WITH CPVC CONTAINMENT PIPE	

PIPE INSULATION CODE INDEX
SEE PIPING SPECIFICATIONS FOR DETAILS

CODE	DESCRIPTION
I(2")	INSULATED (2")
NI	NOT INSULATED
JKT	JACKETED PIPE
I(2")ET	INSULATED (2") AND ELECTRICALLY TRAC
I(2")ST	INSULATED (2") AND STEAM TRACED
I(2")JKT	INSULATED (2") AND JACKETED

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GHD SERVICES INC. JOB NO. 11215702 FILE NO. 001

90% EPA REVIEW



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SAN JACINTO RIVER WASTE PITS

NORTHERN IMPOUNDMENT PRE-FINAL 90% REMEDIAL DESIGN HARRIS COUNTY, TEXAS

4	90% EPA REVIEW	RS	NF 06/27				
No.	Issue	Drawn	Approved Dat				
Draw	n RS	Designer	Designer NF				
Drafti Chec	S IVIVV	Design Check	NF				
Proje Coor	ct CM dinator	Date	June 3, 2022				
	document shall not be used for uction unless signed and sealed for uction.	Scale	N.T.S.				
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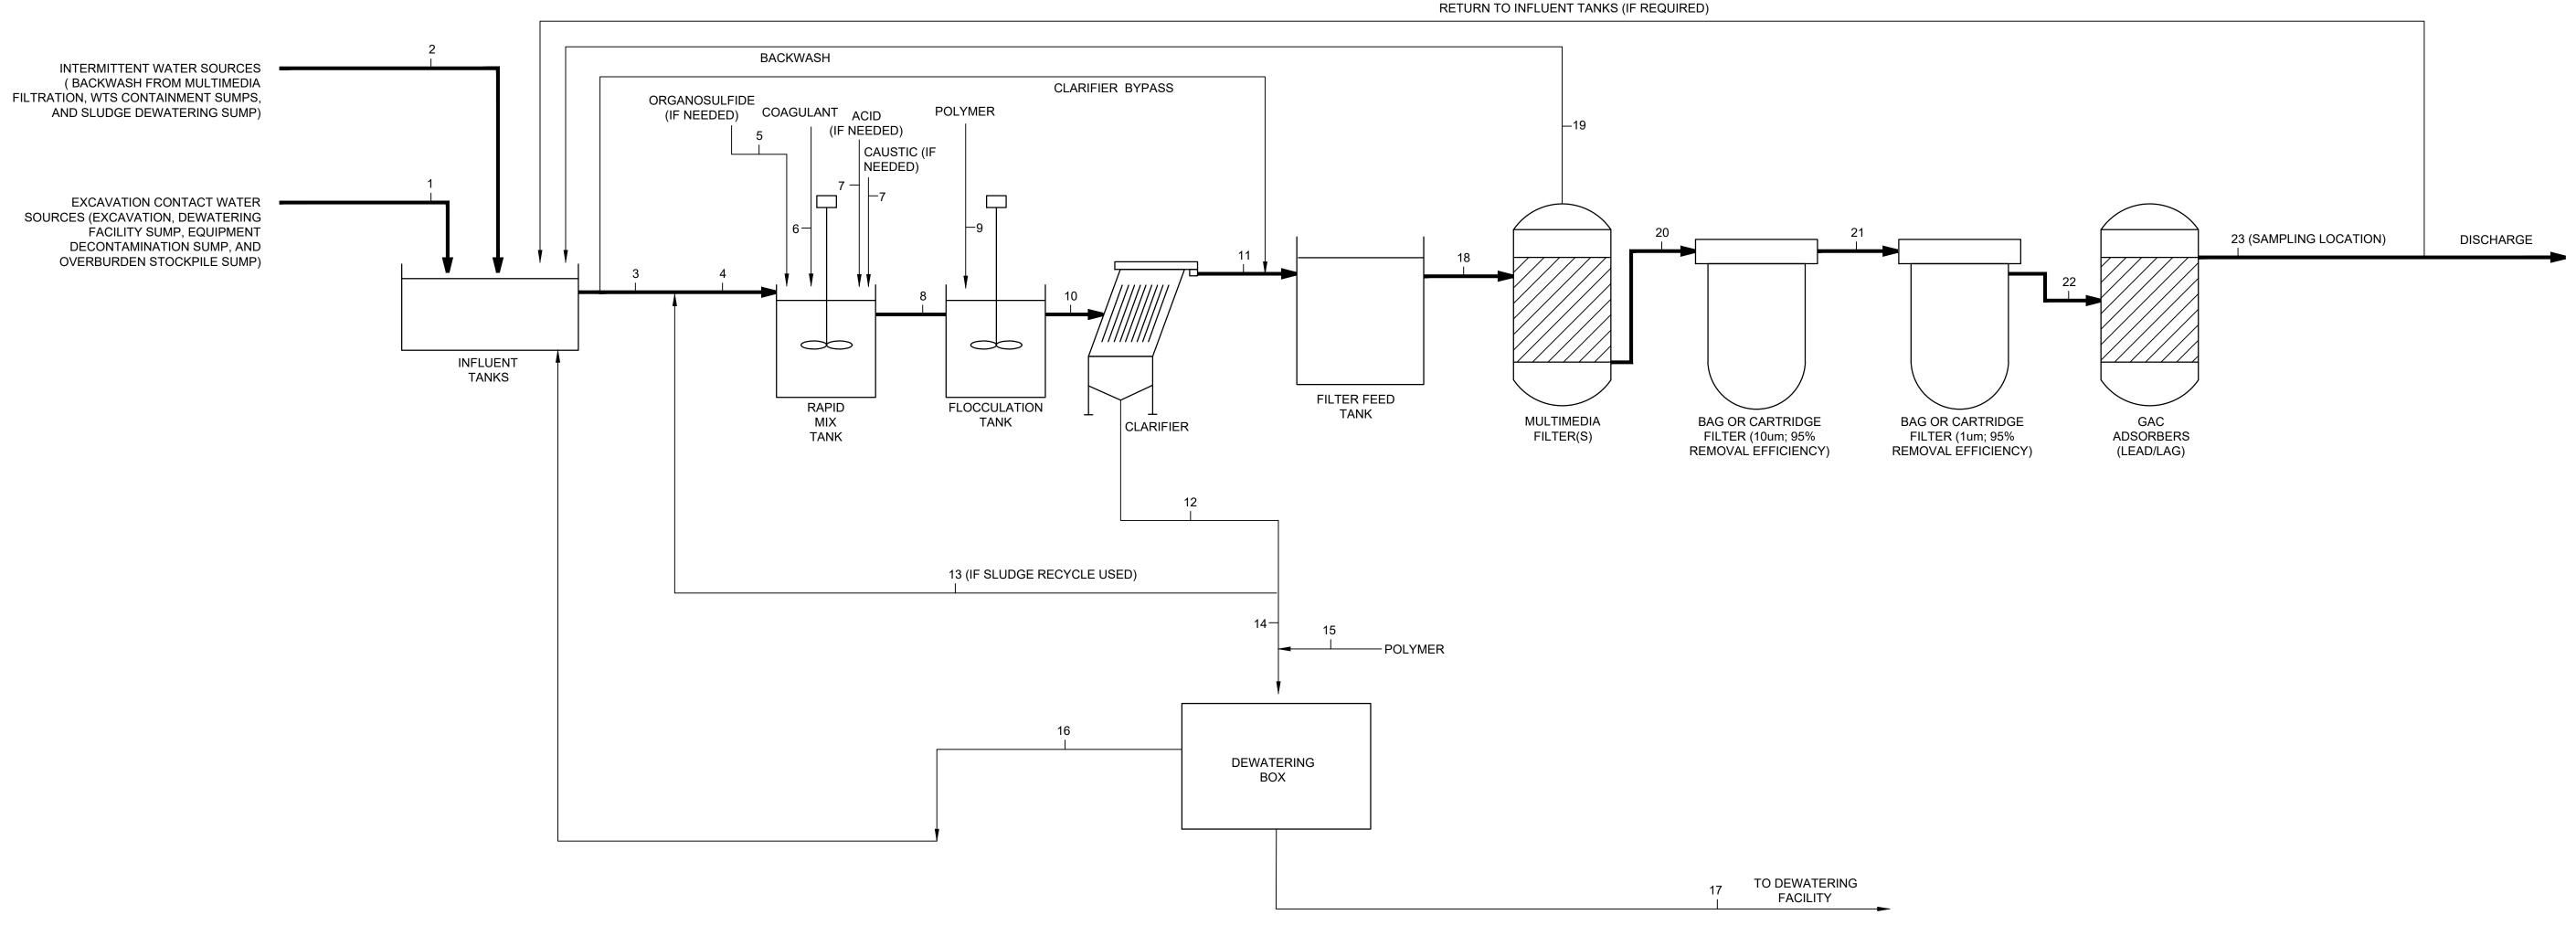
Original Size Bar is one inch on original size drawing 0 1"

Project No. **11215702**

WATER TREATMENT SYSTEM PROCESS FLOW DIAGRAM **SCHEDULES**

Sheet No.

P-00B



WATER TREATMENT PLANT PROCESS STREAMS 1

													TOOLOG OTTE											
Streams		1	2	3	4	5	6	7	8	9	10	11	12	13	14	15	16	17	18	19	20	21	22	23
	Units	Excavation Contact Water	Containmen Water Sources ²	t WTS Treatment Flowrate	Rapid Mix Tank Influent	Organosulfide Feed	Coagulant Feed	Acid or Caustic Feed	Flocculation Tank Influent	Polymer Feed	Clarifier Influent	Clarifier Effluent	Clarifier Underflow	Sludge Recycle		Dewatering Box Polymer Feed	Dewatering Box Decant to Influent Tank	Sludge to Dewatering Facility	Influent to Multimedia Filters	Backwash	Bag Filter Feed (10 um)		GAC Absorber Feed	Discharge Sampling Location
Volumetric Flow	GPM	1,000	400	300	357	0.01	0.03	TBD	357	0.01	357	282	75	0	75	0.01	57	18	282	200	282	282	282	282
Suspended Solids	PPM	4,000	v aries	4,000	4,000	-	-	TBD	4,149	-	4,174	50	19,566	19,566	19,566	-	515	80,000	50	63	5	2	2	2
Chemical Feed	PPM	-	-	-	-	50	100	TBD	-	25	-	-	-	-	-	200	-	-	-	-	-	-	-	-
Mass Flow Solids	LB/HR	2,000	80	0 622	2 715	8.93	17.86	TBD	741	4.47	746	7	734	0	734	7.3	15	720	7.1	6.4	0.7	0.3	0.3	0.3
Specific Gravity		1.0	1.	0 1.0	0 1.0	1.2	1.2	TBD	1.0	1.0	1.0	1.0	-	-	-	1.0	1.0	-	1.0	1.0	1.0	1.0	1.0	1.0
Density	LB/CF	62.4		62.4	4 62.4	74.9	74.9	TBD	62.4	62.4	62.4	62.4	-	-	-	62.4	62.4	-	62.4	62.4	62.4	62.4	62.4	62.4
NOTES:	•	•		•	•			•	•			•	•		•			•	•	•	•	•	•	

1. FOR INFORMATION PURPOSES ONLY

2. FLOW ARE INTERMITTENT AND CONCENTRATIONS MAY VARY

MAJOR PROCESS FLOW

→ MINOR PROCESS FLOW

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Client

SAN JACINTO RIVER

WASTE PITS
ect

NORTHERN IMPOUNDMENT
PRE-FINAL 90% REMEDIAL DESIGN
HARRIS COUNTY, TEXAS

4	90% EPA REVIEW	RS	NF 06/27			
No.	Issue	Drawn	Approved Dat			
Draw	n BP	Designer	KJ			
Drafti Chec	~ IVIVV	Design Check	NF			
Proje Coor	ct dinator	Date	Jun 27, 2022			
	document shall not be used for uction unless signed and sealed for uction.	Scale	N.T.S.			

Original Size

Bar is one inch on original size drawing

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Project No. **11215702**


Title

WATER TREATMENT SYSTEM

PROCESS FLOW DIAGRAM/ MASS BALANCE

Sheet No.

P-01

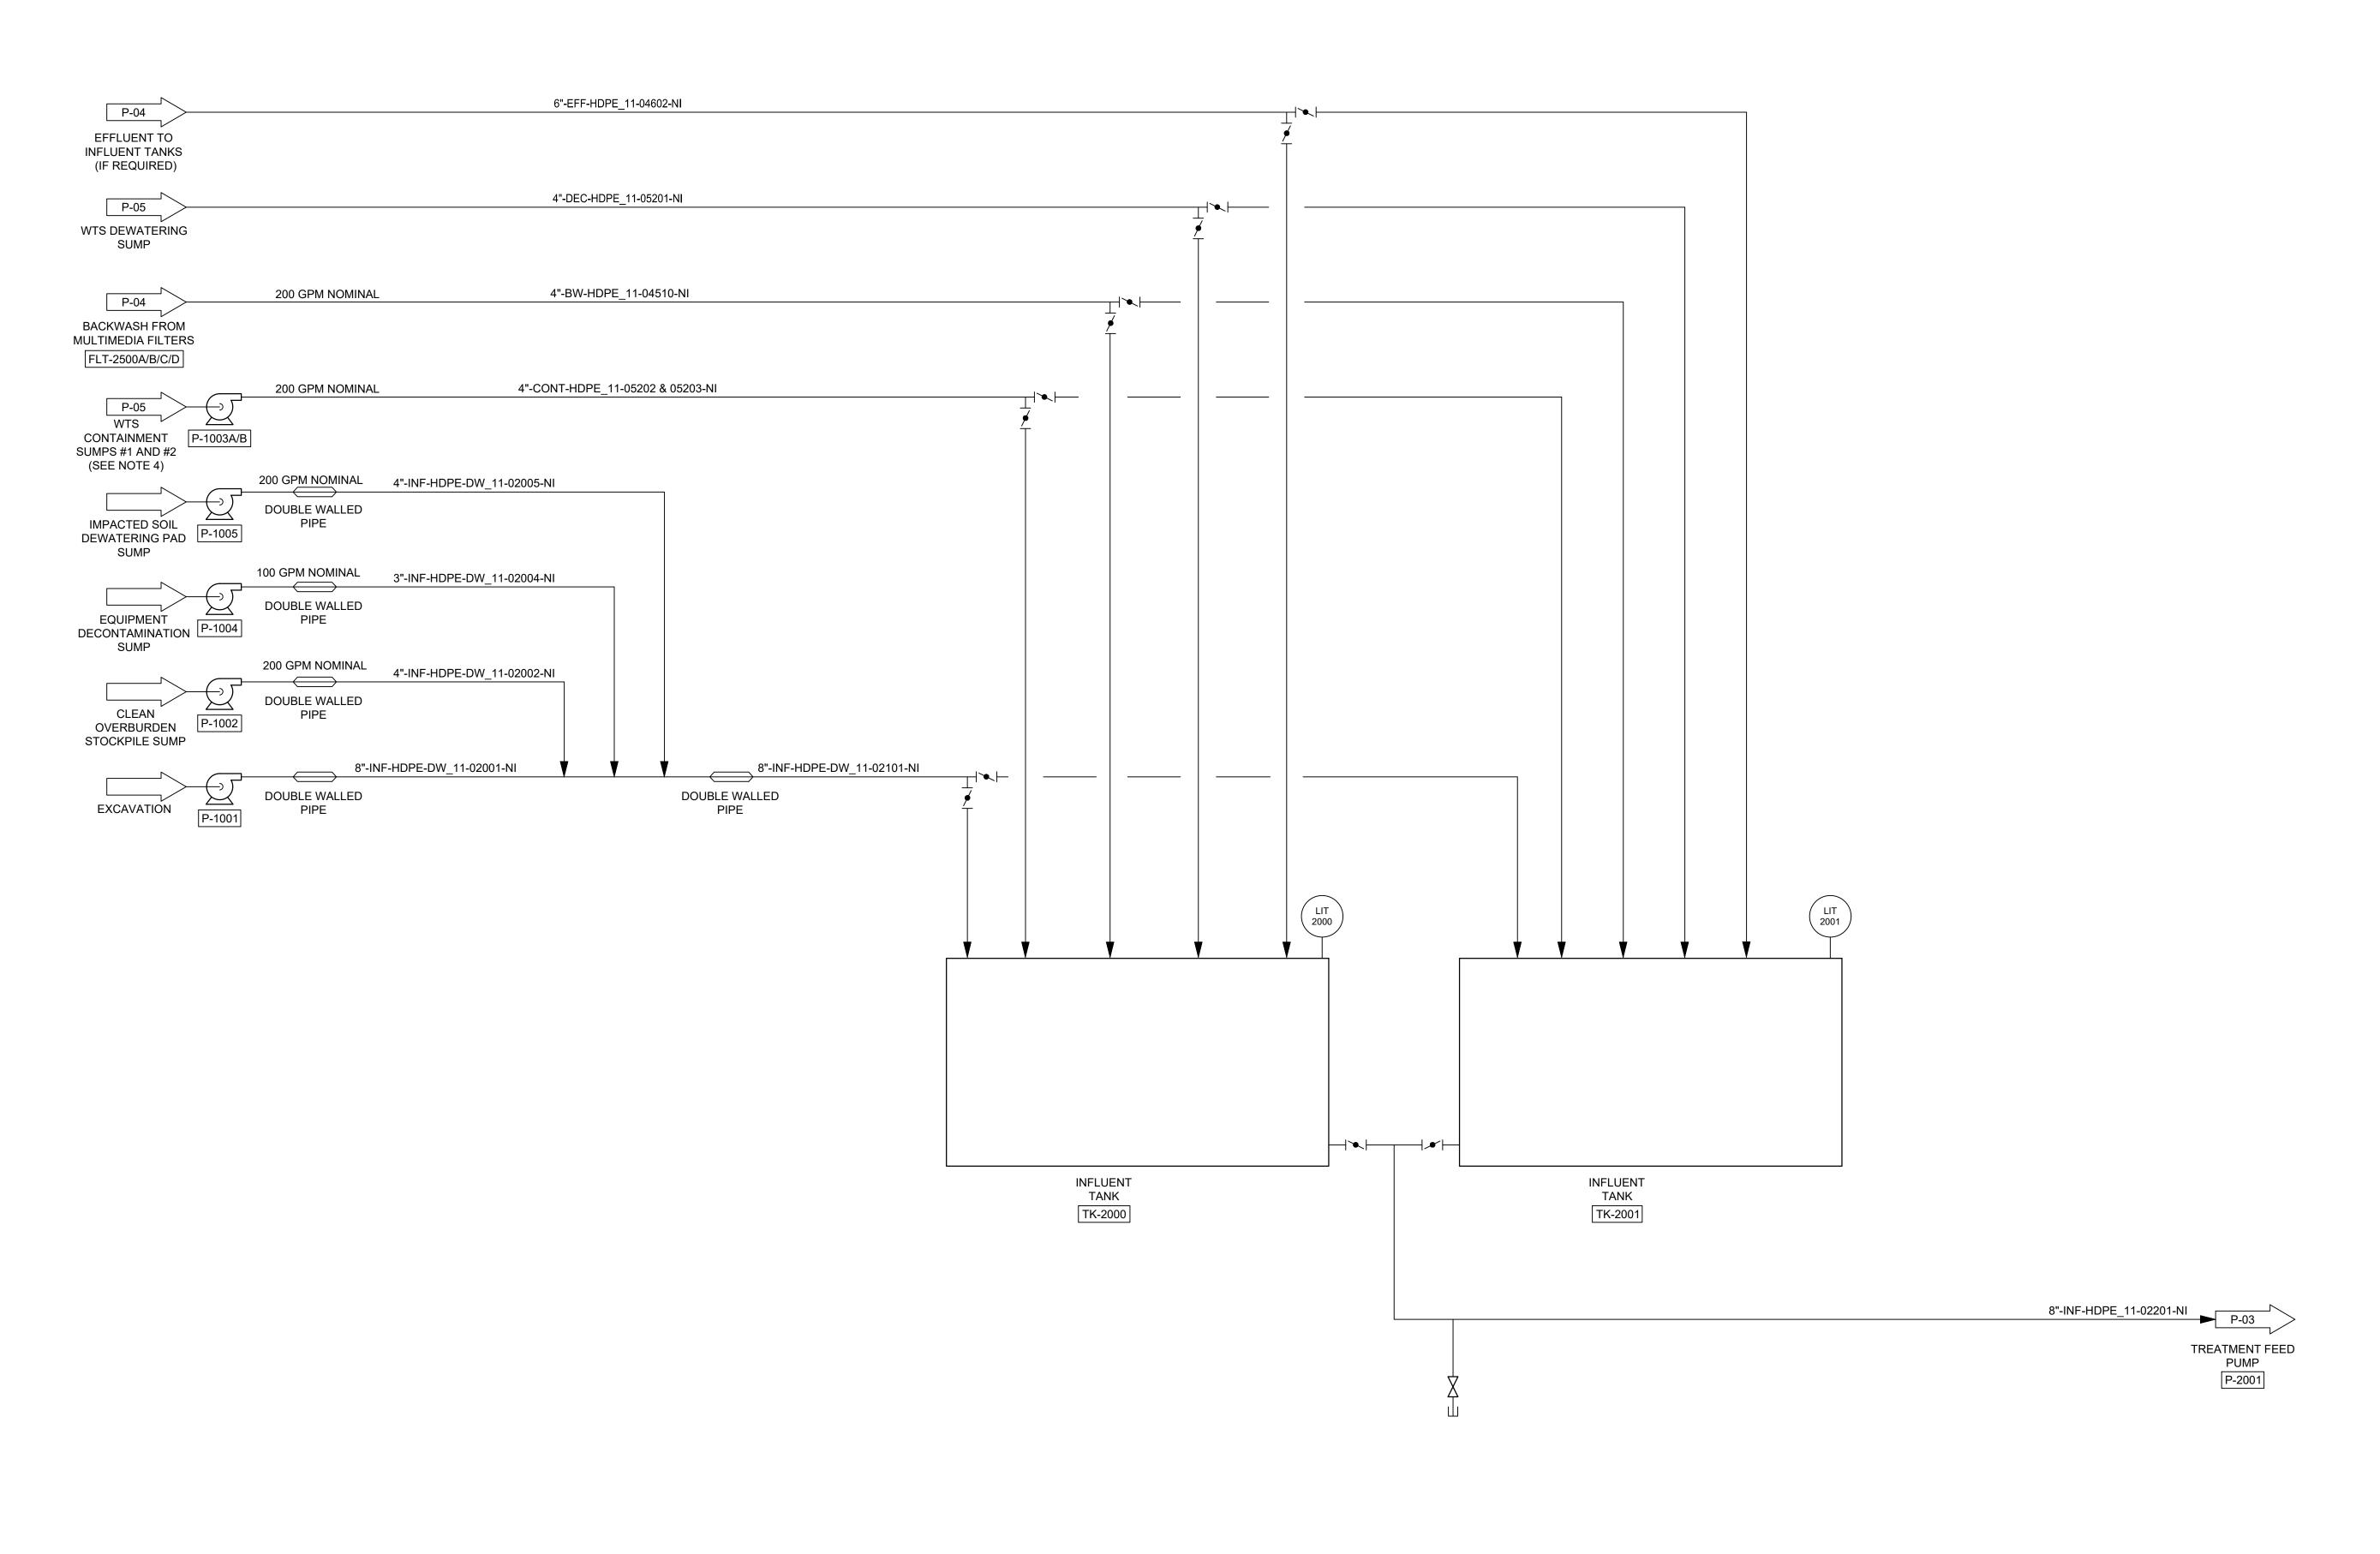

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> **SAN JACINTO RIVER WASTE PITS**

NORTHERN IMPOUNDMENT PRE-FINAL 90% REMEDIAL DESIGN HARRIS COUNTY, TEXAS

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No.	Issue	Drawn	Approved	Da		
Draw	n BP	Designer KJ				
Drafti Chec	S IVIVV	Design Check	NF			
Proje Coor	ct CM dinator	Date	Jun 27, 2022			
	document shall not be used for uction unless signed and sealed for uction.	Scale	N.T.S.			

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Project No. **11215702**

Original Size

WATER TREATMENT SYSTEM

Bar is one inch on original size drawing

(1 OF 4)

Sheet No.

P-02

Sheet - of -


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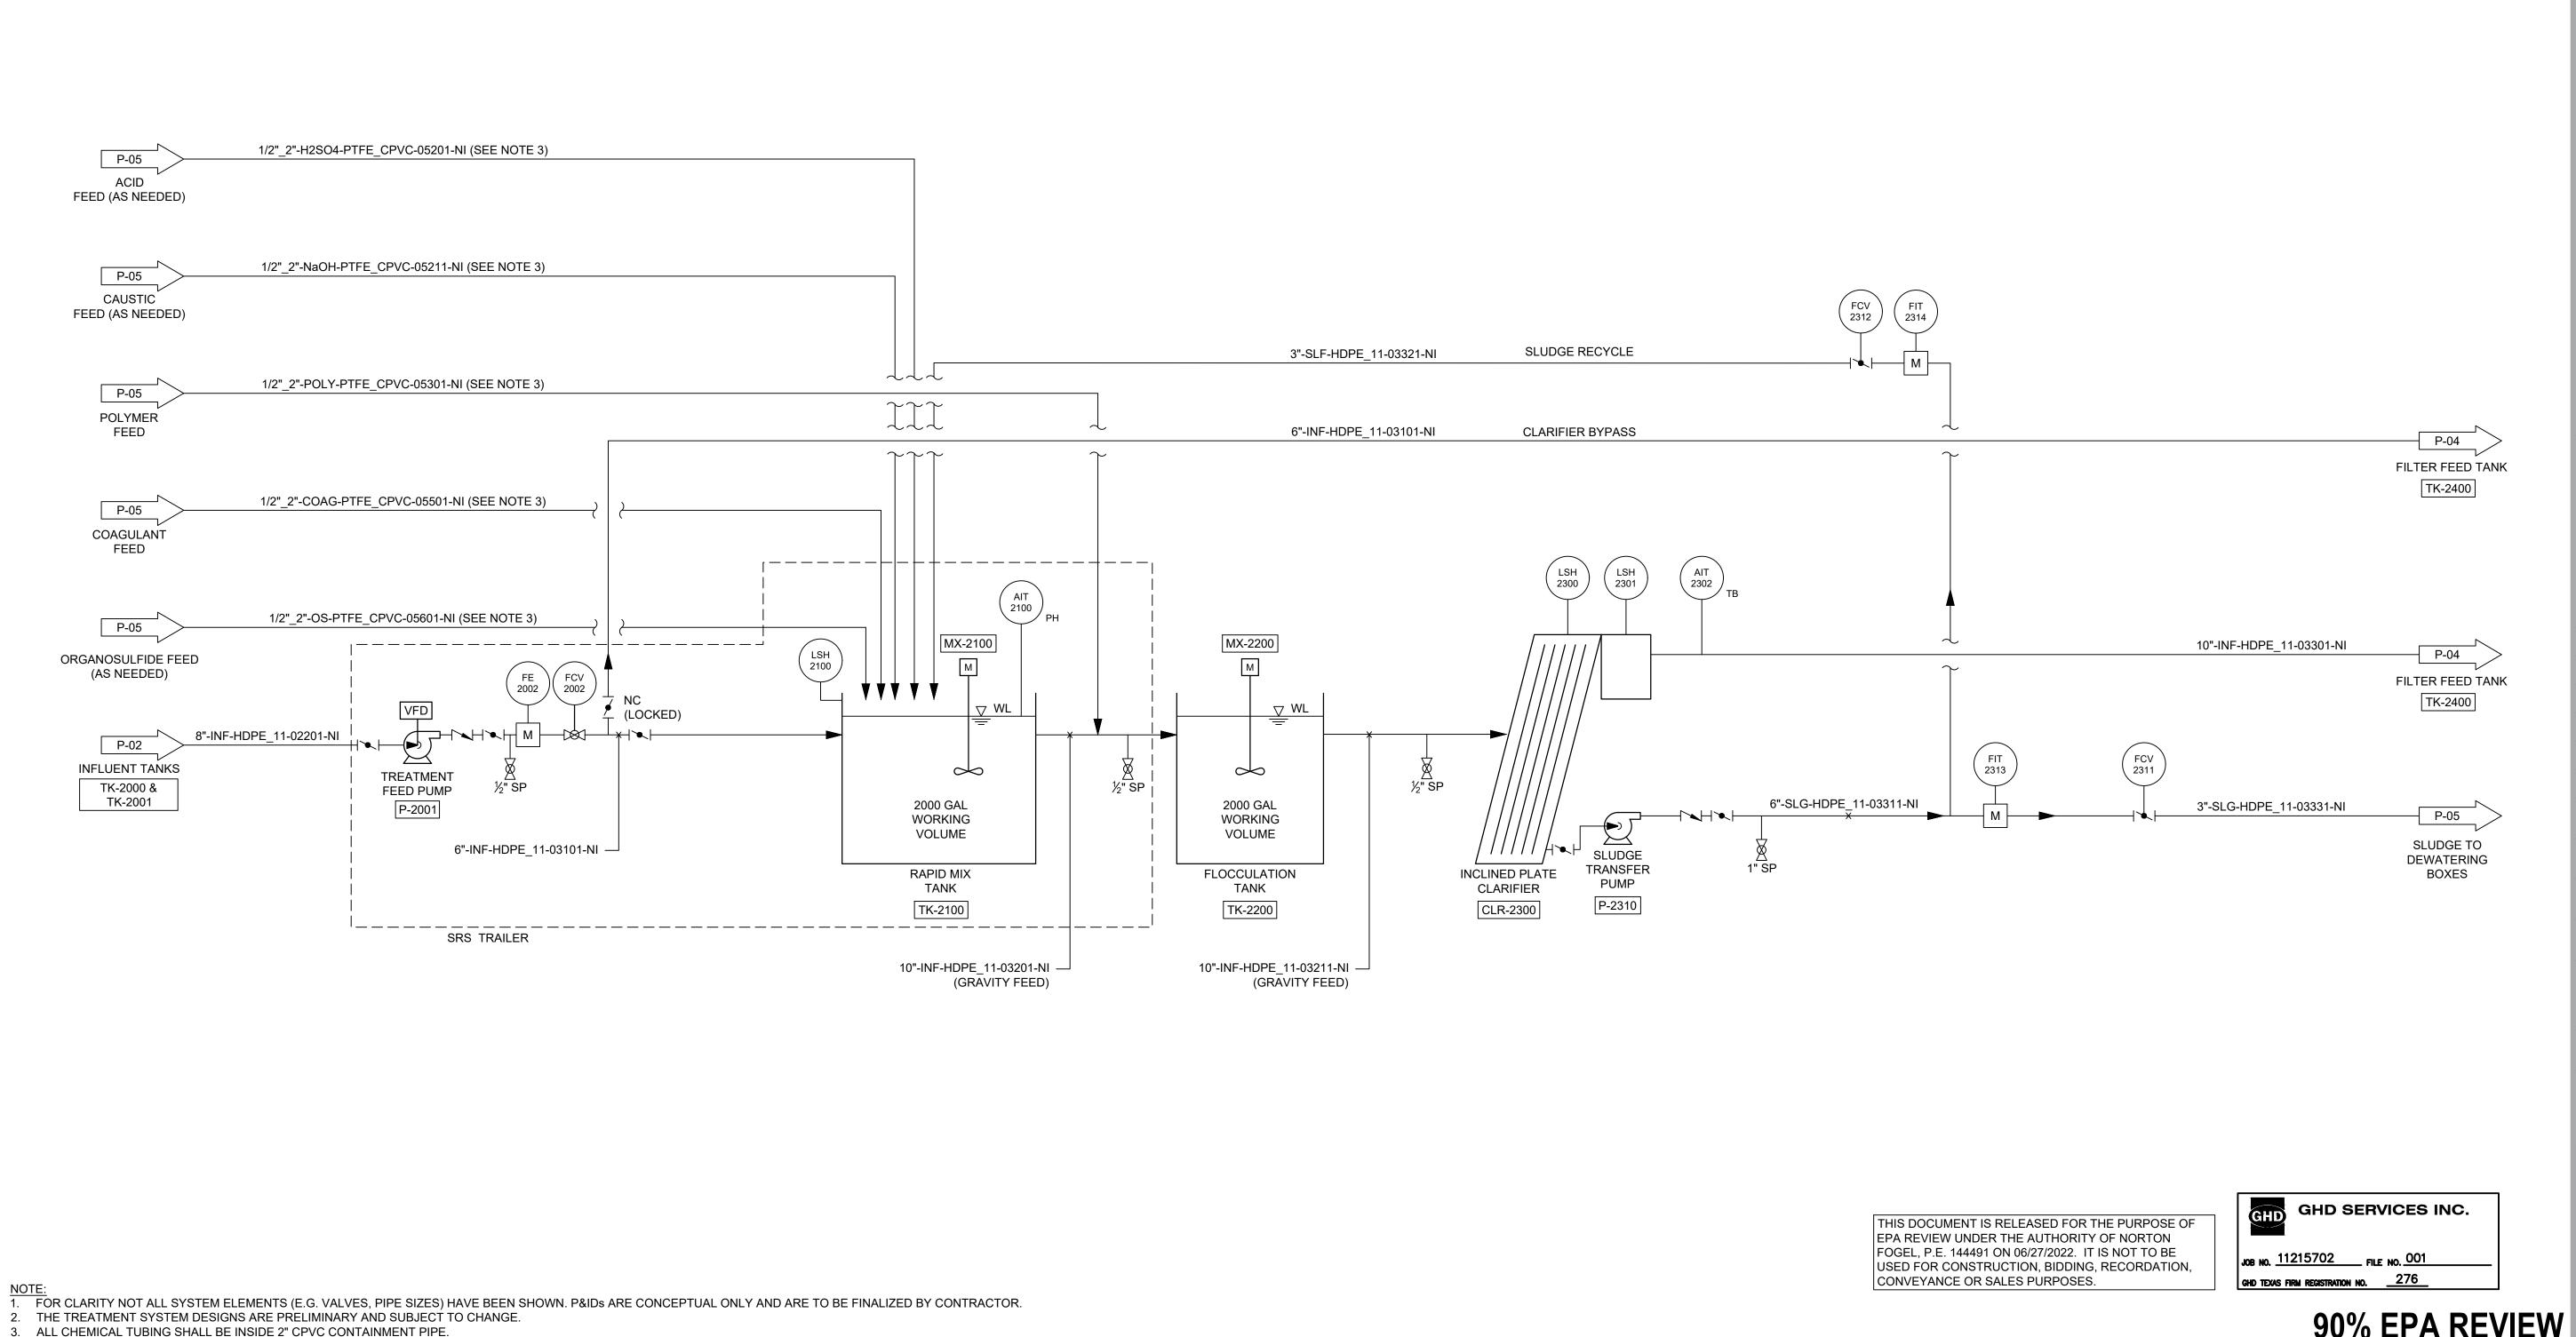
1. FOR CLARITY NOT ALL SYSTEM ELEMENTS (E.G. VALVES, PIPE SIZES) HAVE BEEN SHOWN. P&IDs ARE CONCEPTUAL ONLY AND ARE TO BE FINALIZED BY CONTRACTOR.

2. THE TREATMENT SYSTEM DESIGNS ARE PRELIMINARY AND SUBJECT TO CHANGE.

CONTRACTOR SHALL PROVIDE PROVISIONS TO DIRECT EQUIPMENT DECONTAMINATION WATER TO WATER TREATMENT SYSTEM OR TO AN ADJACENT CONTAINMENT AREA WITH PUMPING SYSTEM.

4. CONTRACTOR PROVIDE AN ADEQUATE NUMBER OF SUMPS AND PUMPS TO DEWATER CONTAINMENT AREA AFTER A LARGE RAIN EVENT TO RESUME ACTIVITIES.



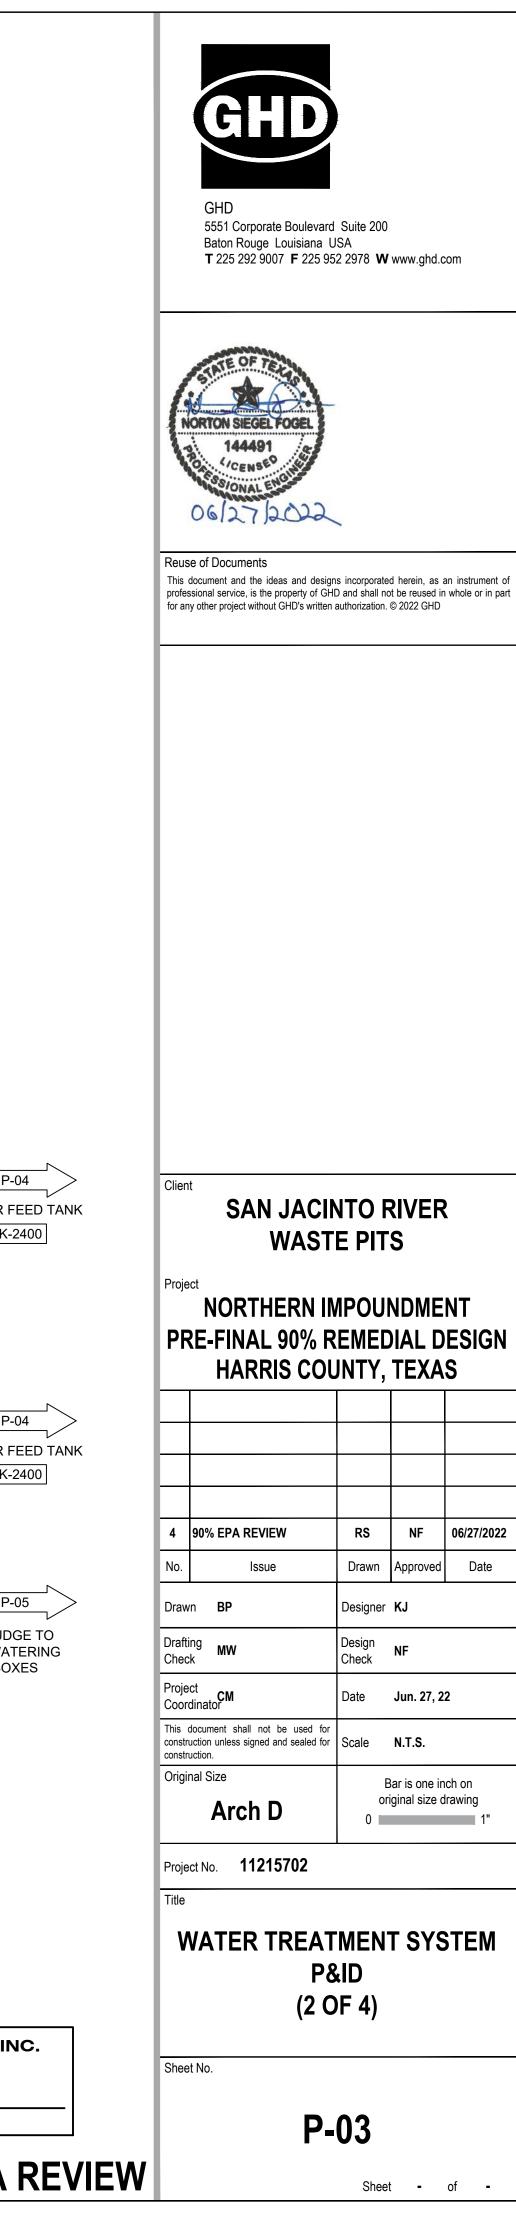

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Plot Date: 27 June 2022 - 3:57 PM

Plotted By: Matt Wolfer

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WASTE PITS

RS

Drawn

WATER TREATMENT SYSTEM

(3 OF 4)

P-04

Sheet No.

Designer **KJ**

Date **Jun. 27, 22**


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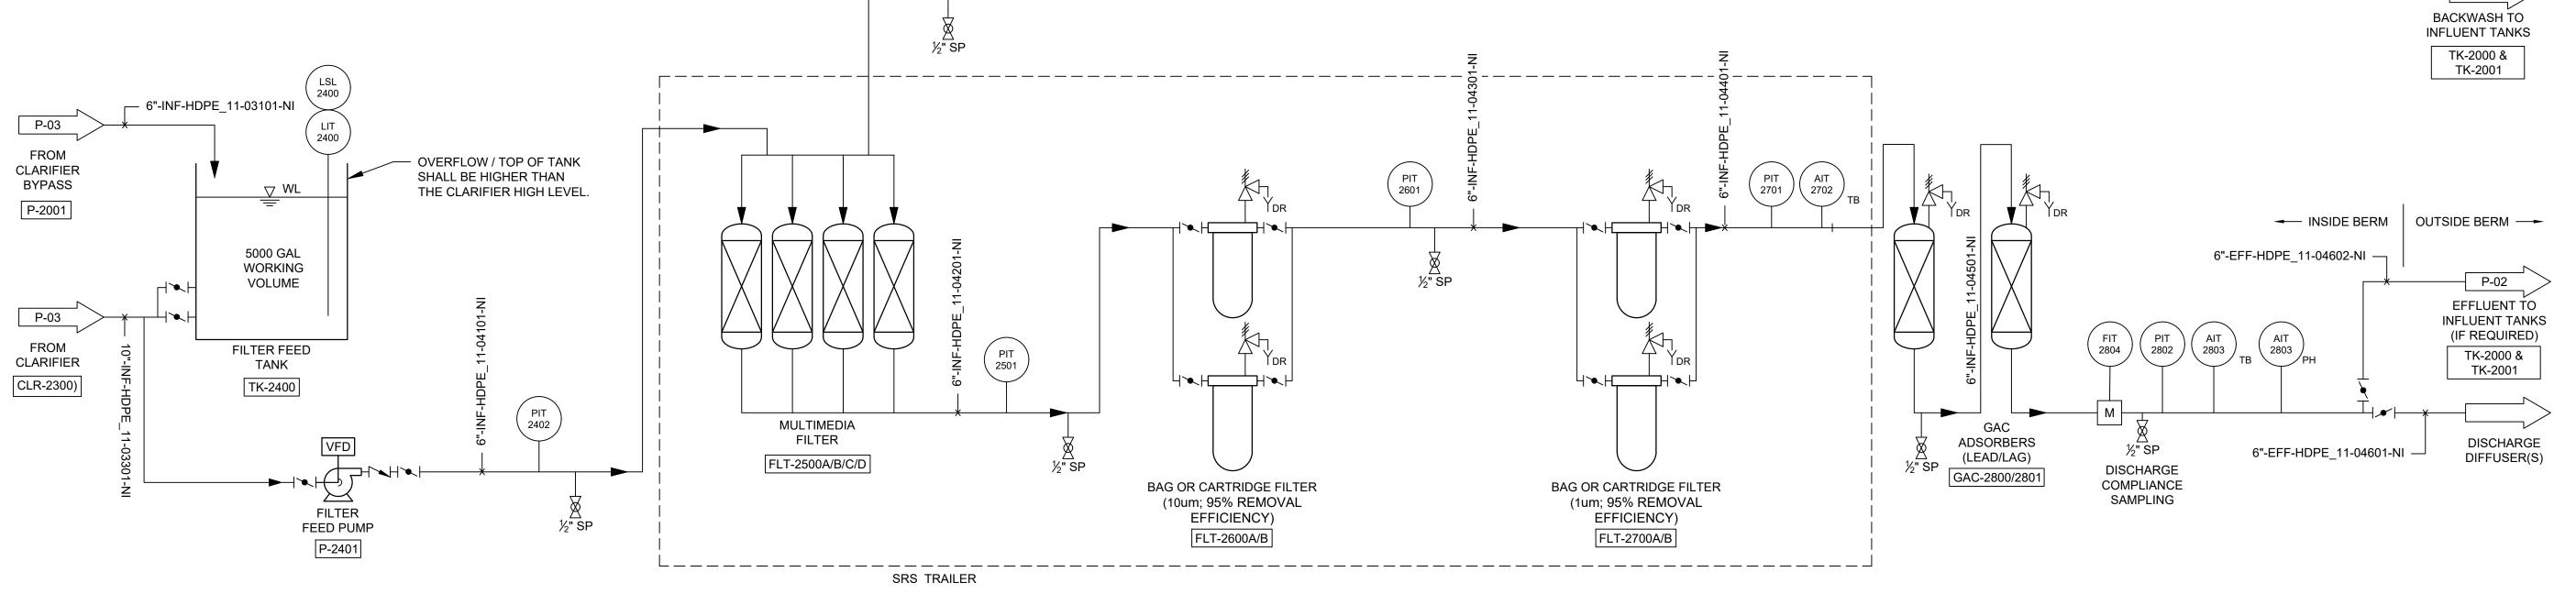
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Sheet - of -

Issue





4"-BW-HDPE_11-04510-NI
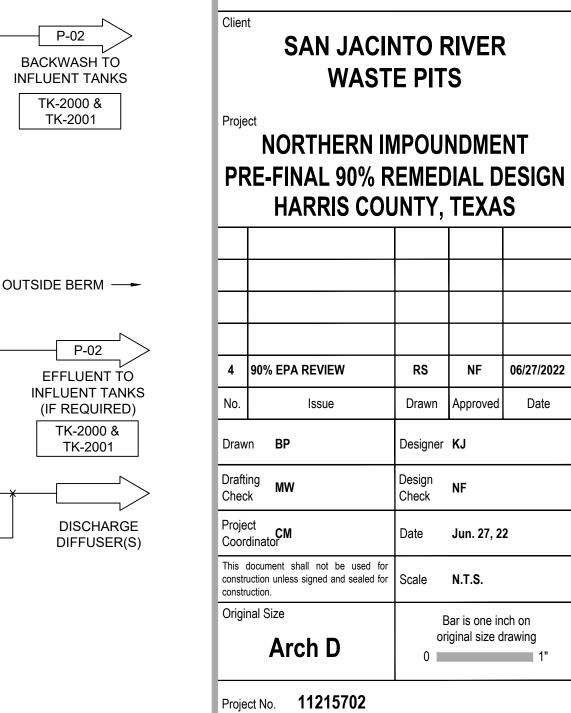
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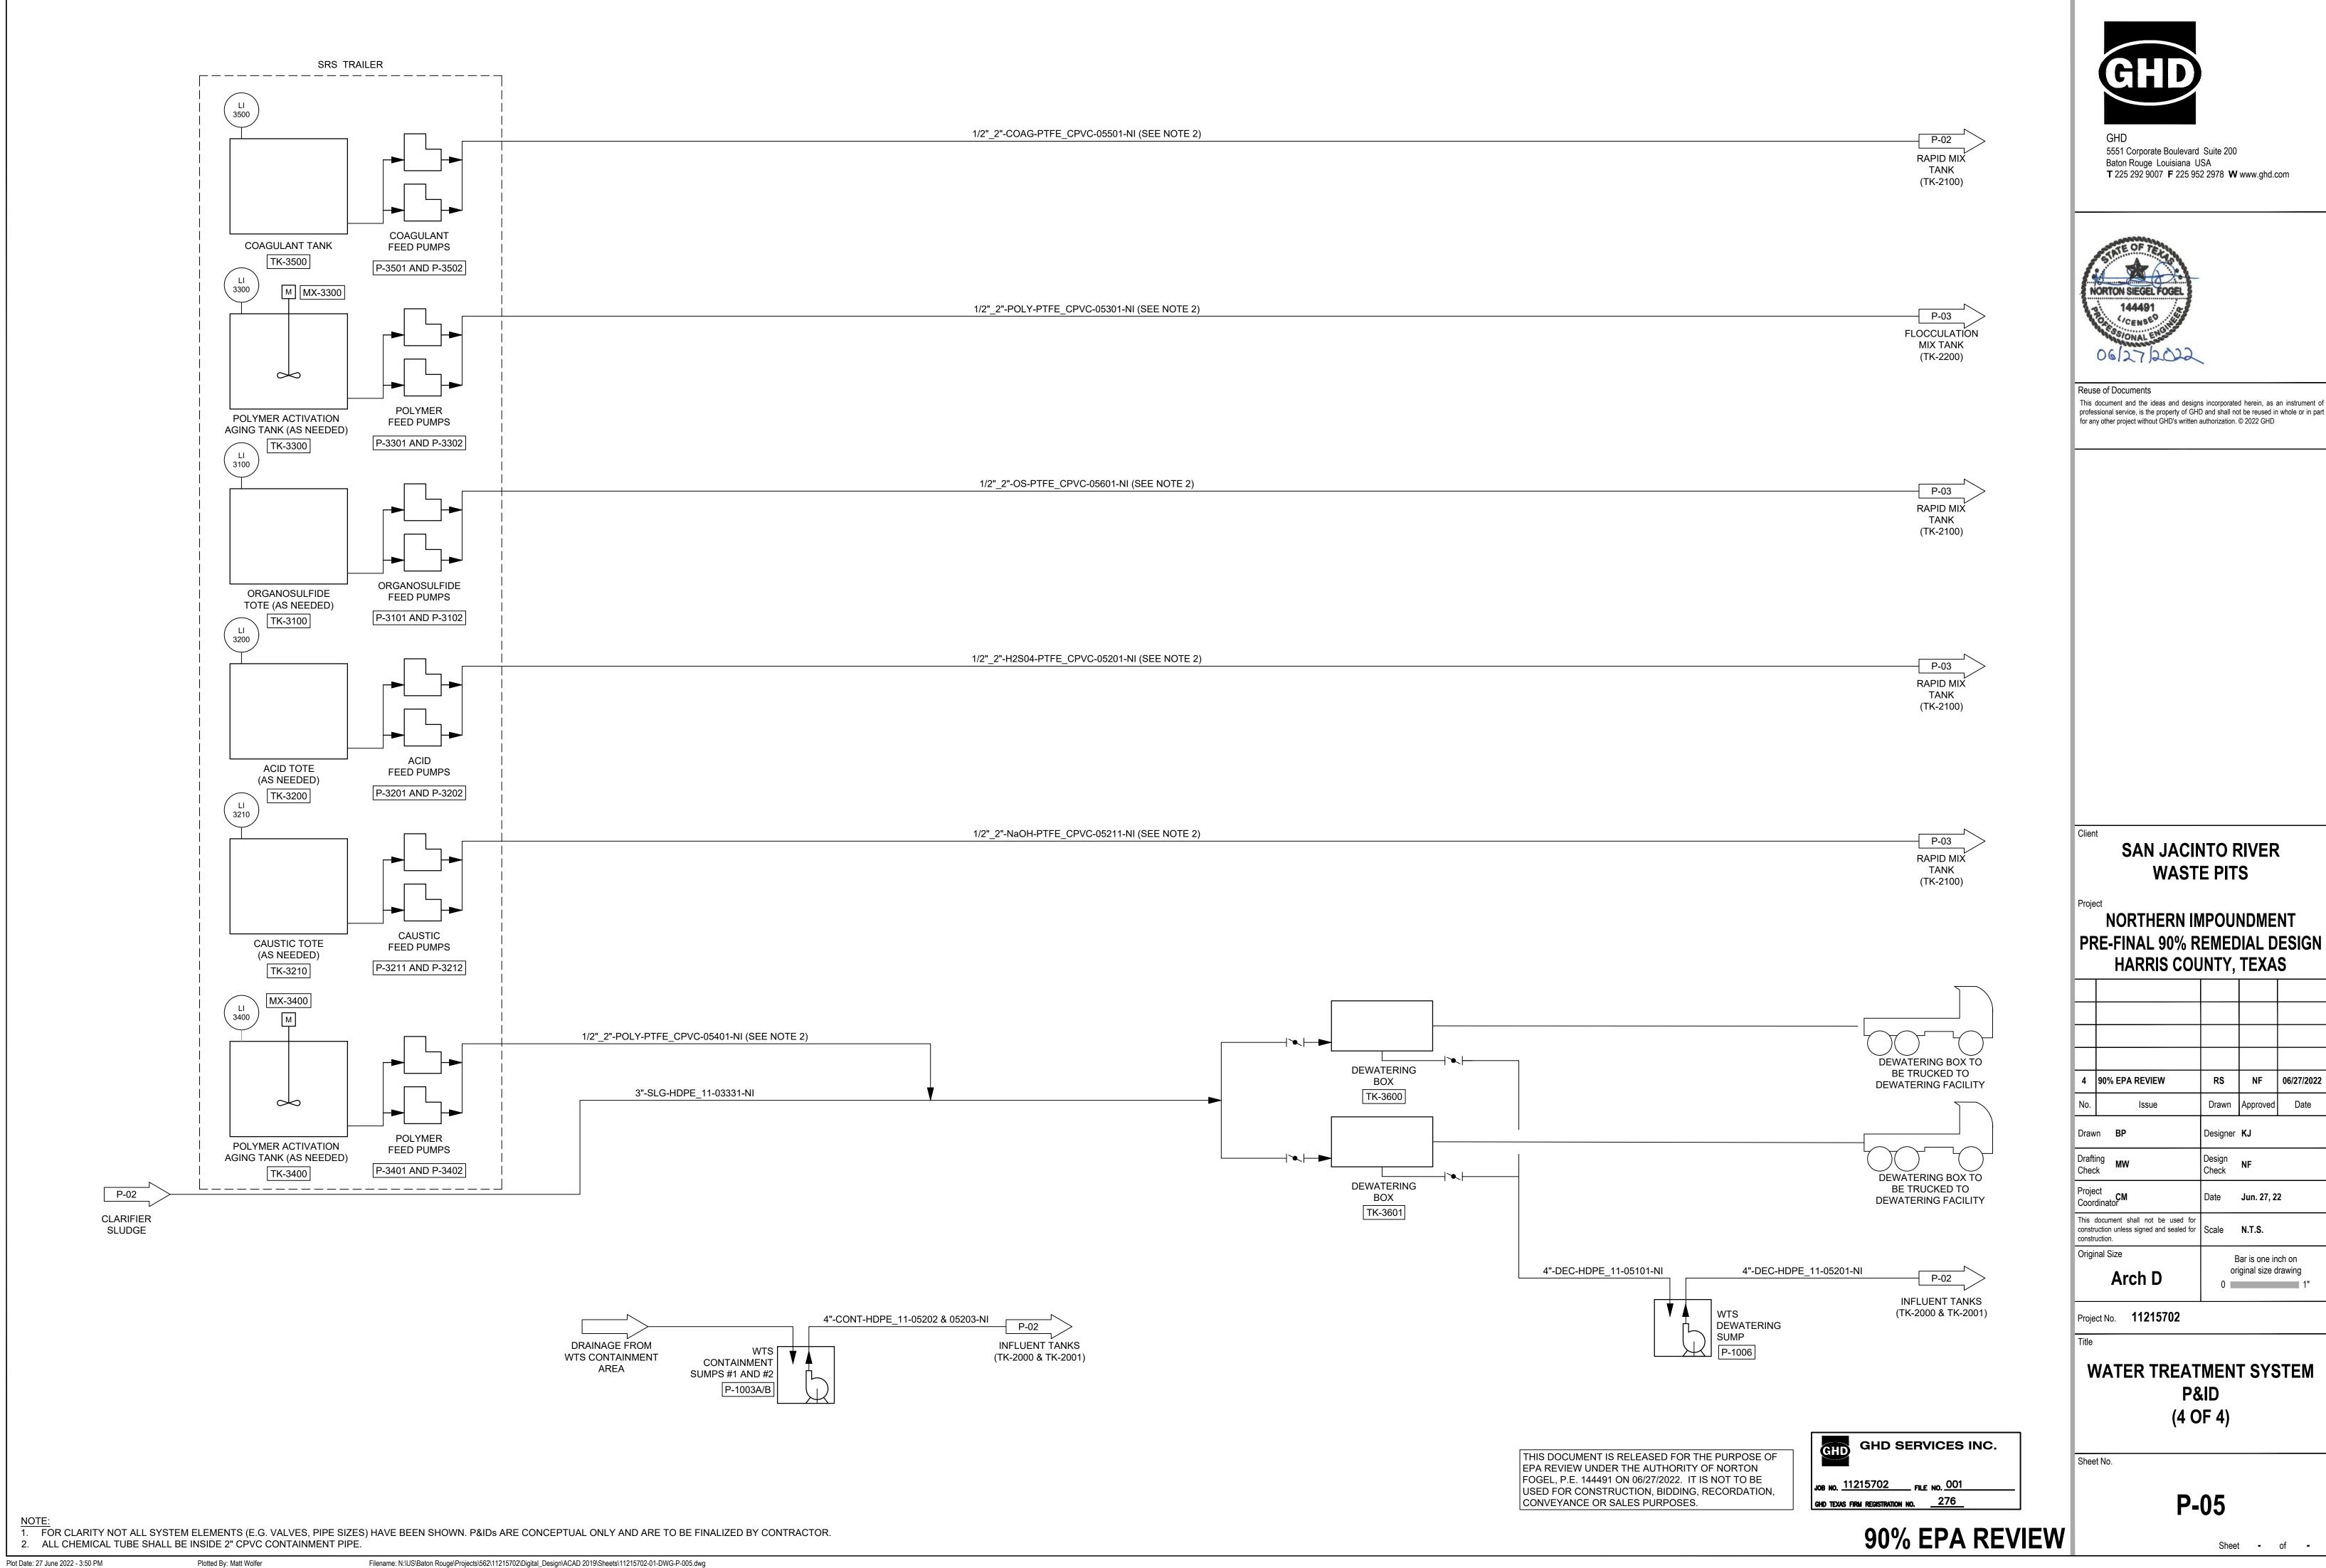
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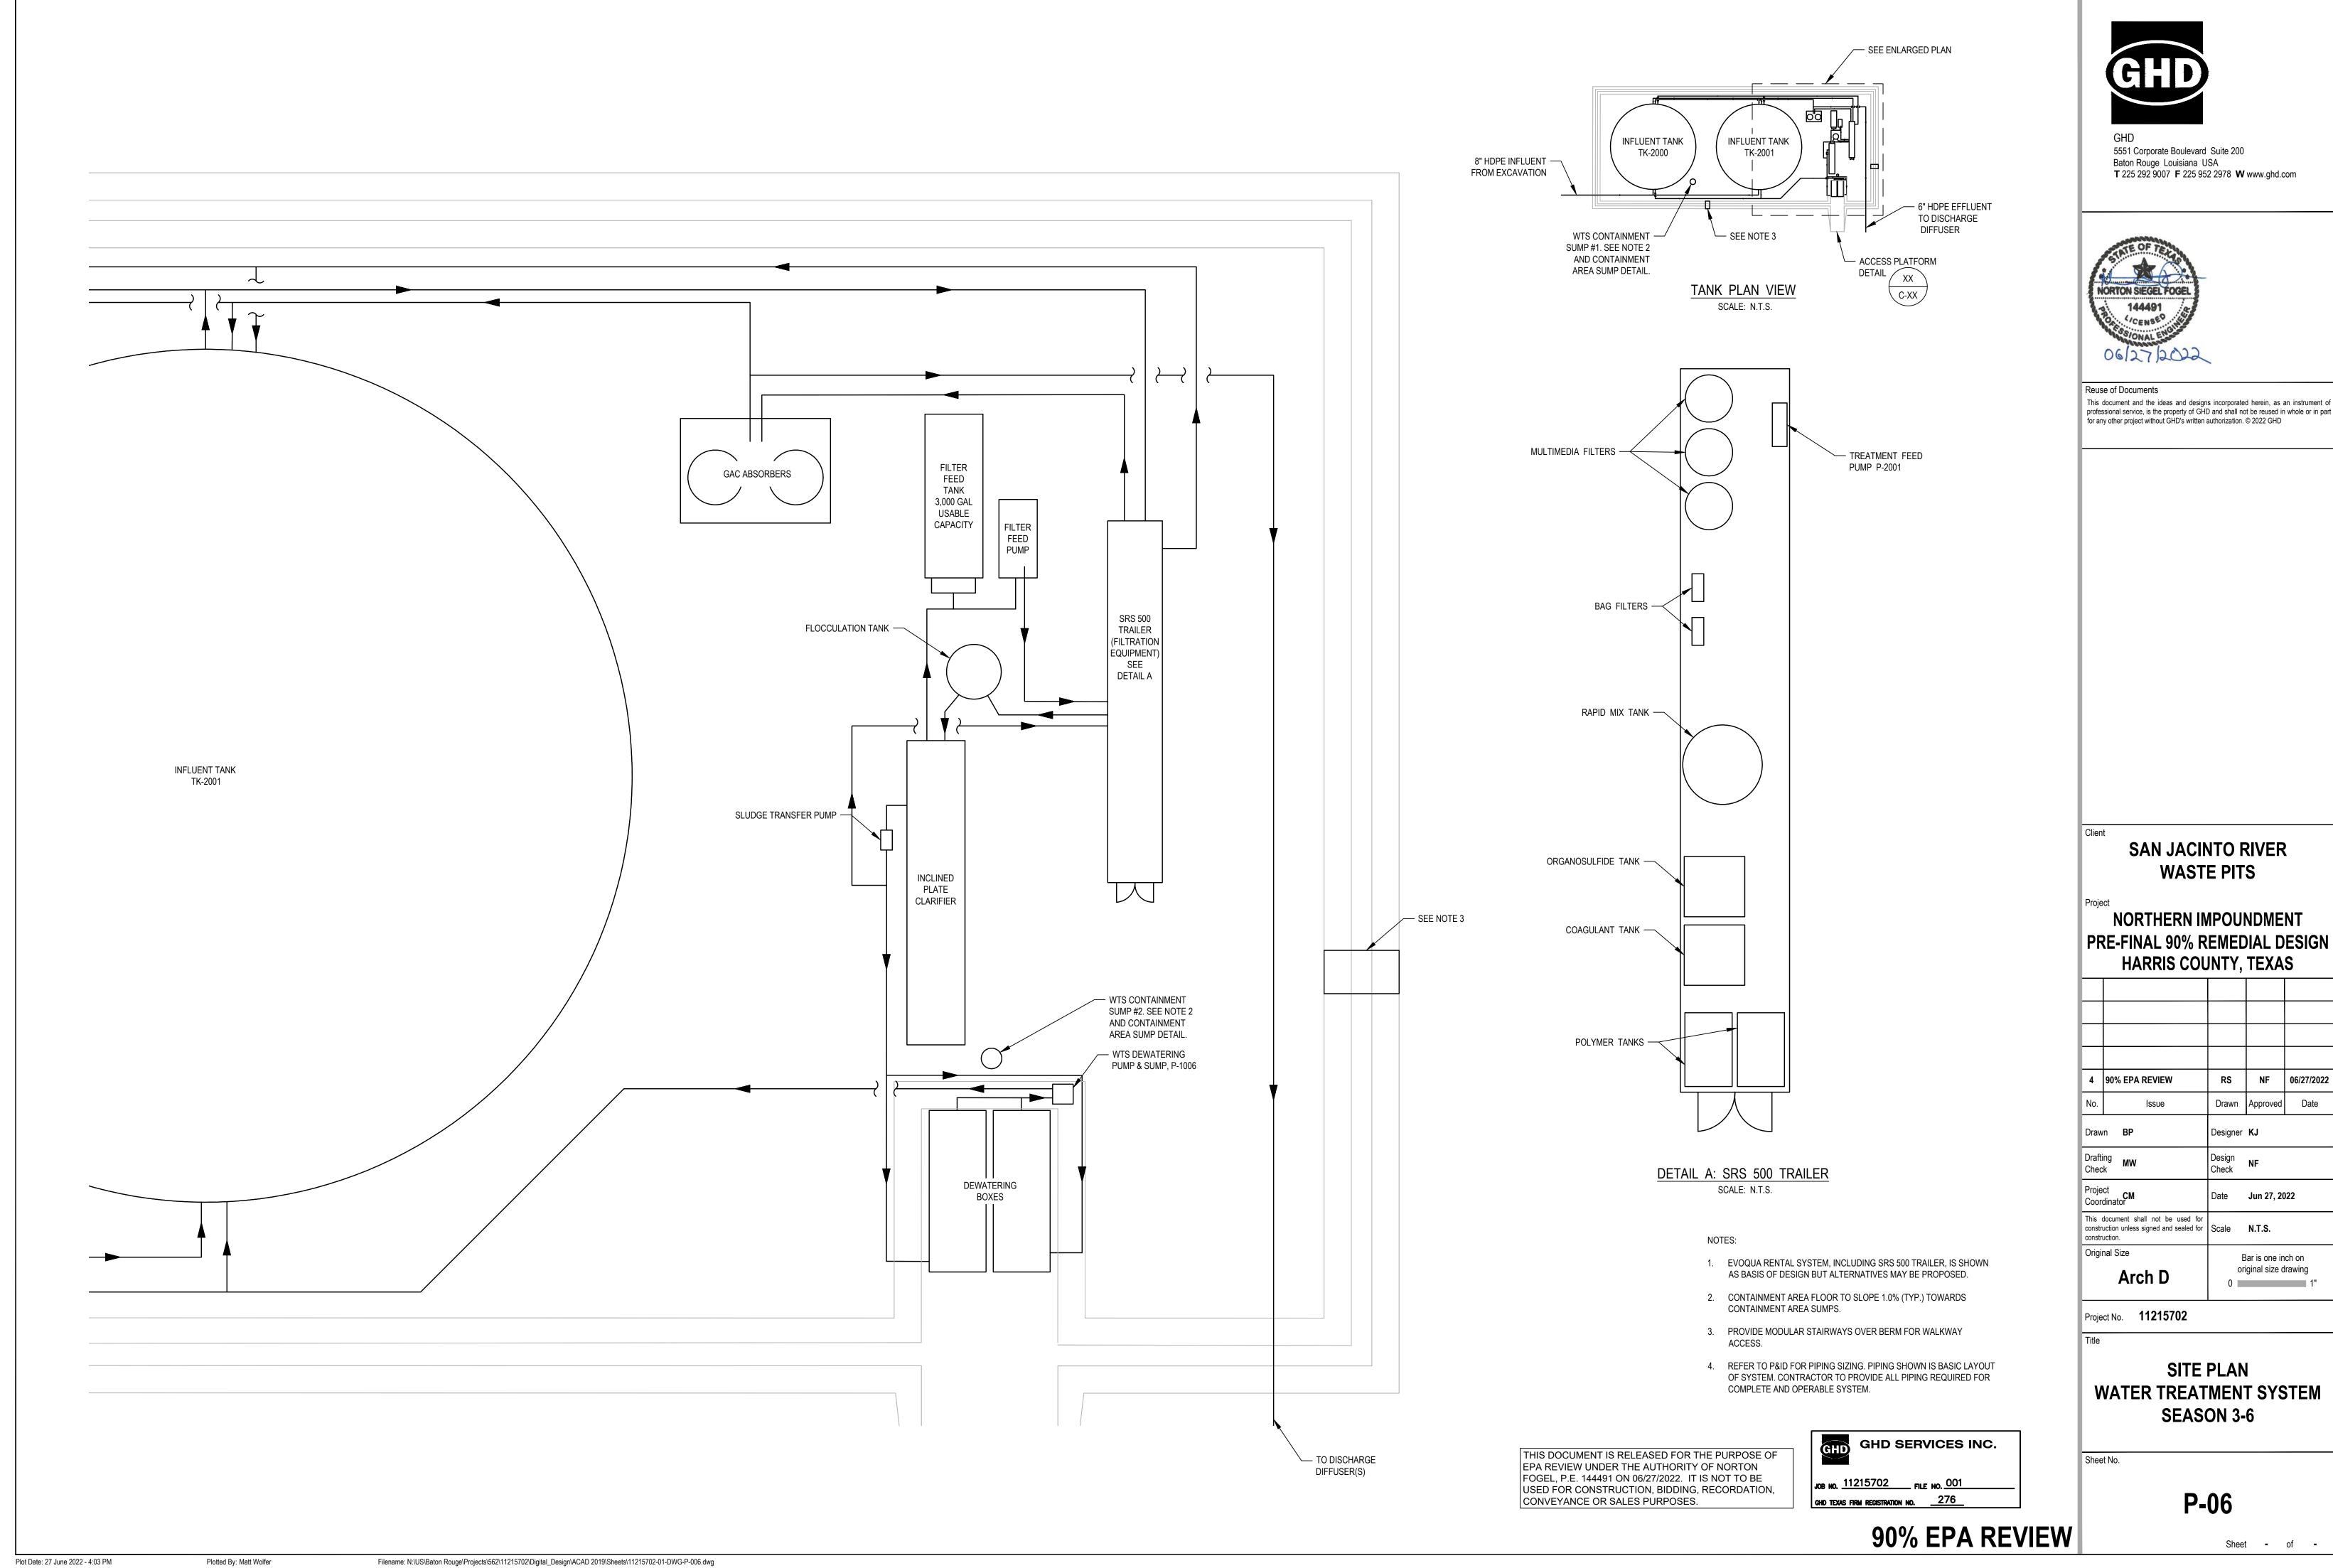
1. FOR CLARITY NOT ALL SYSTEM ELEMENTS (E.G. VALVES, PIPE SIZES) HAVE BEEN SHOWN. P&IDs ARE CONCEPTUAL ONLY AND ARE TO BE FINALIZED BY CONTRACTOR. 2. THE TREATMENT SYSTEM DESIGNS ARE PRELIMINARY AND SUBJECT TO CHANGE.

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WATER TREATMENT SYSTEM