
Appendix G


Design Drawing Package

SAN JACINTO RIVER WASTE PITS NORTHERN IMPOUNDMENT FINAL 100% REMEDIAL DESIGN HARRIS COUNTY, TEXAS

JULY 2024 11215702

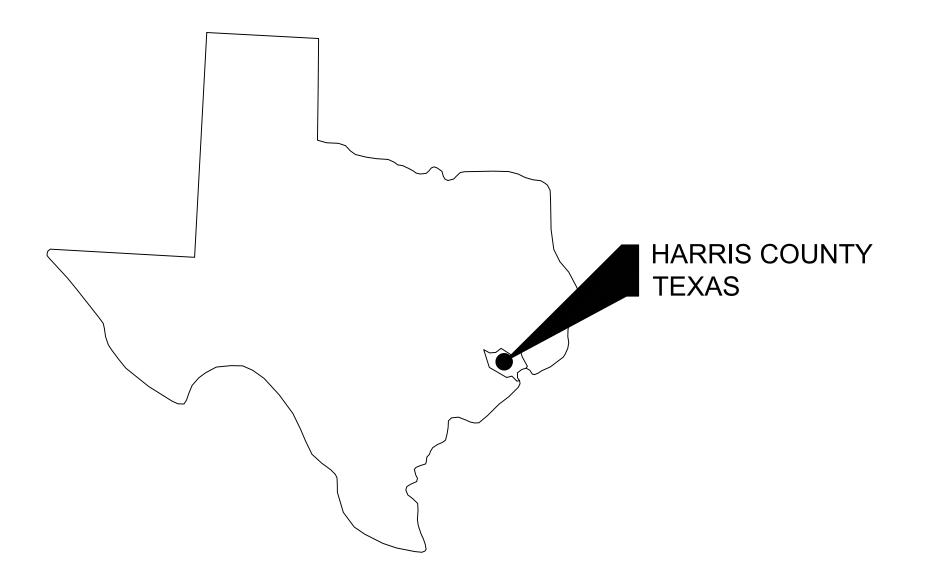


STATE OF TEXAS VICINITY MAP

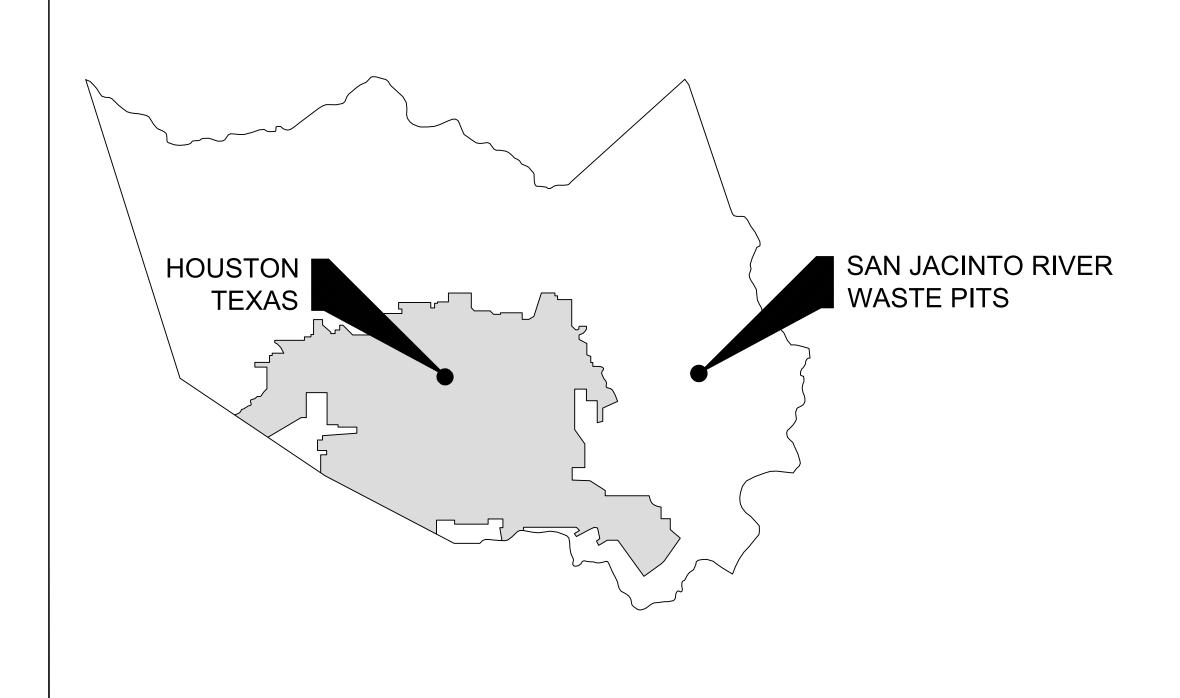

HARRIS COUNTY

VICINITY MAP

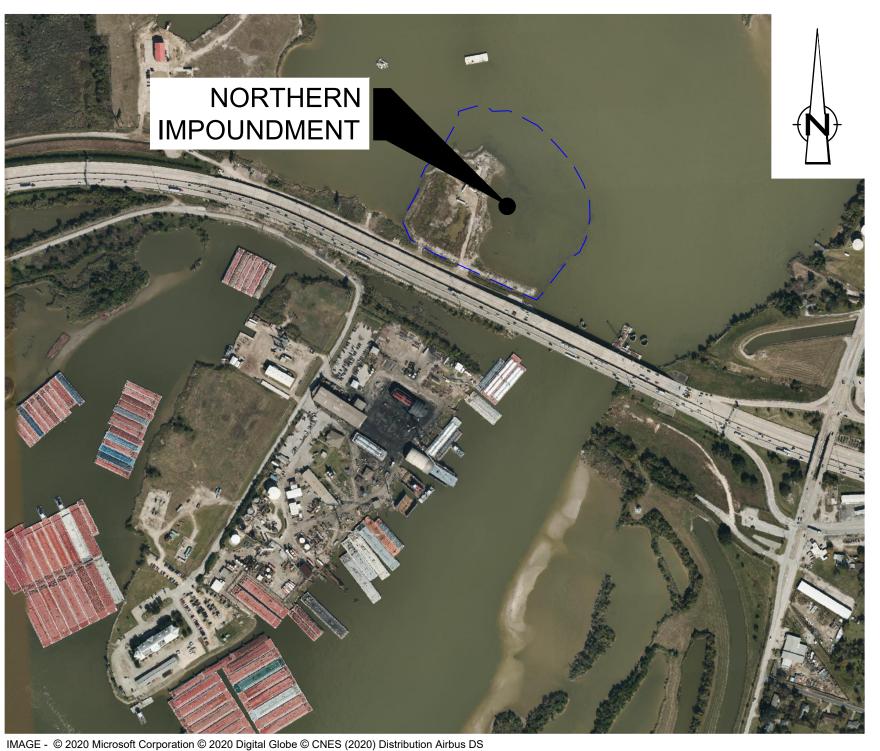

LOCATION MAP







WILLIAM A. BEAL



DRAWING NAME GENERAL SERIES **COVER SHEET**

CIVIL SERIES **EXISTING CONDITIONS** SSA AREA AND NORTHERN IMPOUNDMENT WORKS SOIL EROSION AND SEDIMENT CONTROL PLAN - OVERALL SOIL EROSION AND SEDIMENT CONTROL PLAN - SEASONAL SOIL EROSION AND SEDIMENT CONTROL DETAILS PROJECT TRAFFIC CONTROL PLAN **EXCAVATION PLAN - OVERALL EXCAVATION PLAN NORTHWES EXCAVATION PLAN NORTHEAST EXCAVATION PLAN SOUTHEAS EXCAVATION PLAN SOUTHWES EXCAVATION SECTION - 1 OF 6 EXCAVATION SECTION - 2 OF 6 EXCAVATION SECTION - 3 OF 6 EXCAVATION SECTION - 4 OF 6** EXCAVATION SECTION - 5 OF 6 EXCAVATION SECTION - 6 OF 6 TYPICAL SEASONAL EXCAVATION SEQUENCING TYPICAL EXCAVATION SEQUENCING - 1 OF 2 TYPICAL EXCAVATION SEQUENCING - 2 OF 2 **RESTORATION PLAN** TYPICAL CONSTRUCTION SEQUENCING - 1 OF 2 TYPICAL DETAILS - 1 OF 3 TYPICAL DETAILS - 2 OF 3 TYPICAL DETAILS - 3 OF 3 PILE WALL LAYOUT PLAN

TYPICAL CONSTRUCTION SEQUENCING - 2 OF 2 DOUBLE PILE WALL PLAN AND PROFILE - 1 OF 4 DOUBLE PILE WALL PLAN AND PROFILE - 2 OF 4 DOUBLE PILE WALL PLAN AND PROFILE - 3 OF 4 DOUBLE PILE WALL PLAN AND PROFILE - 4 OF 4 SOUTH WALL PLAN AND PROFILE - 1 OF 2 SOUTH WALL PLAN AND PROFILE - 2 OF 2 DOUBLE PILE WALL SECTIONS - 1 OF 7 DOUBLE PILE WALL SECTIONS - 2 OF 7 DOUBLE PILE WALL SECTIONS - 3 OF 7 DOUBLE PILE WALL SECTIONS - 4 OF 7 DOUBLE PILE WALL SECTIONS - 6 OF 7 DOUBLE PILE WALL SECTIONS - 7 OF 7 SOUTH WALL SECTIONS - 1 OF 3 SOUTH WALL SECTIONS - 2 OF 3 SOUTH WALL SECTIONS - 3 OF 3 DREDGING NORTHWEST CORNER WORKS PLAN DREDGING NORTHWEST CORNER DREDGING CONTROLS DREDGING NORTHWEST CORNER DRY EXCAVATION DREDGING NORTHWEST CORNER WET EXCAVATION DREDGING NORTHWEST CORNER SECTIONS 1 OF 2 DREDGING NORTHWEST CORNER SECTIONS 2 OF 2 DREDGING NORTHWEST CORNER SEQUENCING 1 OF 3 C-52 C-53 C-54 C-55

STRUCTURAL SERIES

STRUCTURAL NOTES S-02 STRUCTURAL LAYOUT PLAN STRUCTURAL SECTIONS STRUCTURAL DETAILS 1 OF 2 S-05 S-06 STRUCTURAL DETAILS 2 OF 2 FRP BARRIER WALL


WATER TREATMENT SYSTEM PROCESS FLOW DIAGRAM SYMBOLS WATER TREATMENT SYSTEM PROCESS FLOW DIAGRAM SCHEDULES WATER TREATMENT SYSTEM PROCESS FLOW DIAGRAM (BULK WATER) P-03 WATER TREATMENT SYSTEM P&ID (BULK WATER) (1 OF 3) WATER TREATMENT SYSTEM P&ID (BULK WATER) (2 OF 3 WATER TREATMENT SYSTEM P&ID (BULK WATER) (3 OF 3) WATER TREATMENT SYSTEM P&ID (CONTACT WATER) (2 OF 4) WATER TREATMENT SYSTEM P&ID (CONTACT WATER) (3 OF 4 WATER TREATMENT SYSTEM P&ID (CONTACT WATER) (4 OF 4 WATER TREATMENT SYSTEM SITE PLAN (BULK WATER) WATER TREATMENT SYSTEM EQUIPMENT LAYOUT (BULK WATER) WATER TREATMENT SYSTEM SITE PLAN (CONTACT WATER) WATER TREATMENT SYSTEM EQUIPMENT LAYOUT (CONTACT WATER) (1 OF 2) WATER TREATMENT SYSTEM EQUIPMENT LAYOUT (CONTACT WATER) (2 OF 2) P-16 HELICAL PILE DETAILS MECHANICAL SCHEDULE

DREDGING NORTHWEST CORNER SEQUENCING 3 OF 3

DREDGING NORTHWEST CORNER FINAL GRADE DREDGING NORTHWEST CORNER DREDGING DETAILS

RESTORATION SECTIONS 1 OF 2 RESTORATION SECTIONS 2 OF 2

> THIS DOCUMENT IS RELEASED FOR THE PURPOSE OF EPA REVIEW UNDER THE AUTHORITY OF CLARENCE R. HOEKSTRA, P.E. 147937, WILLIAM ALLEN BEAL, P.E. 137828, SATISH CHILKA, P.E. 145120, AND NORTON FOGEL, P.E. 144491 ON 07/17/2024. IT IS NOT TO BE USED FOR CONSTRUCTION PURPOSES, BIDDING, RECORDATION, CONVEYANCE OR SALES PURPOSES

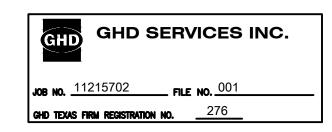

100% EPA SUBMITTAL



2237 S Acadian Thruway Suite 701 Baton Rouge Louisiana 70808 USA **T** 225 292 9007

Reuse of Documents

This document and the ideas and designs incorporated herein, as an instrument of professional service, is the property of GHD and shall not be reused in whole or in part for any other project without GHD's written authorization. © 2024 GHD

> **SAN JACINTO RIVER WASTE PITS**

NORTHERN IMPOUNDMENT FINAL 100% REMEDIAL DESIGN HARRIS COUNTY, TEXAS

6	100% EPA SUBMITTAL	MW	CRH	07/17/202
No.	Issue	Drawn	Approved	Date
Draw	n MW	Designer	RH	
Drafti Chec	° .I(.	Design Check	LL	
Proje Coor	ct dinator CM	Date	Jul 16, 20	24
This document shall not be used for				

Original Size Bar is one inch on original size drawing Arch D


Project No. **11215702**

construction unless signed and sealed for Scale N.T.S.

COVER SHEET

Sheet No.

G-01

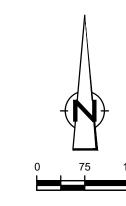



2237 S Acadian Thruway Suite 701 Baton Rouge Louisiana 70808 USA **T** 225 292 9007



Reuse of Documents

This document and the ideas and designs incorporated herein, as an instrument of professional service, is the property of GHD and shall not be reused in whole or in part for any other project without GHD's written authorization. © 2024 GHD

— – – — TxDOT RIGHT OF WAY — — TCRA CAP PERIMETER FENCELINE SHORELINE
TOP OF BANK ---- TOE OF SLOPE

OVERHEAD ELECTRICAL ——O——O——— GUARDRAIL ----- \\ ----- PIPELINE

> MONITORING WELL POWER POLE LIGHT POLE ASPHALT

■ SJSB002 BORING LOCATION

CONCRETE GRAVEL

SAN JACINTO RIVER WASTE PITS

NORTHERN IMPOUNDMENT FINAL 100% REMEDIAL DESIGN HARRIS COUNTY, TEXAS

5	100% EPA SUBMITTAL	MW	CRH	07/17
No.	Issue	Drawn	Approved	Da
Draw	n MW	Designer	RH	
Drafti Chec	· .l(.	Design Check	LL	
Proje Coor	ct dinator	Date	Jul 16, 20	24
	document shall not be used for uction unless signed and sealed for uction.	Scale	1" = 150'	

Bar is one inch on original size drawing Arch D

Project No. **11215702**


OVERALL PLAN

Sheet No.


C-01

100% EPA SUBMITTAL

GHD SERVICES INC.

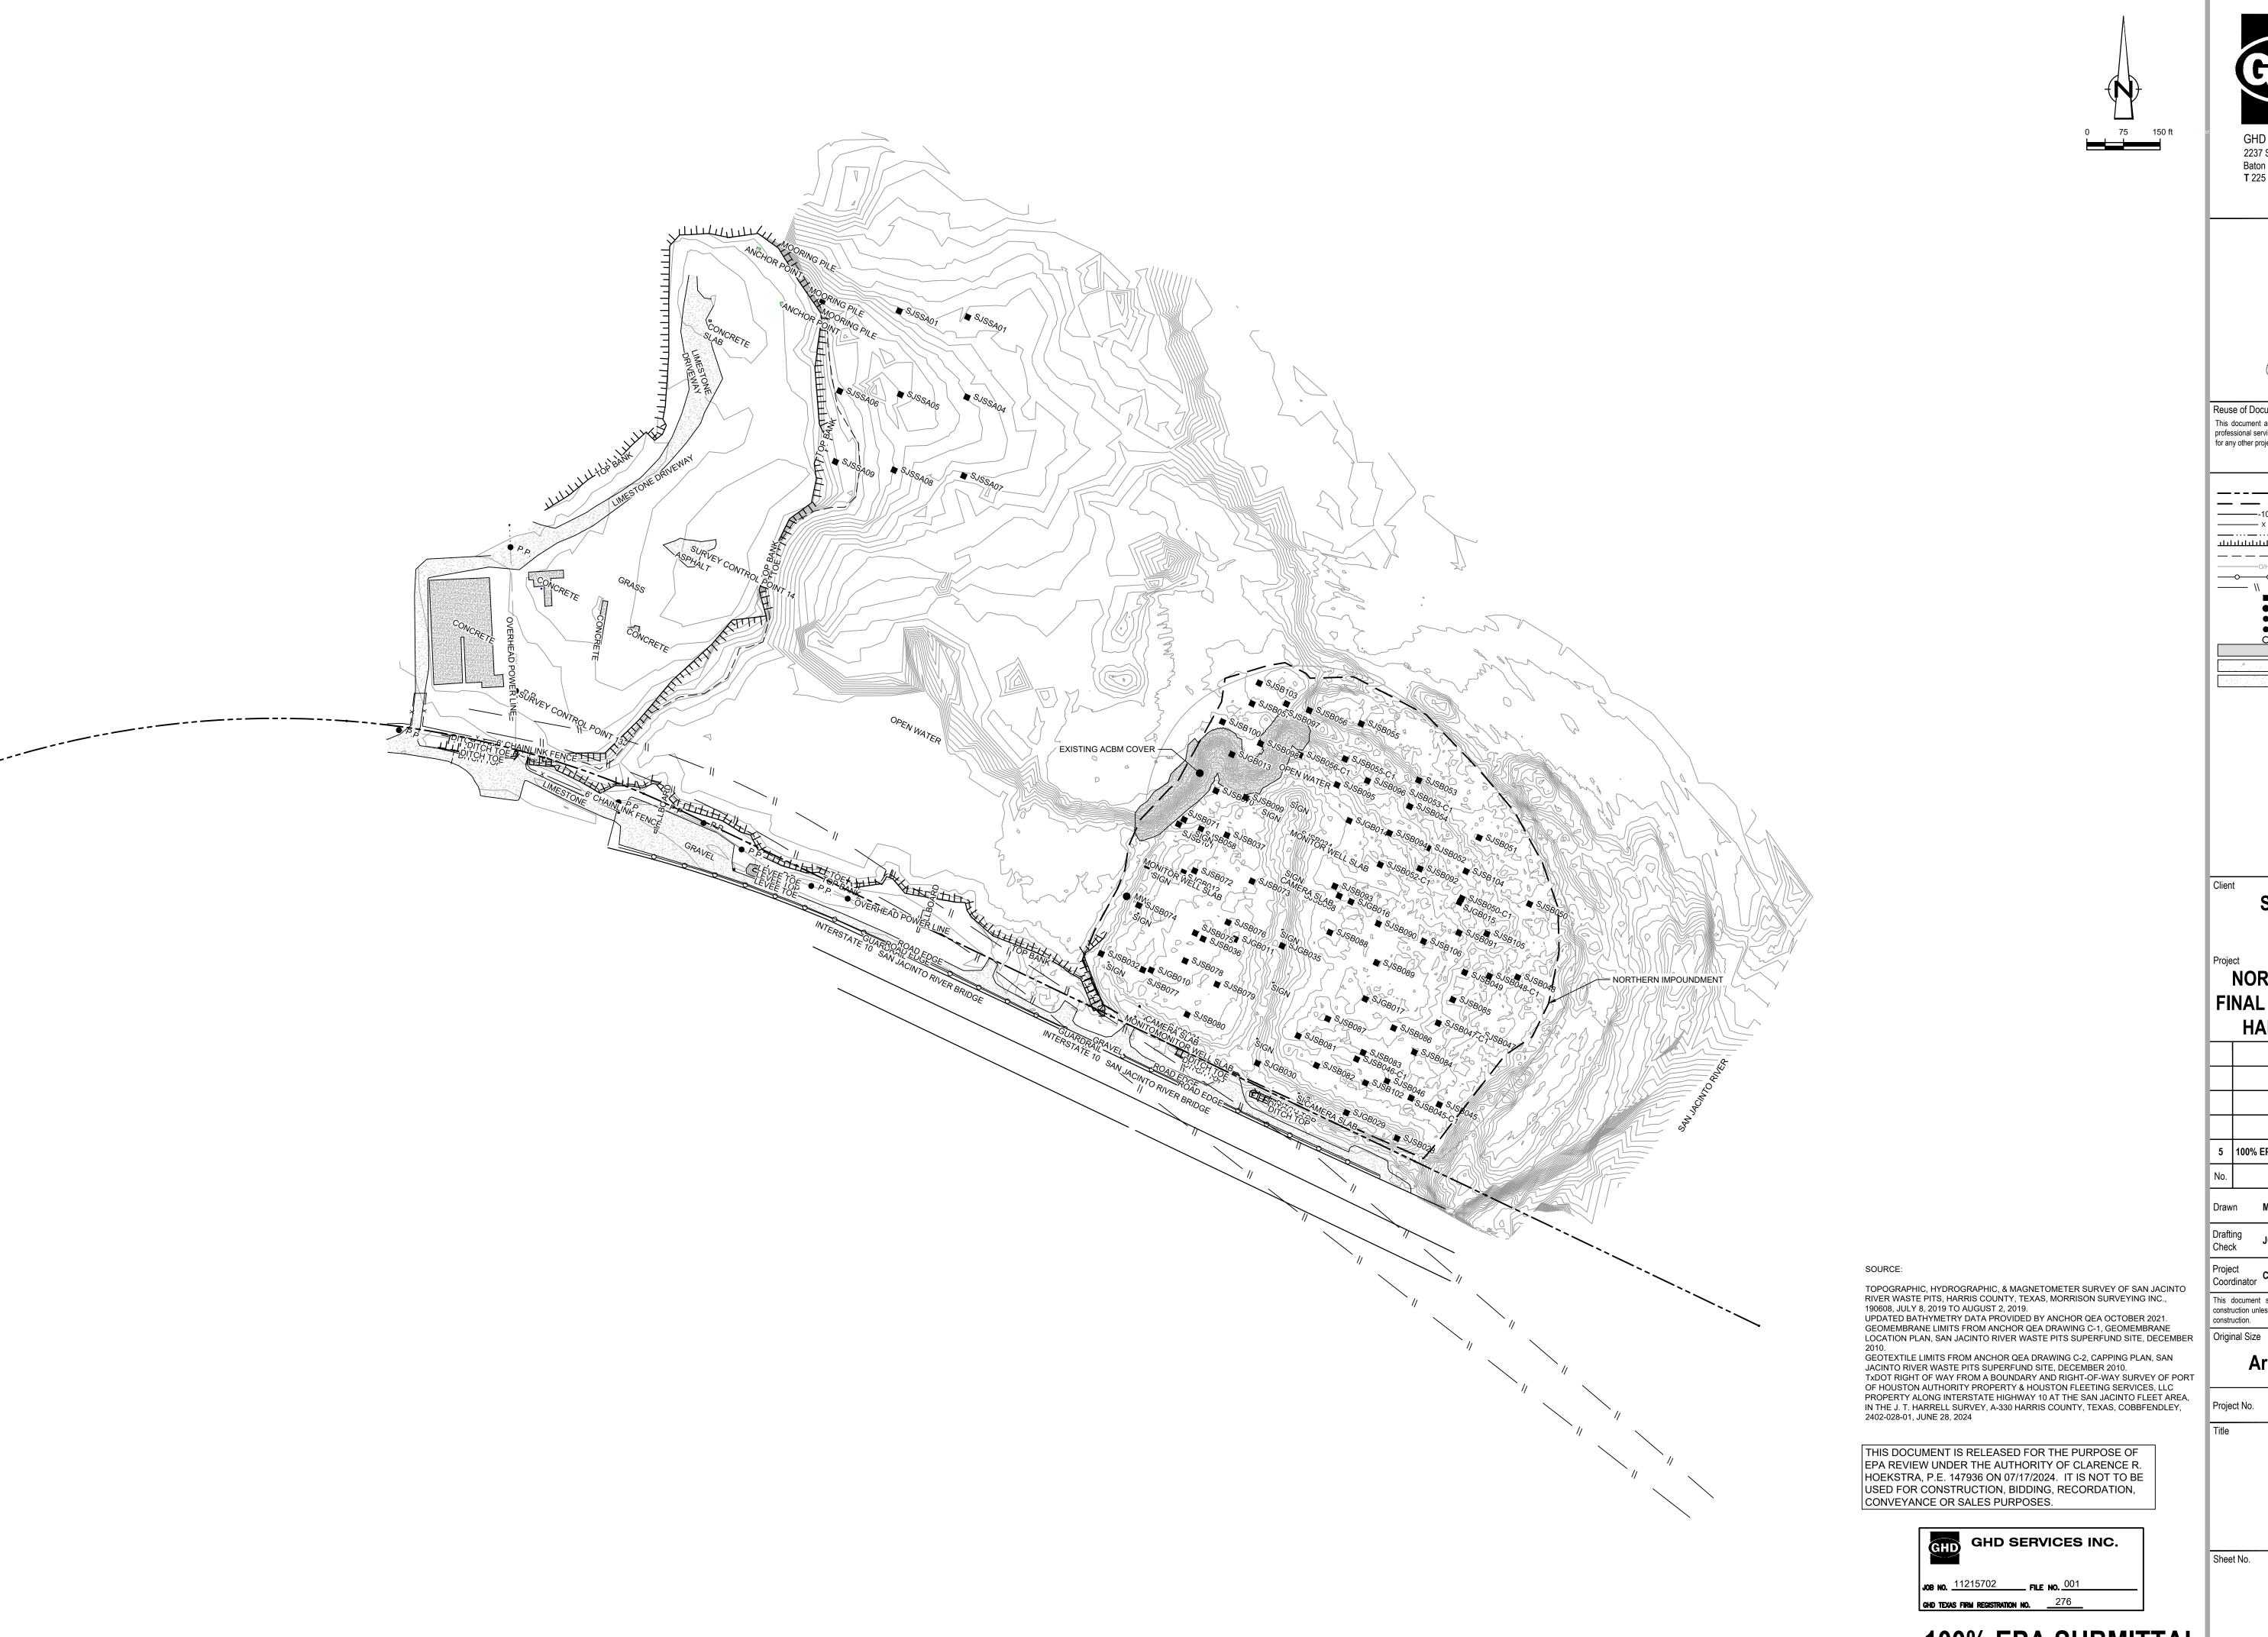

Plot Date: 17 July 2024 - 12:46 PM

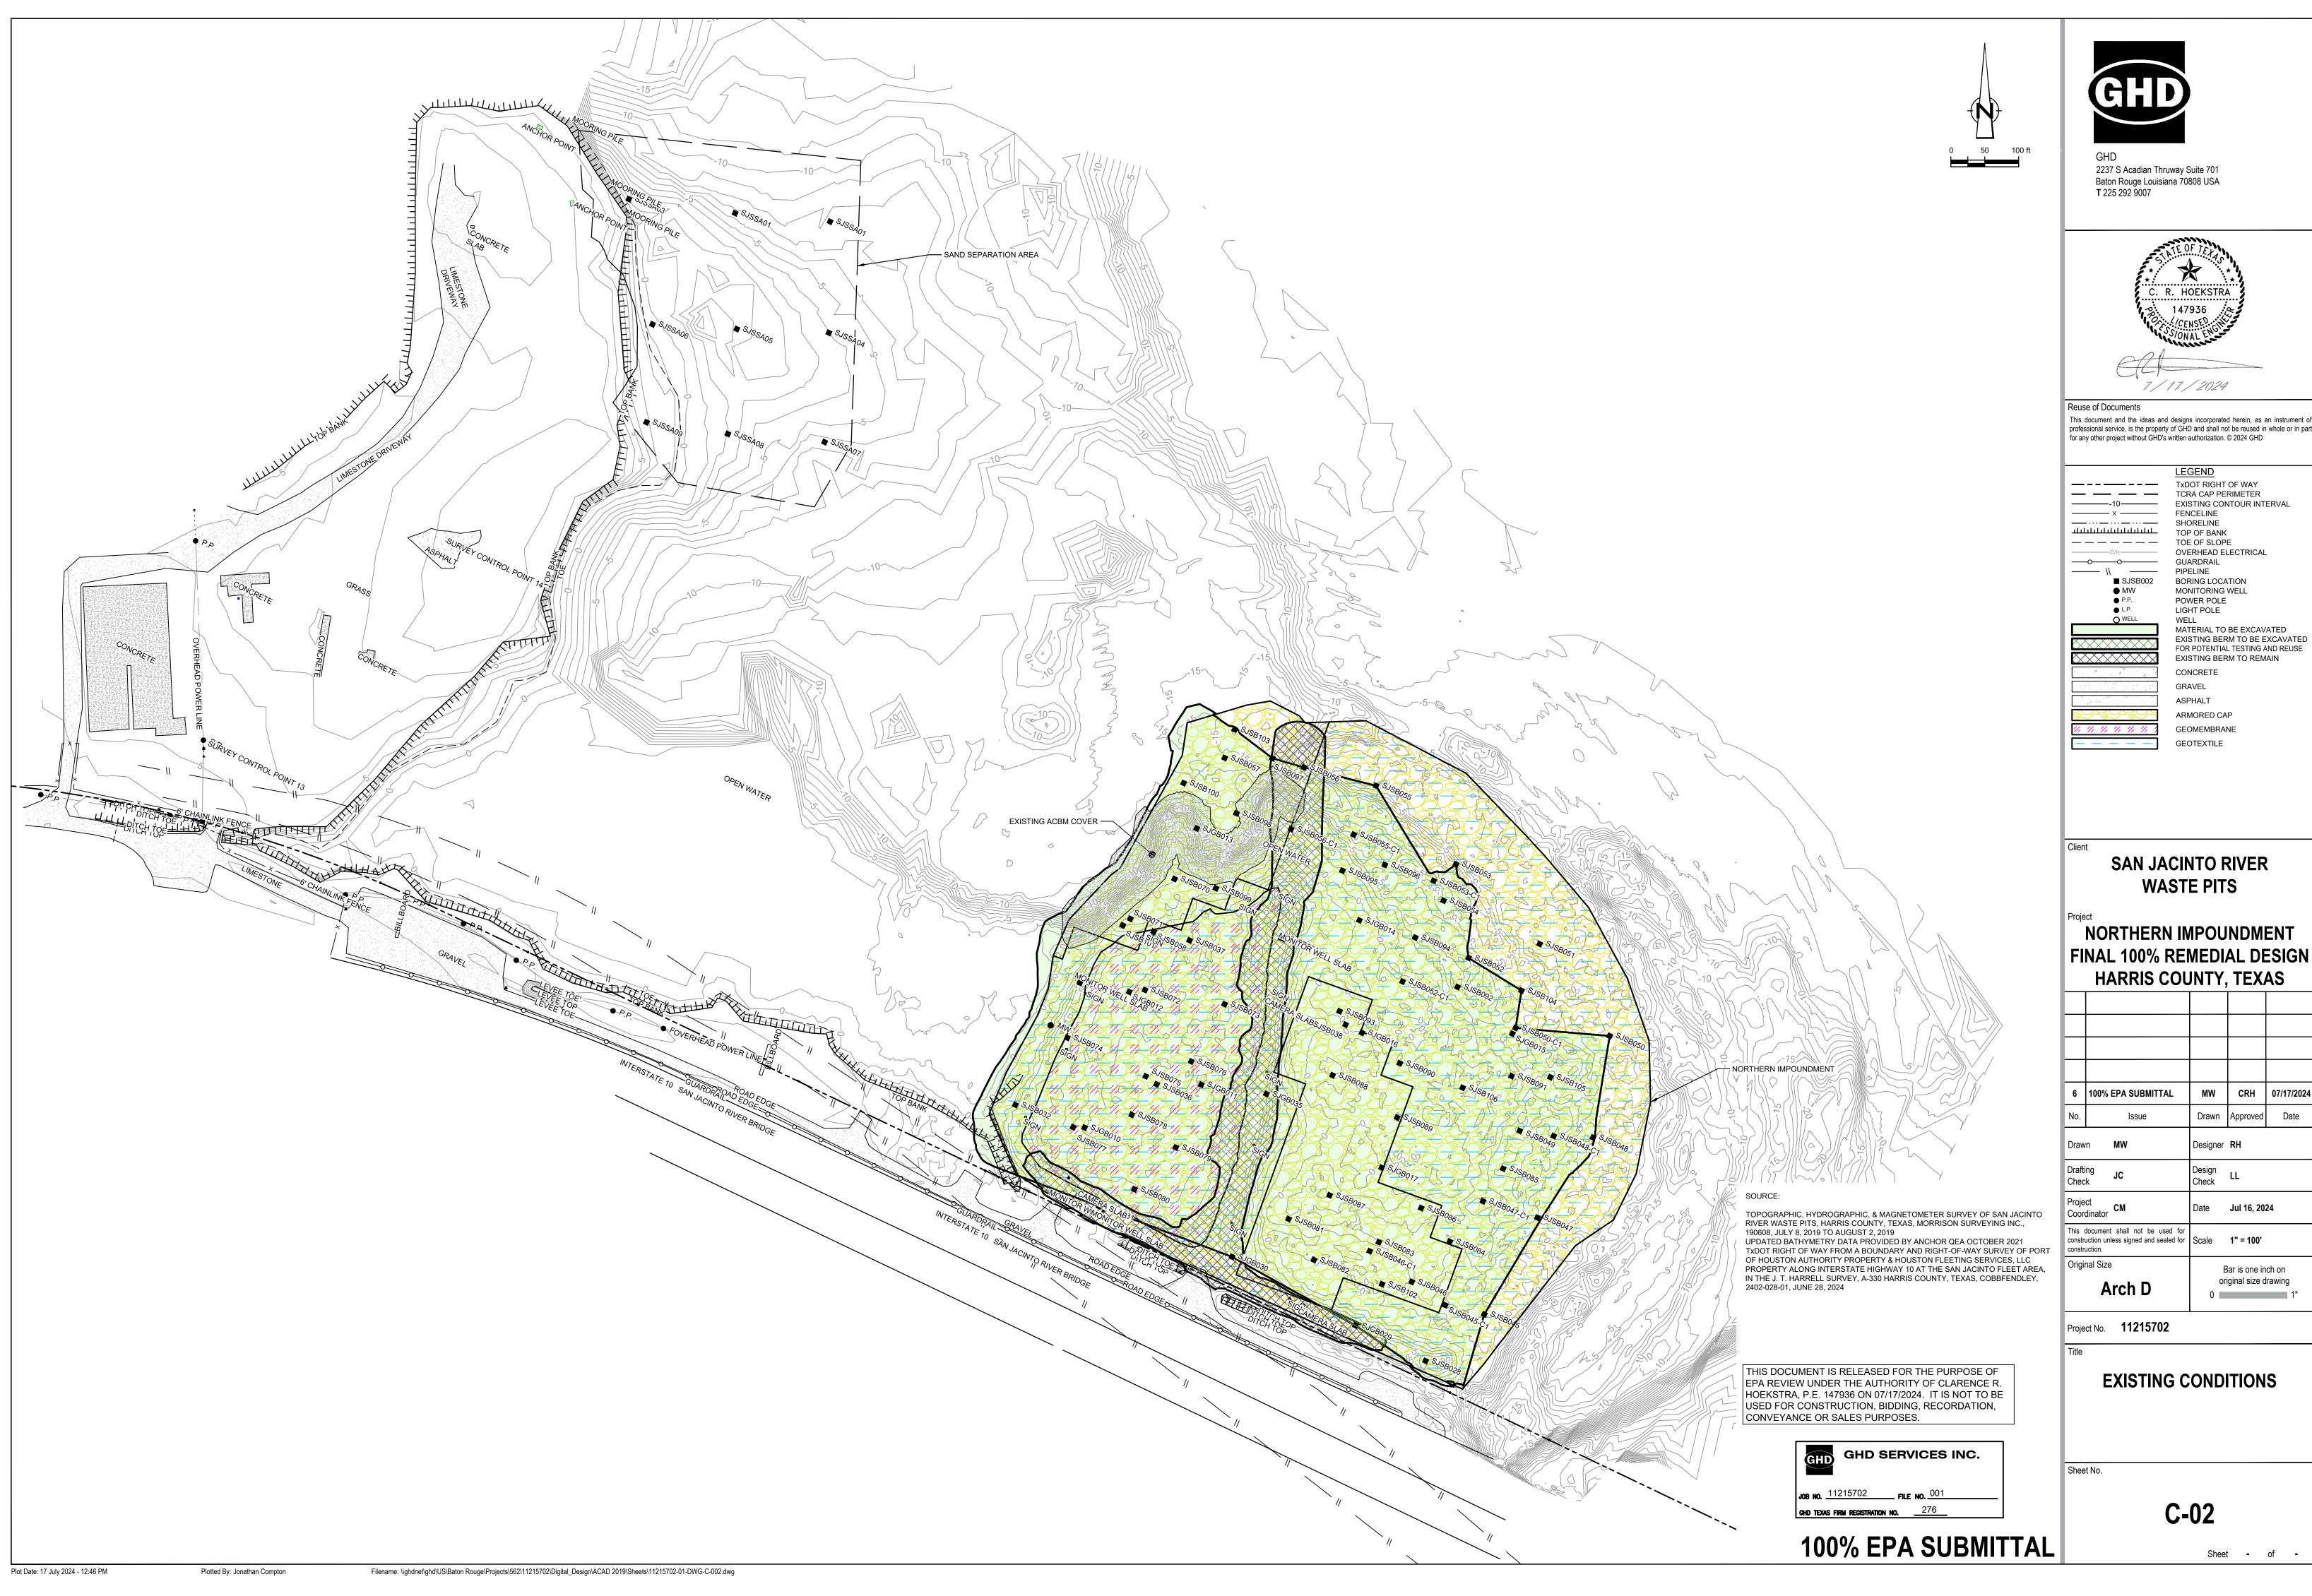

This document and the ideas and designs incorporated herein, as an instrument of professional service, is the property of GHD and shall not be reused in whole or in part

FINAL 100% REMEDIAL DESIGN

ı					
ı					
ı					
ı	6	100% EPA SUBMITTAL	MW	CRH	07/17/20
ı	No.	Issue	Drawn	Approved	Date
	Draw	n MW	Designer	RH	
	Drafti Chec		Design Check	LL	
	Droio	ot			





2237 S Acadian Thruway Suite 701 Baton Rouge Louisiana 70808 USA **T** 225 292 9007



Reuse of Documents

This document and the ideas and designs incorporated herein, as an instrument of professional service, is the property of GHD and shall not be reused in whole or in part for any other project without GHD's written authorization. © 2024 GHD

— – – — TXDOT RIGHT OF WAY — — TCRA CAP PERIMETER EXISTING CONTOUR INTERVAL FENCELINE TOP OF BANK ____ TOE OF SLOPE OVERHEAD ELECTRICAL **GUARDRAIL** PIPELINE ____ \\ ■ SJSB002 BORING LOCATION MW MONITORING WELL POWER POLE LIGHT POLE MATERIAL TO BE EXCAVATED EXISTING BERM TO BE EXCAVATED FOR POTENTIAL TESTING AND REUSE EXISTING BERM TO REMAIN CONCRETE GRAVEL ASPHALT AZ26-700 PILE AZ36-700 PILE AZ42-700 PILE FRP BARRIER WALL PLANNED IMPROVEMENTS FOR NORTHERN IMPOUNDMENT ACCESS SOIL TYPE S1 RAISED BENCH EXTERIOR SCOUR PROTECTION

SAN JACINTO RIVER WASTE PITS

INTERIOR SCOUR PROTECTION

NORTHERN IMPOUNDMENT FINAL 100% REMEDIAL DESIGN

		HARRIS COUNTY, TEXAS					
	6	100% EPA SUBMITTAL	MW	CRH	07/17/2024		
	No.	Issue	Drawn	Approved	Date		
	Draw	n MW	Designer	RH			
	Drafti Chec	• .IC.	Design Check	LL			
-	Proje Coor	ct dinator CM	Date	Jul 16, 20	24		
		document shall not be used for uction unless signed and sealed for	Scale	1" = 100'			

Arch D

Project No. **11215702**

Original Size

SSA AREA AND NORTHERN IMPOUNDMENT **WORKS**

Bar is one inch on original size drawing

Sheet - of -


Sheet No.

C-03

100% EPA SUBMITTAL

Plotted By: Jonathan Compton

Filename: \\ghdnet\ghd\US\Baton Rouge\Projects\562\11215702\Digital_Design\ACAD 2019\Sheets\11215702-01-DWG-C-003.dwg

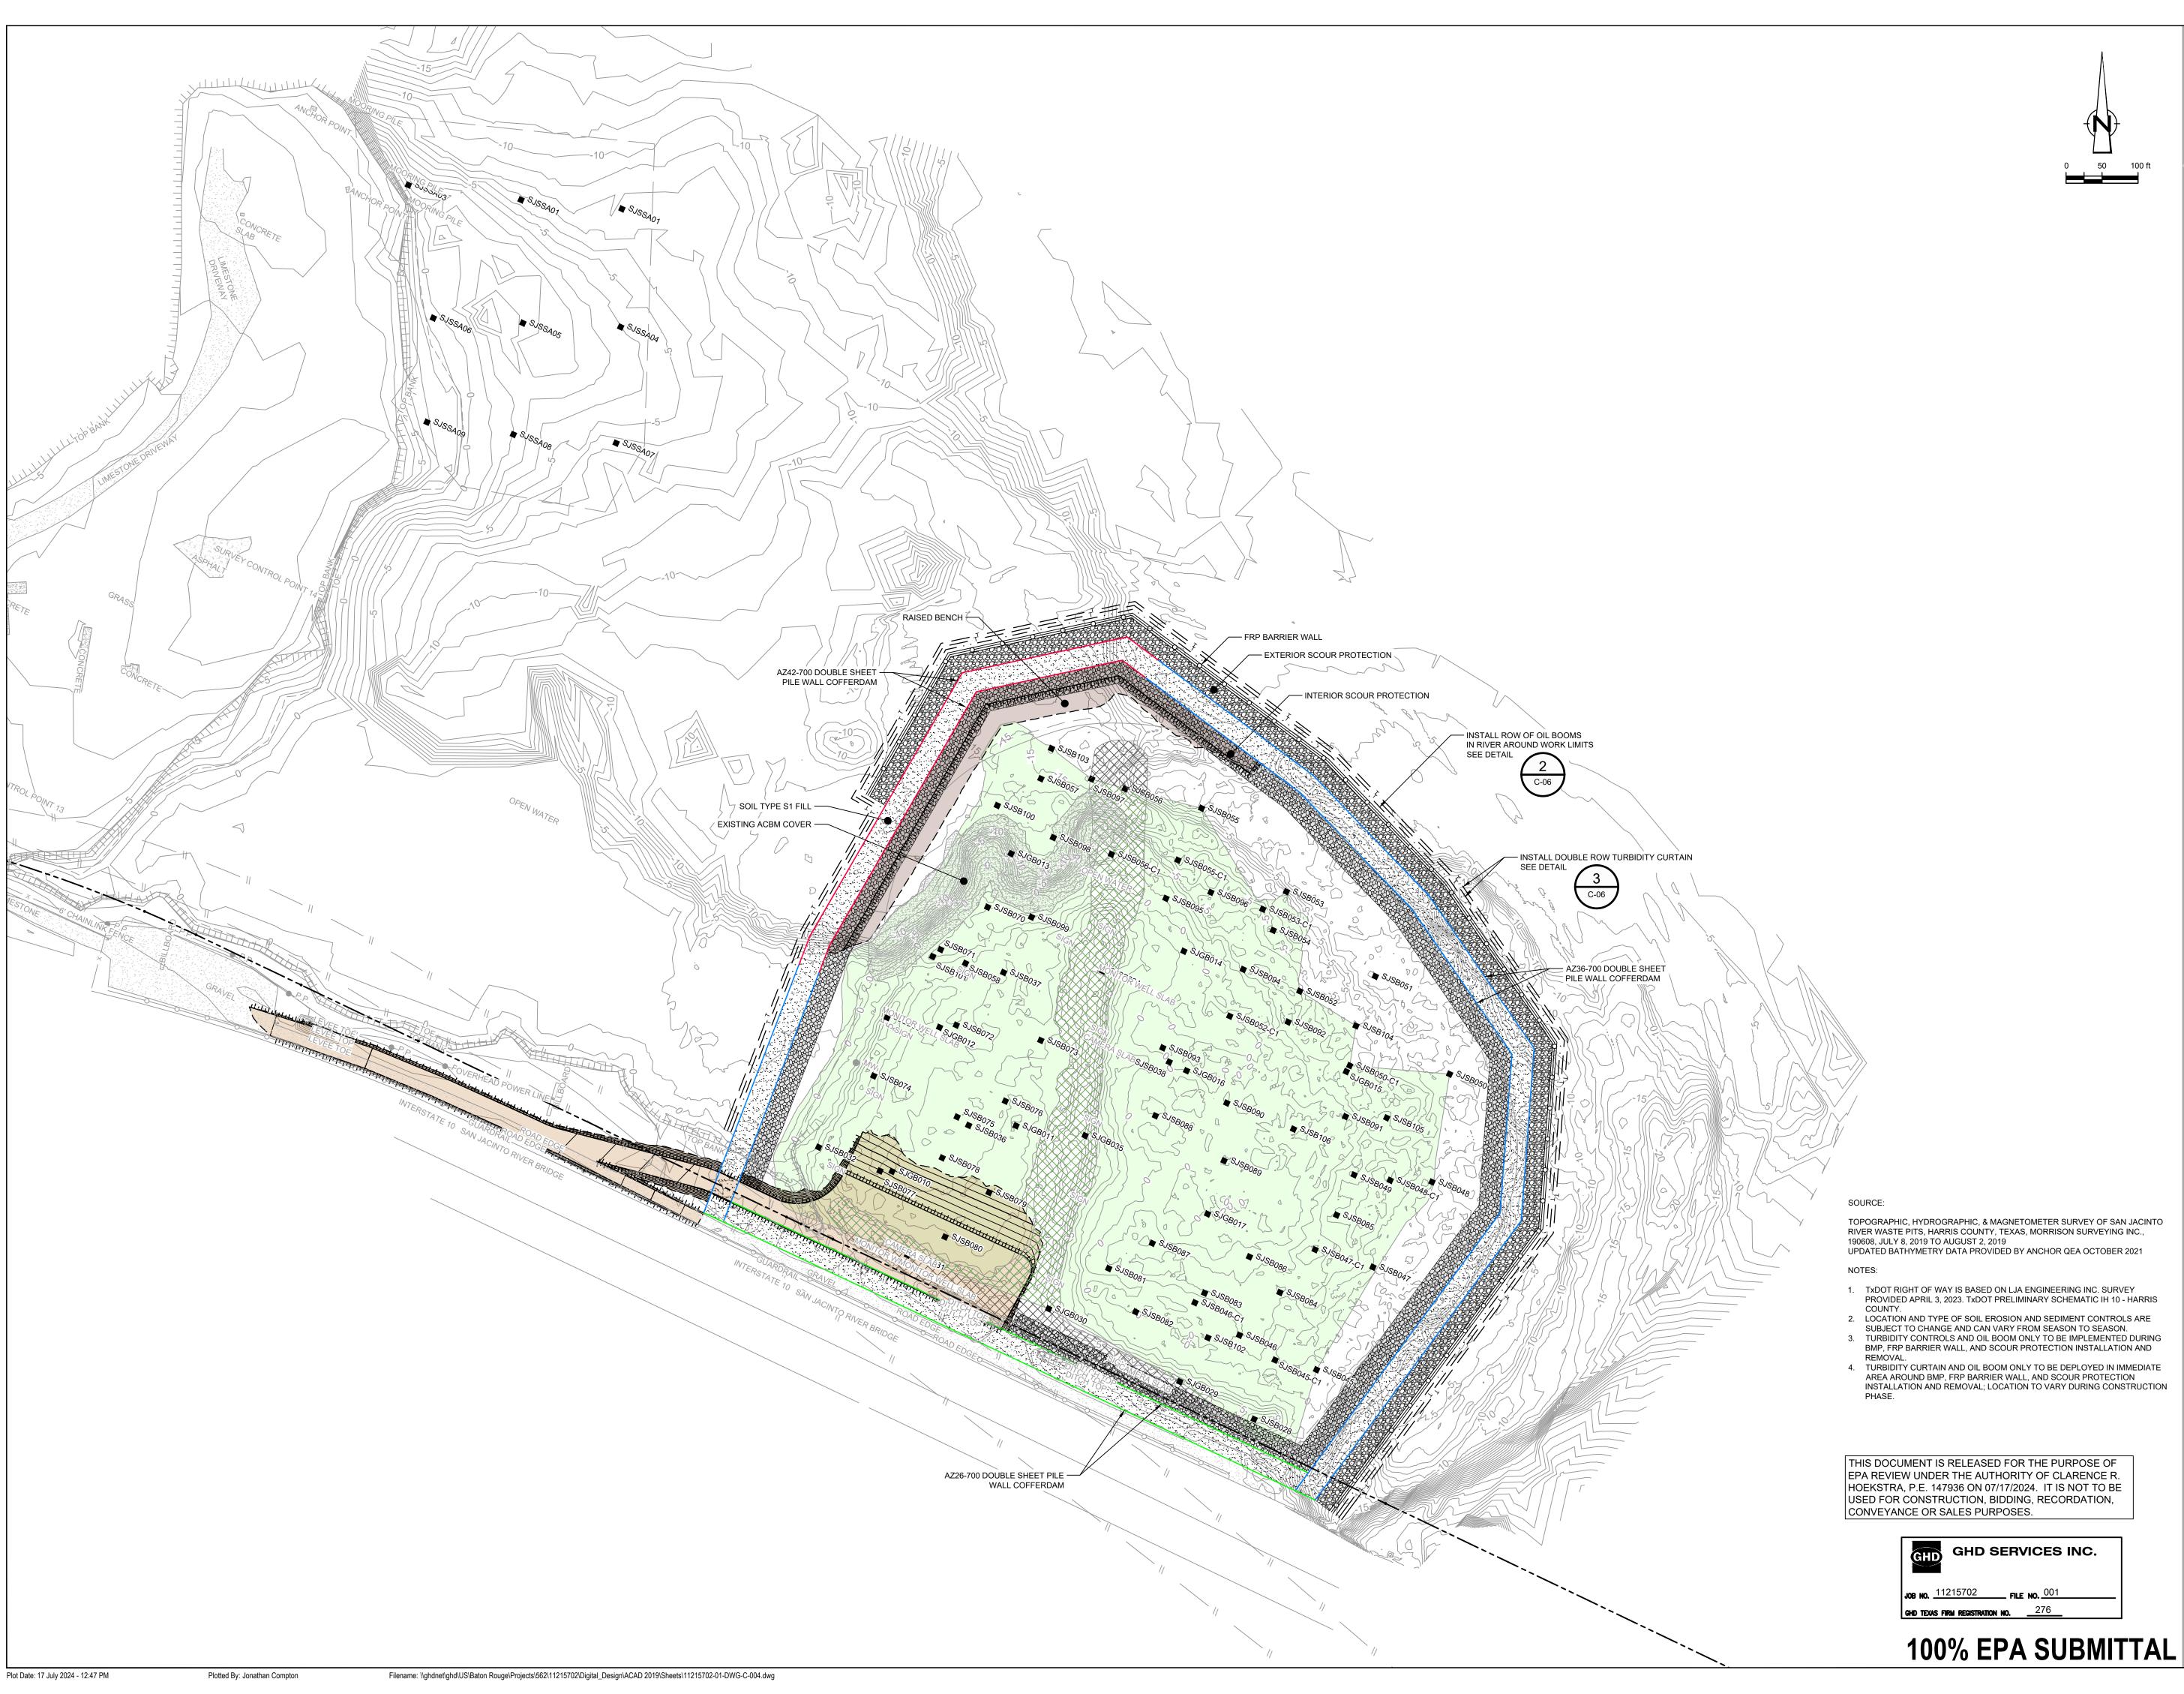

GHD

2237 S Acadian Thruway Suite 701
Baton Rouge Louisiana 70808 USA
T 225 292 9007



Reuse of Documents

This document and the ideas and designs incorporated herein, as an instrument of professional service, is the property of GHD and shall not be reused in whole or in part for any other project without GHD's written authorization. © 2024 GHD

— – – — TXDOT RIGHT OF WAY

— — TCRA CAP PERIMETER EXISTING CONTOUR INTERVAL FENCELINE TOP OF BANK — — — — — TOE OF SLOPE OVERHEAD ELECTRICAL **GUARDRAIL** ____ \\ PIPELINE ■ SJSB002 BORING LOCATION MW MONITORING WELL POWER POLE LIGHT POLE MATERIAL TO BE EXCAVATED EXISTING BERM TO BE EXCAVATED FOR POTENTIAL TESTING AND REUSE EXISTING BERM TO REMAIN CONCRETE GRAVEL ASPHALT AZ26-700 PILE AZ36-700 PILE AZ42-700 PILE

SAN JACINTO RIVER
WASTE PITS

FRP BARRIER WALL SILT FENCE

TURBIDITY CURTAIN

RAISED BENCH

PLANNED IMPROVEMENTS FOR NORTHERN IMPOUNDMENT ACCESS

OIL BOOM

EXTERIOR SCOUR PROTECTION

INTERIOR SCOUR PROTECTION

NORTHERN IMPOUNDMENT FINAL 100% REMEDIAL DESIGN HARRIS COUNTY, TEXAS

6	100% EPA SUBMITTAL	MW	CRH	07/17/20
No.	Issue	Drawn	Approved	Date
Draw	n MW	Designer	RH	
Draft Chec	· .IC.	Design Check	LL	
Proje Coor	ect dinator CM	Date	Jul 16, 20	24
constr	document shall not be used for uction unless signed and sealed for uction.	Scale	1" = 100'	
Origi	nal Size	Bar is one inch on original size drawing		• • • • • • • • • • • • • • • • • • • •

Project No. **11215702**

Arch D


Title

SOIL EROSION AND SEDIMENT CONTROL PLAN OVERALL

Sheet No.

C-04

Sheet - of

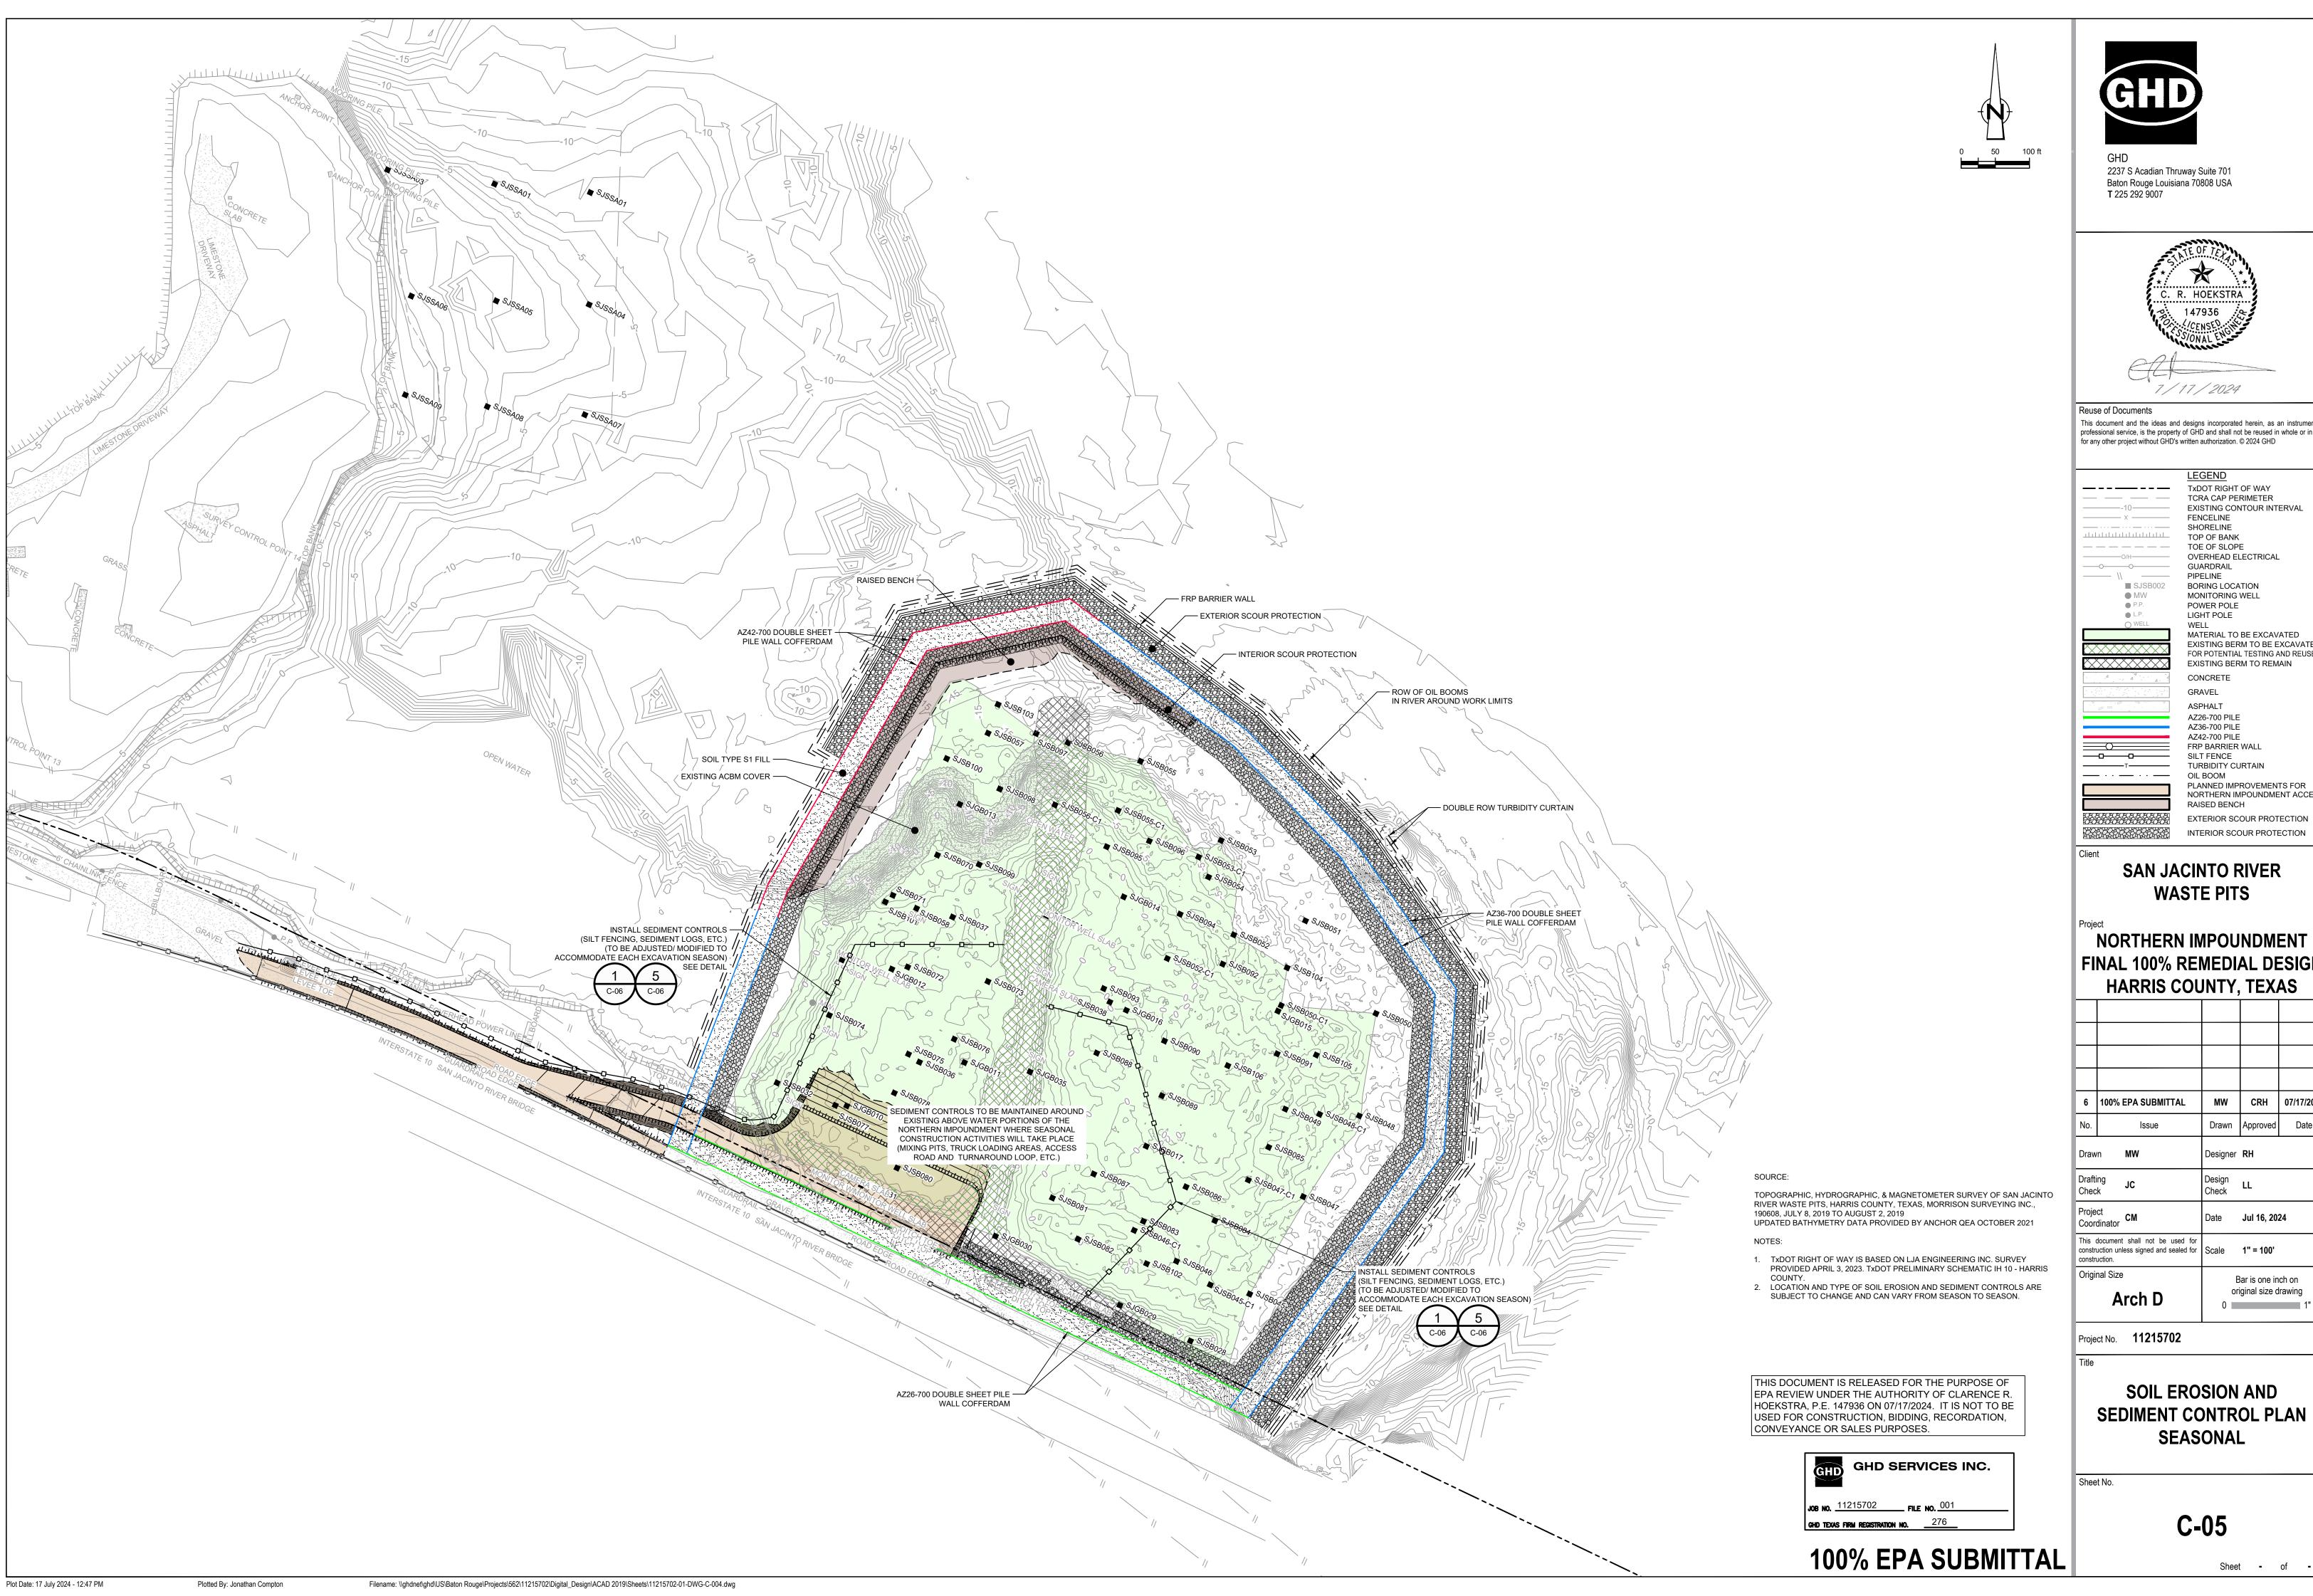



This document and the ideas and designs incorporated herein, as an instrument of professional service, is the property of GHD and shall not be reused in whole or in part

LEGEND
TxDOT RIGHT OF WAY
TCRA CAP PERIMETER
EXISTING CONTOUR INTERVAL
FENCELINE
SHORELINE
TOP OF BANK
TOE OF SLOPE
OVERHEAD ELECTRICAL
GUARDRAIL
PIPELINE
BORING LOCATION
MONITORING WELL
POWER POLE
LIGHT POLE

MATERIAL TO BE EXCAVATED EXISTING BERM TO BE EXCAVATED FOR POTENTIAL TESTING AND REUSE EXISTING BERM TO REMAIN

> AZ26-700 PILE AZ36-700 PILE AZ42-700 PILE FRP BARRIER WALL

TURBIDITY CURTAIN PLANNED IMPROVEMENTS FOR NORTHERN IMPOUNDMENT ACCESS


INTERIOR SCOUR PROTECTION


NORTHERN IMPOUNDMENT FINAL 100% REMEDIAL DESIGN

		•		
6	100% EPA SUBMITTAL	MW	CRH	07/17/2024
No.	Issue	Drawn	Approved	Date
Draw	n MW	Designer	RH	
Drafti Chec	·	Design Check	LL	
Proje Coor	ct dinator	Date	Jul 16, 20	24

Bar is one inch on original size drawing

SOIL EROSION AND SEDIMENT CONTROL PLAN

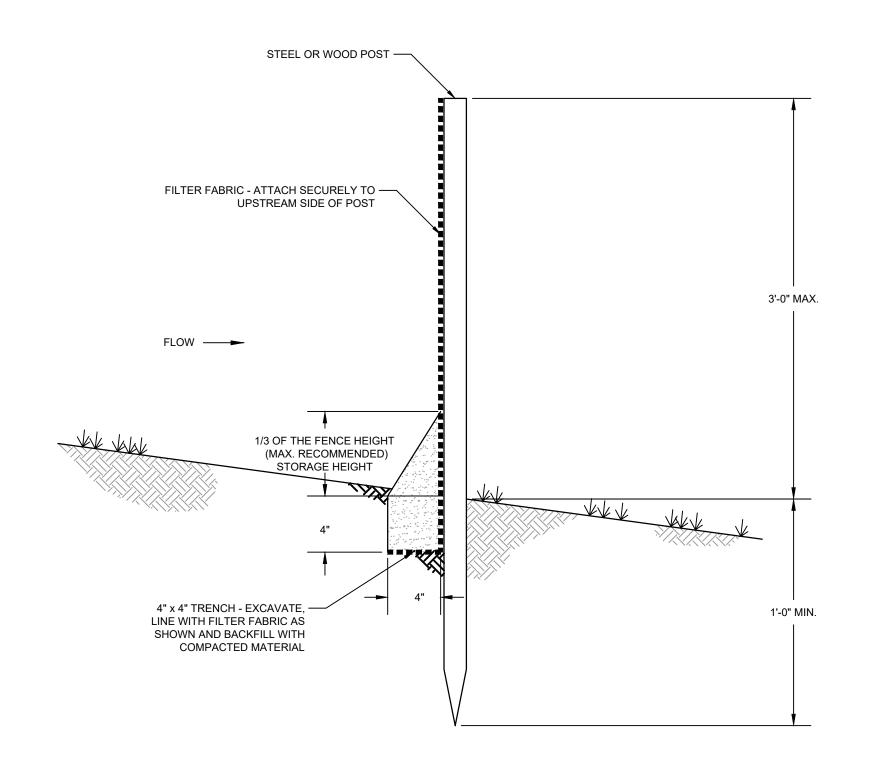

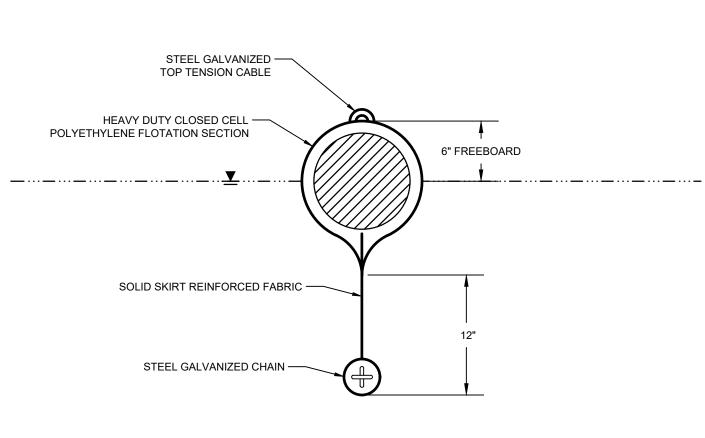

1. OIL BOOM SHALL CONFORM TO COAST GUARD OPA 90 REGULATION AND ASTM F-1523

1' DIA. SEDIMENT LOG

NON-ABSORBENT OIL BOOM

<u>NOTES</u>

2. OIL BOOM SHALL BE CONTINUOUS TYPE.

BUOYANCY TO PROVIDE VINYL COATED CABLE 12" MIN. FREEBOARD FLOTATION CORE TYPE III PERMEABLE HEAVY DUTY -TURBIDITY CURTAIN OR EQUIVALENT AS REQUIRED CHAIN BALLAST — HALF WATER DEPTH RIVER BED

TOP LOAD LINE —

SLOPE

10' C/C (TYP.)


2" SQ WOODEN STAKES PLACED 10' ON CENTER

---- FINAL GRADE

1. TURBIDITY CURTAIN SHALL BE TYPE III ACCORDING TO DEPARTMENT OF THE ARMY, US ARMY CORPS OF ENGINEERS WASHINGTON, DC, ENGINEERING AND DESIGN "HANDBOOK FOR THE PREPARATION OF STORM WATER POLLUTION PREVENTION PLANS FOR CONSTRUCTION ACTIVITIES", APPENDIX 'C' BMP 27 TURBIDITY CURTAIN, DOCUMENT EP1110-1-16, 1997. 2. CURTAIN SYSTEM SHALL BE EQUIPPED WITH LOAD TRANSFER TYPE PANEL CONNECTORS 3. INCLUDE MOORING SYSTEM IF REQUIRED.

TURBIDITY CURTAINS

TEMPORARY SILT FENCE

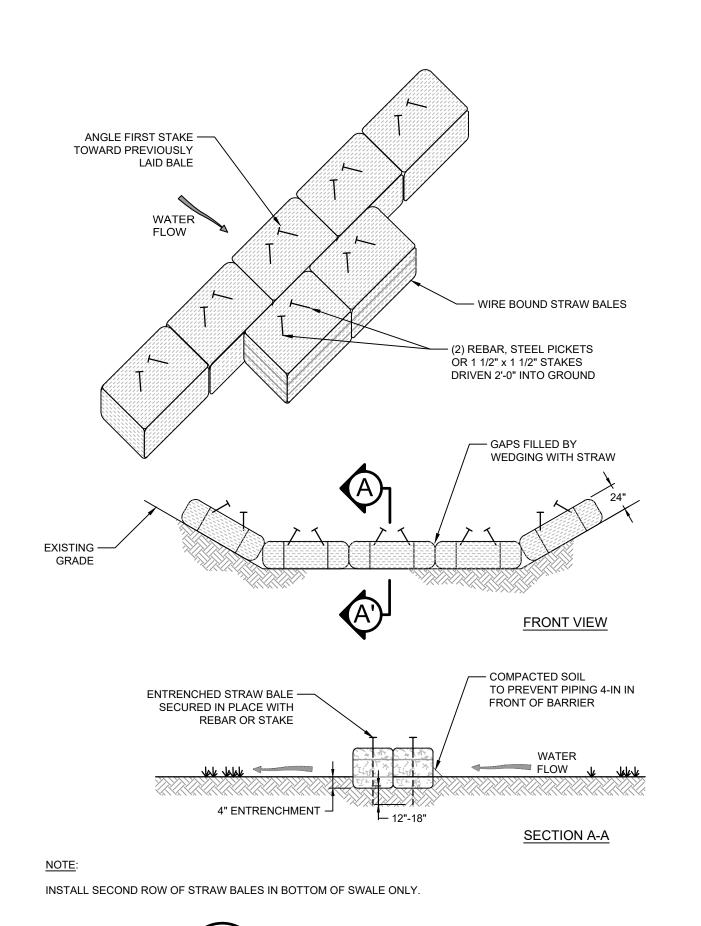

<u>PLAN</u> 1' DIA. SEDIMENT LOG — — 3' LONG 2" SQ WOODEN STAKES PLACED 10' ON CENTER FILTREXX SILT SOXX OR EQUAL ACCUMULATED SEDIMENT — REACHING HALF THE HEIGHT OF THE SILT LOG SHALL BE REMOVED MIN. 16" OR AS PER MANUFACTURING RECOMMENDATION

DETAIL

D-__

— 2" SQ WOODEN STAKES


5 SEDIMENT LOG

THIS DOCUMENT IS RELEASED FOR THE PURPOSE OF EPA REVIEW UNDER THE AUTHORITY OF CLARENCE R. HOEKSTRA, P.E. 147936 ON 07/17/2024. IT IS NOT TO BE USED FOR CONSTRUCTION, BIDDING, RECORDATION, CONVEYANCE OR SALES PURPOSES.



100% EPA SUBMITTAL




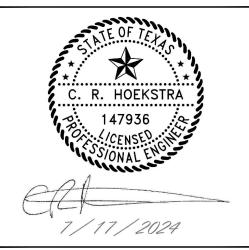

Reuse of Documents This document and the ideas and designs incorporated herein, as an instrument of professional service, is the property of GHD and shall not be reused in whole or in part for any other project without GHD's written authorization. © 2024 GHD

SAN JACINTO RIVER WASTE PITS

NORTHERN IMPOUNDMENT FINAL 100% REMEDIAL DESIGN HARRIS COUNTY, TEXAS

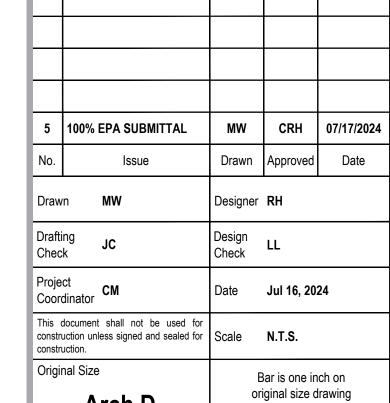

Project No. **11215702**

Arch D

SOIL EROSION AND SEDIMENT CONTROL DETAILS

Sheet No.

C-06


Sheet - of -

Plot Date: 17 July 2024 - 12:48 PM

Plotted By: Jonathan Compton


Filename: \\ghdnet\ghd\US\Baton Rouge\Projects\562\11215702\Digital_Design\ACAD 2019\Sheets\11215702-01-DWG-C-006.dwg

STRAW BALE BARRIER

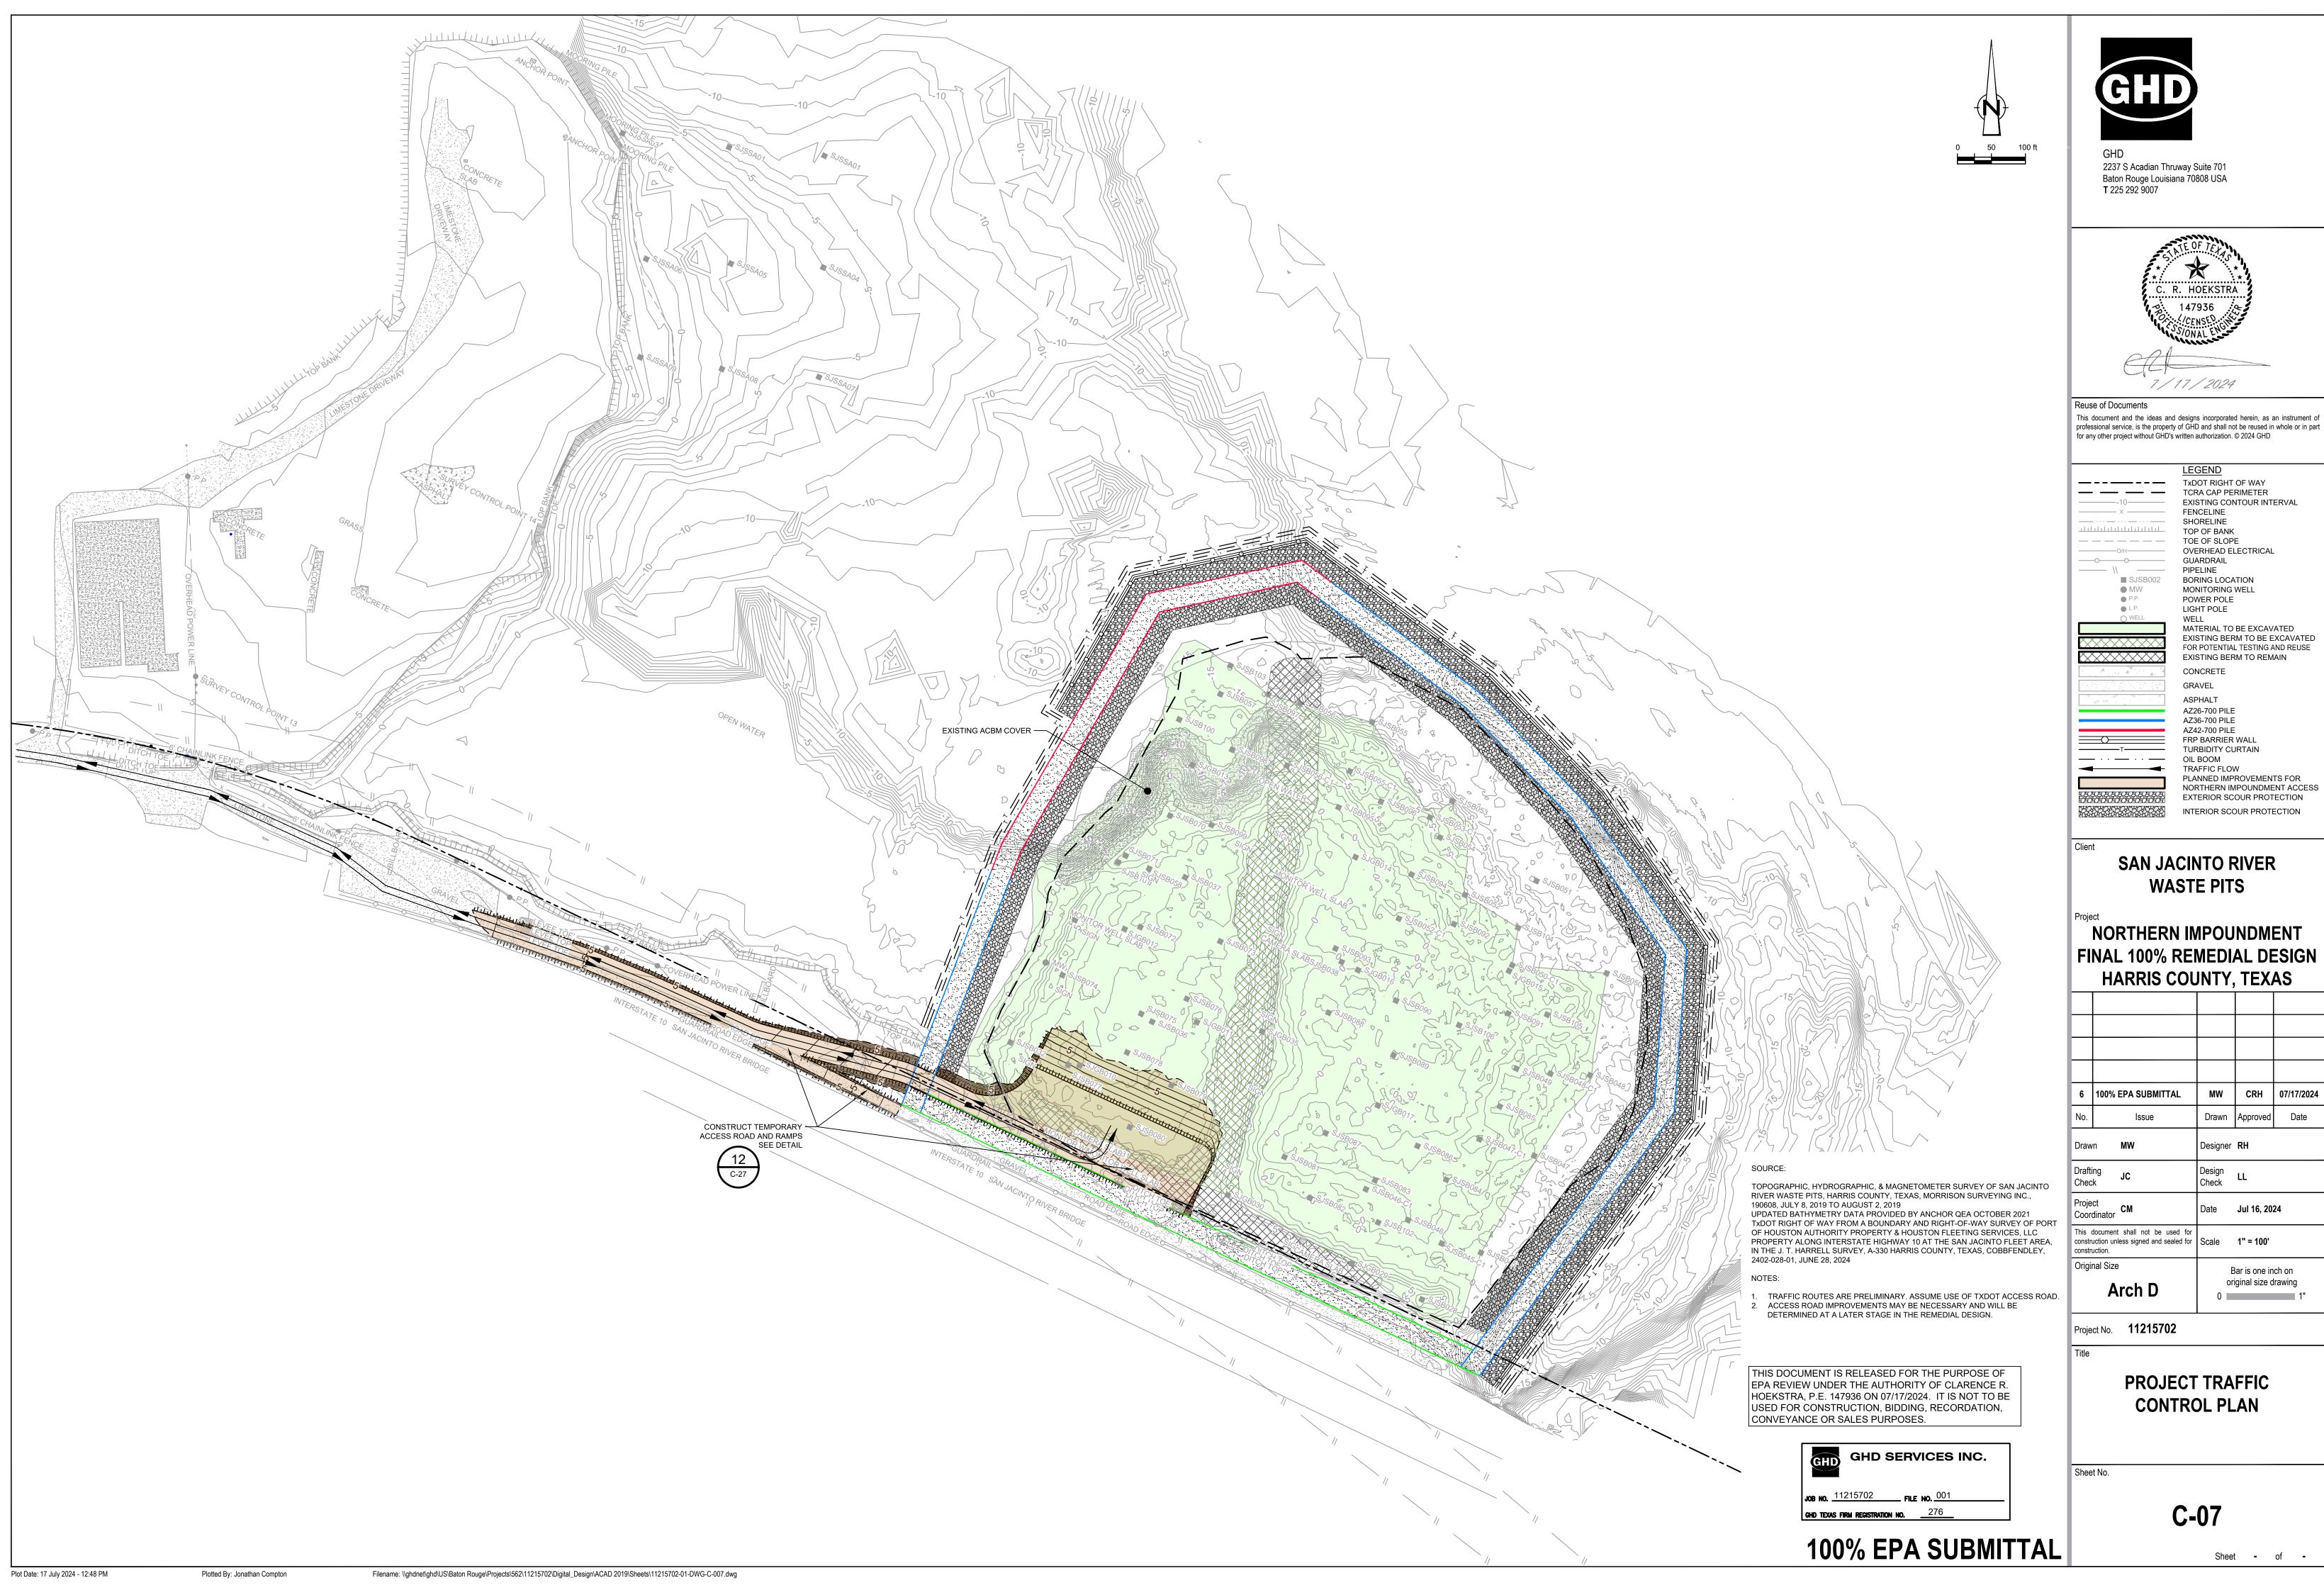


This document and the ideas and designs incorporated herein, as an instrument of professional service, is the property of GHD and shall not be reused in whole or in part


NORTHERN IMPOUNDMENT

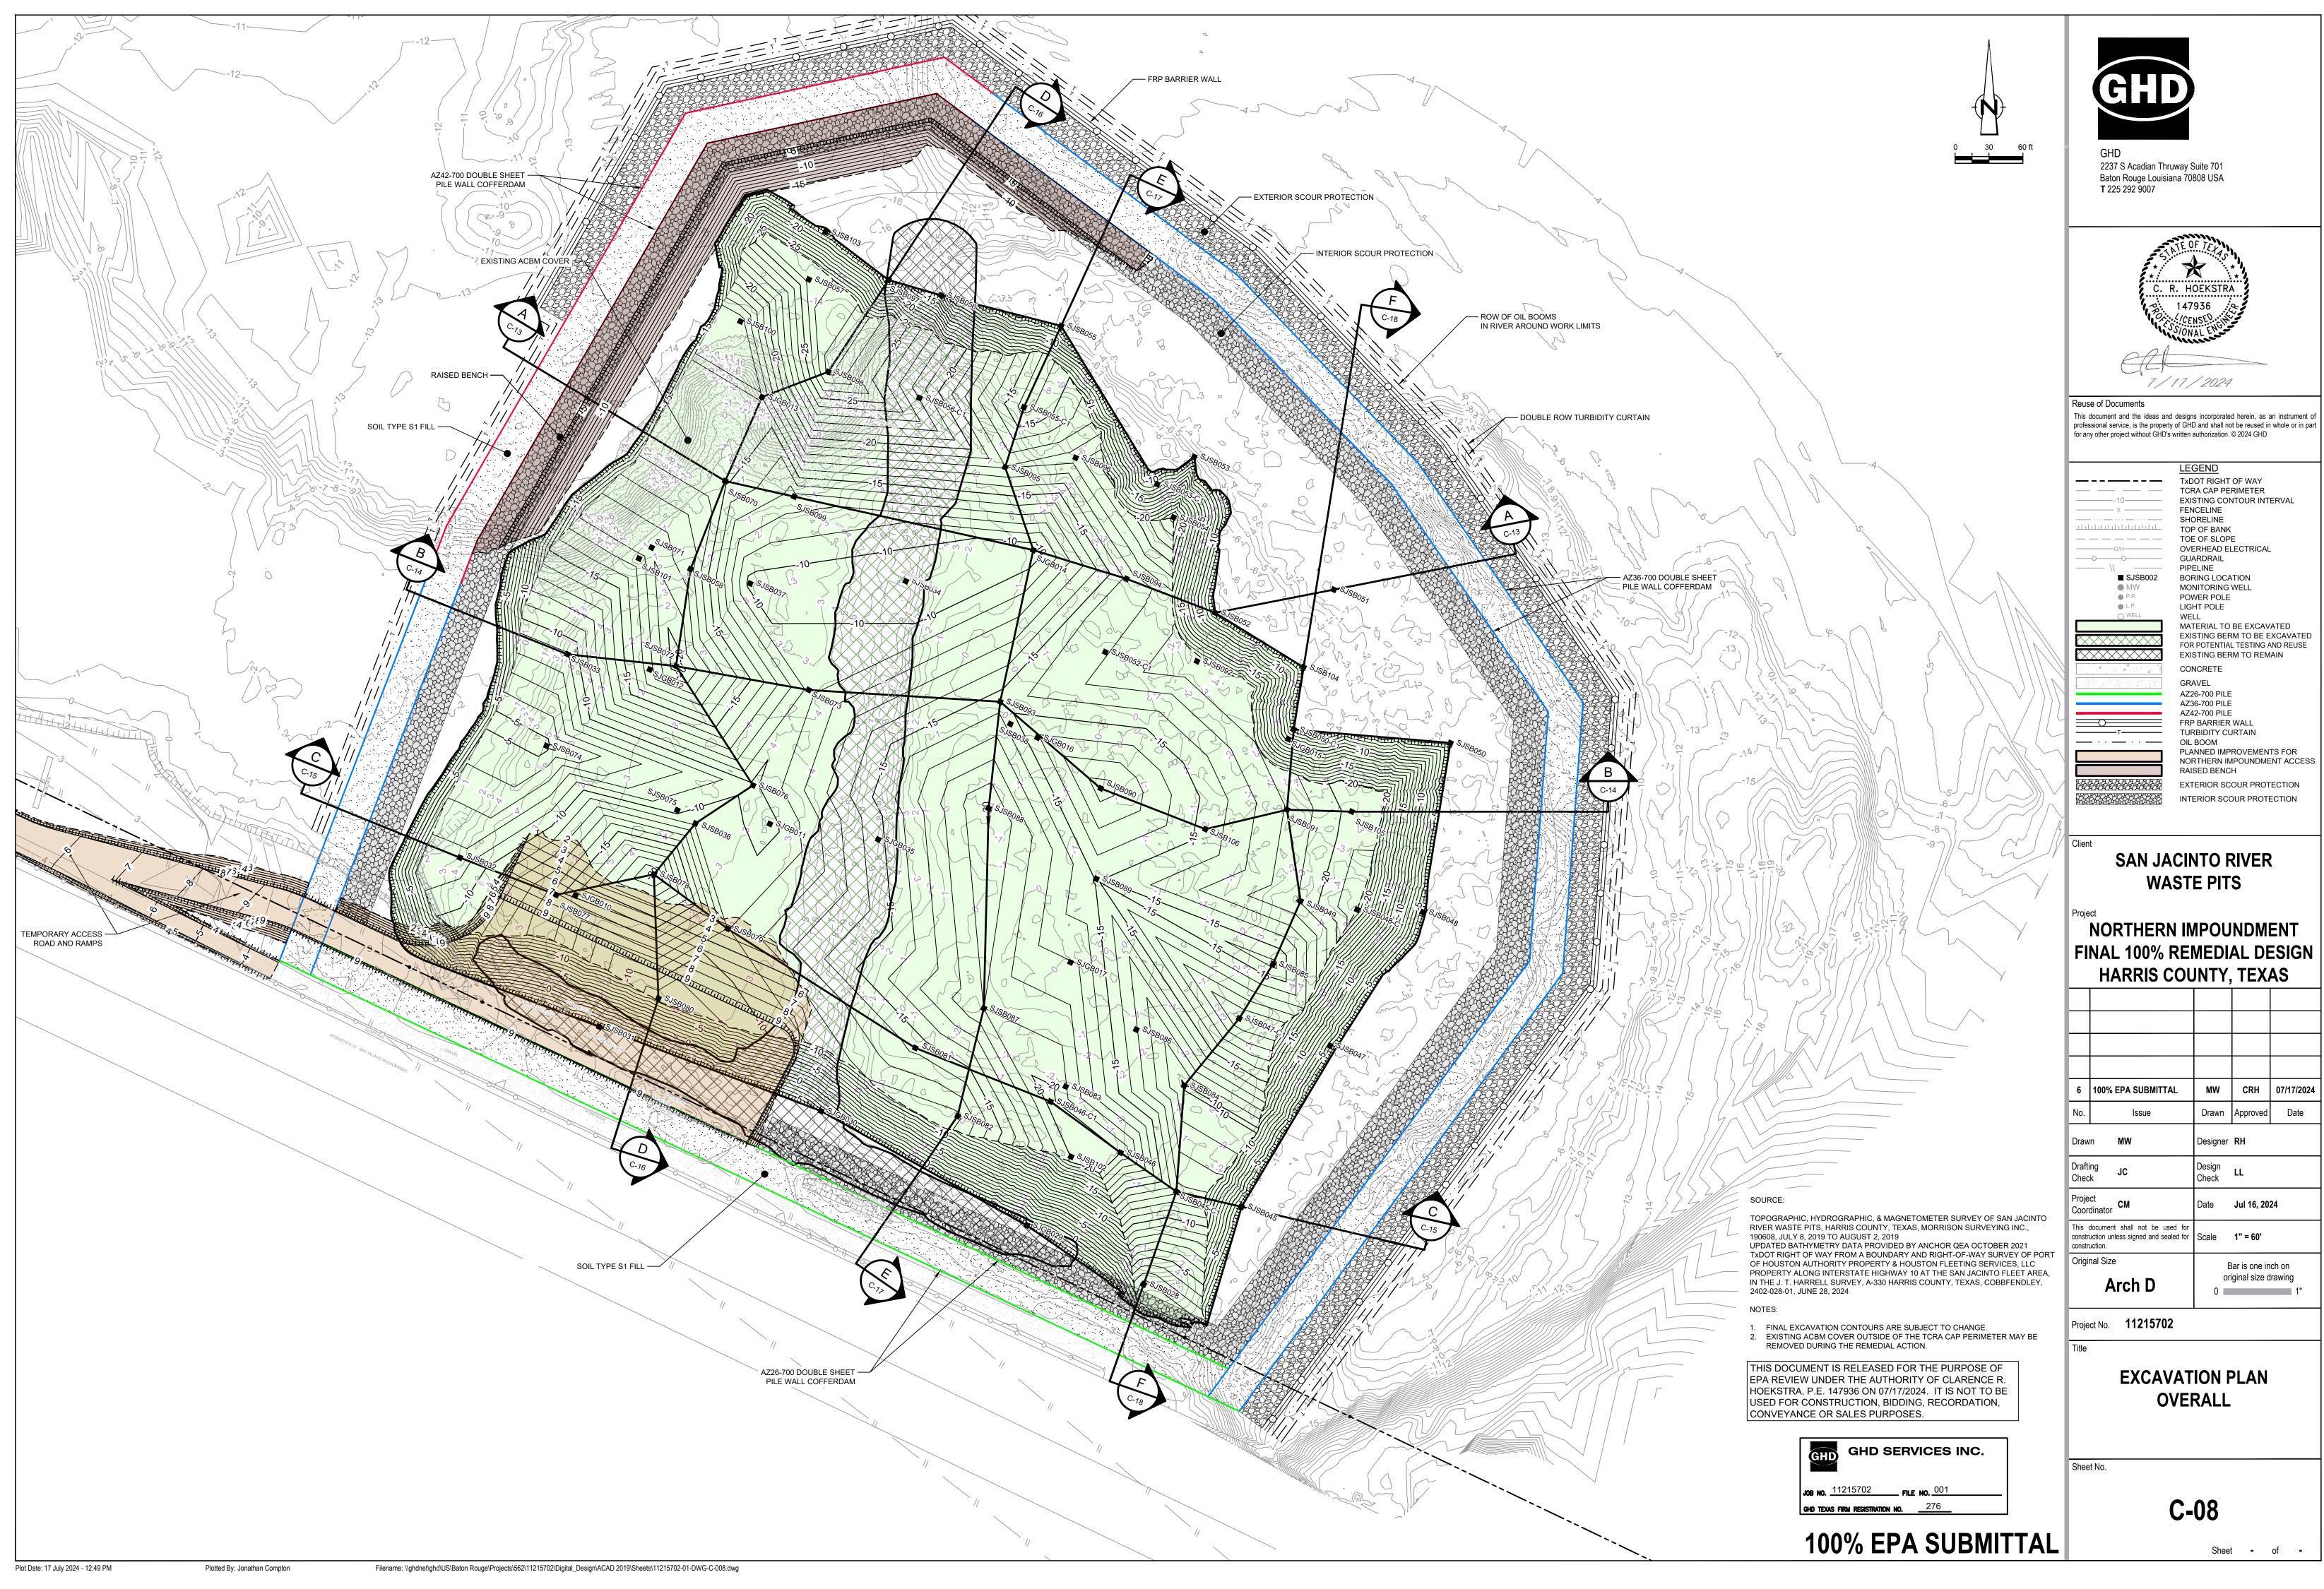



This document and the ideas and designs incorporated herein, as an instrument of


FINAL 100% REMEDIAL DESIGN

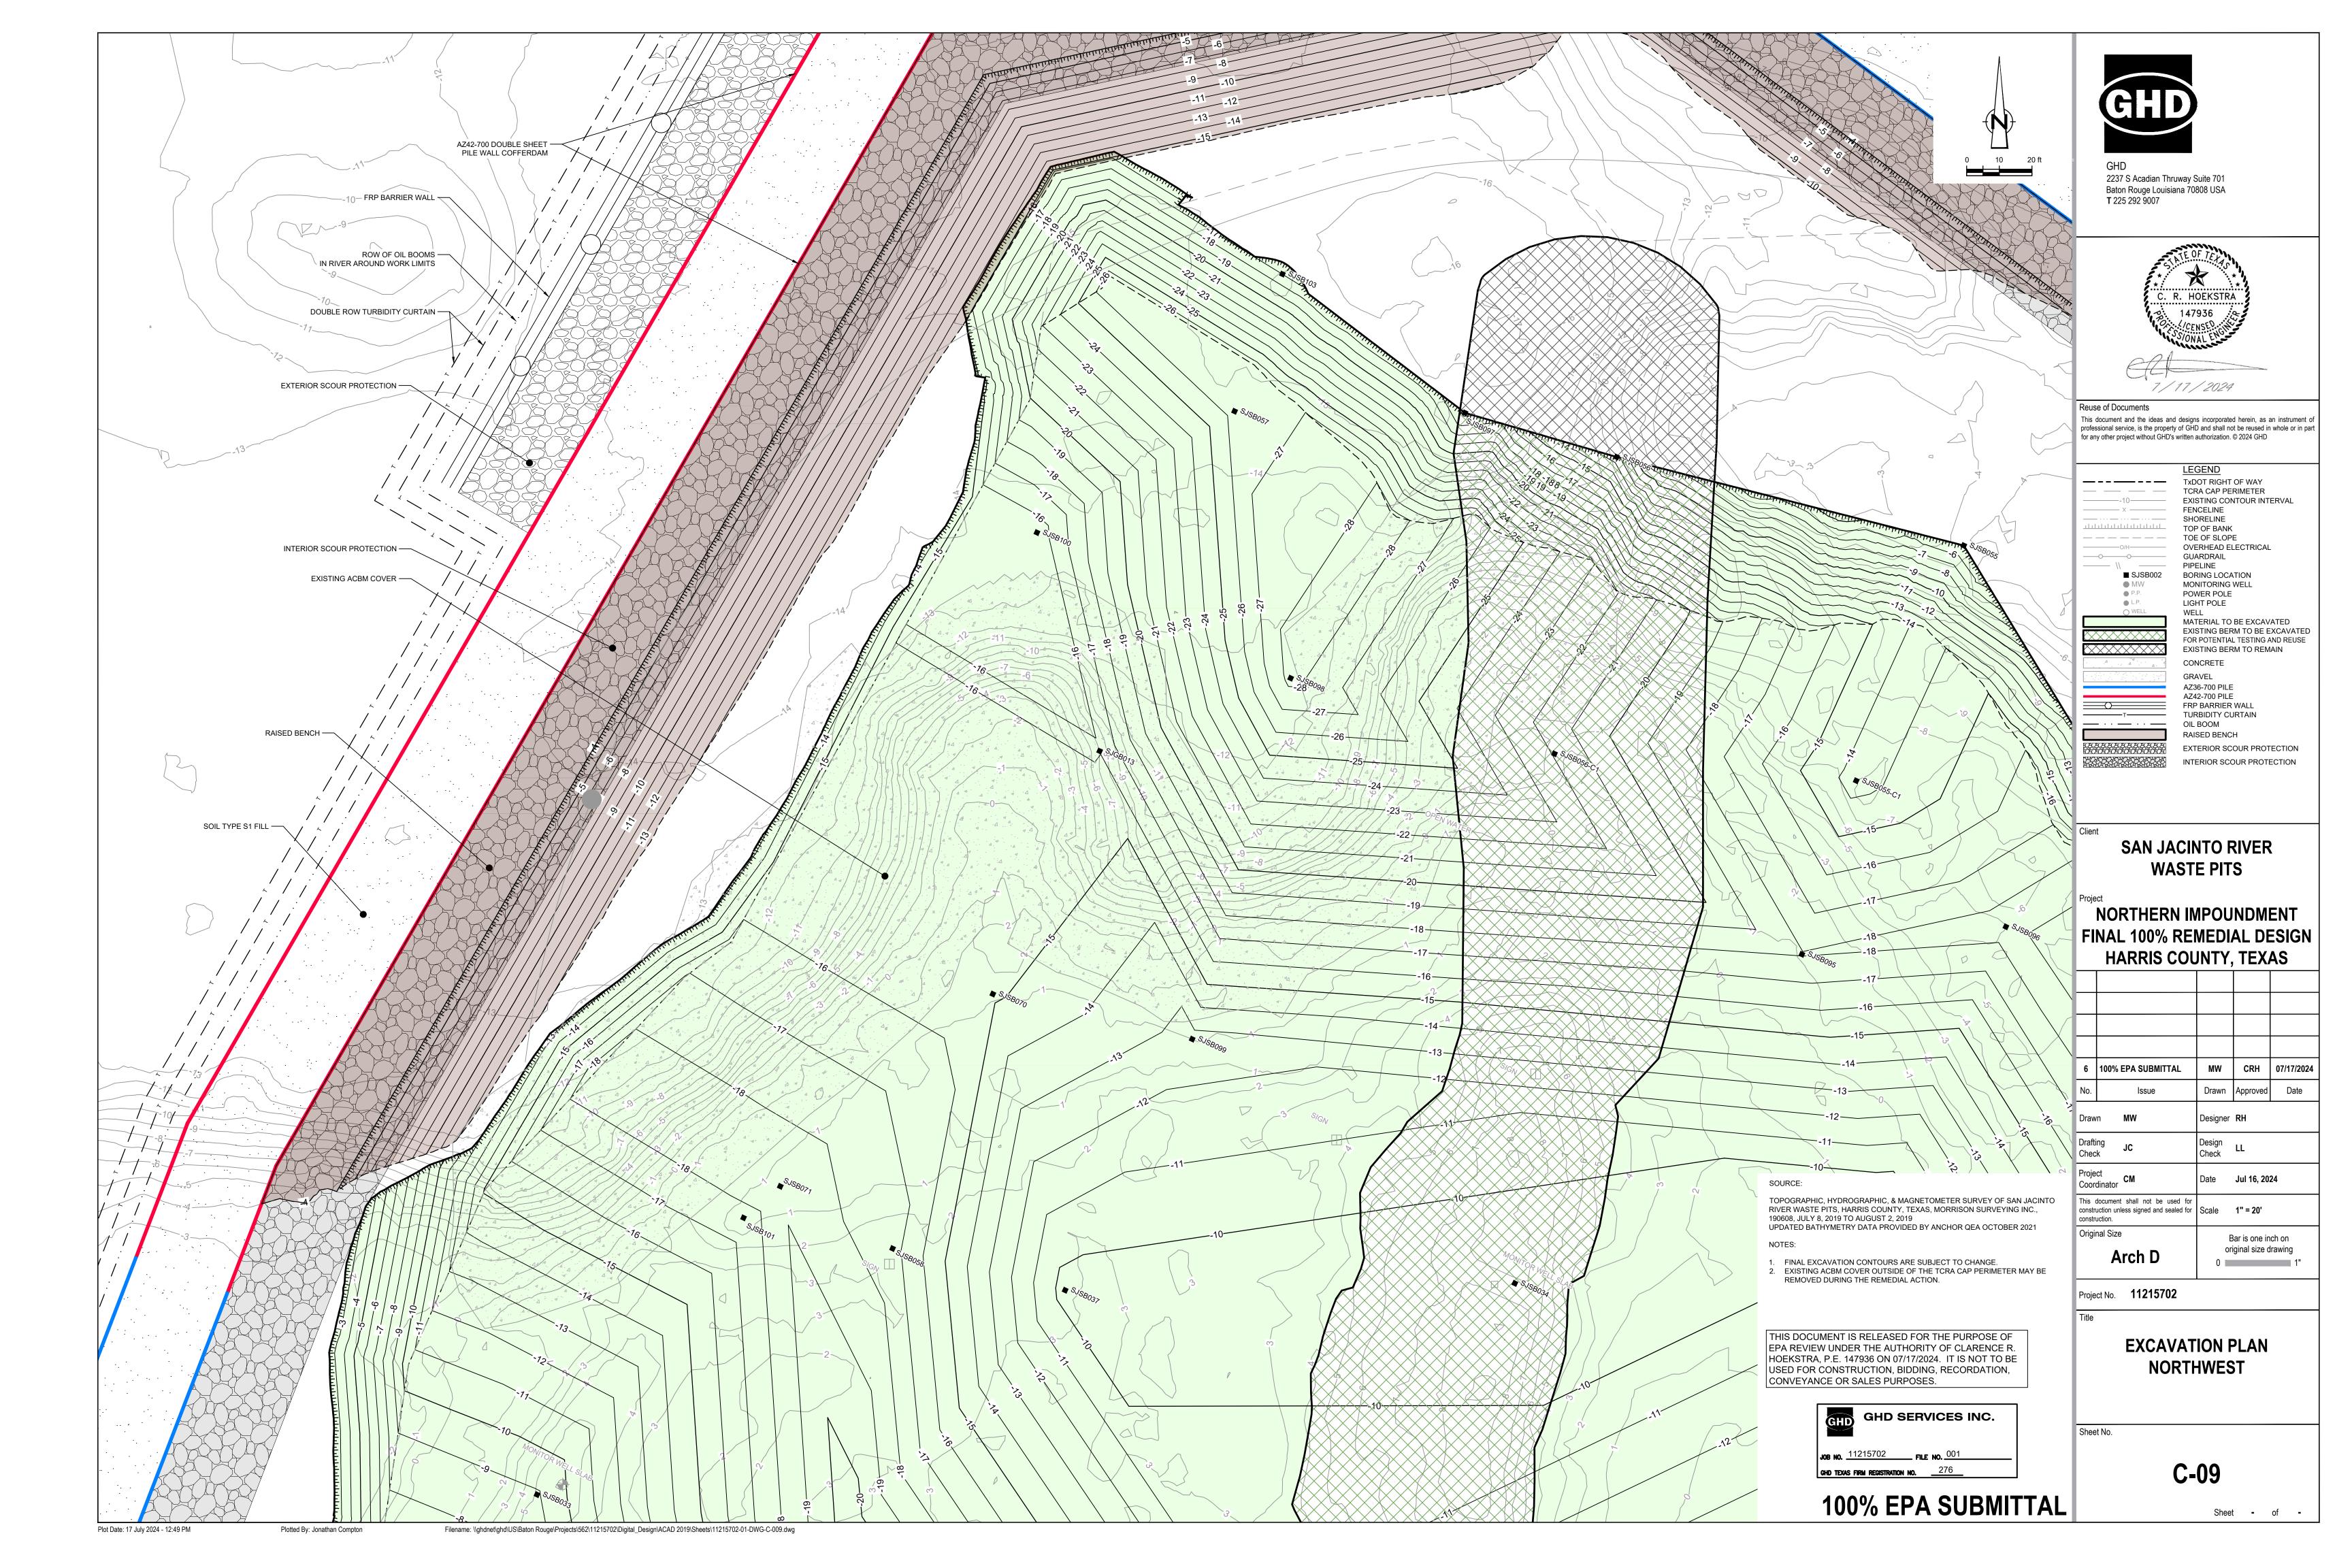


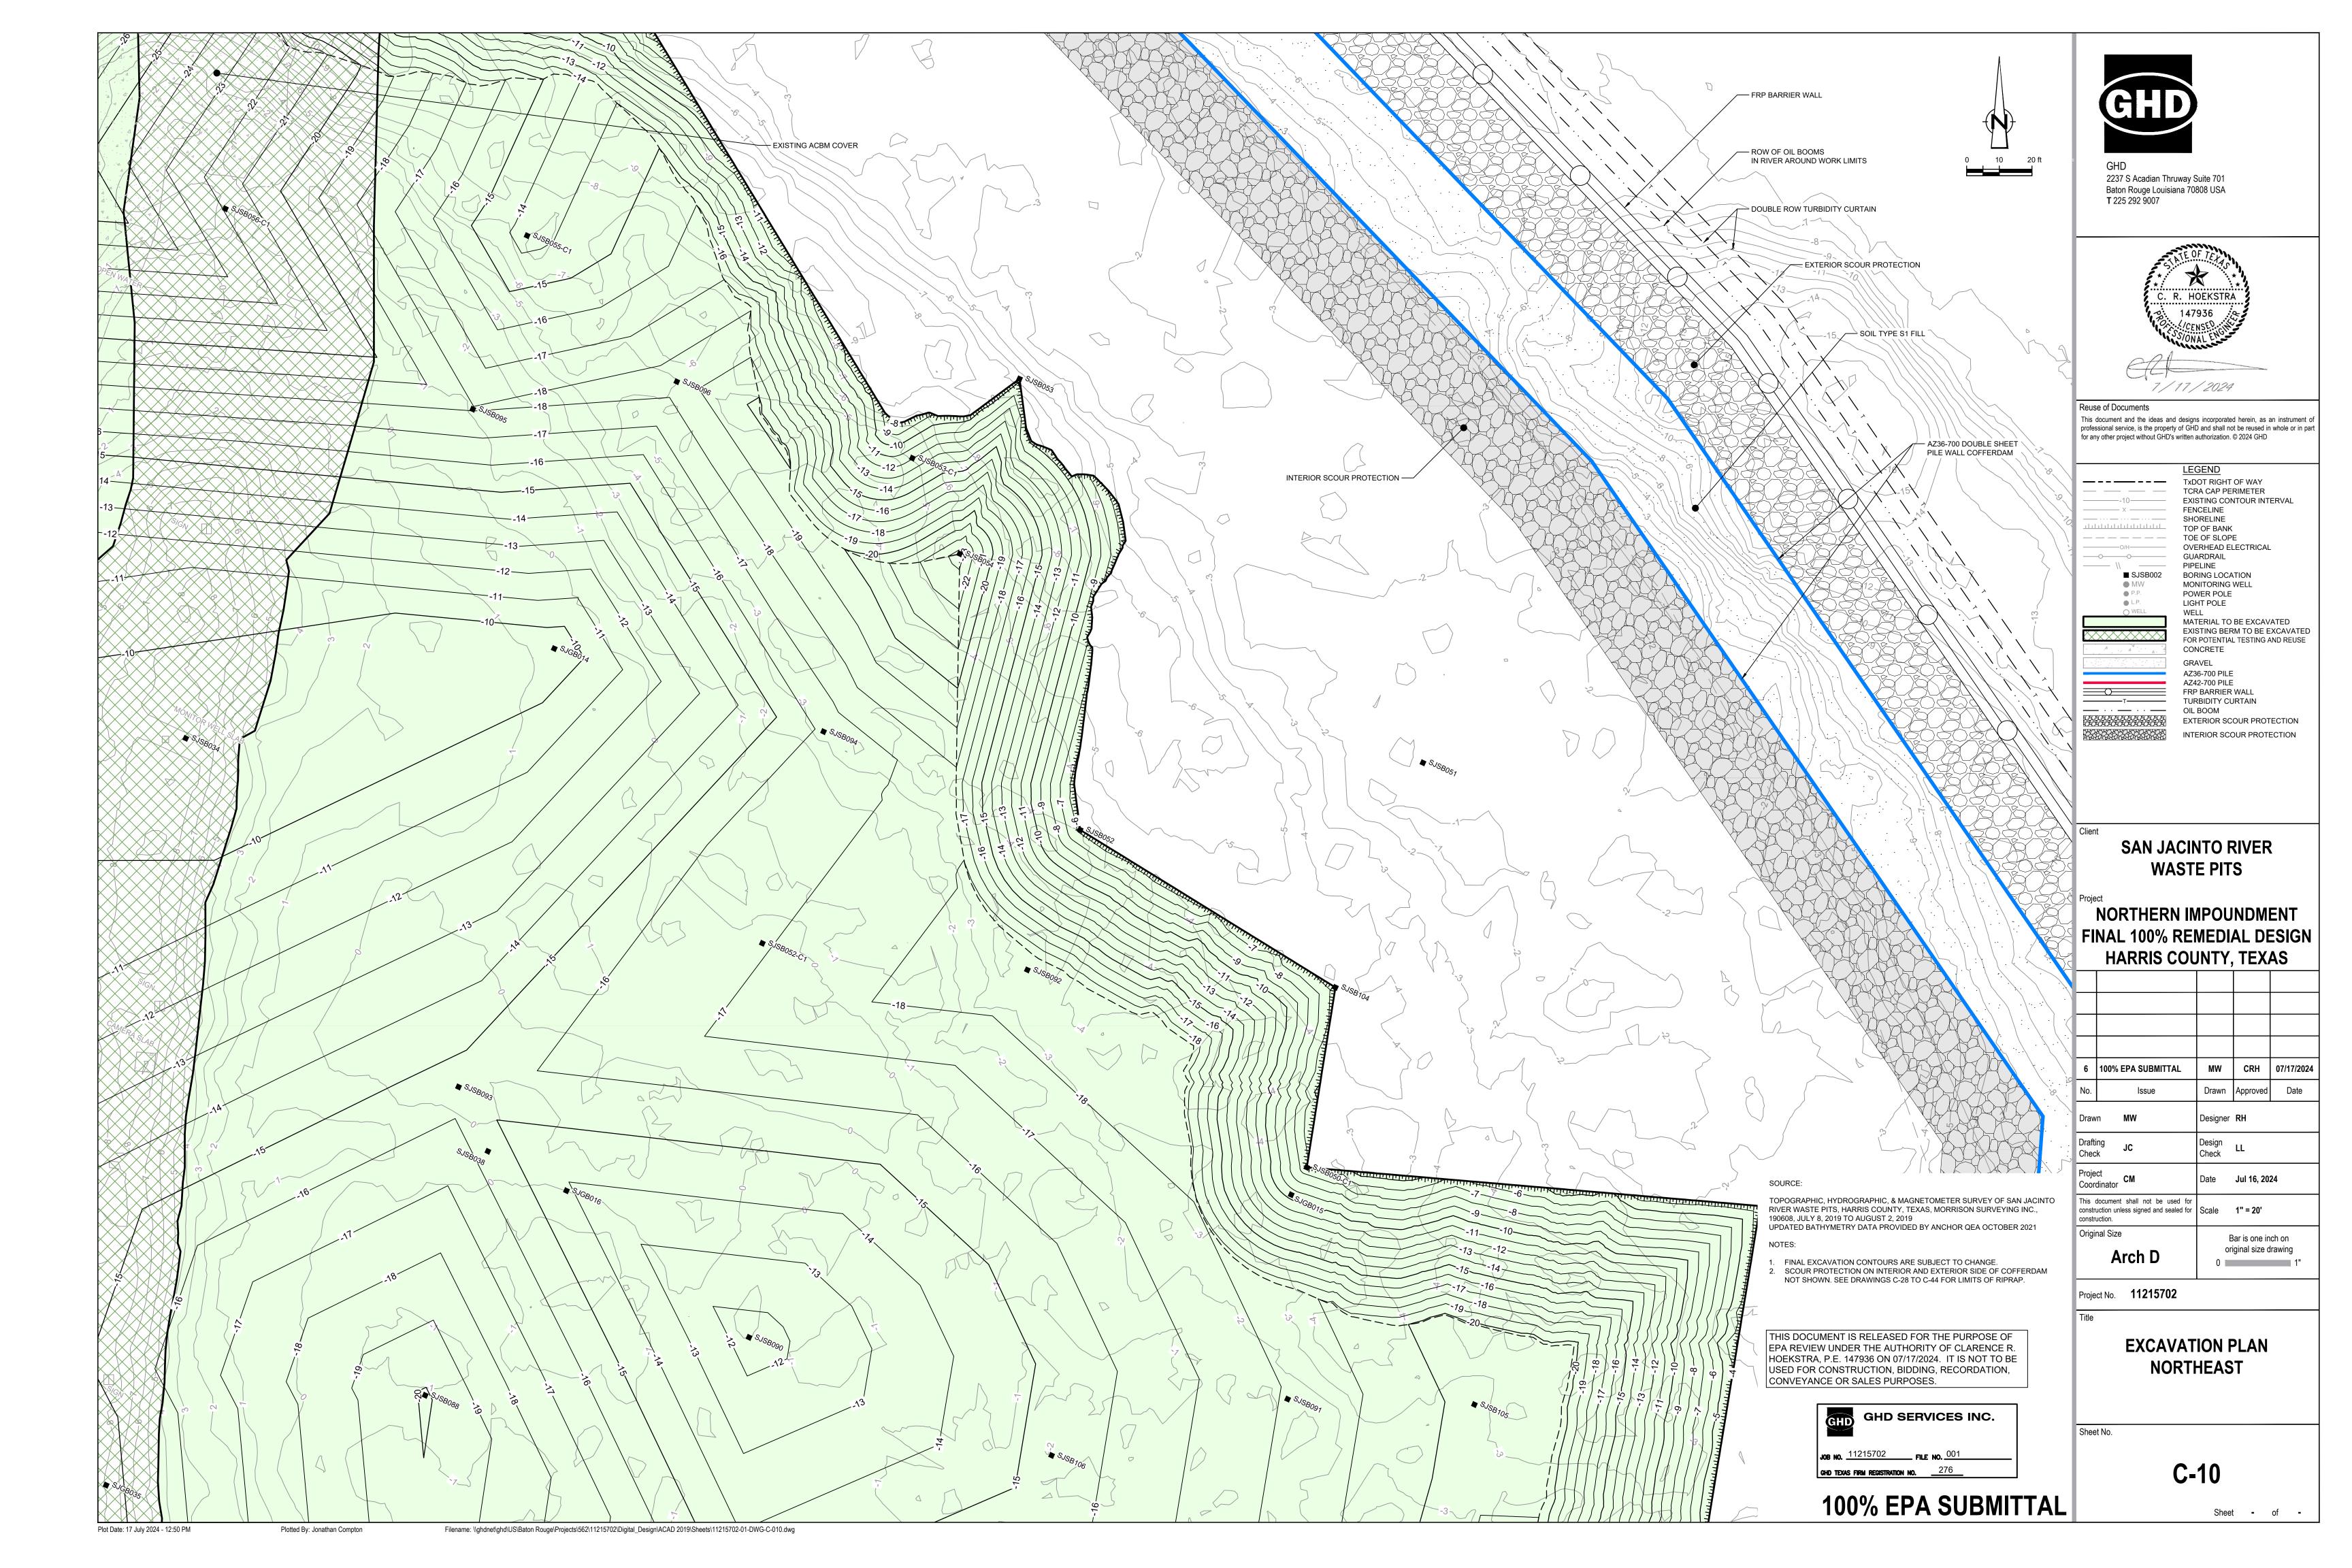

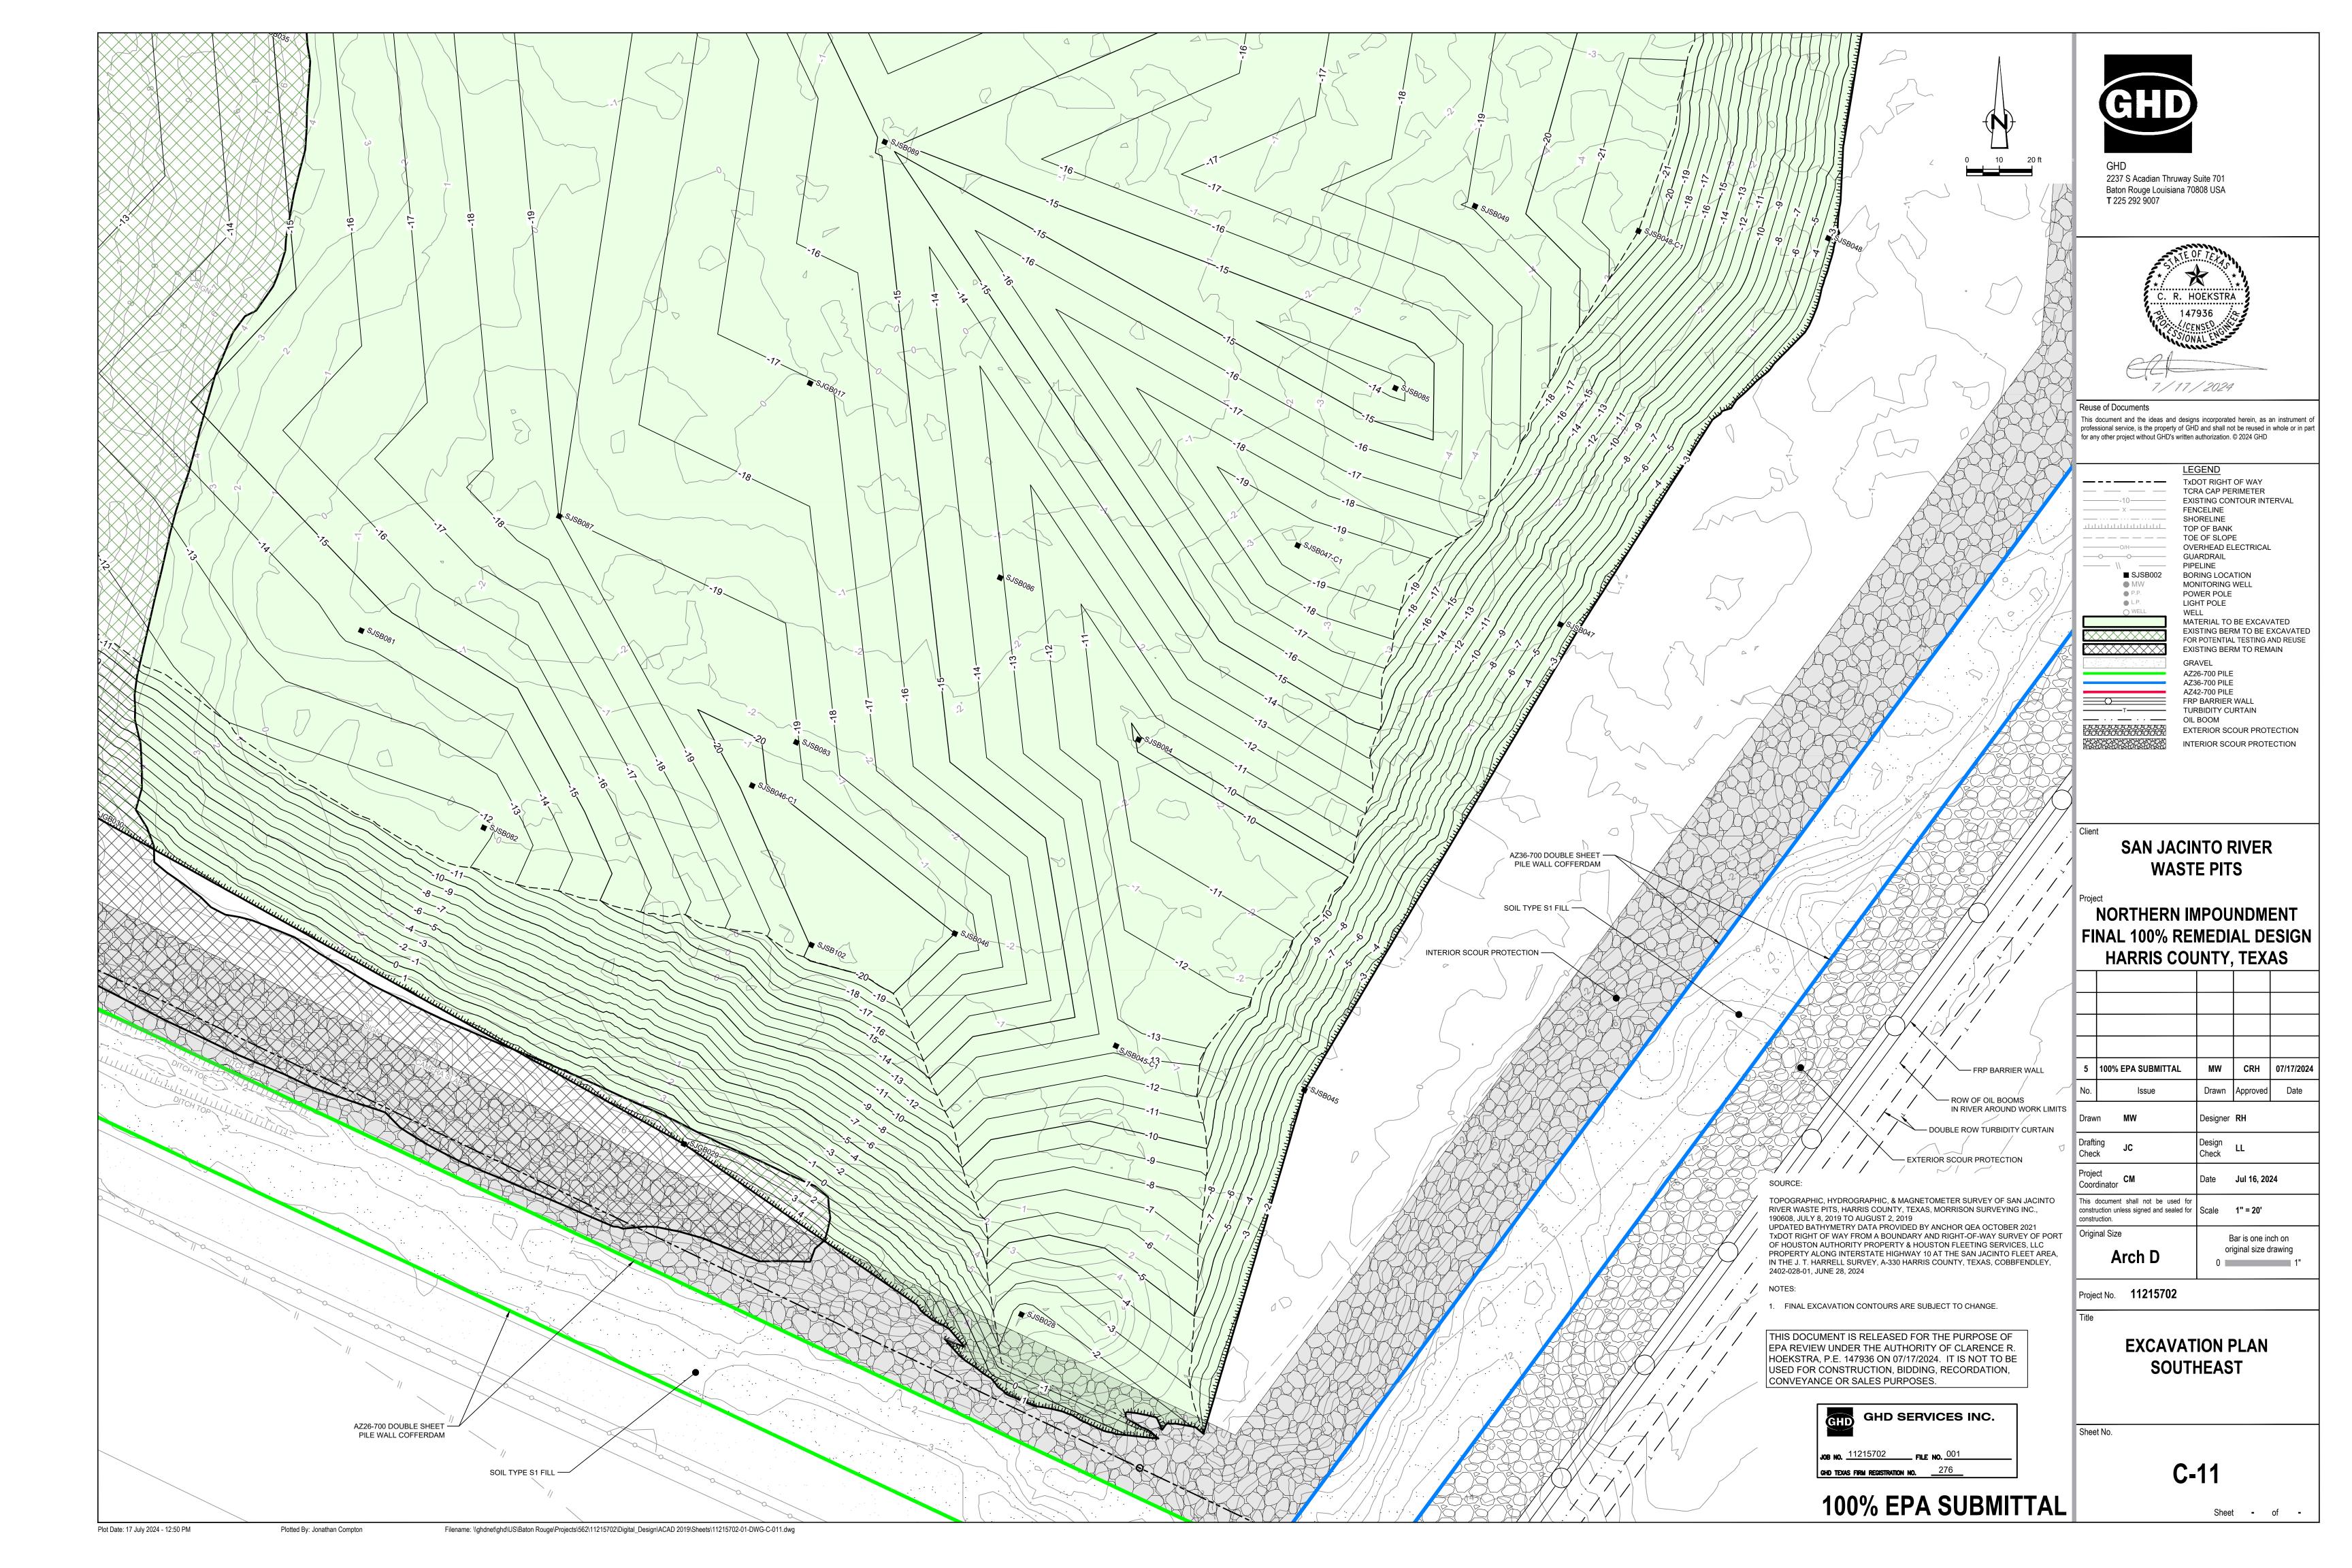

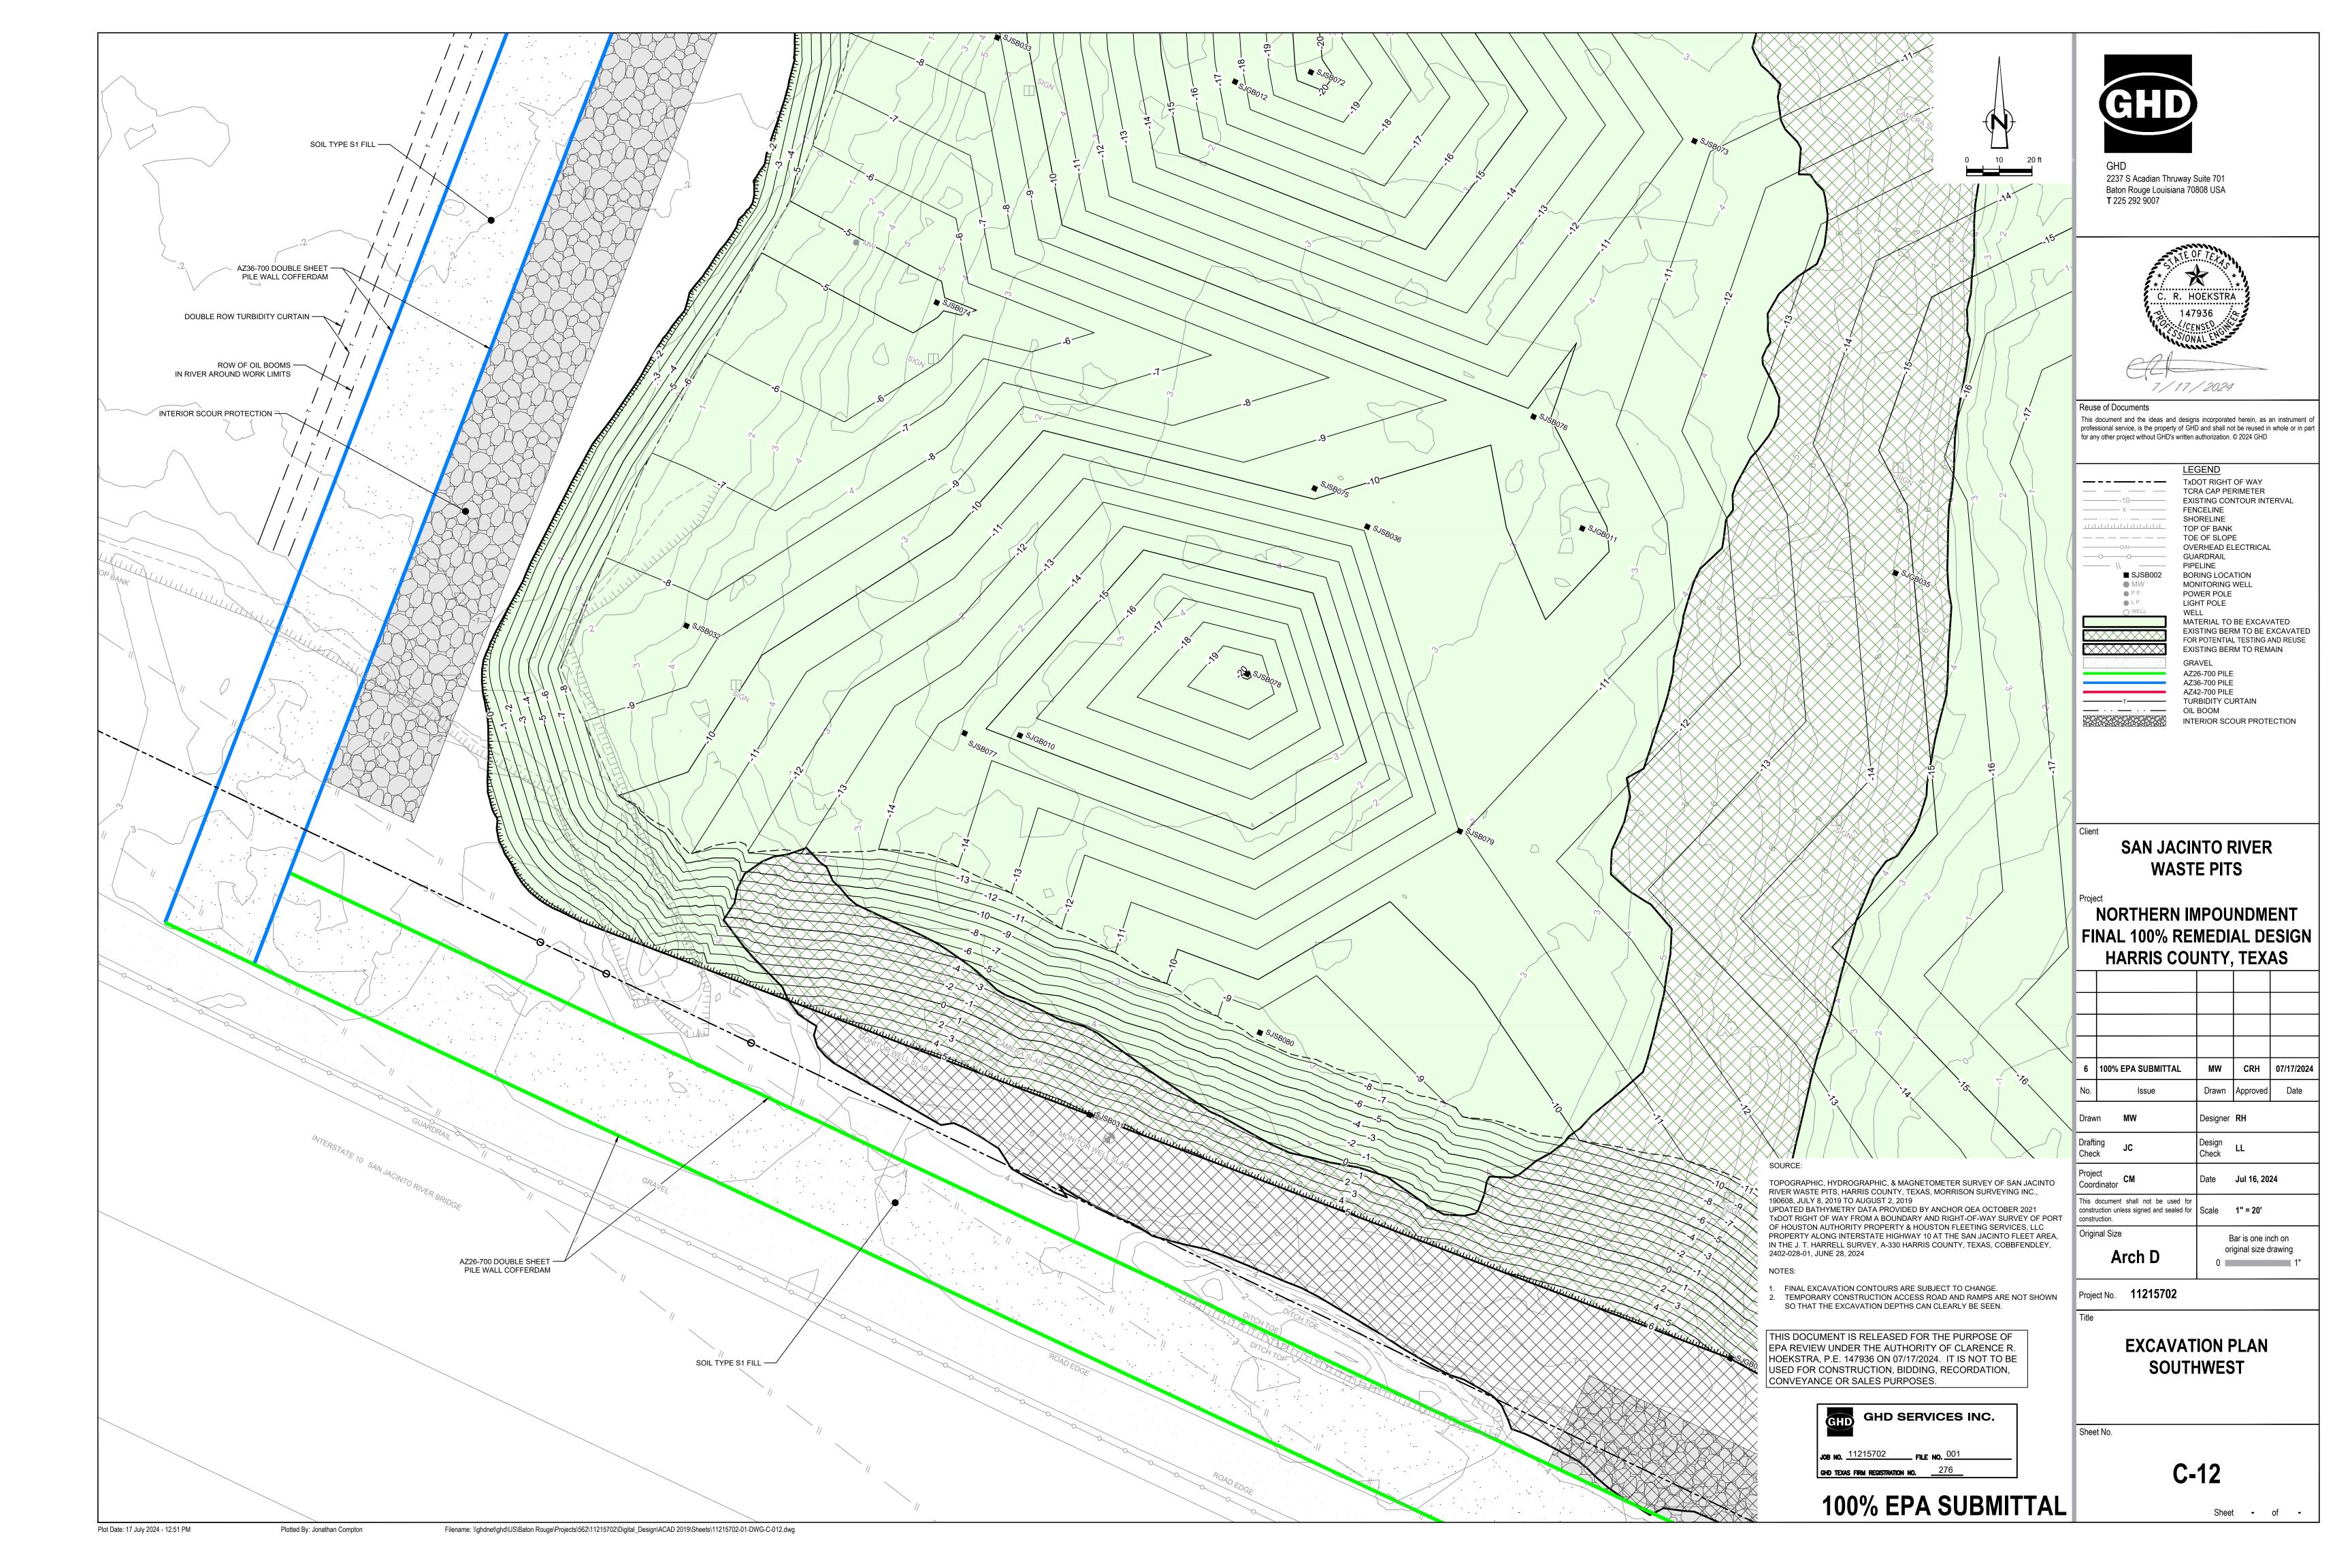


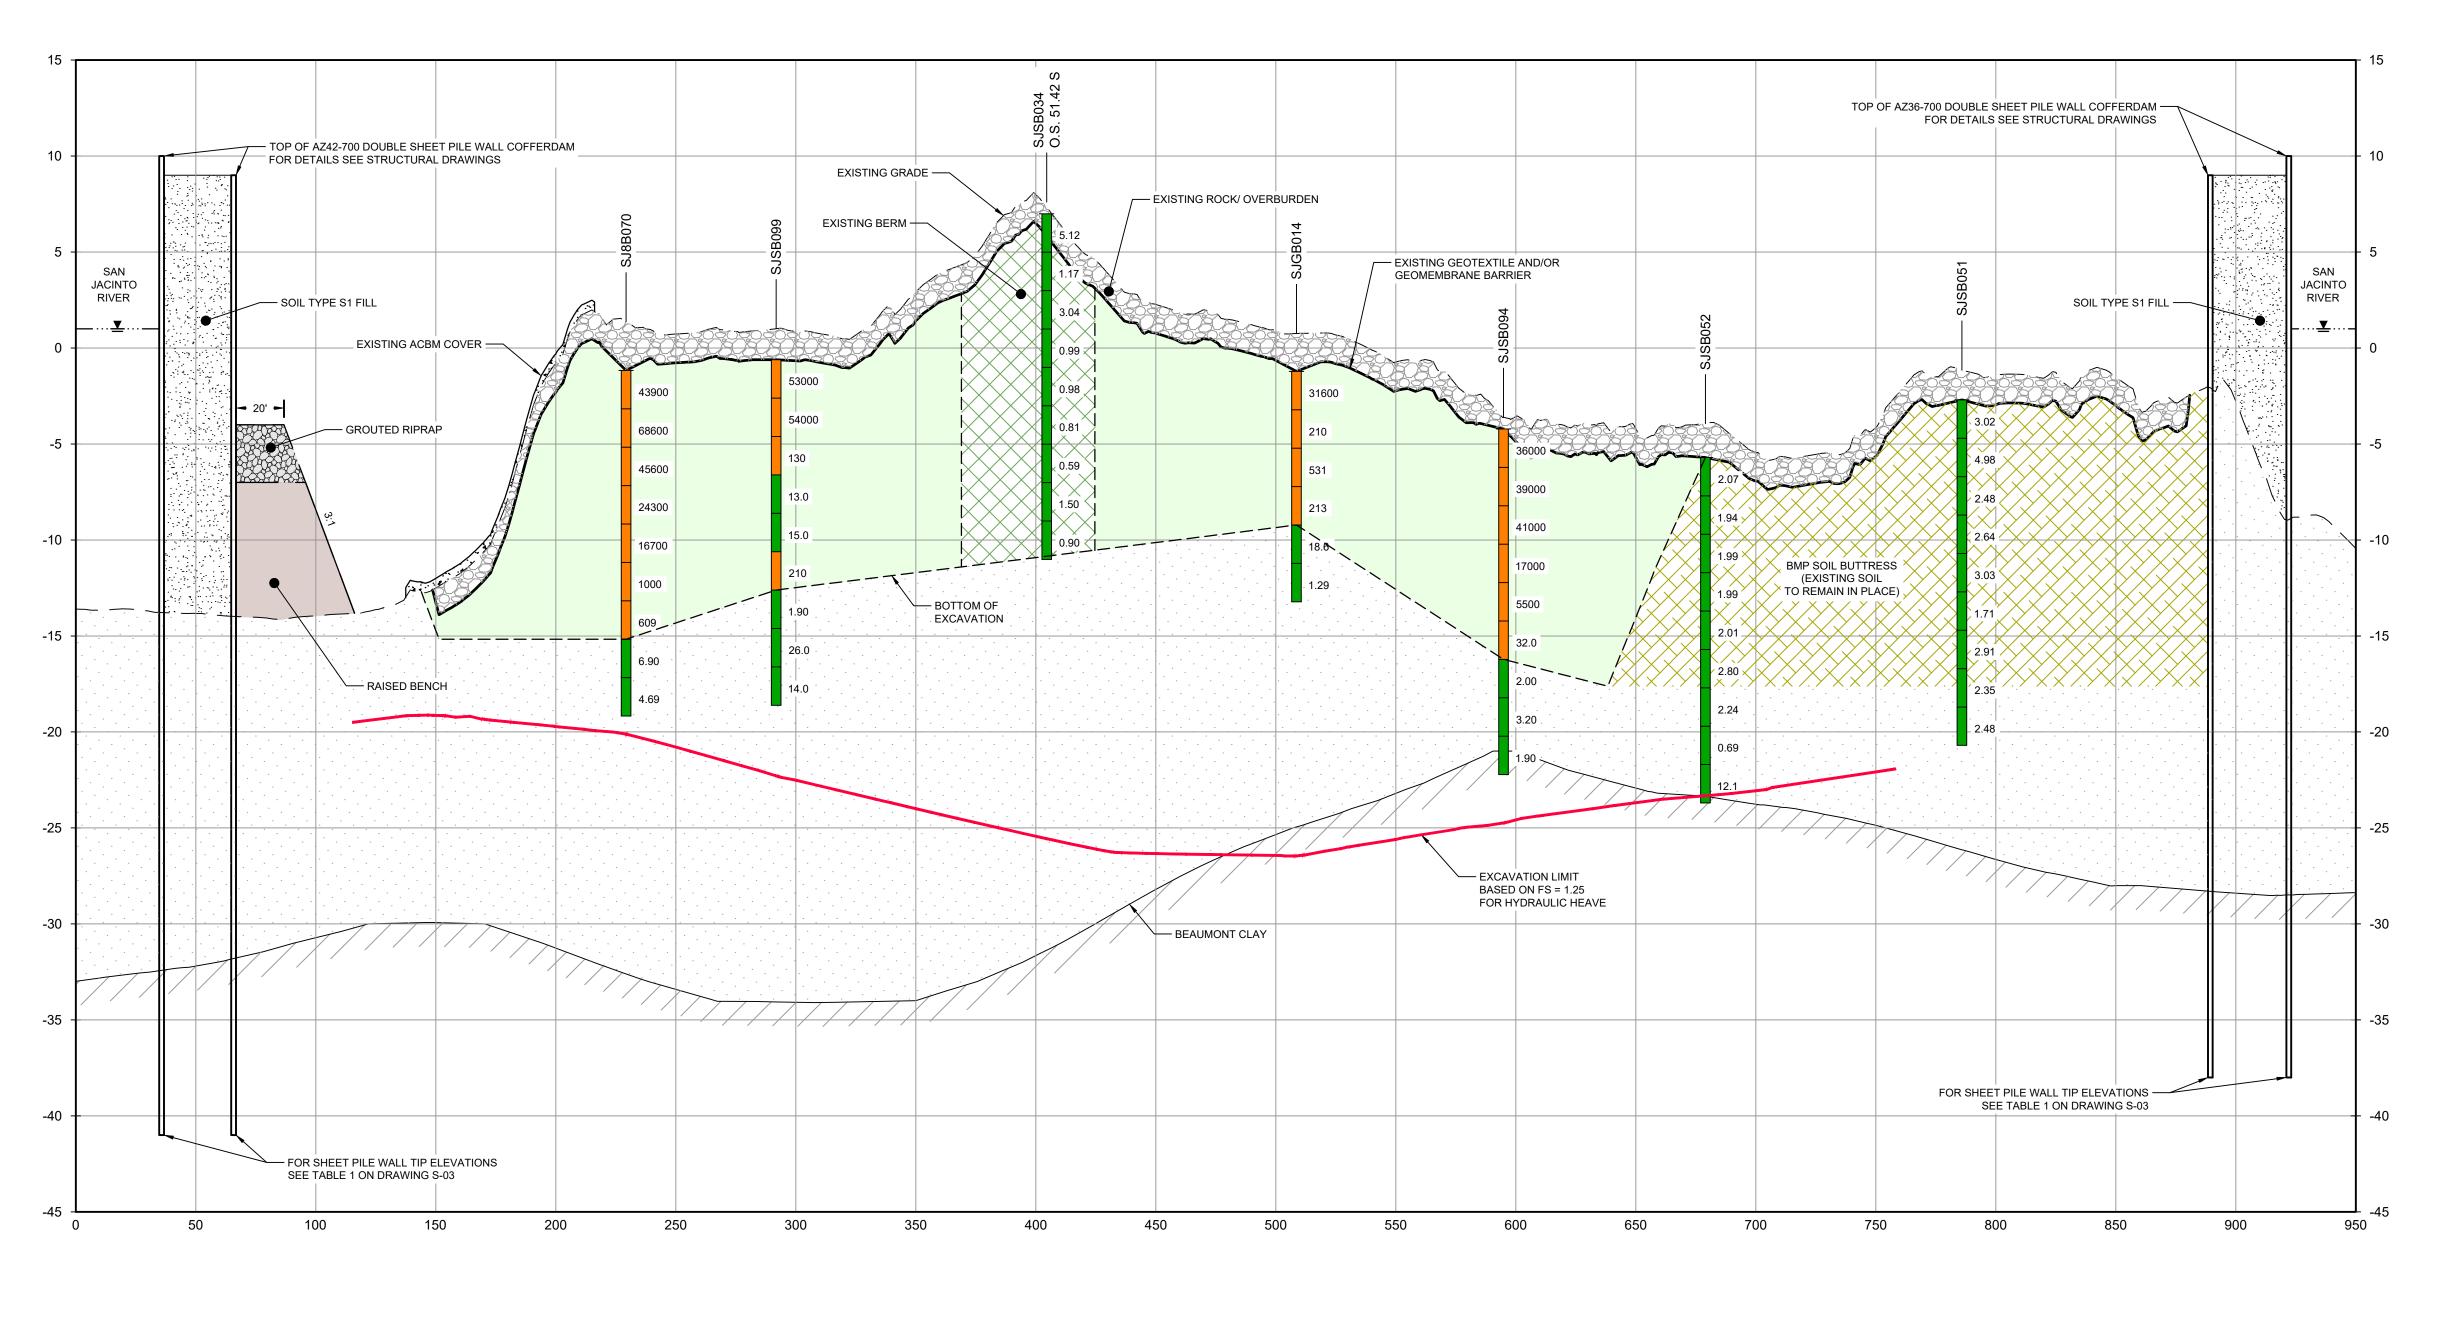

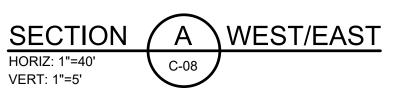

BOTTOM OF EXCAVATION IS SUBJECT TO CHANGE.
 SCOUR PROTECTION ON INTERIOR AND EXTERIOR SIDE OF COFFERDAM NOT SHOWN. SEE DRAWINGS C-28 TO C-44 FOR LIMITS OF RIPRAP.

THIS DOCUMENT IS RELEASED FOR THE PURPOSE OF EPA REVIEW UNDER THE AUTHORITY OF CLARENCE R. HOEKSTRA, P.E. 147936 ON 07/17/2024. IT IS NOT TO BE USED FOR CONSTRUCTION, BIDDING, RECORDATION, CONVEYANCE OR SALES PURPOSES.

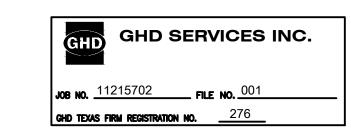

100% EPA SUBMITTAL



2237 S Acadian Thruway Suite 701 Baton Rouge Louisiana 70808 USA **T** 225 292 9007



Reuse of Documents

This document and the ideas and designs incorporated herein, as an instrument of professional service, is the property of GHD and shall not be reused in whole or in part for any other project without GHD's written authorization. © 2024 GHD

> SOILS WITH CONCENTRATIONS <30 ng/kg TEQ_{DF,M} TCDD SOILS WITH CONCENTRATIONS

>30 ng/kg TEQ_{DF,M} TCDD

EXCAVATION LIMIT BASED ON FS = 1.25 FOR HYDRAULIC HEAVE MATERIAL TO BE EXCAVATED EXISTING BERM TO BE EXCAVATED FOR POTENTIAL TESTING AND REUSE BMP SOIL BUTTRESS (EXISTING SOIL TO REMAIN IN PLACE) INTERIOR SCOUR PROTECTION

RAISED BENCH

SAN JACINTO RIVER WASTE PITS

NORTHERN IMPOUNDMENT FINAL 100% REMEDIAL DESIGN HARRIS COUNTY, TEXAS

6	100% EPA SUBMITTAL	MW	CRH	07/17/20
No.	Issue	Drawn	Approved	Date
Draw	n MW	Designer	RH	
Drafti Chec	• .IC.	Design Check	LL	
Proje Coord	ct dinator CM	Date	Jul 16, 202	24
	document shall not be used for uction unless signed and sealed for uction.	Scale	AS SHOW	'N

Original Size Bar is one inch on original size drawing Arch D

Project No. **11215702**

EXCAVATION SECTION 1 OF 6

Sheet No.


C-13

Sheet - of -

Plot Date: 17 July 2024 - 12:51 PM

Plotted By: Jonathan Compton


Filename: \\ghd\uS\Baton Rouge\Projects\562\11215702\Digital_Design\ACAD 2019\Sheets\11215702-01-DWG-C-013.dwg

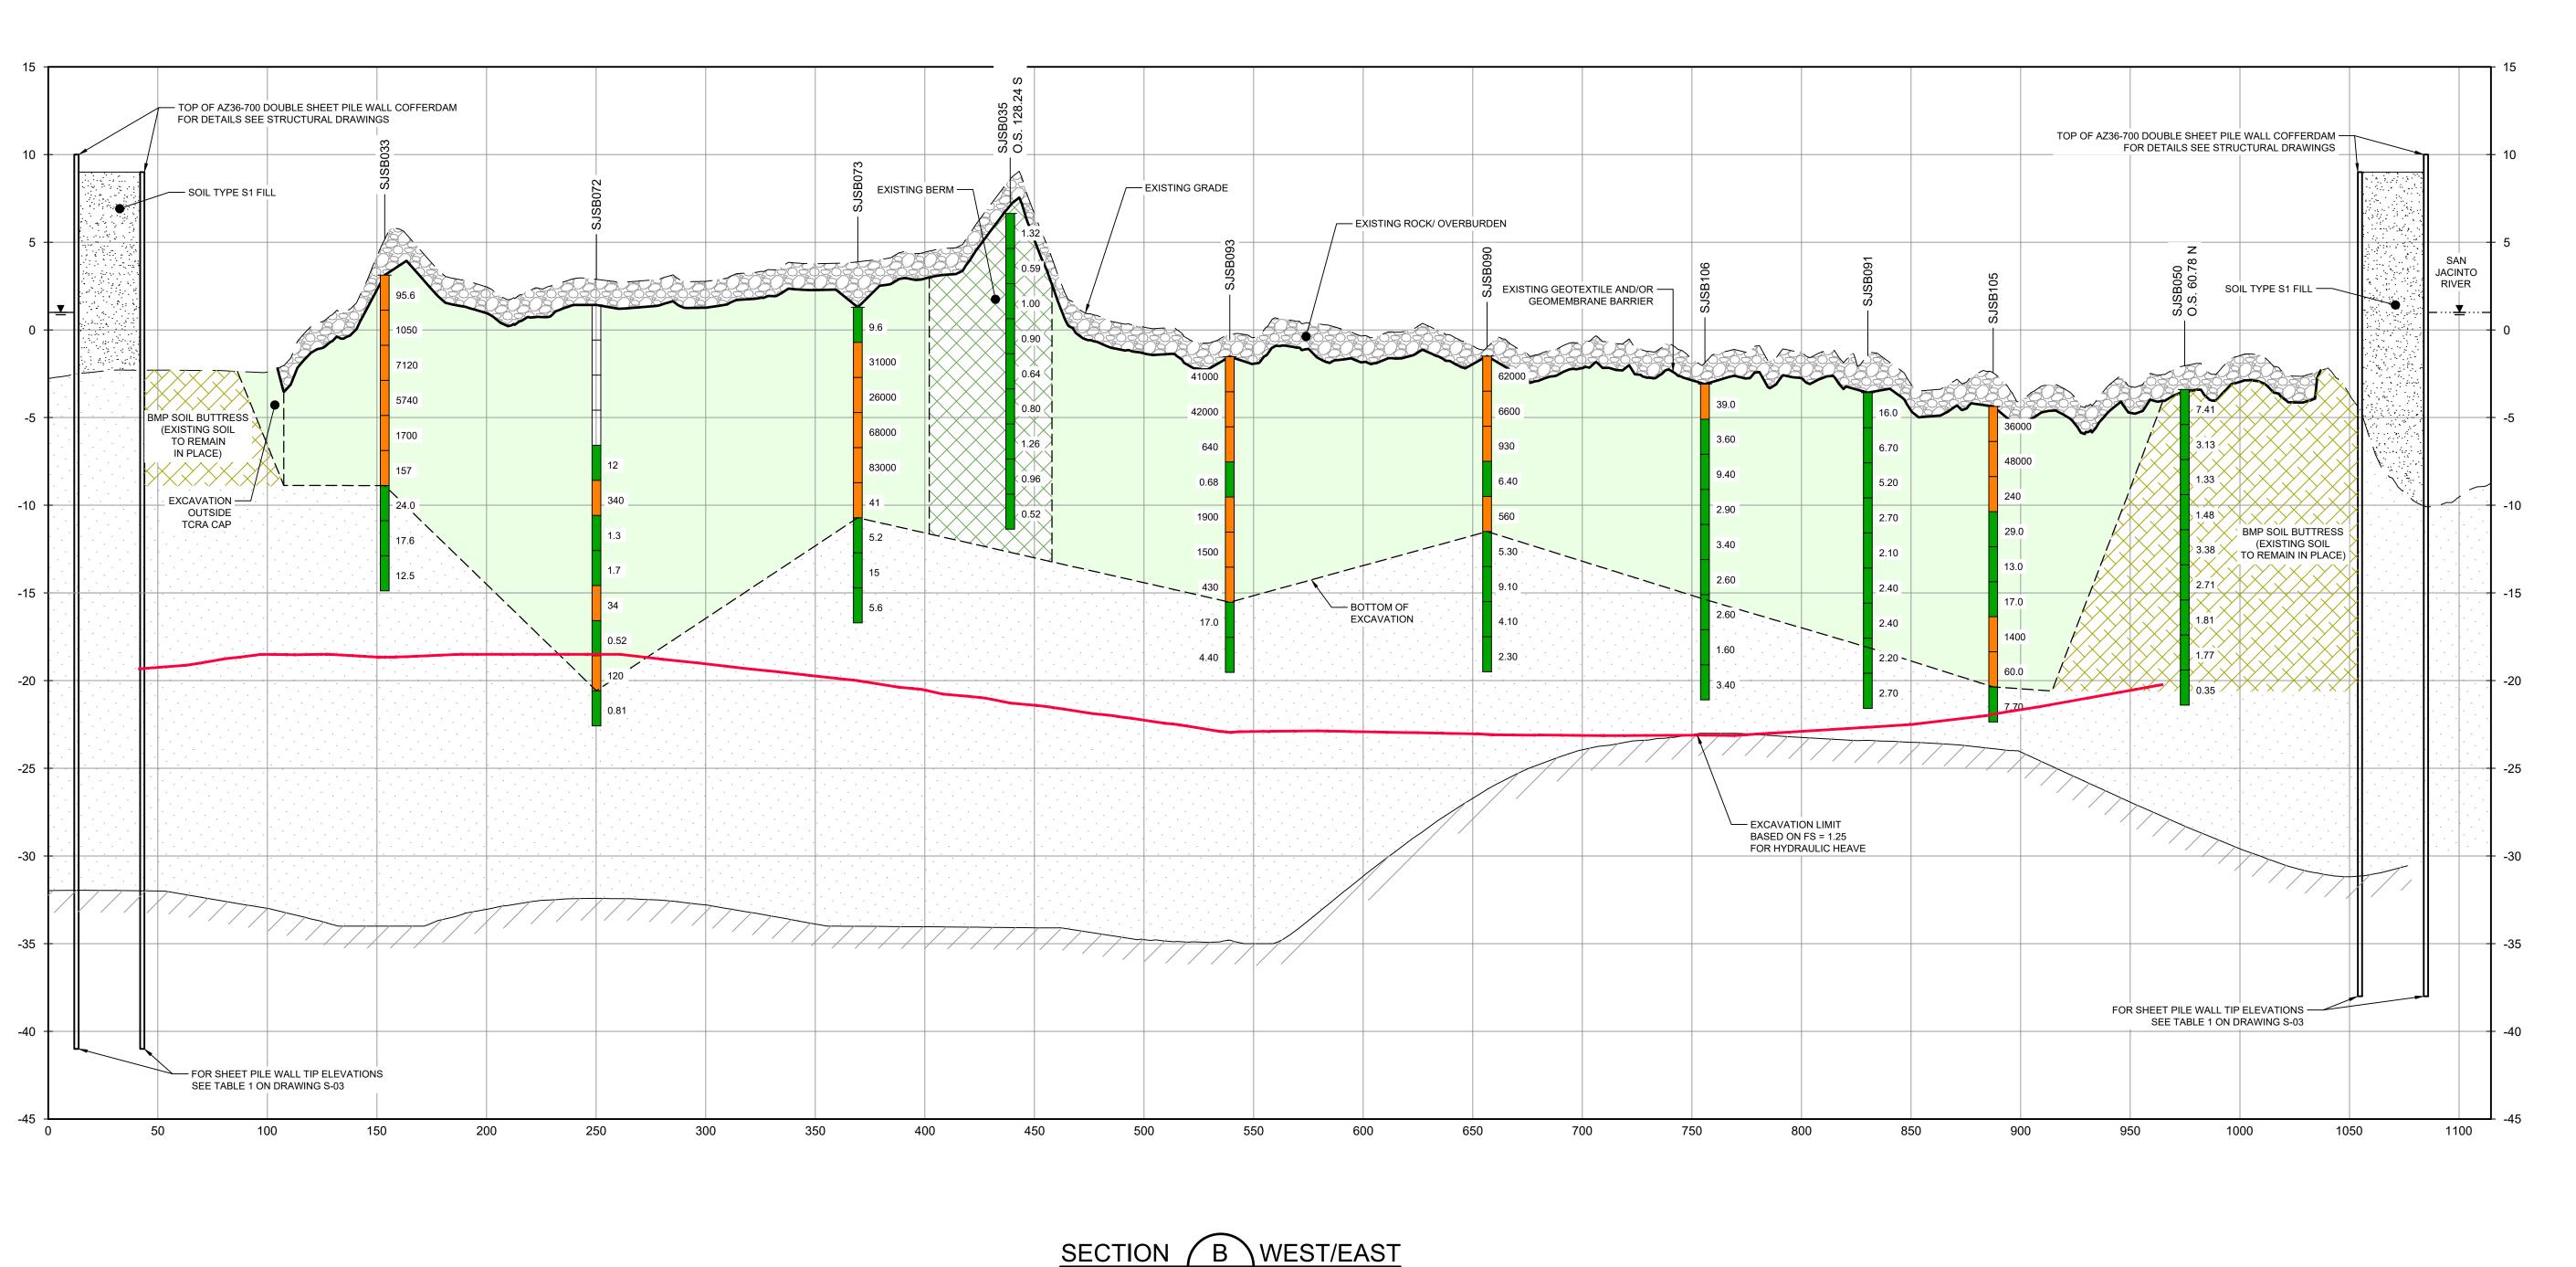

C-08

VERT: 1"=5'

2237 S Acadian Thruway Suite 701 Baton Rouge Louisiana 70808 USA **T** 225 292 9007

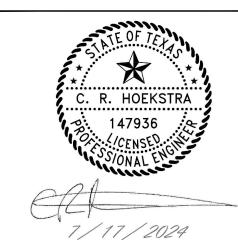

Reuse of Documents


This document and the ideas and designs incorporated herein, as an instrument of professional service, is the property of GHD and shall not be reused in whole or in part for any other project without GHD's written authorization. © 2024 GHD

SOILS WITH CONCENTRATIONS <30 ng/kg TEQ_{DF,M} TCDD SOILS WITH CONCENTRATIONS >30 ng/kg TEQ_{DF,M} TCDD

EXCAVATION LIMIT BASED ON FS = 1.25 FOR HYDRAULIC HEAVE MATERIAL TO BE EXCAVATED EXISTING BERM TO BE EXCAVATED FOR POTENTIAL TESTING AND REUSE BMP SOIL BUTTRESS (EXISTING SOIL TO REMAIN IN PLACE)

SAN JACINTO RIVER WASTE PITS

NORTHERN IMPOUNDMENT FINAL 100% REMEDIAL DESIGN HARRIS COUNTY, TEXAS

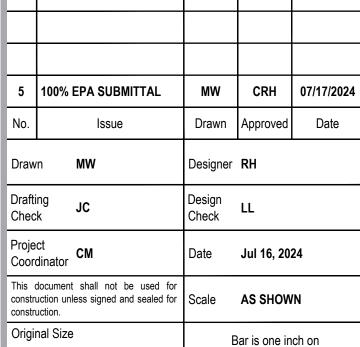

Arch D

Project No. **11215702**

EXCAVATION SECTION 2 OF 6

original size drawing

0 1"


Sheet - of -

Sheet No.


C-14

BOTTOM OF EXCAVATION IS SUBJECT TO CHANGE.
 SCOUR PROTECTION ON INTERIOR AND EXTERIOR SIDE OF COFFERDAM NOT SHOWN. SEE DRAWINGS C-28 TO C-44 FOR LIMITS OF RIPRAP.

THIS DOCUMENT IS RELEASED FOR THE PURPOSE OF EPA REVIEW UNDER THE AUTHORITY OF CLARENCE R. HOEKSTRA, P.E. 147936 ON 07/17/2024. IT IS NOT TO BE USED FOR CONSTRUCTION, BIDDING, RECORDATION, CONVEYANCE OR SALES PURPOSES.

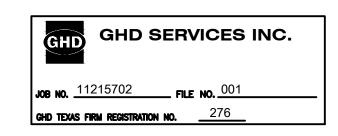

100% EPA SUBMITTAL

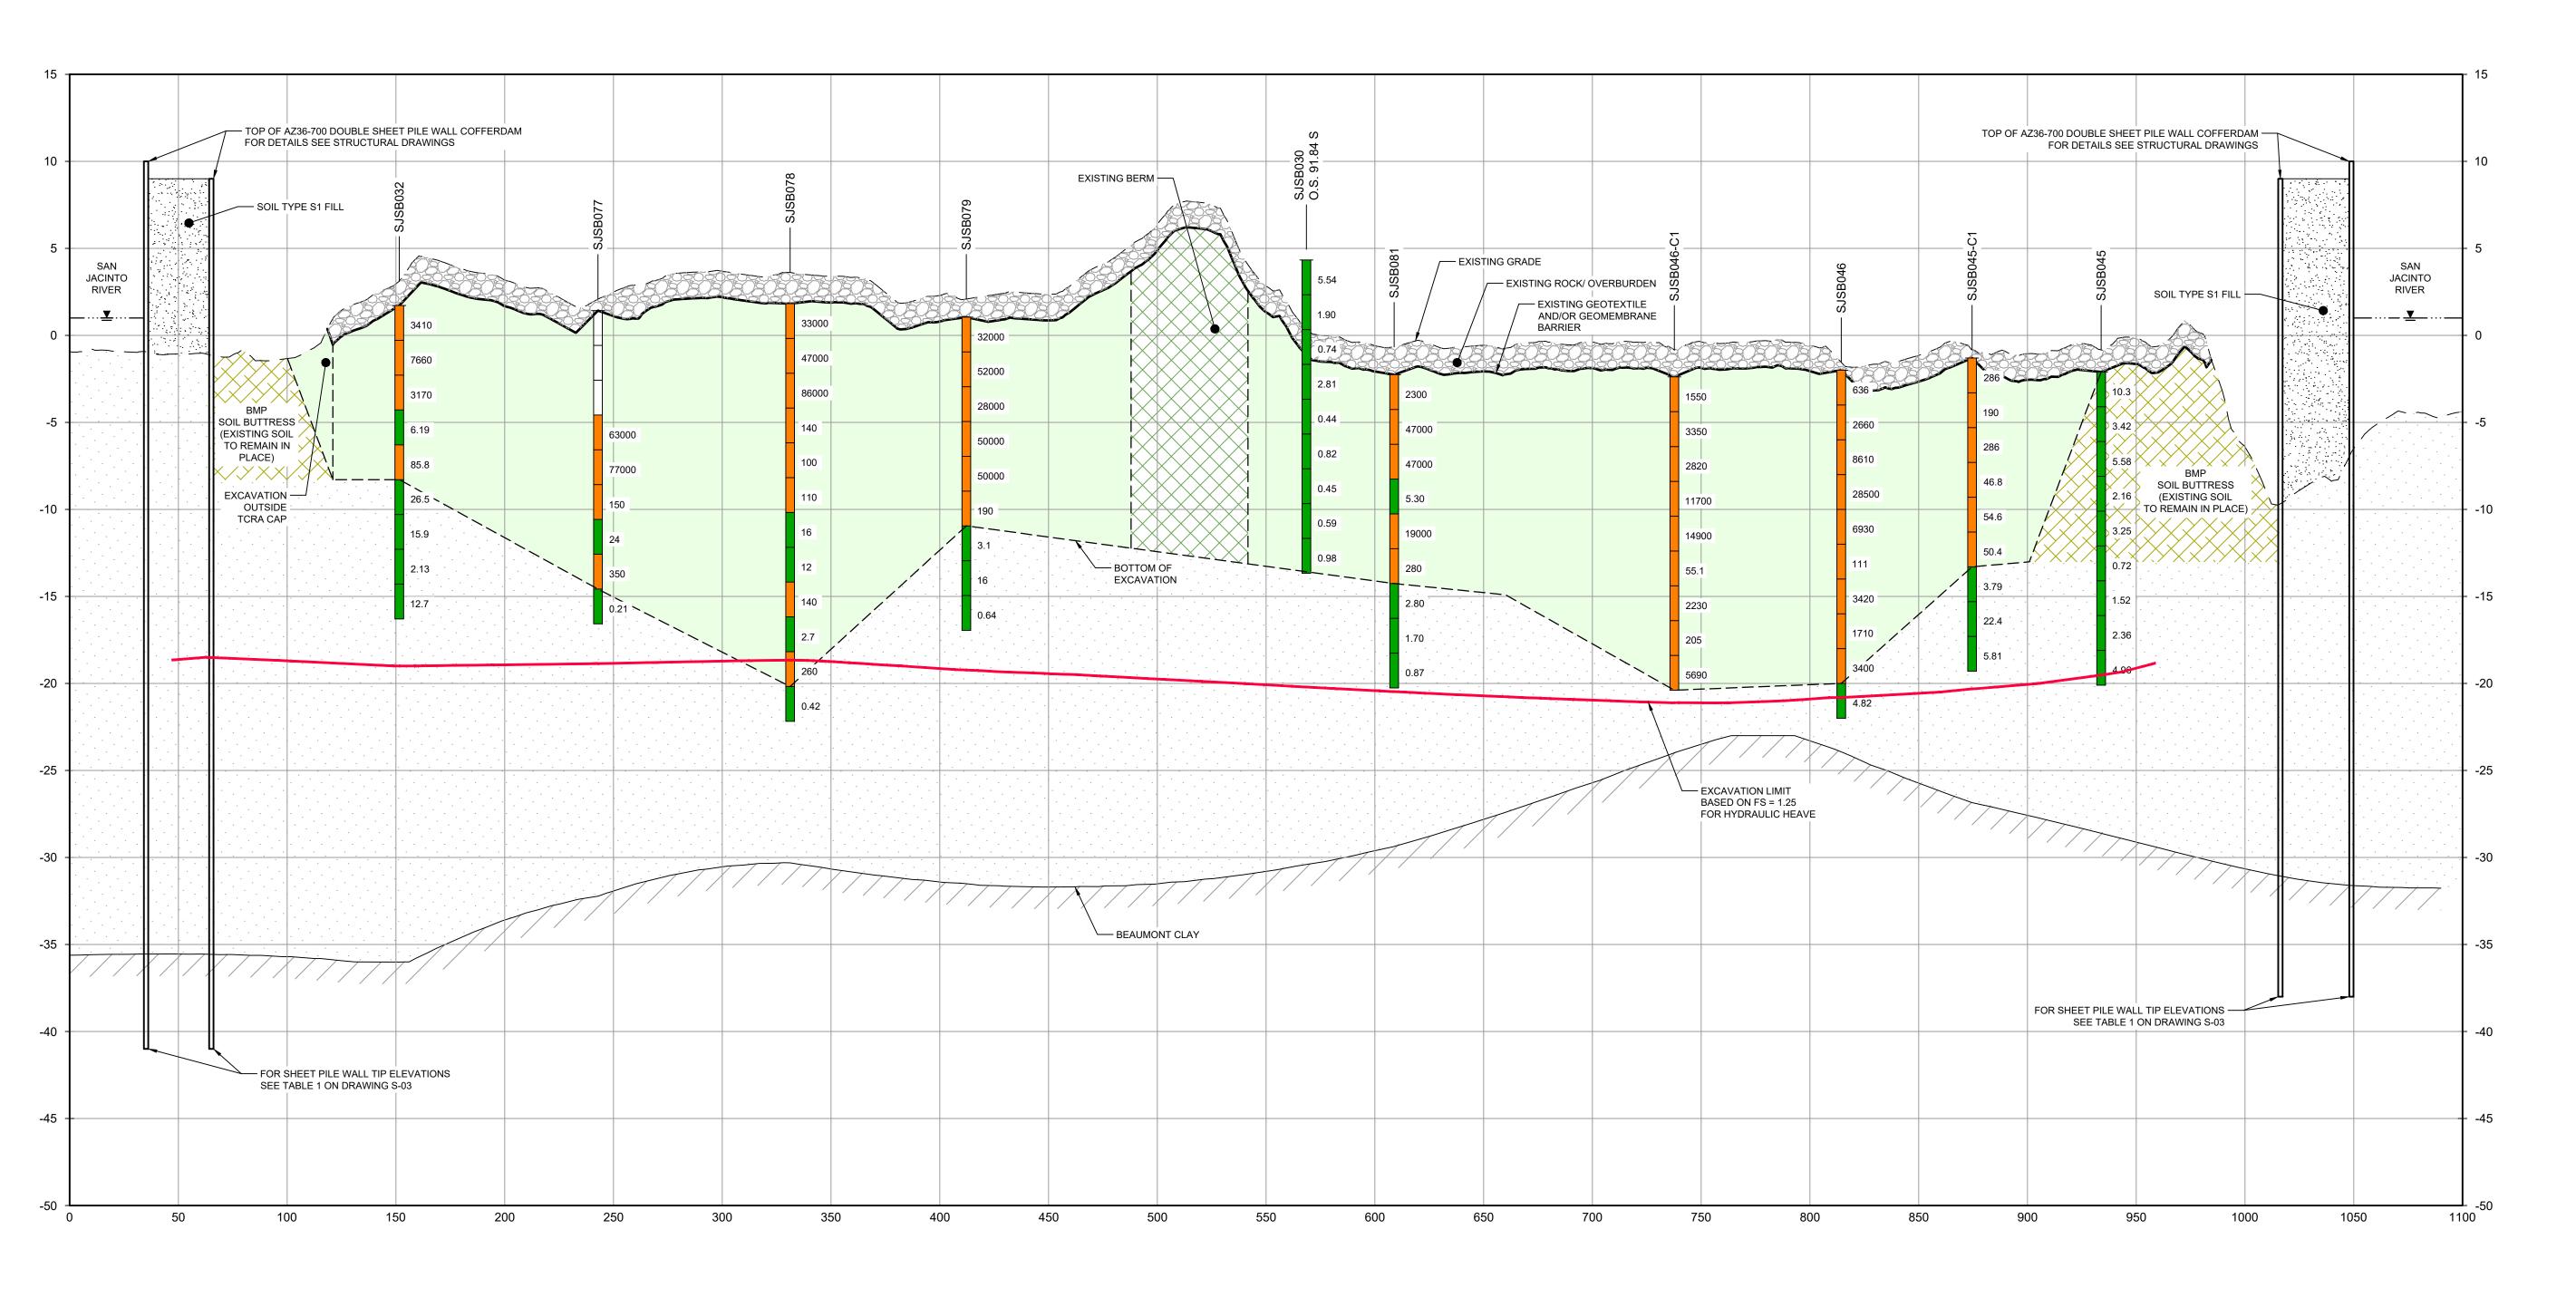


SECTION C WEST/EAST
HORIZ: 1"=40'
VERT: 1"=5'

NOTES:

 BOTTOM OF EXCAVATION IS SUBJECT TO CHANGE.
 SCOUR PROTECTION ON INTERIOR AND EXTERIOR SIDE OF COFFERDAM NOT SHOWN. SEE DRAWINGS C-28 TO C-44 FOR LIMITS OF RIPRAP.

THIS DOCUMENT IS RELEASED FOR THE PURPOSE OF EPA REVIEW UNDER THE AUTHORITY OF CLARENCE R. HOEKSTRA, P.E. 147936 ON 07/17/2024. IT IS NOT TO BE USED FOR CONSTRUCTION, BIDDING, RECORDATION, CONVEYANCE OR SALES PURPOSES.

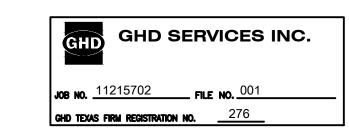

100% EPA SUBMITTAL



GHD
2237 S Acadian Thruway Suite 701
Baton Rouge Louisiana 70808 USA
T 225 292 9007



Reuse of Documents

This document and the ideas and designs incorporated herein, as an instrument of professional service, is the property of GHD and shall not be reused in whole or in part for any other project without GHD's written authorization. © 2024 GHD

LEGE SOILS <30 ng/ SOILS

SOILS WITH CONCENTRATIONS
<30 ng/kg TEQ_{DF,M} TCDD

SOILS WITH CONCENTRATIONS
>30 ng/kg TEQ_{DF,M} TCDD

EXCAVATION LIMIT BASED ON
FS = 1.25 FOR HYDRAULIC HEAVE
MATERIAL TO BE EXCAVATED

EXISTING BERM TO BE EXCAVATED

TO REMAIN IN PLACE)

FOR POTENTIAL TESTING AND REUSE

BMP SOIL BUTTRESS (EXISTING SOIL

SAN JACINTO RIVER WASTE PITS

NORTHERN IMPOUNDMENT FINAL 100% REMEDIAL DESIGN HARRIS COUNTY, TEXAS

_				
5	100% EPA SUBMITTAL	MW	CRH	07/17/
No.	Issue	Drawn	Approved	Dat
Draw	n MW	Designer	RH	
Drafti Chec	· .l(.	Design Check	LL	
Proje Coor	ct dinator CM	Date	Jul 16, 20	24
	document shall not be used for uction unless signed and sealed for uction.	Scale	AS SHOW	/N

Original Size

Arch D

Project No. **11215702**

Title

EXCAVATION SECTION 3 OF 6

Sheet No.

C-15


Sheet - of -

Bar is one inch on original size drawing

Plot Date: 17 July 2024 - 12:51 PM Plotted By:

Plotted By: Jonathan Compton

Filename: \\ghdnet\ghd\US\Baton Rouge\Projects\562\11215702\Digital_Design\ACAD 2019\Sheets\11215702-01-DWG-C-013.dwg

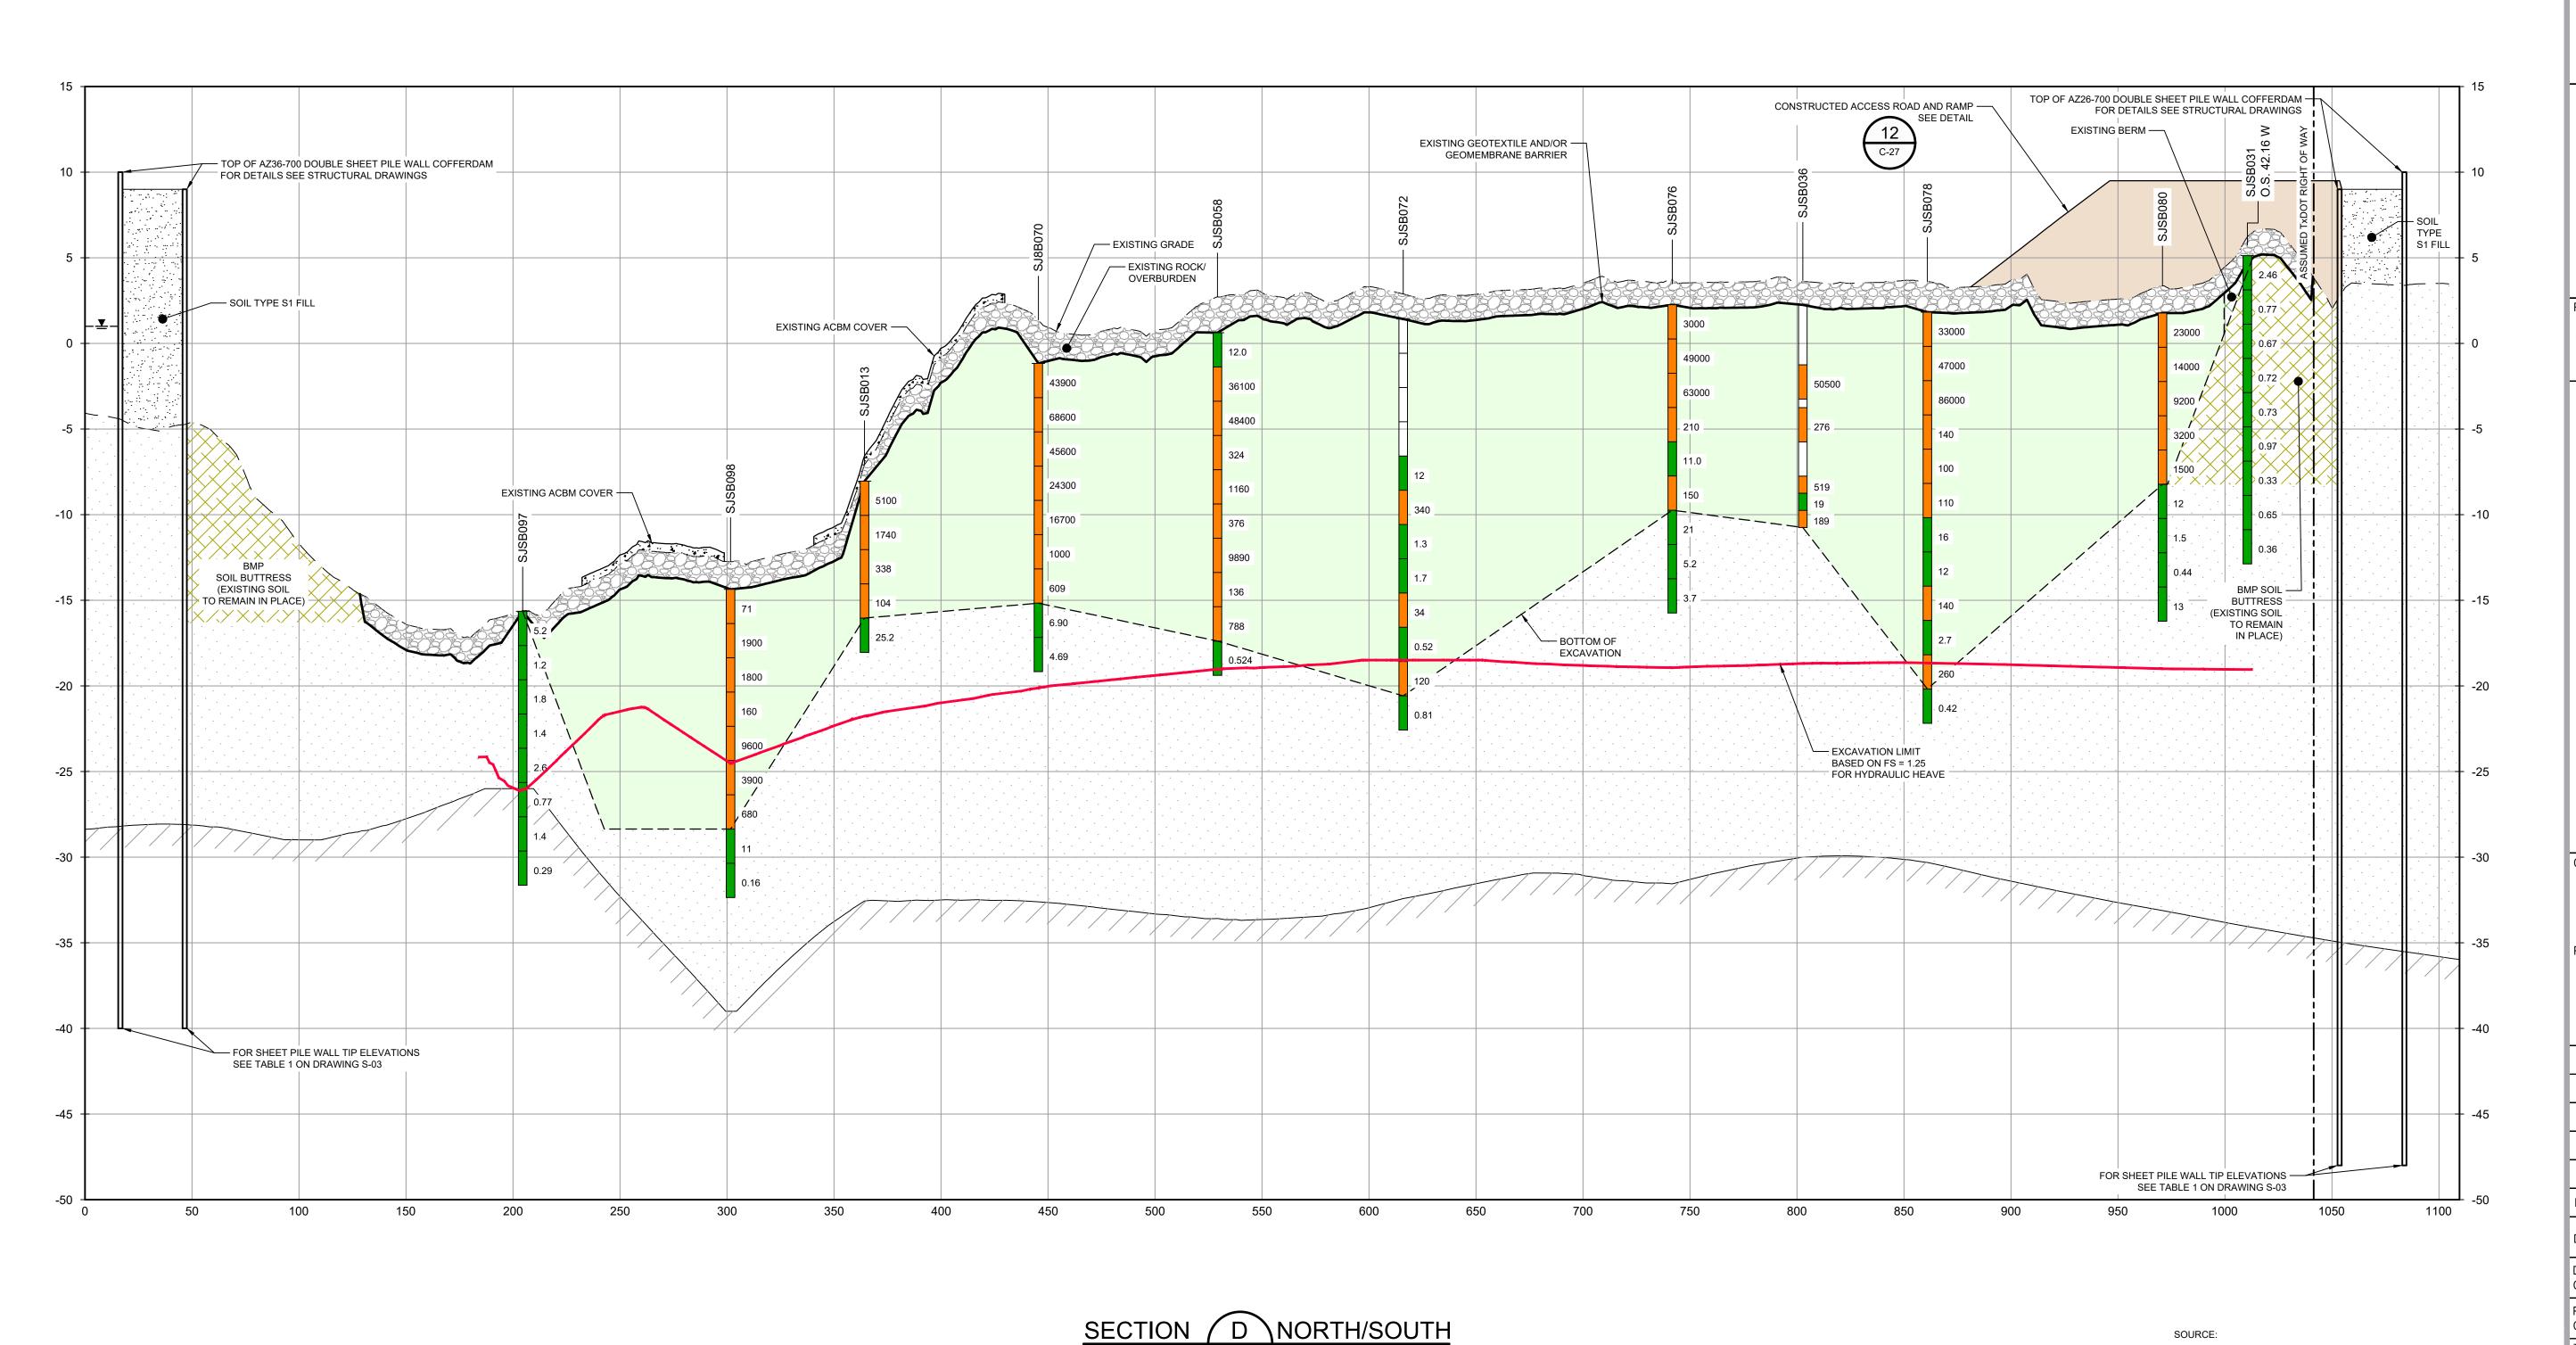

C-08

VERT: 1"=5'


SOURCE:

TXDOT RIGHT OF WAY FROM A BOUNDARY AND RIGHT-OF-WAY SURVEY OF PORT OF HOUSTON AUTHORITY PROPERTY & HOUSTON FLEETING SERVICES, LLC PROPERTY ALONG INTERSTATE HIGHWAY 10 AT THE SAN JACINTO FLEET AREA, IN THE J. T. HARRELL SURVEY, A-330 HARRIS COUNTY, TEXAS, COBBFENDLEY, 2402-028-01, JUNE 28, 2024

1. BOTTOM OF EXCAVATION IS SUBJECT TO CHANGE. 2. SCOUR PROTECTION ON INTERIOR AND EXTERIOR SIDE OF COFFERDAM NOT SHOWN. SEE DRAWINGS C-28 TO C-44 FOR LIMITS OF RIPRAP.

THIS DOCUMENT IS RELEASED FOR THE PURPOSE OF EPA REVIEW UNDER THE AUTHORITY OF CLARENCE R. HOEKSTRA, P.E. 147936 ON 07/17/2024. IT IS NOT TO BE USED FOR CONSTRUCTION, BIDDING, RECORDATION,


CONVEYANCE OR SALES PURPOSES.

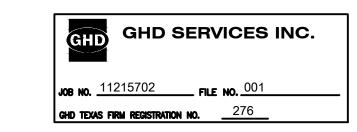

100% EPA SUBMITTAL



2237 S Acadian Thruway Suite 701 Baton Rouge Louisiana 70808 USA **T** 225 292 9007

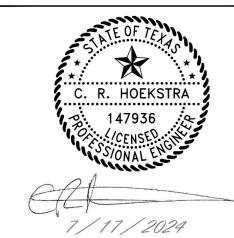

Reuse of Documents

This document and the ideas and designs incorporated herein, as an instrument of professional service, is the property of GHD and shall not be reused in whole or in part for any other project without GHD's written authorization. © 2024 GHD

EXCAVATION LIMIT BASED ON FS = 1.25 FOR HYDRAULIC HEAVE

SOILS WITH CONCENTRATIONS <30 ng/kg TEQ_{DF,M} TCDD SOILS WITH CONCENTRATIONS >30 ng/kg TEQ_{DF,M} TCDD

MATERIAL TO BE EXCAVATED EXISTING BERM TO BE EXCAVATED FOR POTENTIAL TESTING AND REUSE BMP SOIL BUTTRESS (EXISTING SOIL TO REMAIN IN PLACE) PLANNED IMPROVEMENTS FOR NORTHERN IMPOUNDMENT ACCESS

SAN JACINTO RIVER

NORTHERN IMPOUNDMENT FINAL 100% REMEDIAL DESIGN HARRIS COUNTY, TEXAS

WASTE PITS

6 100% EPA SUBMITTAL MW CRH 07/17/2024 Issue Drawn Designer RH Drafting Check Project Coordinator CM Date **Jul 16, 2024** This document shall not be used for construction unless signed and sealed for Scale AS SHOWN

Original Size Bar is one inch on original size drawing Arch D 0 1"

Project No. **11215702**

construction.

EXCAVATION SECTION 4 OF 6

Sheet No.


C-16

Sheet - of -

Plot Date: 17 July 2024 - 12:51 PM

Plotted By: Jonathan Compton

Filename: \\ghdnet\ghd\US\Baton Rouge\Projects\562\11215702\Digital_Design\ACAD 2019\Sheets\11215702-01-DWG-C-013.dwg

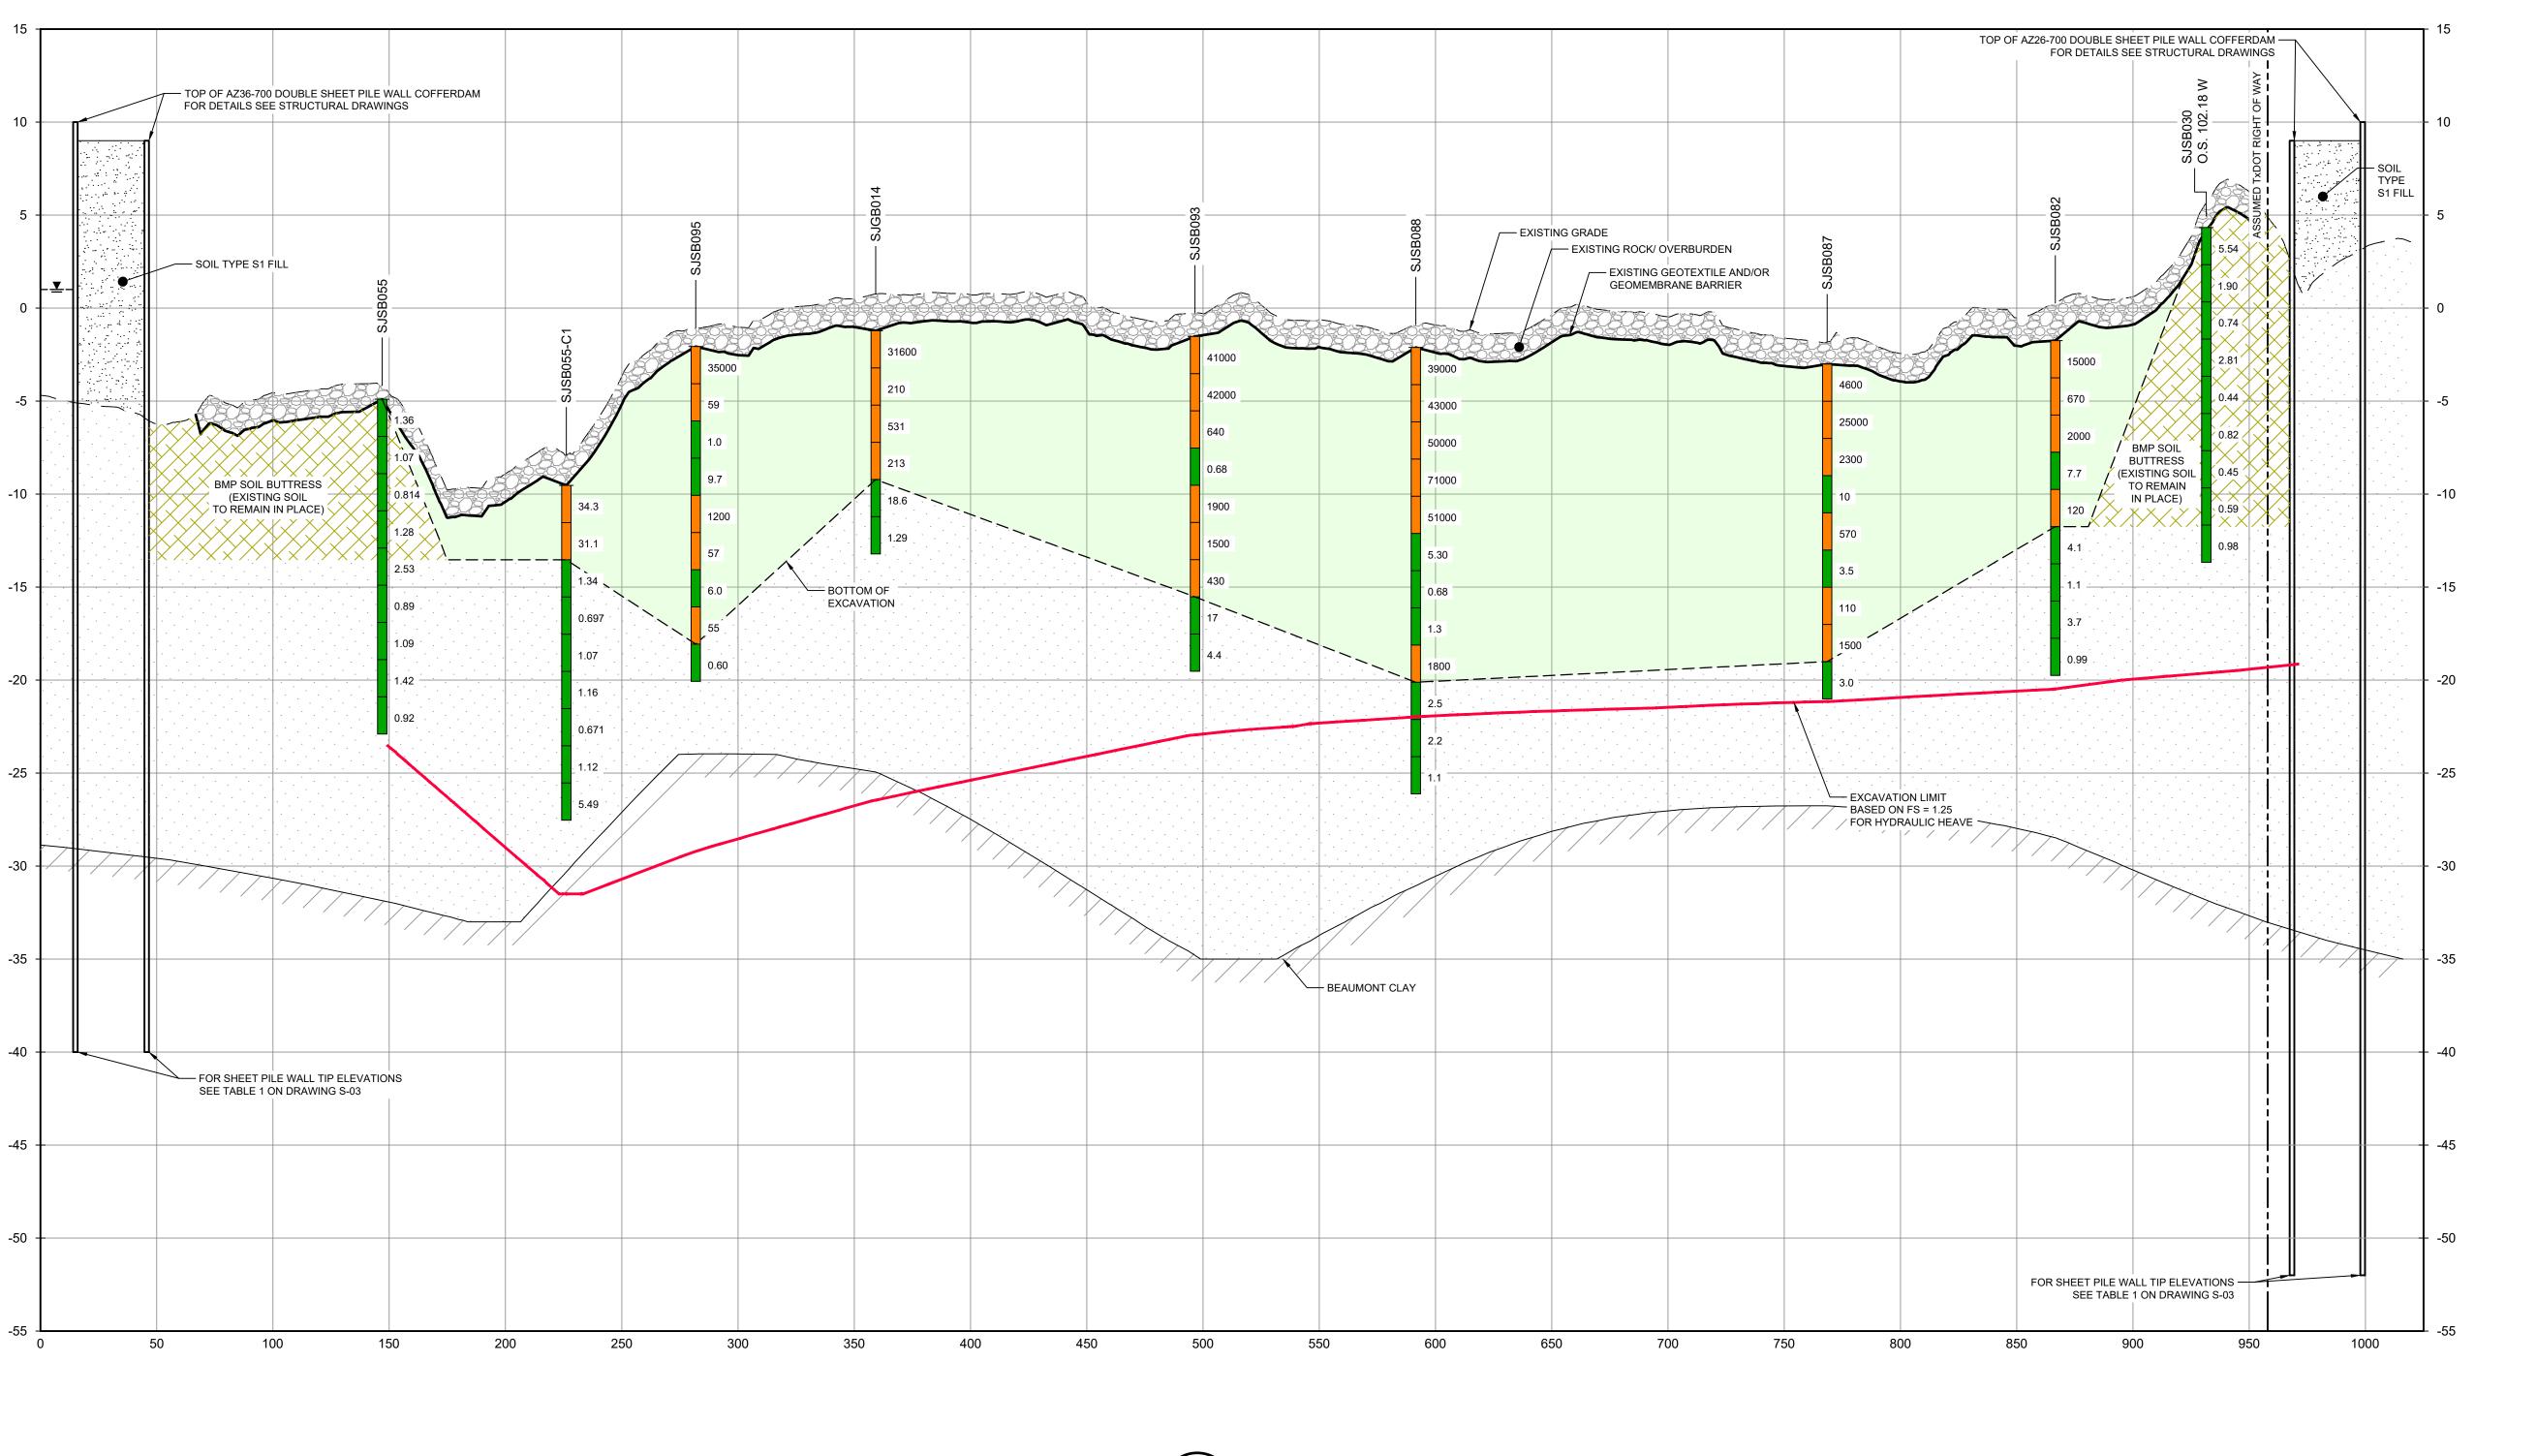

E NORTH/SOUTH C-08 VERT: 1"=5'

SOURCE:

TXDOT RIGHT OF WAY FROM A BOUNDARY AND RIGHT-OF-WAY SURVEY OF PORT OF HOUSTON AUTHORITY PROPERTY & HOUSTON FLEETING SERVICES, LLC PROPERTY ALONG INTERSTATE HIGHWAY 10 AT THE SAN JACINTO FLEET AREA, IN THE J. T. HARRELL SURVEY, A-330 HARRIS COUNTY, TEXAS, COBBFENDLEY, 2402-028-01, JUNE 28, 2024

1. BOTTOM OF EXCAVATION IS SUBJECT TO CHANGE. 2. SCOUR PROTECTION ON INTERIOR AND EXTERIOR SIDE OF COFFERDAM NOT SHOWN. SEE DRAWINGS C-28 TO C-44 FOR LIMITS OF RIPRAP.

THIS DOCUMENT IS RELEASED FOR THE PURPOSE OF EPA REVIEW UNDER THE AUTHORITY OF CLARENCE R. HOEKSTRA, P.E. 147936 ON 07/17/2024. IT IS NOT TO BE USED FOR CONSTRUCTION, BIDDING, RECORDATION, CONVEYANCE OR SALES PURPOSES.



100% EPA SUBMITTAL



2237 S Acadian Thruway Suite 701 Baton Rouge Louisiana 70808 USA **T** 225 292 9007



Reuse of Documents

This document and the ideas and designs incorporated herein, as an instrument of professional service, is the property of GHD and shall not be reused in whole or in part for any other project without GHD's written authorization. © 2024 GHD

SOILS WITH CONCENTRATIONS <30 ng/kg TEQ_{DF,M} TCDD SOILS WITH CONCENTRATIONS >30 ng/kg TEQ_{DF,M} TCDD

EXCAVATION LIMIT BASED ON FS = 1.25 FOR HYDRAULIC HEAVE MATERIAL TO BE EXCAVATED EXISTING BERM TO BE EXCAVATED FOR POTENTIAL TESTING AND REUSE BMP SOIL BUTTRESS (EXISTING SOIL TO REMAIN IN PLACE)

Client **SAN JACINTO RIVER WASTE PITS**

NORTHERN IMPOUNDMENT FINAL 100% REMEDIAL DESIGN HARRIS COUNTY, TEXAS

6	100% EPA SUBMITTAL	MW	CRH	07/17/2
No.	Issue	Drawn	Approved	Dat
Draw	n MW	Designer	RH	
Drafti Chec	· .II.	Design Check	LL	
Proje Coor	ct dinator CM	Date	Jul 16, 20	24
	document shall not be used for uction unless signed and sealed for	Scale	AS SHOW	/N

Original Size Arch D

Project No. **11215702**

construction.

EXCAVATION SECTION 5 OF 6


Sheet No.

C-17

Sheet - of -

Bar is one inch on

original size drawing

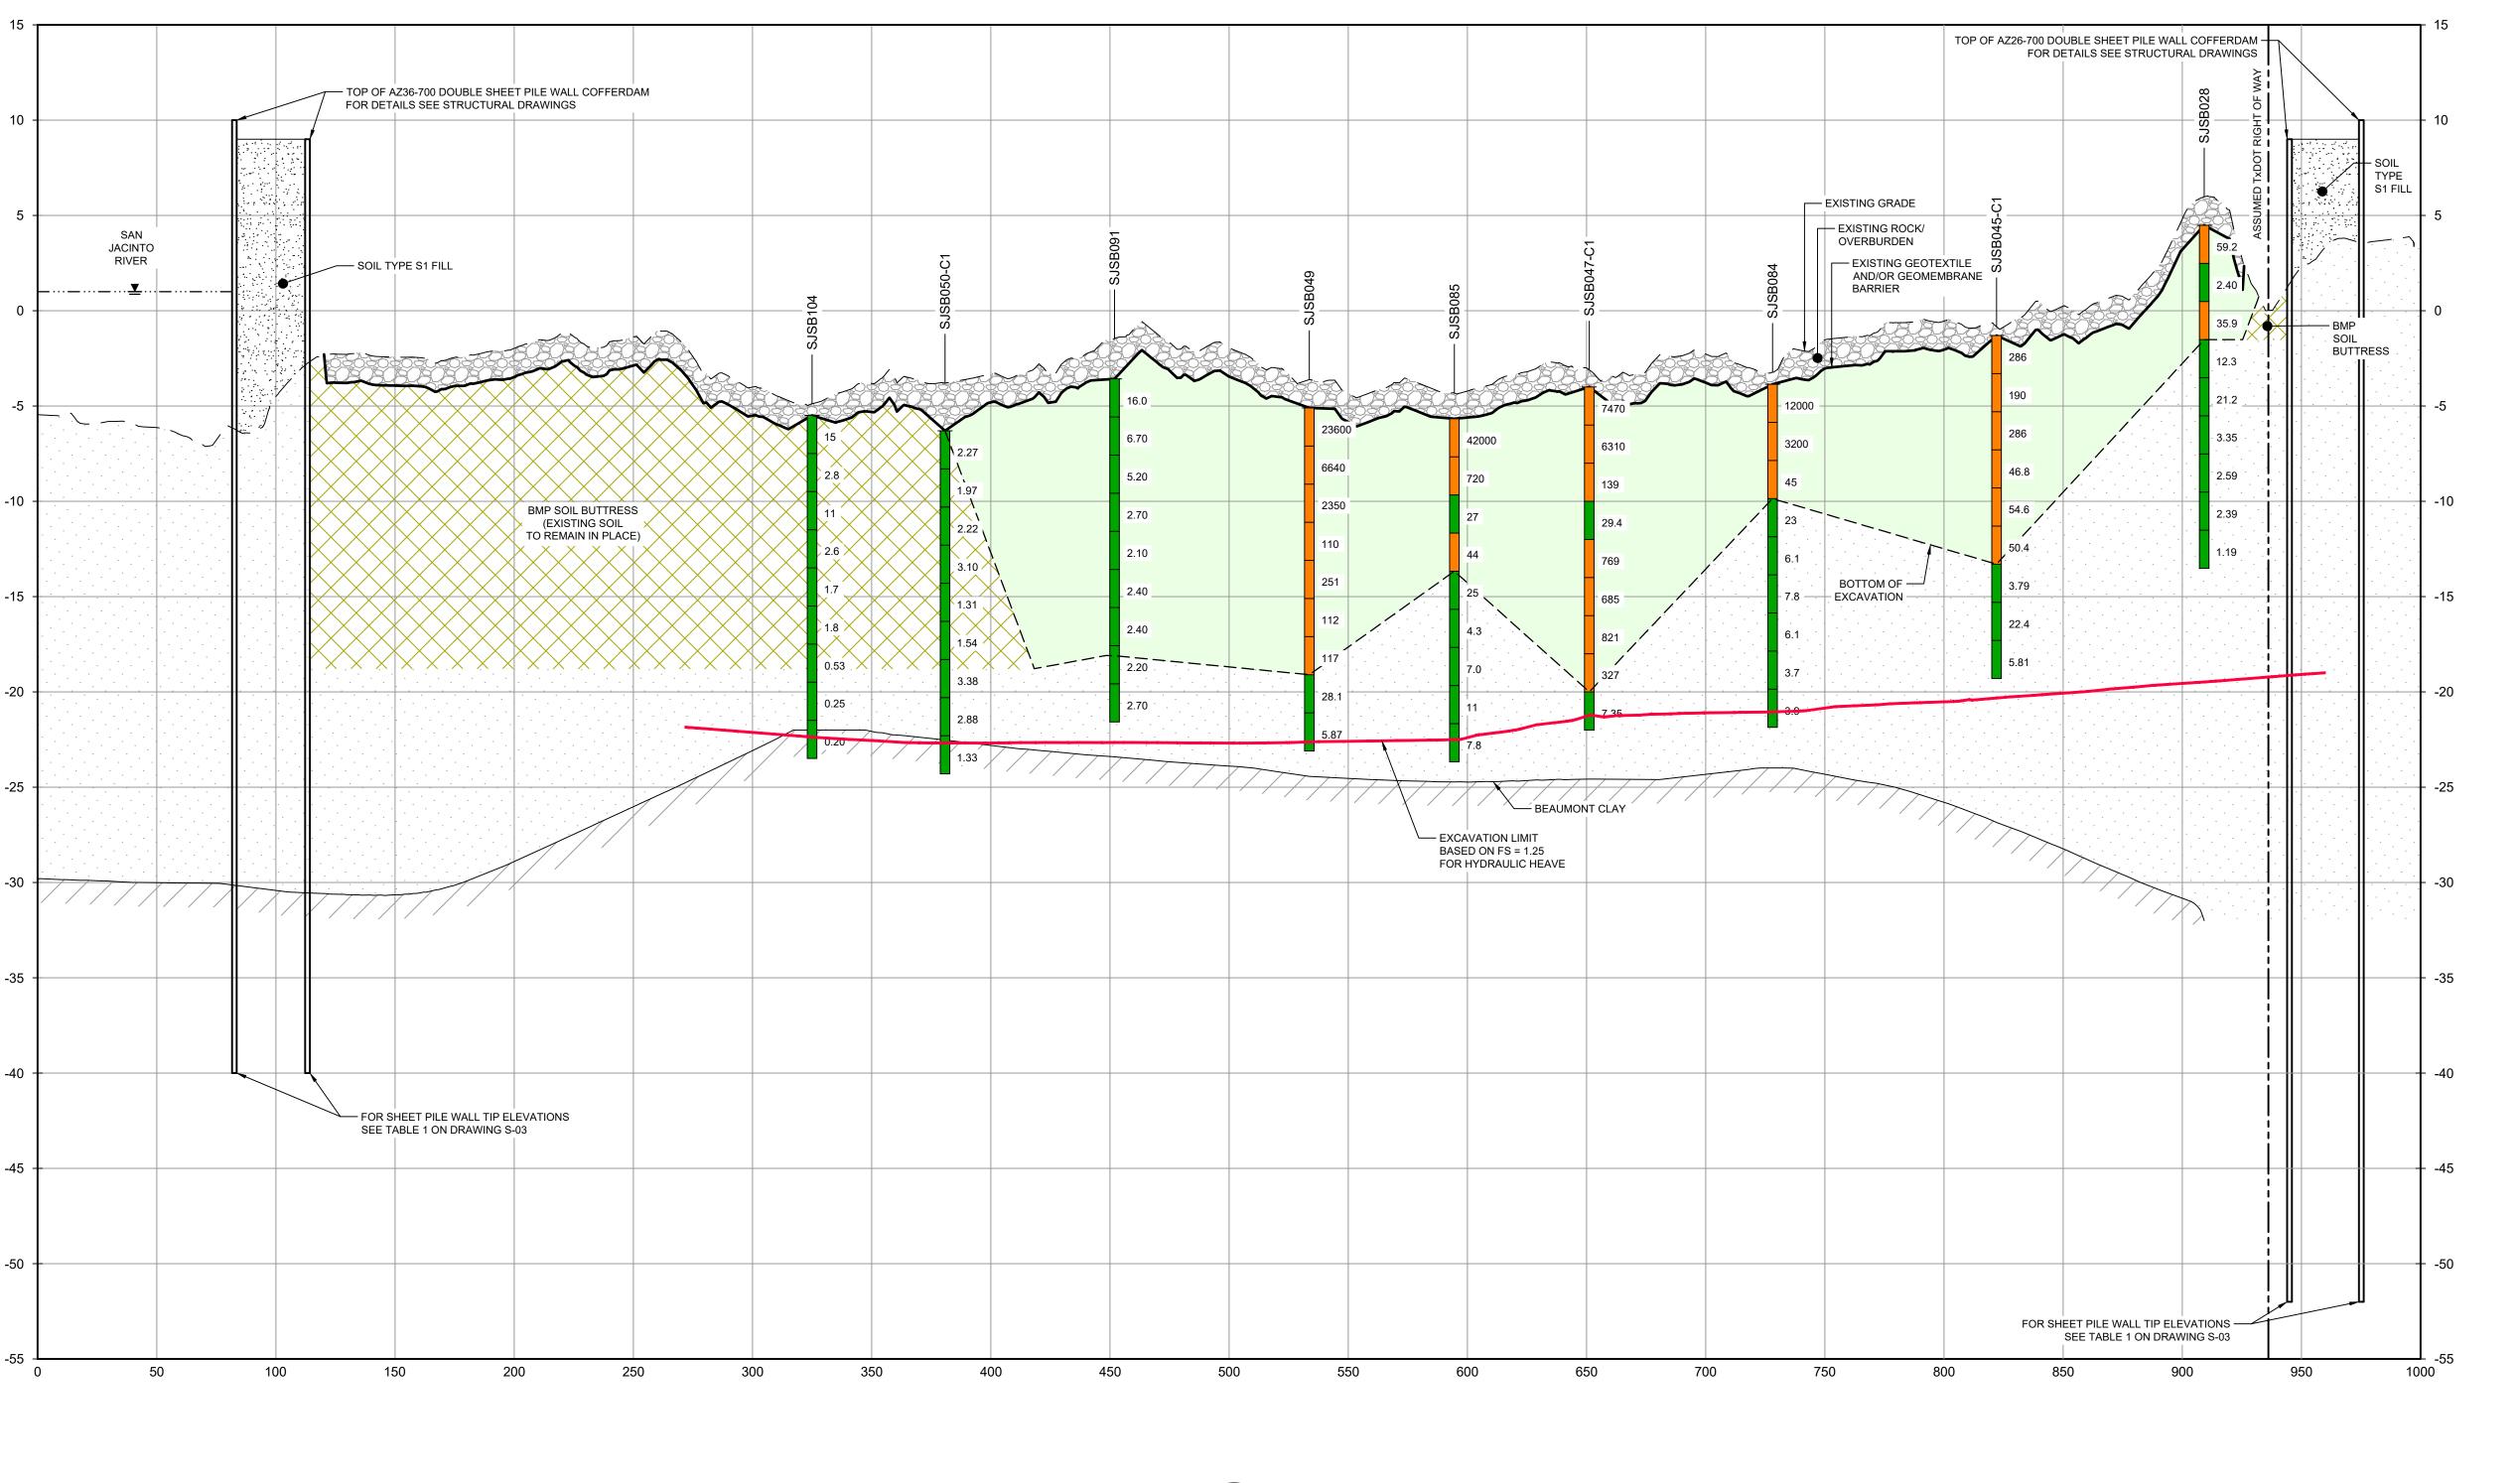

F NORTH/SOUTH C-08 VERT: 1"=5'


SOURCE:

TXDOT RIGHT OF WAY FROM A BOUNDARY AND RIGHT-OF-WAY SURVEY OF PORT OF HOUSTON AUTHORITY PROPERTY & HOUSTON FLEETING SERVICES, LLC PROPERTY ALONG INTERSTATE HIGHWAY 10 AT THE SAN JACINTO FLEET AREA, IN THE J. T. HARRELL SURVEY, A-330 HARRIS COUNTY, TEXAS, COBBFENDLEY, 2402-028-01, JUNE 28, 2024

1. BOTTOM OF EXCAVATION IS SUBJECT TO CHANGE. 2. SCOUR PROTECTION ON INTERIOR AND EXTERIOR SIDE OF COFFERDAM

NOT SHOWN. SEE DRAWINGS C-28 TO C-44 FOR LIMITS OF RIPRAP.

THIS DOCUMENT IS RELEASED FOR THE PURPOSE OF EPA REVIEW UNDER THE AUTHORITY OF CLARENCE R. HOEKSTRA, P.E. 147936 ON 07/17/2024. IT IS NOT TO BE USED FOR CONSTRUCTION, BIDDING, RECORDATION, CONVEYANCE OR SALES PURPOSES.

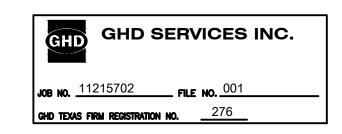

100% EPA SUBMITTAL



2237 S Acadian Thruway Suite 701 Baton Rouge Louisiana 70808 USA **T** 225 292 9007



Reuse of Documents

This document and the ideas and designs incorporated herein, as an instrument of professional service, is the property of GHD and shall not be reused in whole or in part for any other project without GHD's written authorization. © 2024 GHD

SOILS WITH CONCENTRATIONS

<30 ng/kg TEQ_{DF,M} TCDD SOILS WITH CONCENTRATIONS

>30 ng/kg TEQ_{DF,M} TCDD EXCAVATION LIMIT BASED ON FS = 1.25 FOR HYDRAULIC HEAVE MATERIAL TO BE EXCAVATED EXISTING BERM TO BE EXCAVATED FOR POTENTIAL TESTING AND REUSE BMP SOIL BUTTRESS (EXISTING SOIL TO REMAIN IN PLACE)

Client

SAN JACINTO RIVER WASTE PITS

NORTHERN IMPOUNDMENT FINAL 100% REMEDIAL DESIGN HARRIS COUNTY, TEXAS

5	100% EPA SUBMITTAL	MW	CRH	07/17/2
No.	Issue	Drawn	Approved	Dat
Drav	n MW	Designer	RH	
Draft Chec	· .)(.	Design Check	LL	
Proje Coor	ect dinator CM	Date	Jul 16, 20	24
consti	document shall not be used for ruction unless signed and sealed for	Scale	AS SHOW	/N

Original Size Bar is one inch on original size drawing Arch D

Project No. **11215702**

EXCAVATION SECTION 6 OF 6

0 1"

Sheet - of -


Sheet No.


C-18


Plot Date: 17 July 2024 - 12:52 PM


Plotted By: Jonathan Compton


Filename: \\ghdnet\ghd\US\Baton Rouge\Projects\562\11215702\Digital_Design\ACAD 2019\Sheets\11215702-01-DWG-C-013.dwg

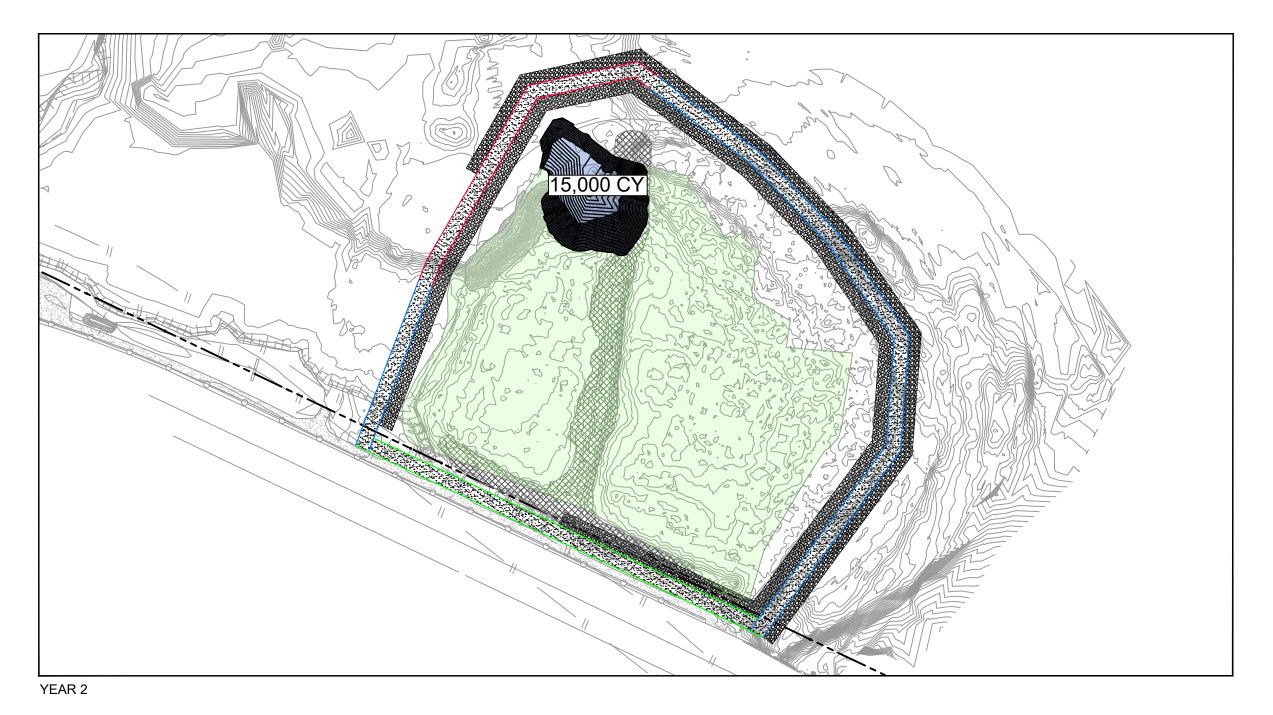

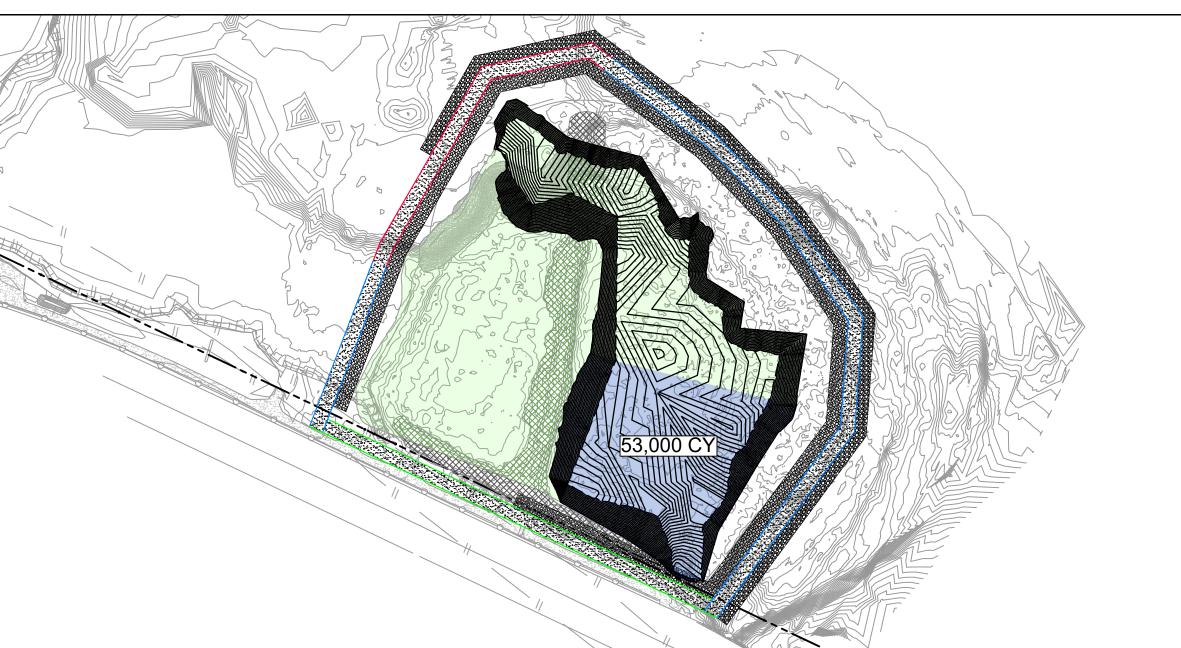

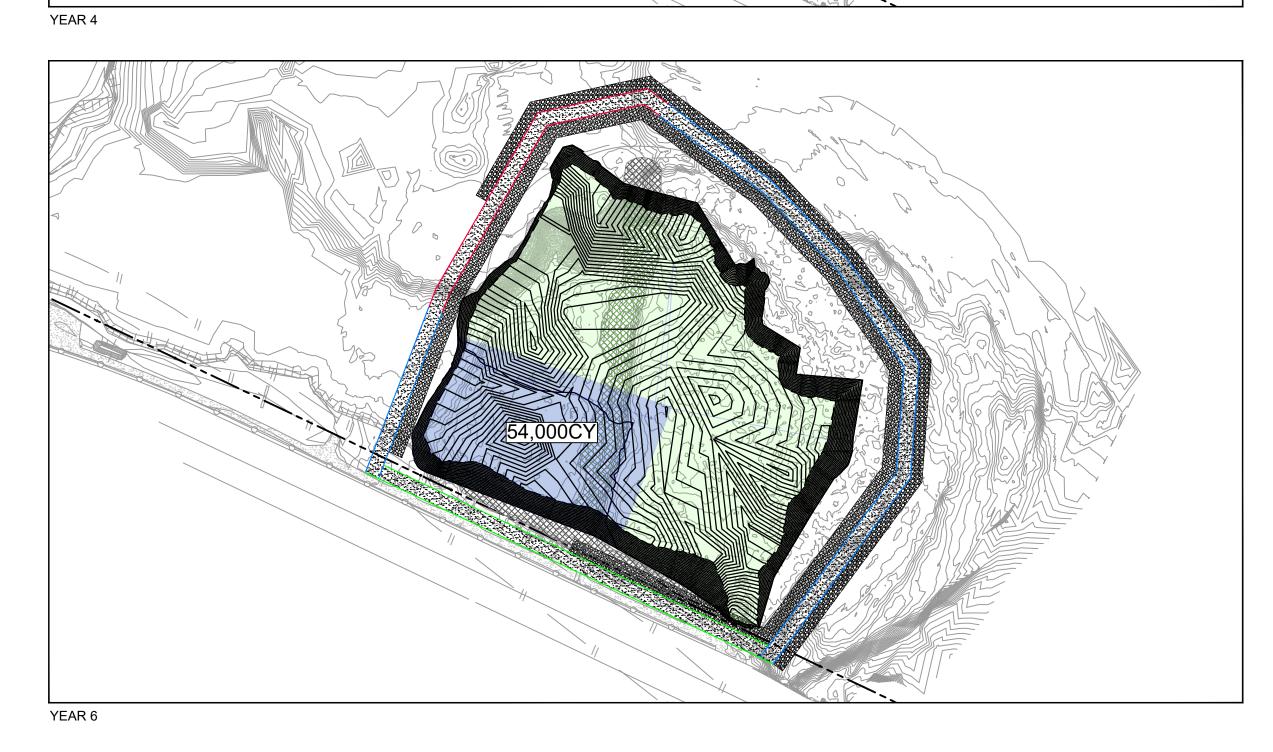

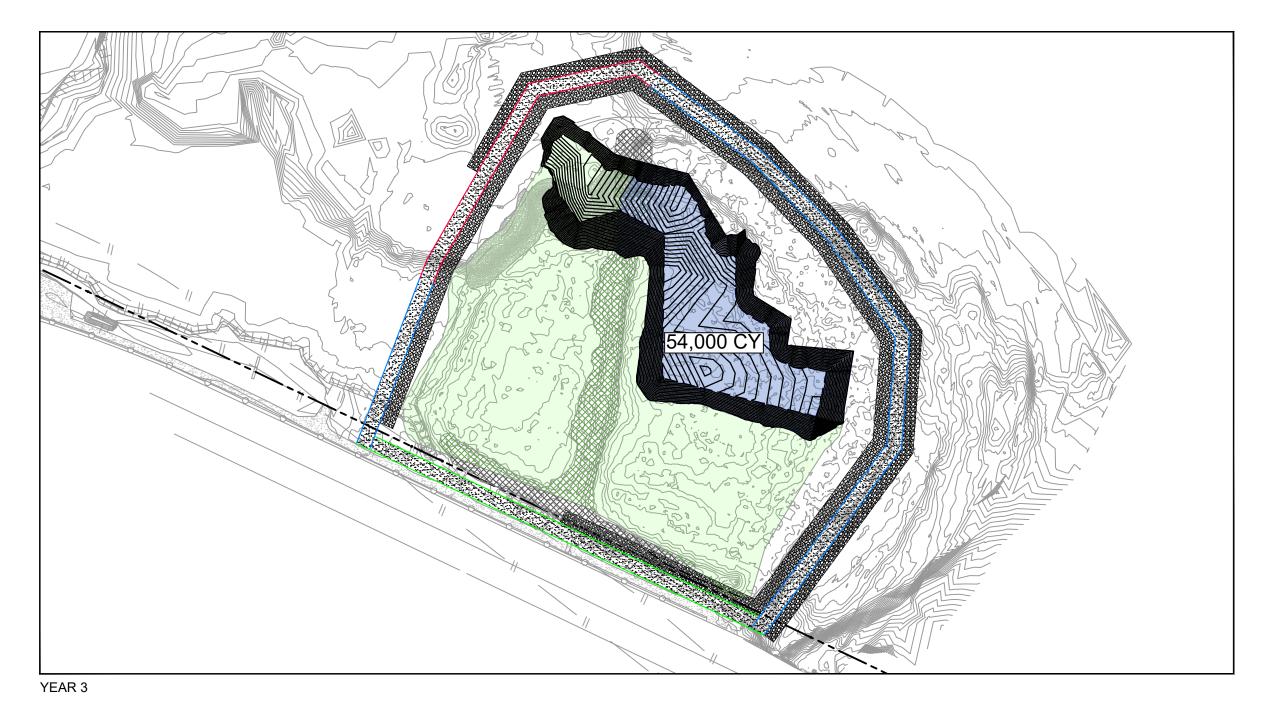

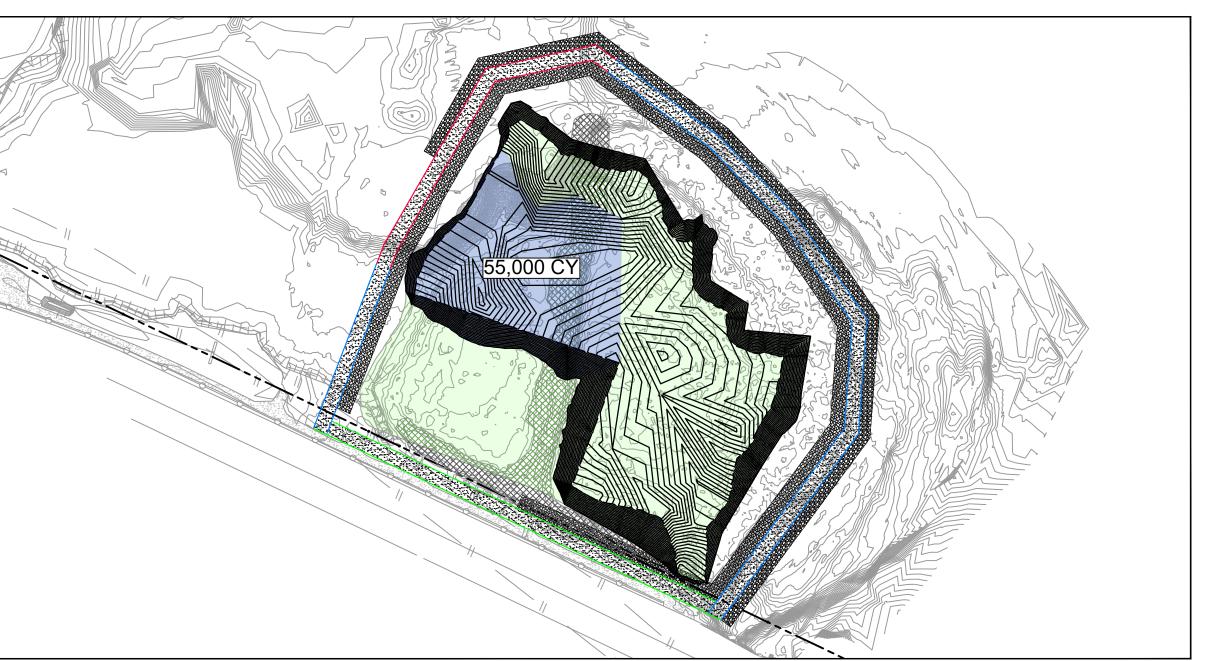

SOURCE:

TOPOGRAPHIC, HYDROGRAPHIC, & MAGNETOMETER SURVEY OF SAN JACINTO RIVER WASTE PITS, HARRIS COUNTY, TEXAS, MORRISON SURVEYING INC.,

190608, JULY 8, 2019 TO AUGUST 2, 2019
UPDATED BATHYMETRY DATA PROVIDED BY ANCHOR QEA OCTOBER 2021
TXDOT RIGHT OF WAY FROM A BOUNDARY AND RIGHT-OF-WAY SURVEY OF
PORT OF HOUSTON AUTHORITY PROPERTY & HOUSTON FLEETING SERVICES, LLC PROPERTY ALONG INTERSTATE HIGHWAY 10 AT THE SAN JACINTO FLEET AREA, IN THE J. T. HARRELL SURVEY, A-330 HARRIS COUNTY, TEXAS, COBBFENDLEY, 2402-028-01, JUNE 28, 2024

NOTES:

- 1. TYPICAL EXCAVATION SEQUENCING ASSUMES BMP INSTALLATION AND SITE PREPARATION WILL BE COMPLETED IN YEAR 1, REMEDIATION OF THE NORTHWEST CORNER IN YEAR 2, AND BMP REMOVAL AND SITE RESTORATION WILL BE COMPLETED IN YEAR 7.

 2. SEASONAL EXCAVATION AREAS, VOLUMES, AND SEQUENCING ARE APPROXIMATE AND SUBJECT TO CHANGE.


THIS DOCUMENT IS RELEASED FOR THE PURPOSE OF EPA REVIEW UNDER THE AUTHORITY OF CLARENCE R. HOEKSTRA, P.E. 147936 ON 07/17/2024. IT IS NOT TO BE USED FOR CONSTRUCTION, BIDDING, RECORDATION, CONVEYANCE OR SALES PURPOSES.



100% EPA SUBMITTAL



2237 S Acadian Thruway Suite 701 Baton Rouge Louisiana 70808 USA **T** 225 292 9007

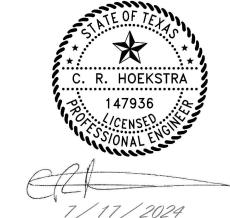

Reuse of Documents

This document and the ideas and designs incorporated herein, as an instrument of professional service, is the property of GHD and shall not be reused in whole or in part for any other project without GHD's written authorization. © 2024 GHD

— – – — TXDOT RIGHT OF WAY TCRA CAP PERIMETER EXISTING CONTOUR INTERVAL FENCELINE SHORELINE TOP OF BANK ____ TOE OF SLOPE GUARDRAIL PIPELINE SJSB002 **BORING LOCATION** MONITORING WELL POWER POLE

LIGHT POLE

MATERIAL TO BE EXCAVATED EXISTING BERM TO BE EXCAVATED FOR POTENTIAL TESTING AND REUSE EXISTING BERM TO REMAIN CONCRETE AZ26-700 PILE AZ36-700 PILE AZ42-700 PILE

PHASE OF EXCAVATION EXTERIOR SCOUR PROTECTION INTERIOR SCOUR PROTECTION

SAN JACINTO RIVER

WASTE PITS

NORTHERN IMPOUNDMENT

FINAL 100% REMEDIAL DESIGN HARRIS COUNTY, TEXAS

3	100% EPA SUBMITTAL	MW	CRH	07/17/
No.	Issue	Drawn	Approved	Da
Draw	n MW	Designer	RH	
Drafti Chec	·	Design Check	LL	
Proje Coor	ct dinator	Date	Jul 16, 20	24
	document shall not be used for uction unless signed and sealed for uction.	Scale	1" = 200'	
Origi	nal Size		ar is one in	

Arch D


Project No. **11215702**

SEASONAL EXCAVATION SEQUENCING TYPICAL


Sheet No.

C-19

Plot Date: 17 July 2024 - 12:52 PM

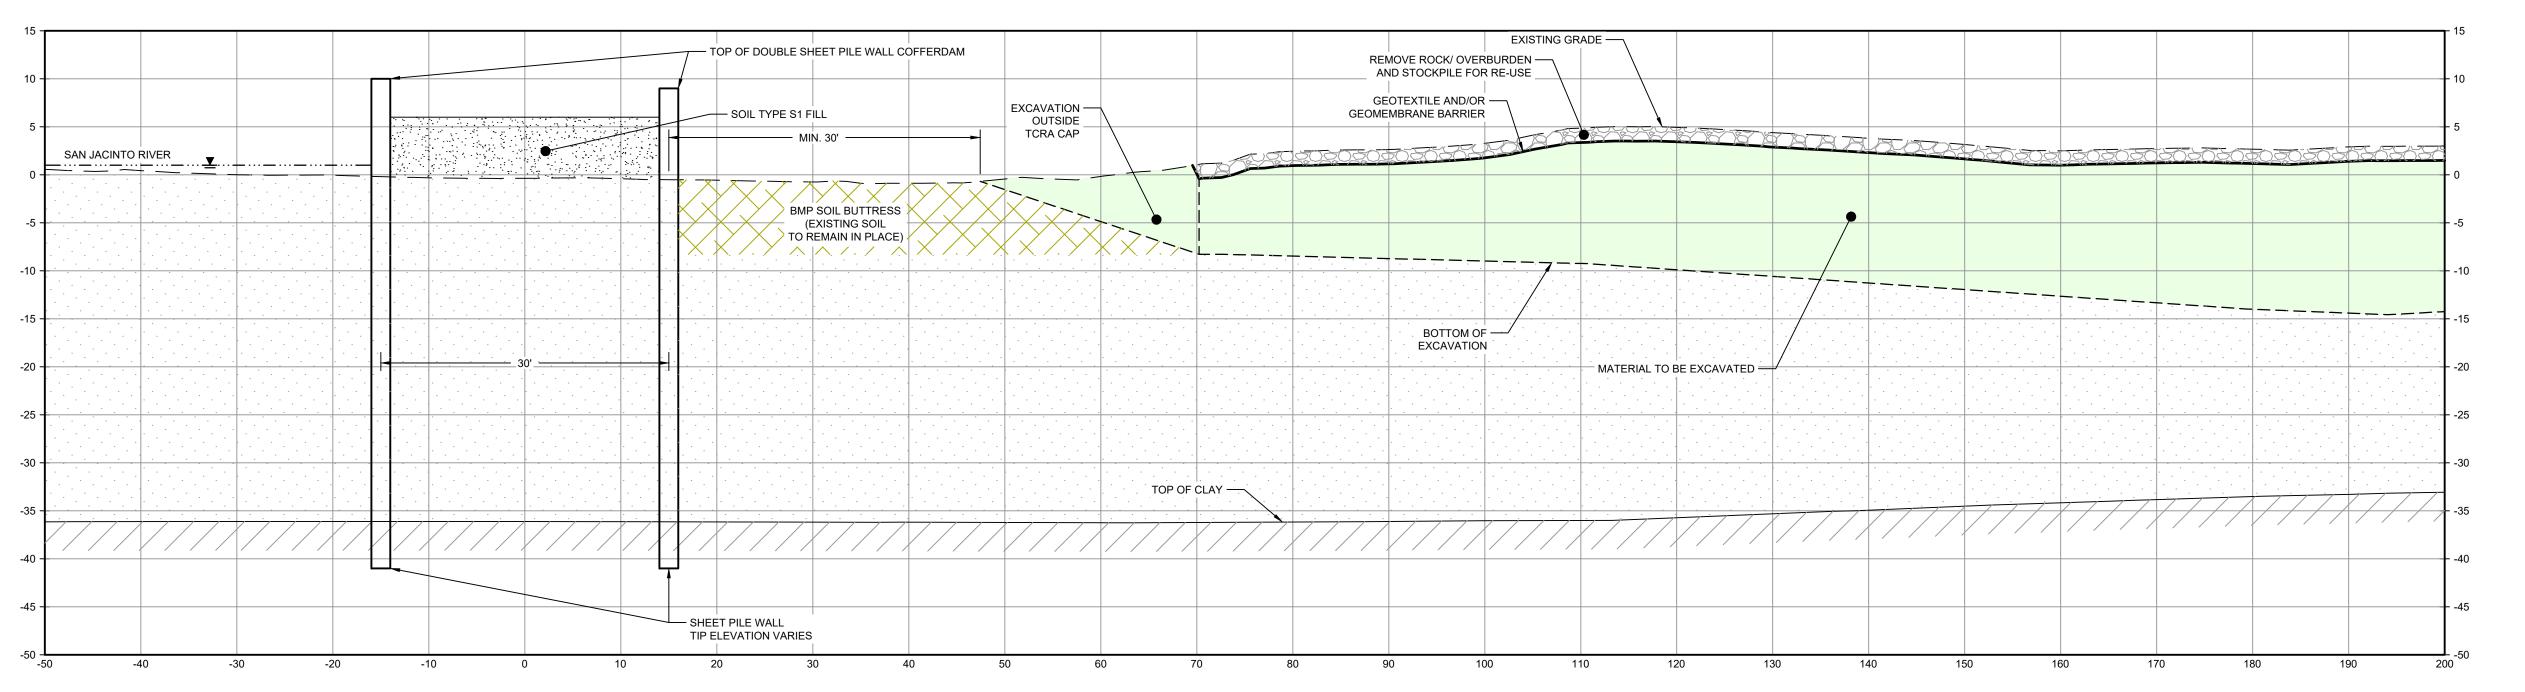

1. INSTALL PILE WALL COFFERDAM AROUND PERIMETER OF EXCAVATION AND DEWATER.

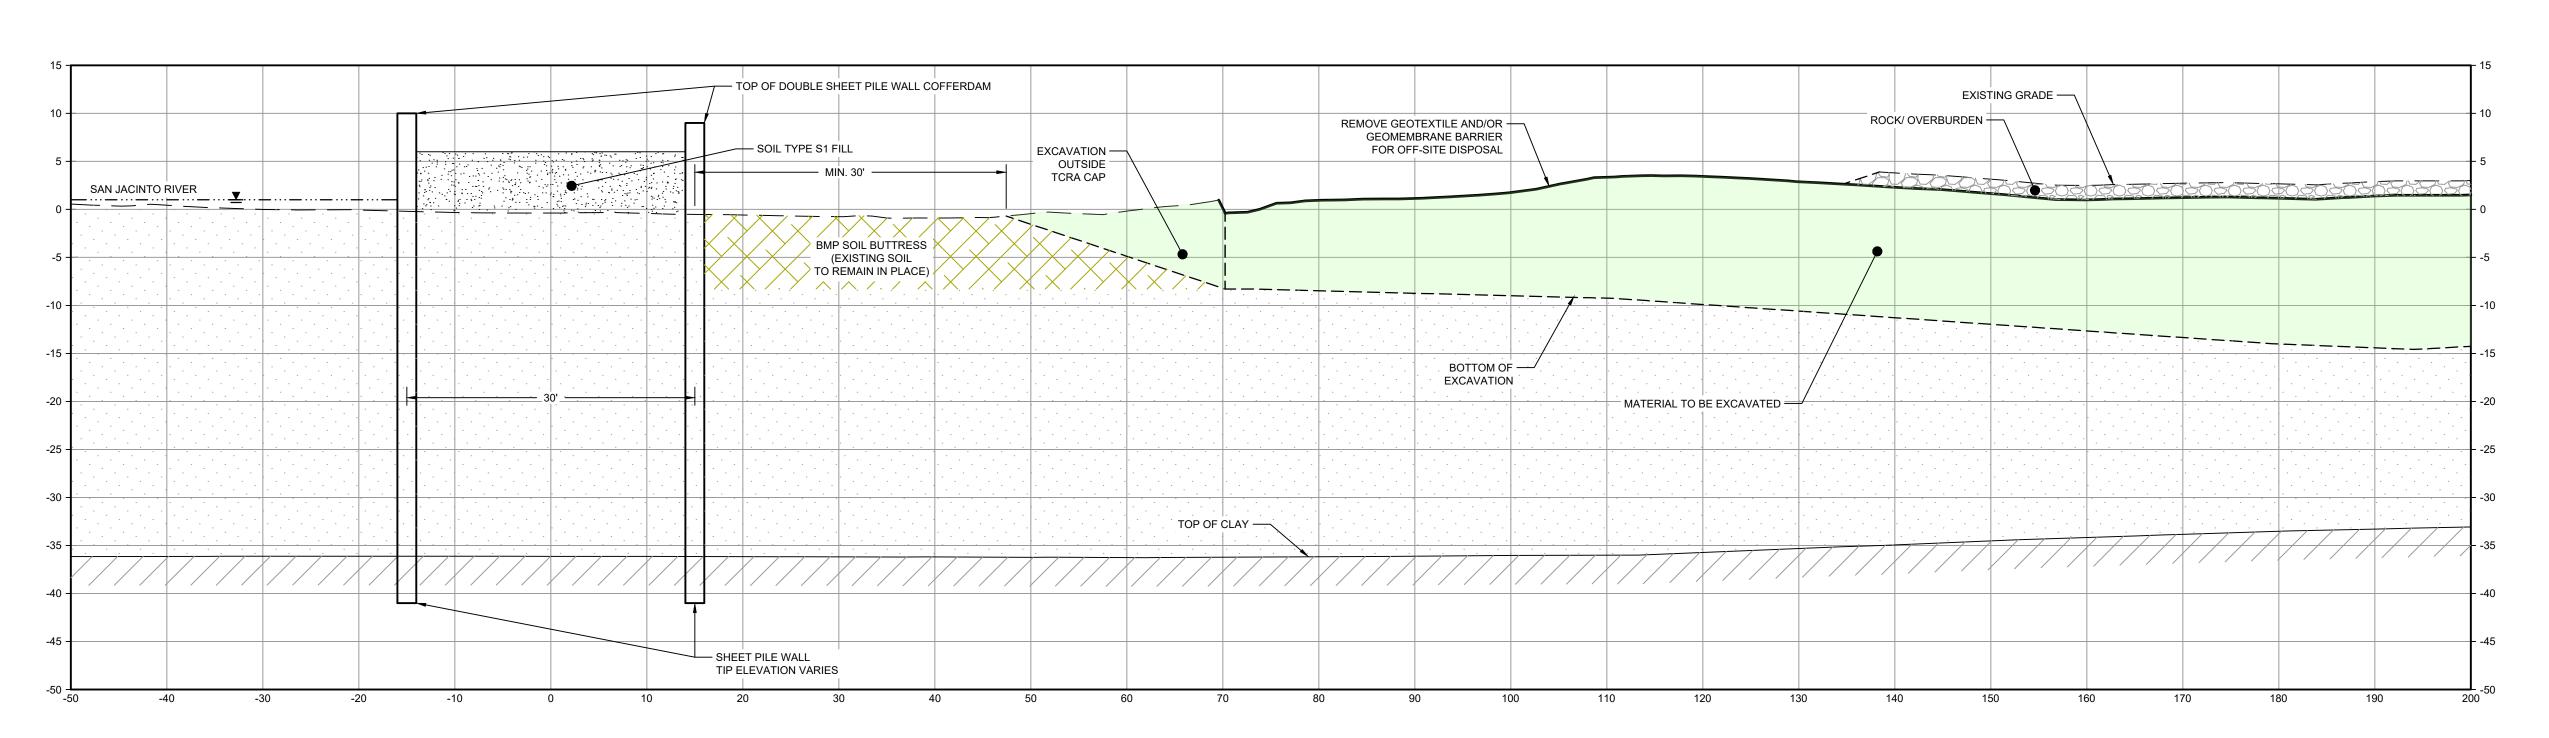

NOTES:

REMOVE ROCK LAYER TO BE STOCKPILED ON SITE. REUSED AS TEMPORARY COVER AT END OF SEASONAL EXCAVATION.

PHASE 2

- 1. BOTTOM OF EXCAVATION IS SUBJECT TO CHANGE. 2. SCOUR PROTECTION ON INTERIOR AND EXTERIOR SIDE OF COFFERDAM NOT SHOWN. SEE DRAWINGS C-28 TO C-44 FOR LIMITS OF RIPRAP.
- 3. FRP BARRIER WALL NOT SHOWN FOR CLARITY.


THIS DOCUMENT IS RELEASED FOR THE PURPOSE OF EPA REVIEW UNDER THE AUTHORITY OF CLARENCE R. HOEKSTRA, P.E. 147936 ON 07/17/2024. IT IS NOT TO BE USED FOR CONSTRUCTION, BIDDING, RECORDATION, CONVEYANCE OR SALES PURPOSES.



100% EPA SUBMITTAL



2237 S Acadian Thruway Suite 701 Baton Rouge Louisiana 70808 USA **T** 225 292 9007

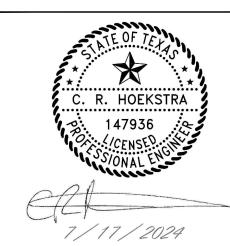

Reuse of Documents This document and the ideas and designs incorporated herein, as an instrument of professional service, is the property of GHD and shall not be reused in whole or in part


<u>LEGEND</u>

for any other project without GHD's written authorization. © 2024 GHD

MATERIAL TO BE EXCAVATED BMP SOIL BUTTRESS (EXISTING SOIL TO REMAIN IN PLACE)

SAN JACINTO RIVER WASTE PITS

NORTHERN IMPOUNDMENT FINAL 100% REMEDIAL DESIGN HARRIS COUNTY, TEXAS

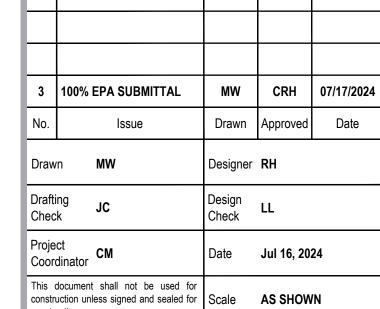

Original Size Arch D

Bar is one inch on original size drawing

Project No. **11215702**


TYPICAL EXCAVATION **SEQUENCING** 1 OF 2

Sheet No.

C-20


Sheet - of -

Plot Date: 17 July 2024 - 12:52 PM

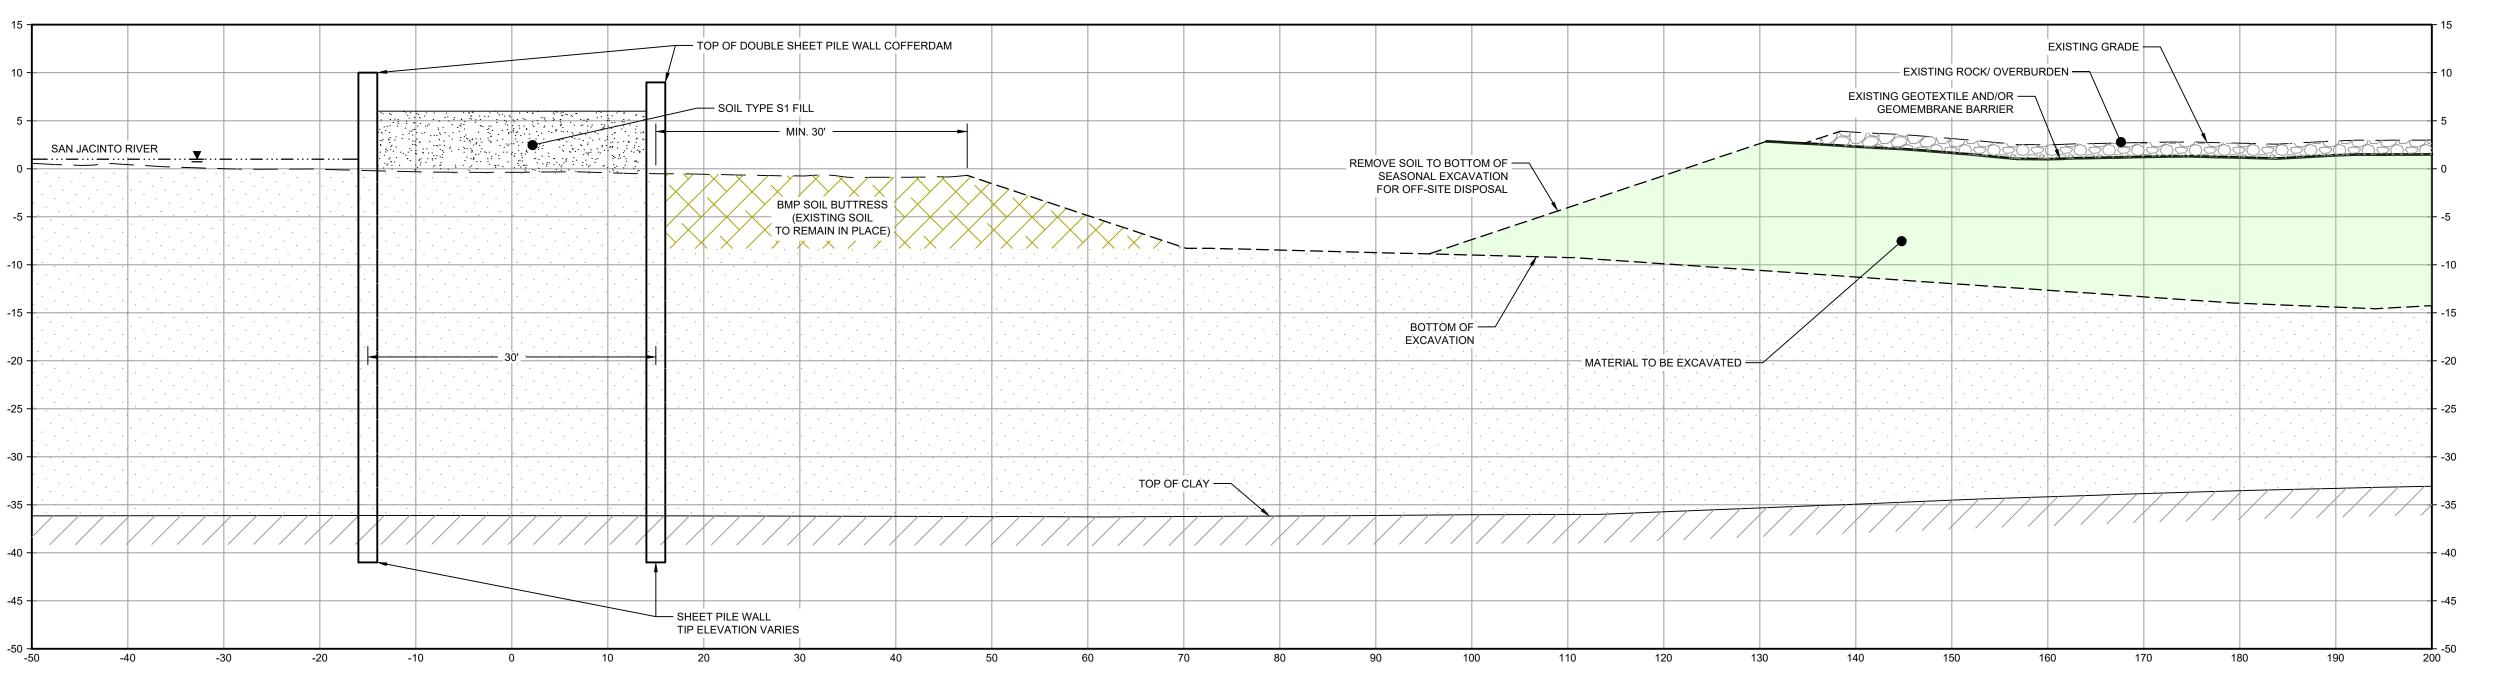

NOTES:


1. REMOVE GEOMEMBRANE, EXCAVATE MATERIAL AND DISPOSE OF OFFSITE.

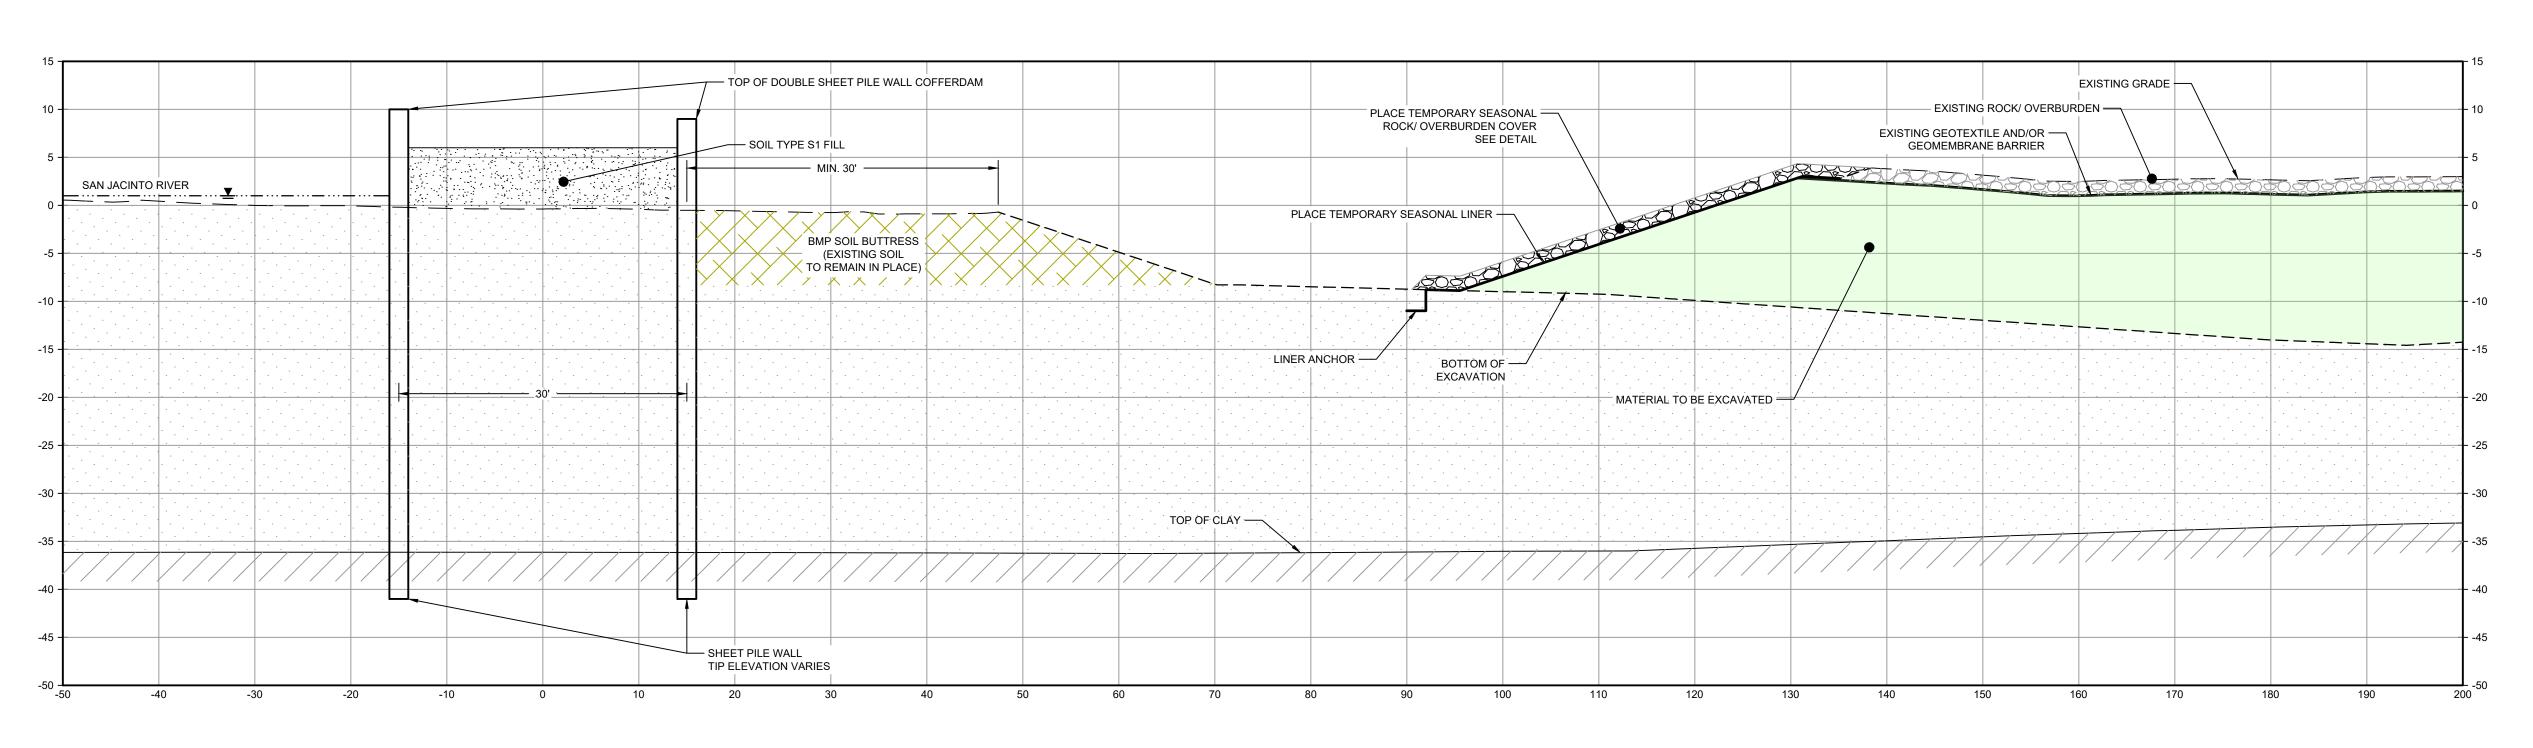

PHASE 4

- 1. BOTTOM OF EXCAVATION IS SUBJECT TO CHANGE. 2. SCOUR PROTECTION ON INTERIOR AND EXTERIOR SIDE OF COFFERDAM NOT SHOWN. SEE DRAWINGS C-28 TO C-44 FOR LIMITS OF RIPRAP.
- 3. FRP BARRIER WALL NOT SHOWN FOR CLARITY.


THIS DOCUMENT IS RELEASED FOR THE PURPOSE OF EPA REVIEW UNDER THE AUTHORITY OF CLARENCE R. HOEKSTRA, P.E. 147936 ON 07/17/2024. IT IS NOT TO BE USED FOR CONSTRUCTION, BIDDING, RECORDATION, CONVEYANCE OR SALES PURPOSES.

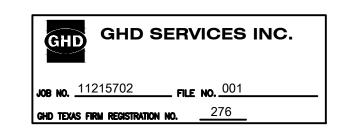

100% EPA SUBMITTAL



2237 S Acadian Thruway Suite 701 Baton Rouge Louisiana 70808 USA **T** 225 292 9007

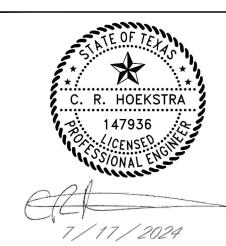

Reuse of Documents This document and the ideas and designs incorporated herein, as an instrument of professional service, is the property of GHD and shall not be reused in whole or in part for any other project without GHD's written authorization. © 2024 GHD


<u>LEGEND</u>

MATERIAL TO BE EXCAVATED BMP SOIL BUTTRESS (EXISTING SOIL

TO REMAIN IN PLACE)

SAN JACINTO RIVER WASTE PITS

NORTHERN IMPOUNDMENT FINAL 100% REMEDIAL DESIGN HARRIS COUNTY, TEXAS

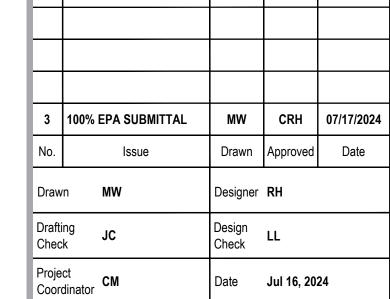

Original Size

Bar is one inch on original size drawing Arch D

This document shall not be used for construction unless signed and sealed for Scale AS SHOWN

Project No. **11215702**

TYPICAL EXCAVATION **SEQUENCING** 2 OF 2

Sheet No.


C-21


Sheet - of -

Plot Date: 17 July 2024 - 12:52 PM


Plotted By: Jonathan Compton

Filename: \\ghdnet\ghd\US\Baton Rouge\Projects\562\11215702\Digital_Design\ACAD 2019\Sheets\11215702-01-DWG-C-020.dwg

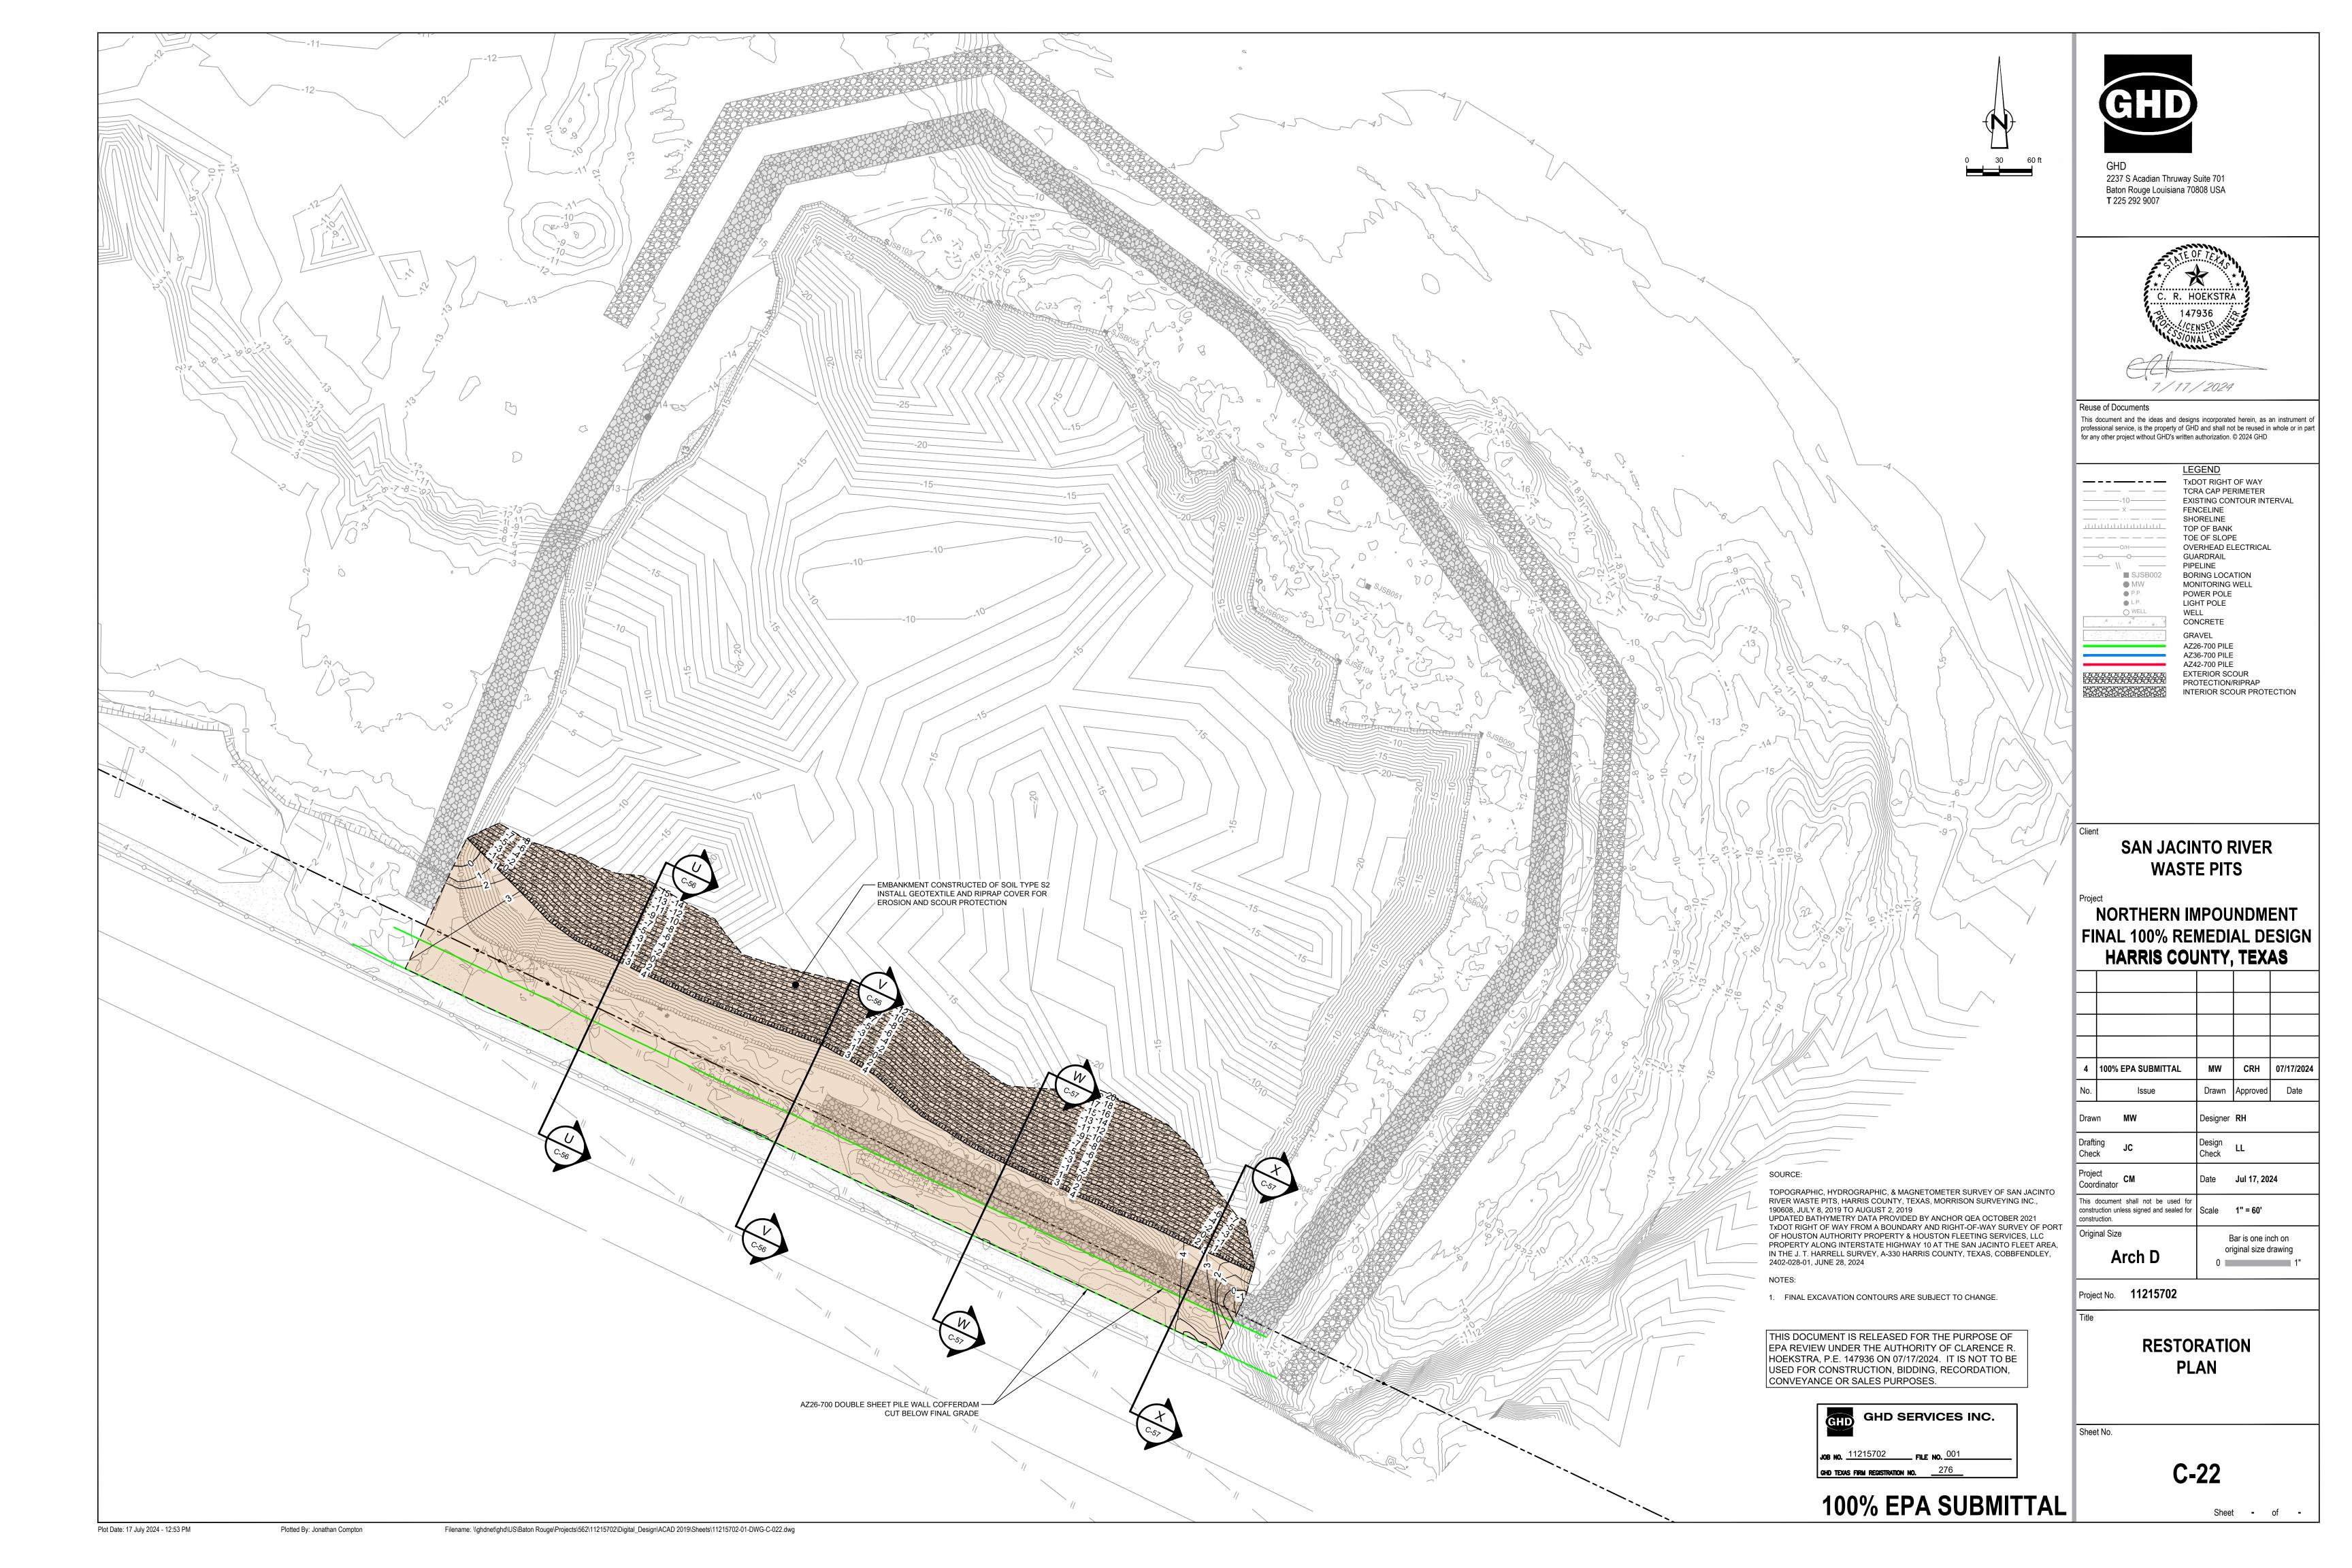

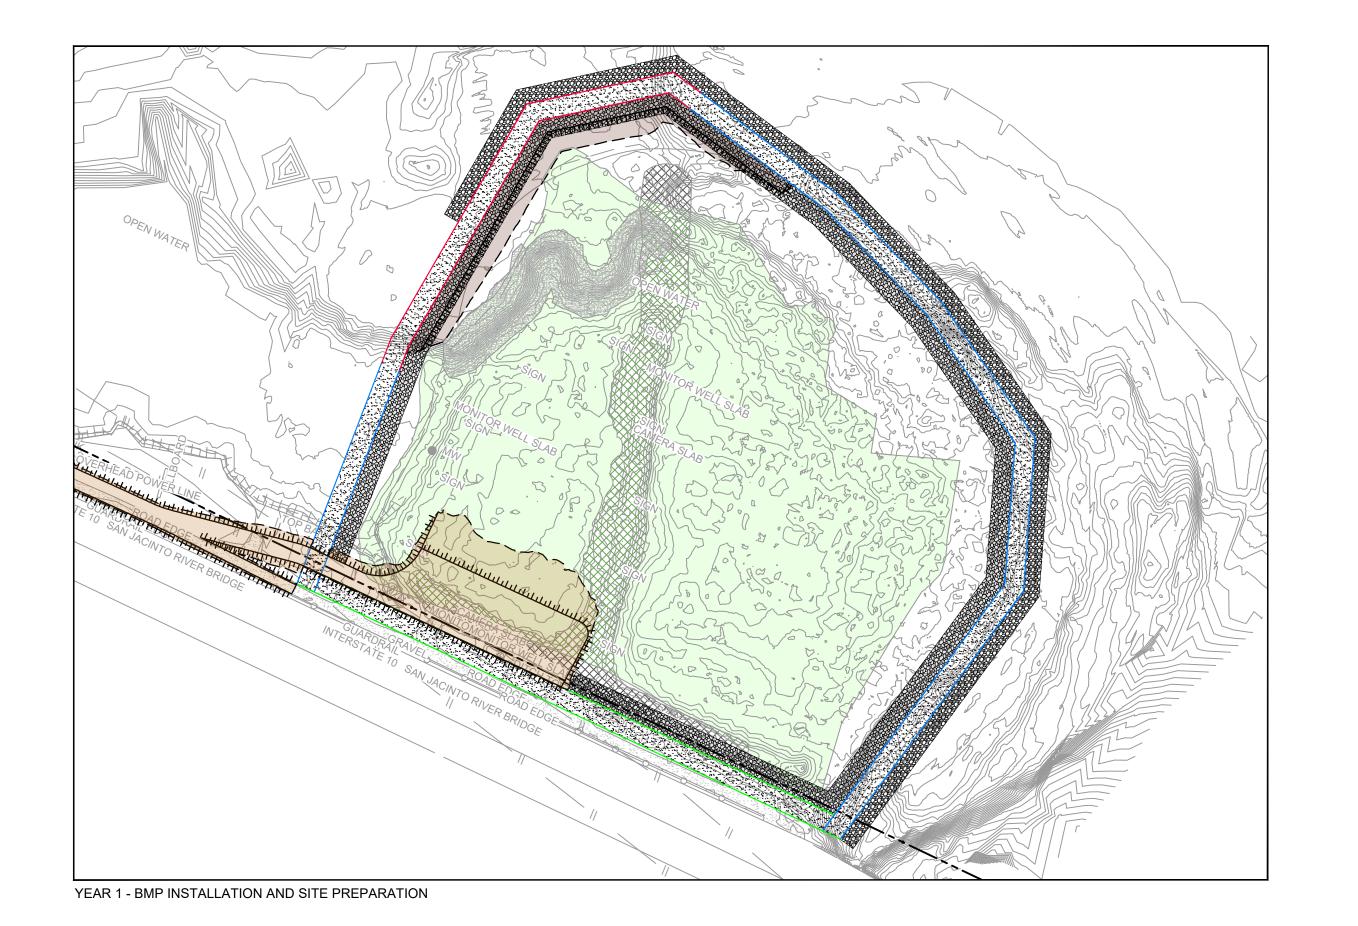



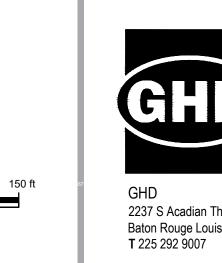



2237 S Acadian Thruway Suite 701 Baton Rouge Louisiana 70808 USA



Reuse of Documents This document and the ideas and designs incorporated herein, as an instrument of professional service, is the property of GHD and shall not be reused in whole or in part for any other project without GHD's written authorization. © 2024 GHD

— – – — TXDOT RIGHT OF WAY _ _ _ _ TOE OF SLOPE

EXISTING CONTOUR INTERVAL FENCELINE SHORELINE TOP OF BANK OVERHEAD ELECTRICAL **GUARDRAIL** PIPELINE ■ SJSB002 BORING LOCATION MONITORING WELL POWER POLE LIGHT POLE

TCRA CAP PERIMETER

MATERIAL TO BE EXCAVATED

EXISTING BERM TO BE EXCAVATED FOR POTENTIAL TESTING AND REUSE EXISTING BERM TO REMAIN CONCRETE GRAVEL AZ26-700 PILE AZ36-700 PILE AZ42-700 PILE PHASE OF EXCAVATION PLANNED IMPROVEMENTS FOR NORTHERN IMPOUNDMENT ACCESS RAISED BENCH

EXTERIOR SCOUR PROTECTION INTERIOR SCOUR PROTECTION

SAN JACINTO RIVER

NORTHERN IMPOUNDMENT FINAL 100% REMEDIAL DESIGN

WASTE PITS

HARRIS COUNTY, TEXAS 4 100% EPA SUBMITTAL MW CRH 07/17/2024

Project Coordinator CM Date **Jul 16, 2024**

This document shall not be used for construction unless signed and sealed for construction.

Scale 1" = 150' Original Size Arch D

Bar is one inch on original size drawing

Project No. **11215702**

CONSTRUCTION **SEQUENCING** 1 OF 2

Sheet No.

C-23


100% EPA SUBMITTAL


THIS DOCUMENT IS RELEASED FOR THE PURPOSE OF

EPA REVIEW UNDER THE AUTHORITY OF CLARENCE R. HOEKSTRA, P.E. 147936 ON 07/17/2024. IT IS NOT TO BE USED FOR CONSTRUCTION, BIDDING, RECORDATION,

GHD SERVICES INC.

CONVEYANCE OR SALES PURPOSES.

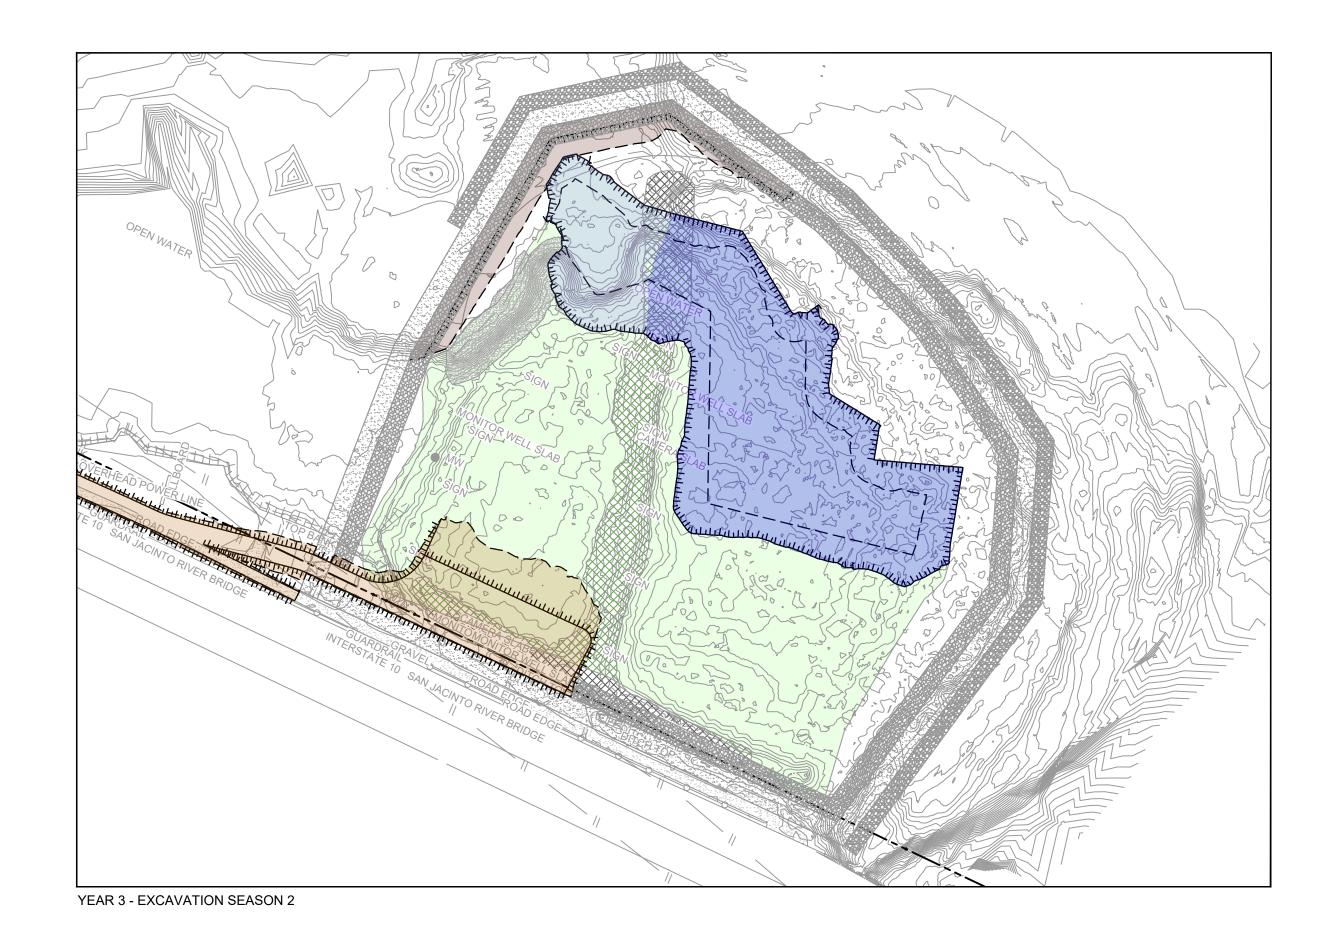

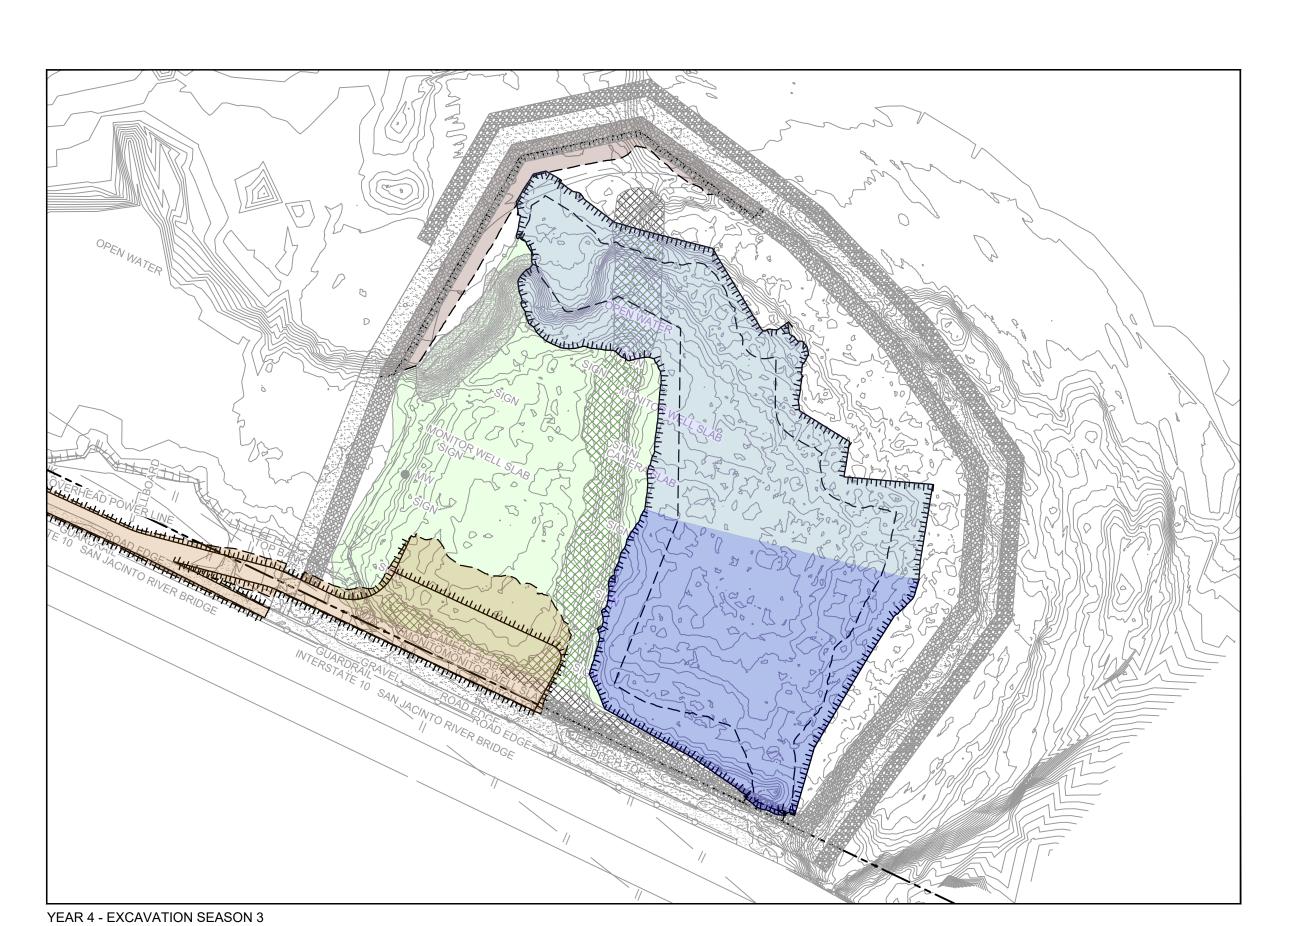


SOURCE:

TOPOGRAPHIC, HYDROGRAPHIC, & MAGNETOMETER SURVEY OF SAN JACINTO RIVER WASTE PITS, HARRIS COUNTY, TEXAS, MORRISON SURVEYING INC., 190608, JULY 8, 2019 TO AUGUST 2, 2019 UPDATED BATHYMETRY DATA PROVIDED BY ANCHOR QEA OCTOBER 2021
TXDOT RIGHT OF WAY FROM A BOUNDARY AND RIGHT-OF-WAY
SURVEY OF PORT OF HOUSTON AUTHORITY PROPERTY & HOUSTON FLEETING SERVICES, LLC PROPERTY ALONG INTERSTATE HIGHWAY 10 AT THE SAN JACINTO FLEET AREA, IN THE J. T. HARRELL SURVEY, A-330 HARRIS COUNTY, TEXAS, COBBFENDLEY, 2402-028-01, JUNE 28,

ARE APPROXIMATE AND SUBJECT TO CHANGE.

1. SEASONAL EXCAVATION AREAS, VOLUMES, AND SEQUENCING

Plot Date: 17 July 2024 - 12:54 PM

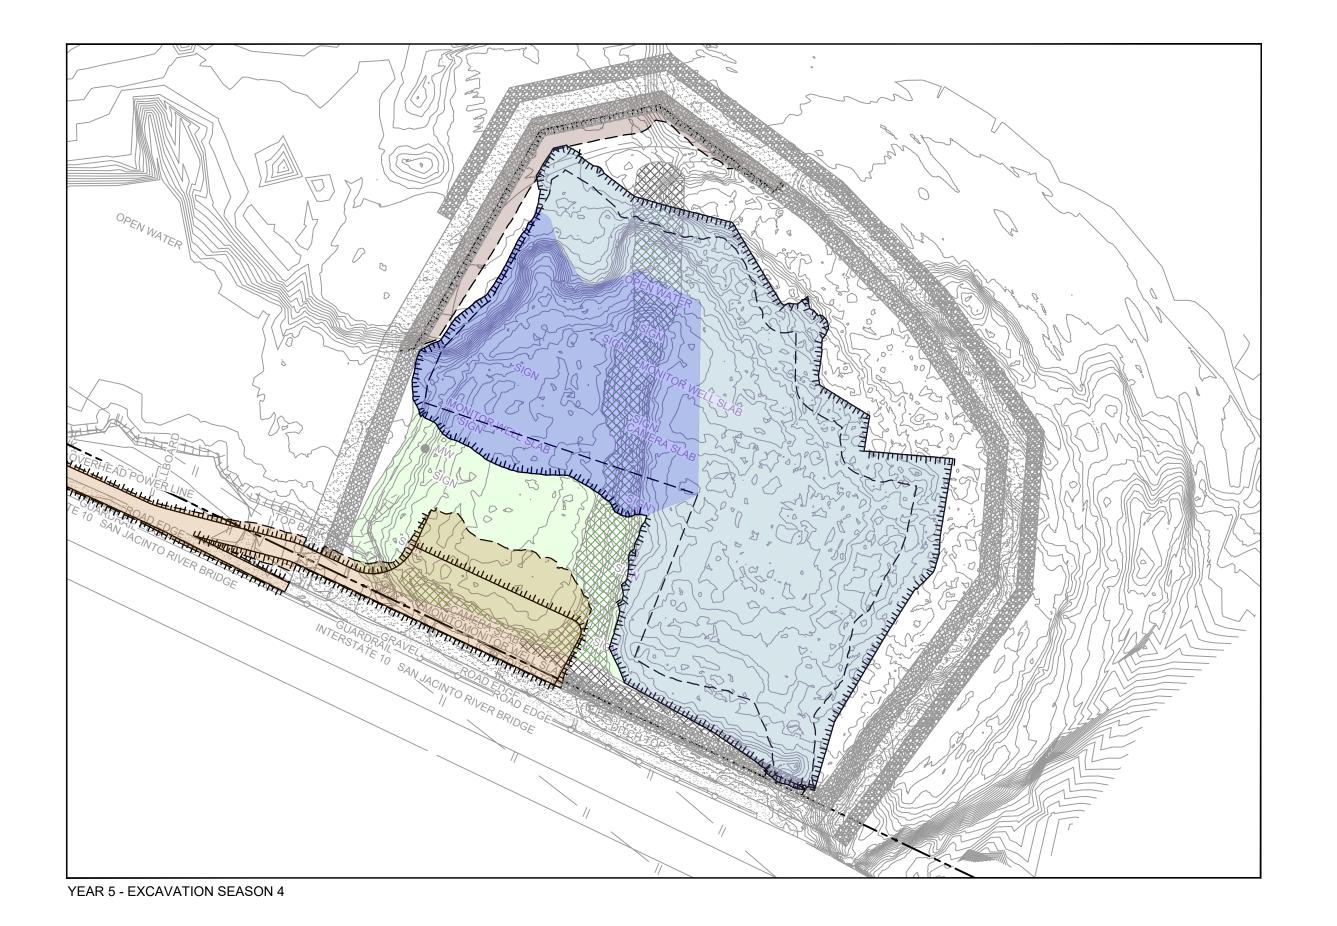





THIS DOCUMENT IS RELEASED FOR THE PURPOSE OF

EPA REVIEW UNDER THE AUTHORITY OF CLARENCE R. HOEKSTRA, P.E. 147936 ON 07/17/2024. IT IS NOT TO BE

USED FOR CONSTRUCTION, BIDDING, RECORDATION,


GHD SERVICES INC.

100% EPA SUBMITTAL

CONVEYANCE OR SALES PURPOSES.




2237 S Acadian Thruway Suite 701 Baton Rouge Louisiana 70808 USA **T** 225 292 9007

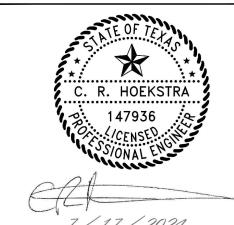

Reuse of Documents

This document and the ideas and designs incorporated herein, as an instrument of professional service, is the property of GHD and shall not be reused in whole or in part for any other project without GHD's written authorization. © 2024 GHD

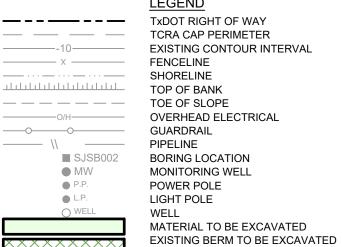

FOR POTENTIAL TESTING AND REUSE EXISTING BERM TO REMAIN CONCRETE GRAVEL AZ26-700 PILE AZ36-700 PILE AZ42-700 PILE PHASE OF EXCAVATION PLANNED IMPROVEMENTS FOR

NORTHERN IMPOUNDMENT ACCESS RESTORED AREA INCLUDING TOPSOIL PLACEMENT AND SEEDING TO RIVER LEVEL RAISED BENCH EXTERIOR SCOUR PROTECTION INTERIOR SCOUR PROTECTION

SAN JACINTO RIVER

WASTE PITS

NORTHERN IMPOUNDMENT FINAL 100% REMEDIAL DESIGN HARRIS COUNTY, TEXAS

4	100% EPA SUBMITTAL	MW	CRH	07/17/
No.	Issue	Drawn	Approved	Dat
Draw	n MW	Designer	RH	
Drafting JC Check		Design Check	LL	
Proje Coor	ct dinator CM	Date	Jul 16, 20	24
This document shall not be used for construction unless signed and sealed for construction.		Scale	1" = 150'	

Arch D

Project No. **11215702**

Original Size


CONSTRUCTION **SEQUENCING**

Bar is one inch on original size drawing

2 OF 2

Sheet No.

C-24

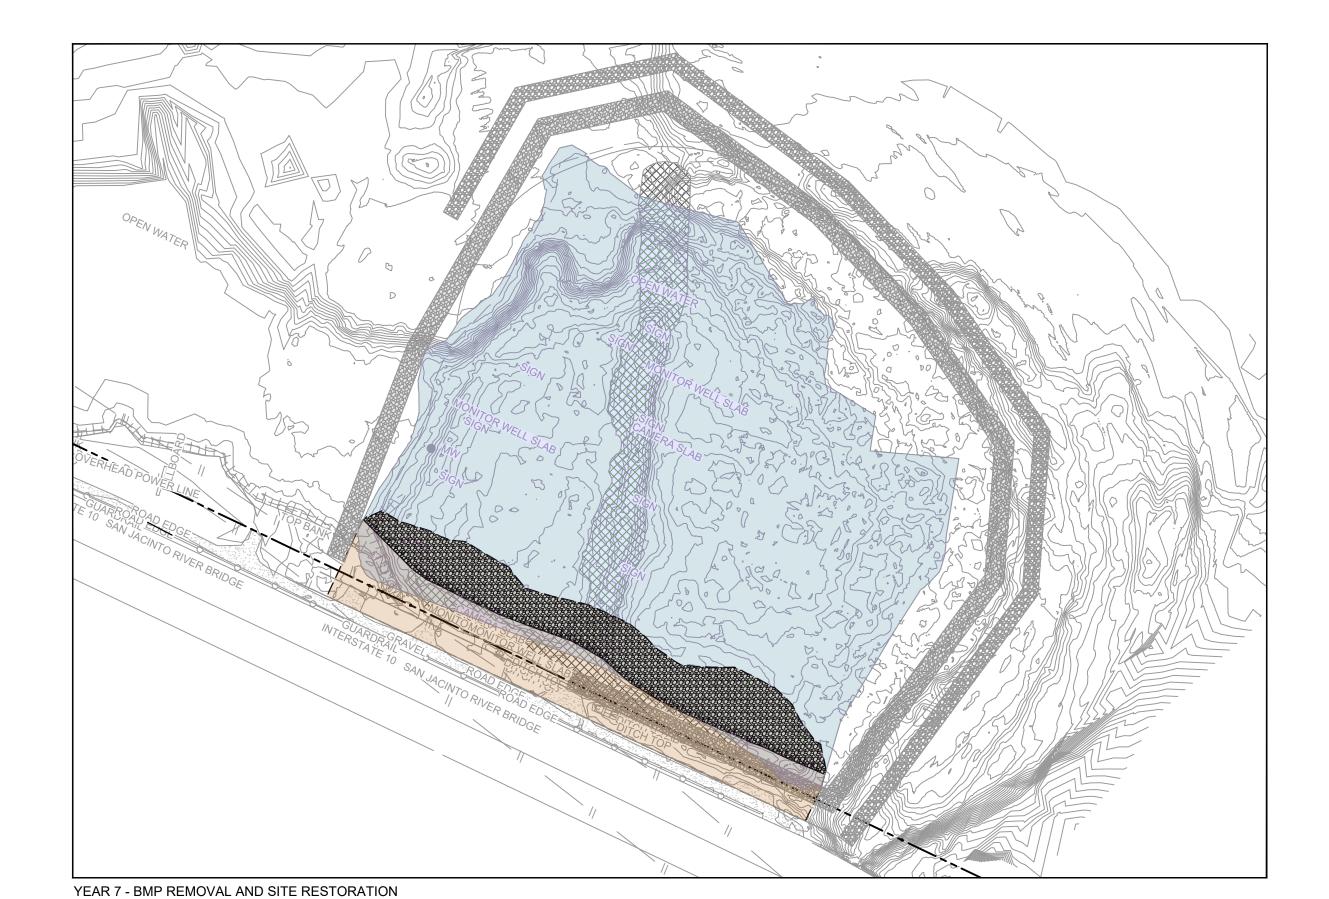

SOURCE:


TOPOGRAPHIC, HYDROGRAPHIC, & MAGNETOMETER SURVEY OF SAN JACINTO RIVER WASTE PITS, HARRIS COUNTY, TEXAS, MORRISON


1. SEASONAL EXCAVATION AREAS, VOLUMES, AND SEQUENCING


YEAR 6 - EXCAVATION SEASON 5

SURVEYING INC., 190608, JULY 8, 2019 TO AUGUST 2, 2019 UPDATED BATHYMETRY DATA PROVIDED BY ANCHOR QEA OCTOBER 2021 TxDOT RIGHT OF WAY FROM A BOUNDARY AND RIGHT-OF-WAY SURVEY OF PORT OF HOUSTON AUTHORITY PROPERTY & HOUSTON FLEETING SERVICES, LLC PROPERTY ALONG INTERSTATE HIGHWAY 10 AT THE SAN JACINTO FLEET AREA, IN THE J. T. HARRELL SURVEY, A-330 HARRIS COUNTY, TEXAS, COBBFENDLEY, 2402-028-01, JUNE 28,


ARE APPROXIMATE AND SUBJECT TO CHANGE.

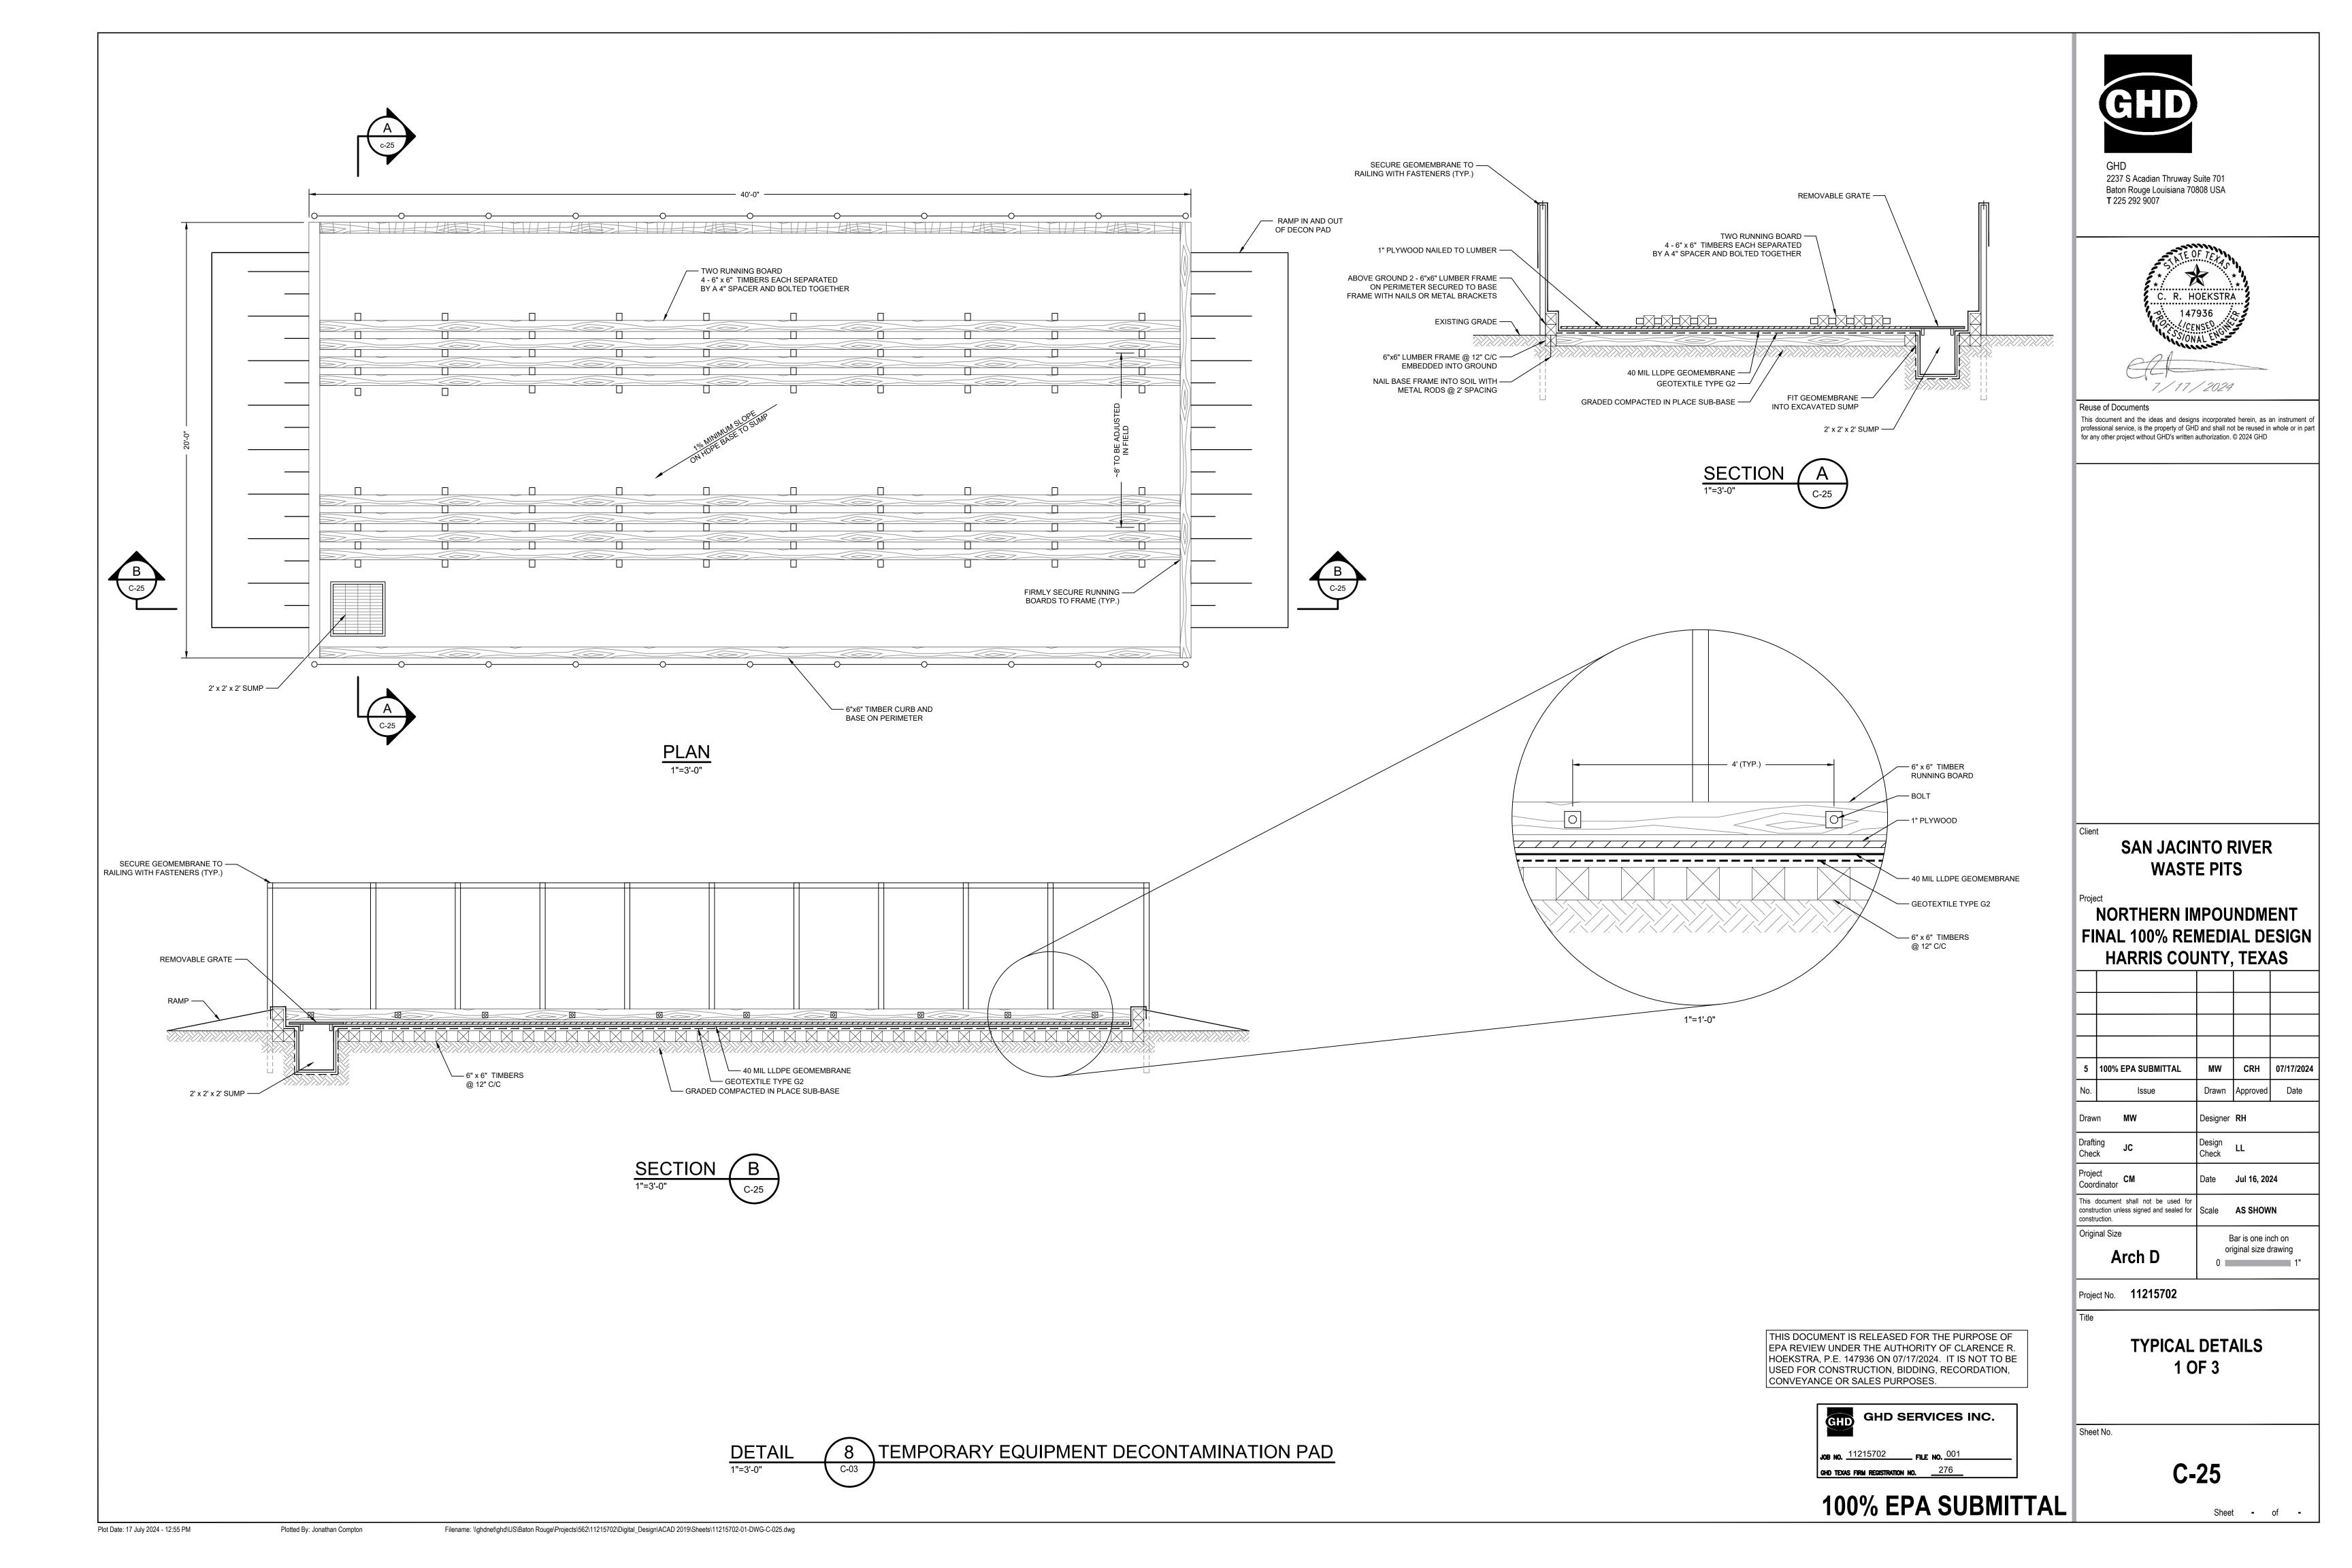

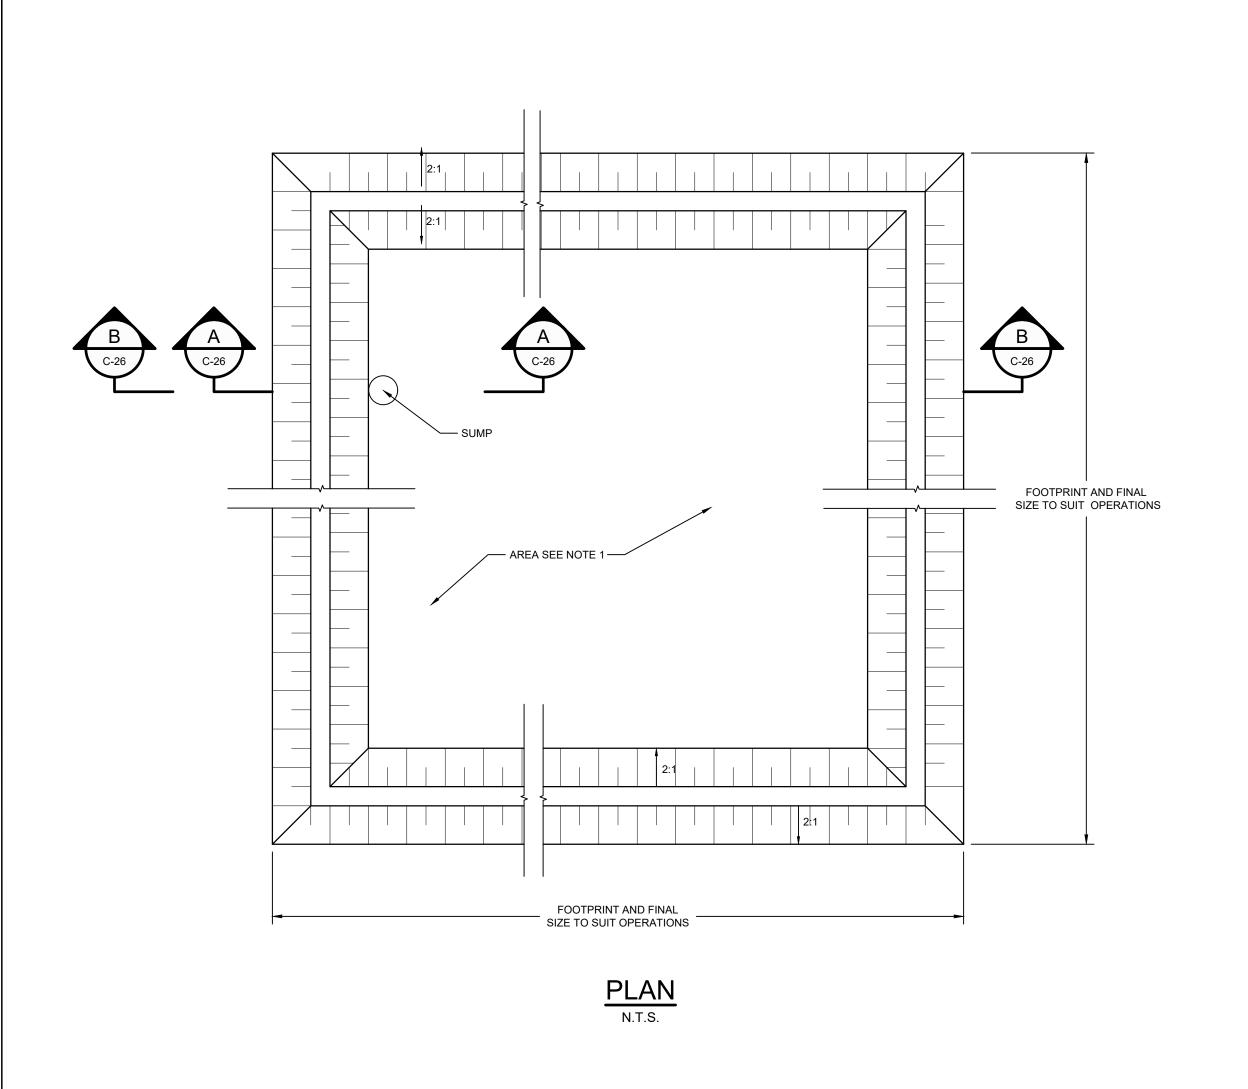

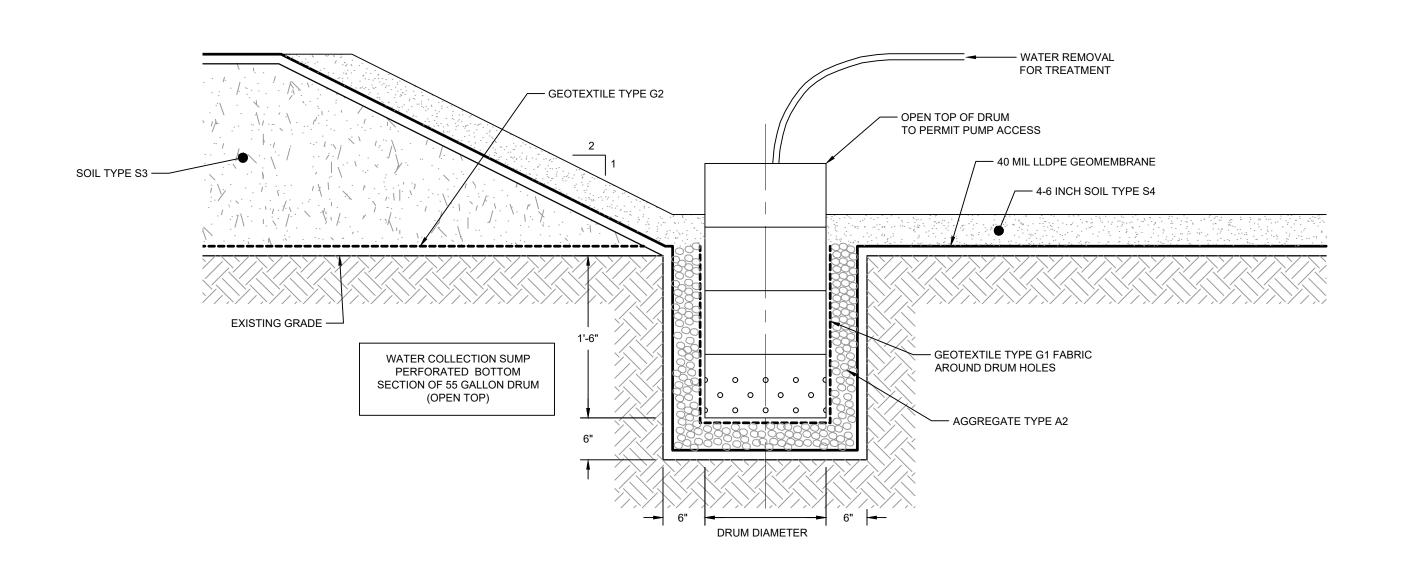


1. TYPICAL DETAILS SHOWN AT DEWATERING AND SOLIDIFICATION AREA MAY BE REVISED BY THE CONTRACTOR. CONTRACTOR'S REVISED DETAILS SHALL BE SUBMITTED FOR REVIEW PRIOR TO CONSTRUCTION.

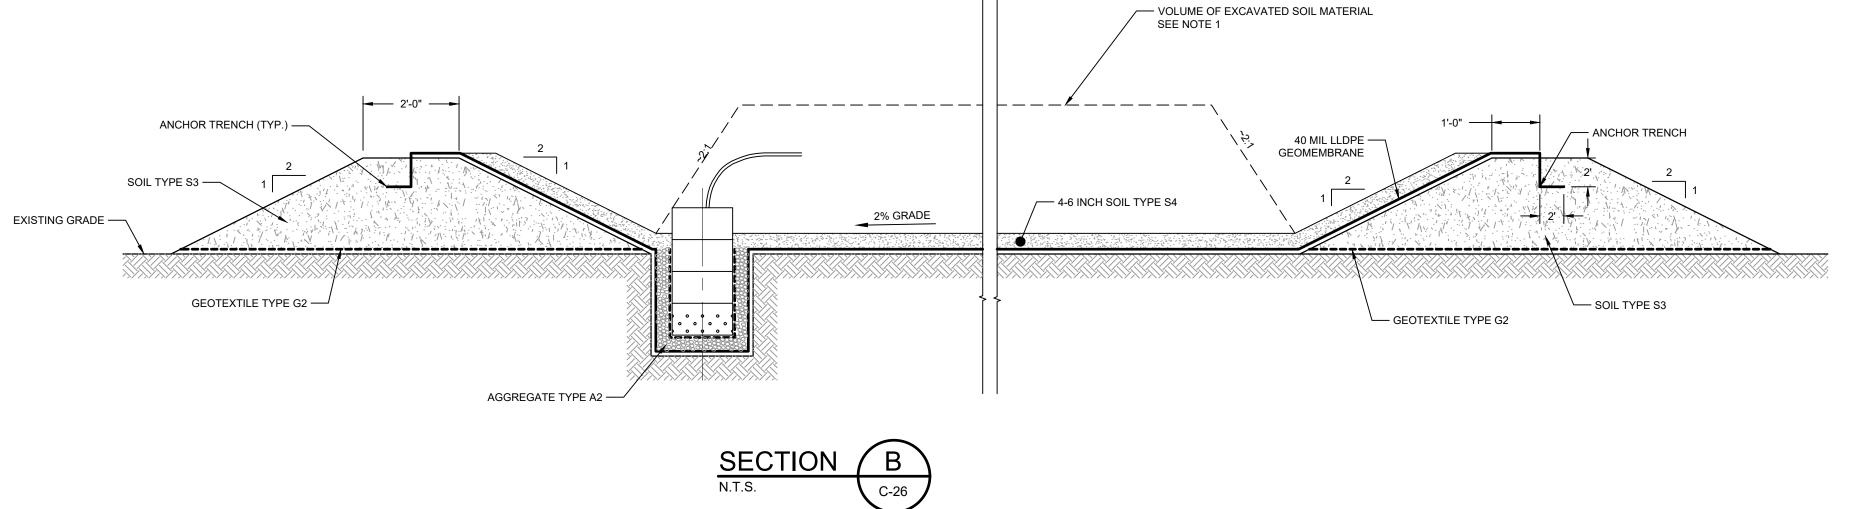

9 TEMPORARY DEWATERING FACILITY


THIS DOCUMENT IS RELEASED FOR THE PURPOSE OF EPA REVIEW UNDER THE AUTHORITY OF CLARENCE R. HOEKSTRA, P.E. 147936 ON 07/17/2024. IT IS NOT TO BE USED FOR CONSTRUCTION, BIDDING, RECORDATION, CONVEYANCE OR SALES PURPOSES.

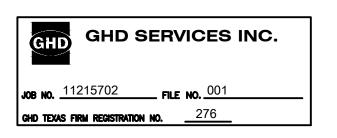

100% EPA SUBMITTAL



2237 S Acadian Thruway Suite 701 Baton Rouge Louisiana 70808 USA **T** 225 292 9007

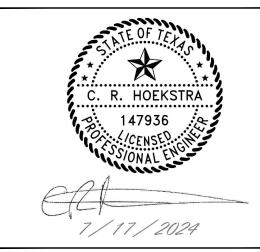

Reuse of Documents This document and the ideas and designs incorporated herein, as an instrument of professional service, is the property of GHD and shall not be reused in whole or in part for any other project without GHD's written authorization. © 2024 GHD

SAN JACINTO RIVER WASTE PITS

NORTHERN IMPOUNDMENT FINAL 100% REMEDIAL DESIGN HARRIS COUNTY, TEXAS

5	100% EPA SUBMITTAL	MW	CRH	07/17/2
No.	Issue	Drawn	Approved	Dat
Draw	n MW	Designer	RH	
Drafti Chec	• .IC.	Design Check	LL	
Proje Coor	ct dinator	Date	Jul 16, 20	24
	document shall not be used for uction unless signed and sealed for uction.	Scale	N.T.S.	

Arch D

Project No. **11215702**

Original Size


TYPICAL DETAILS

2 OF 3


Bar is one inch on original size drawing

Sheet No.

C-26 Sheet - of -

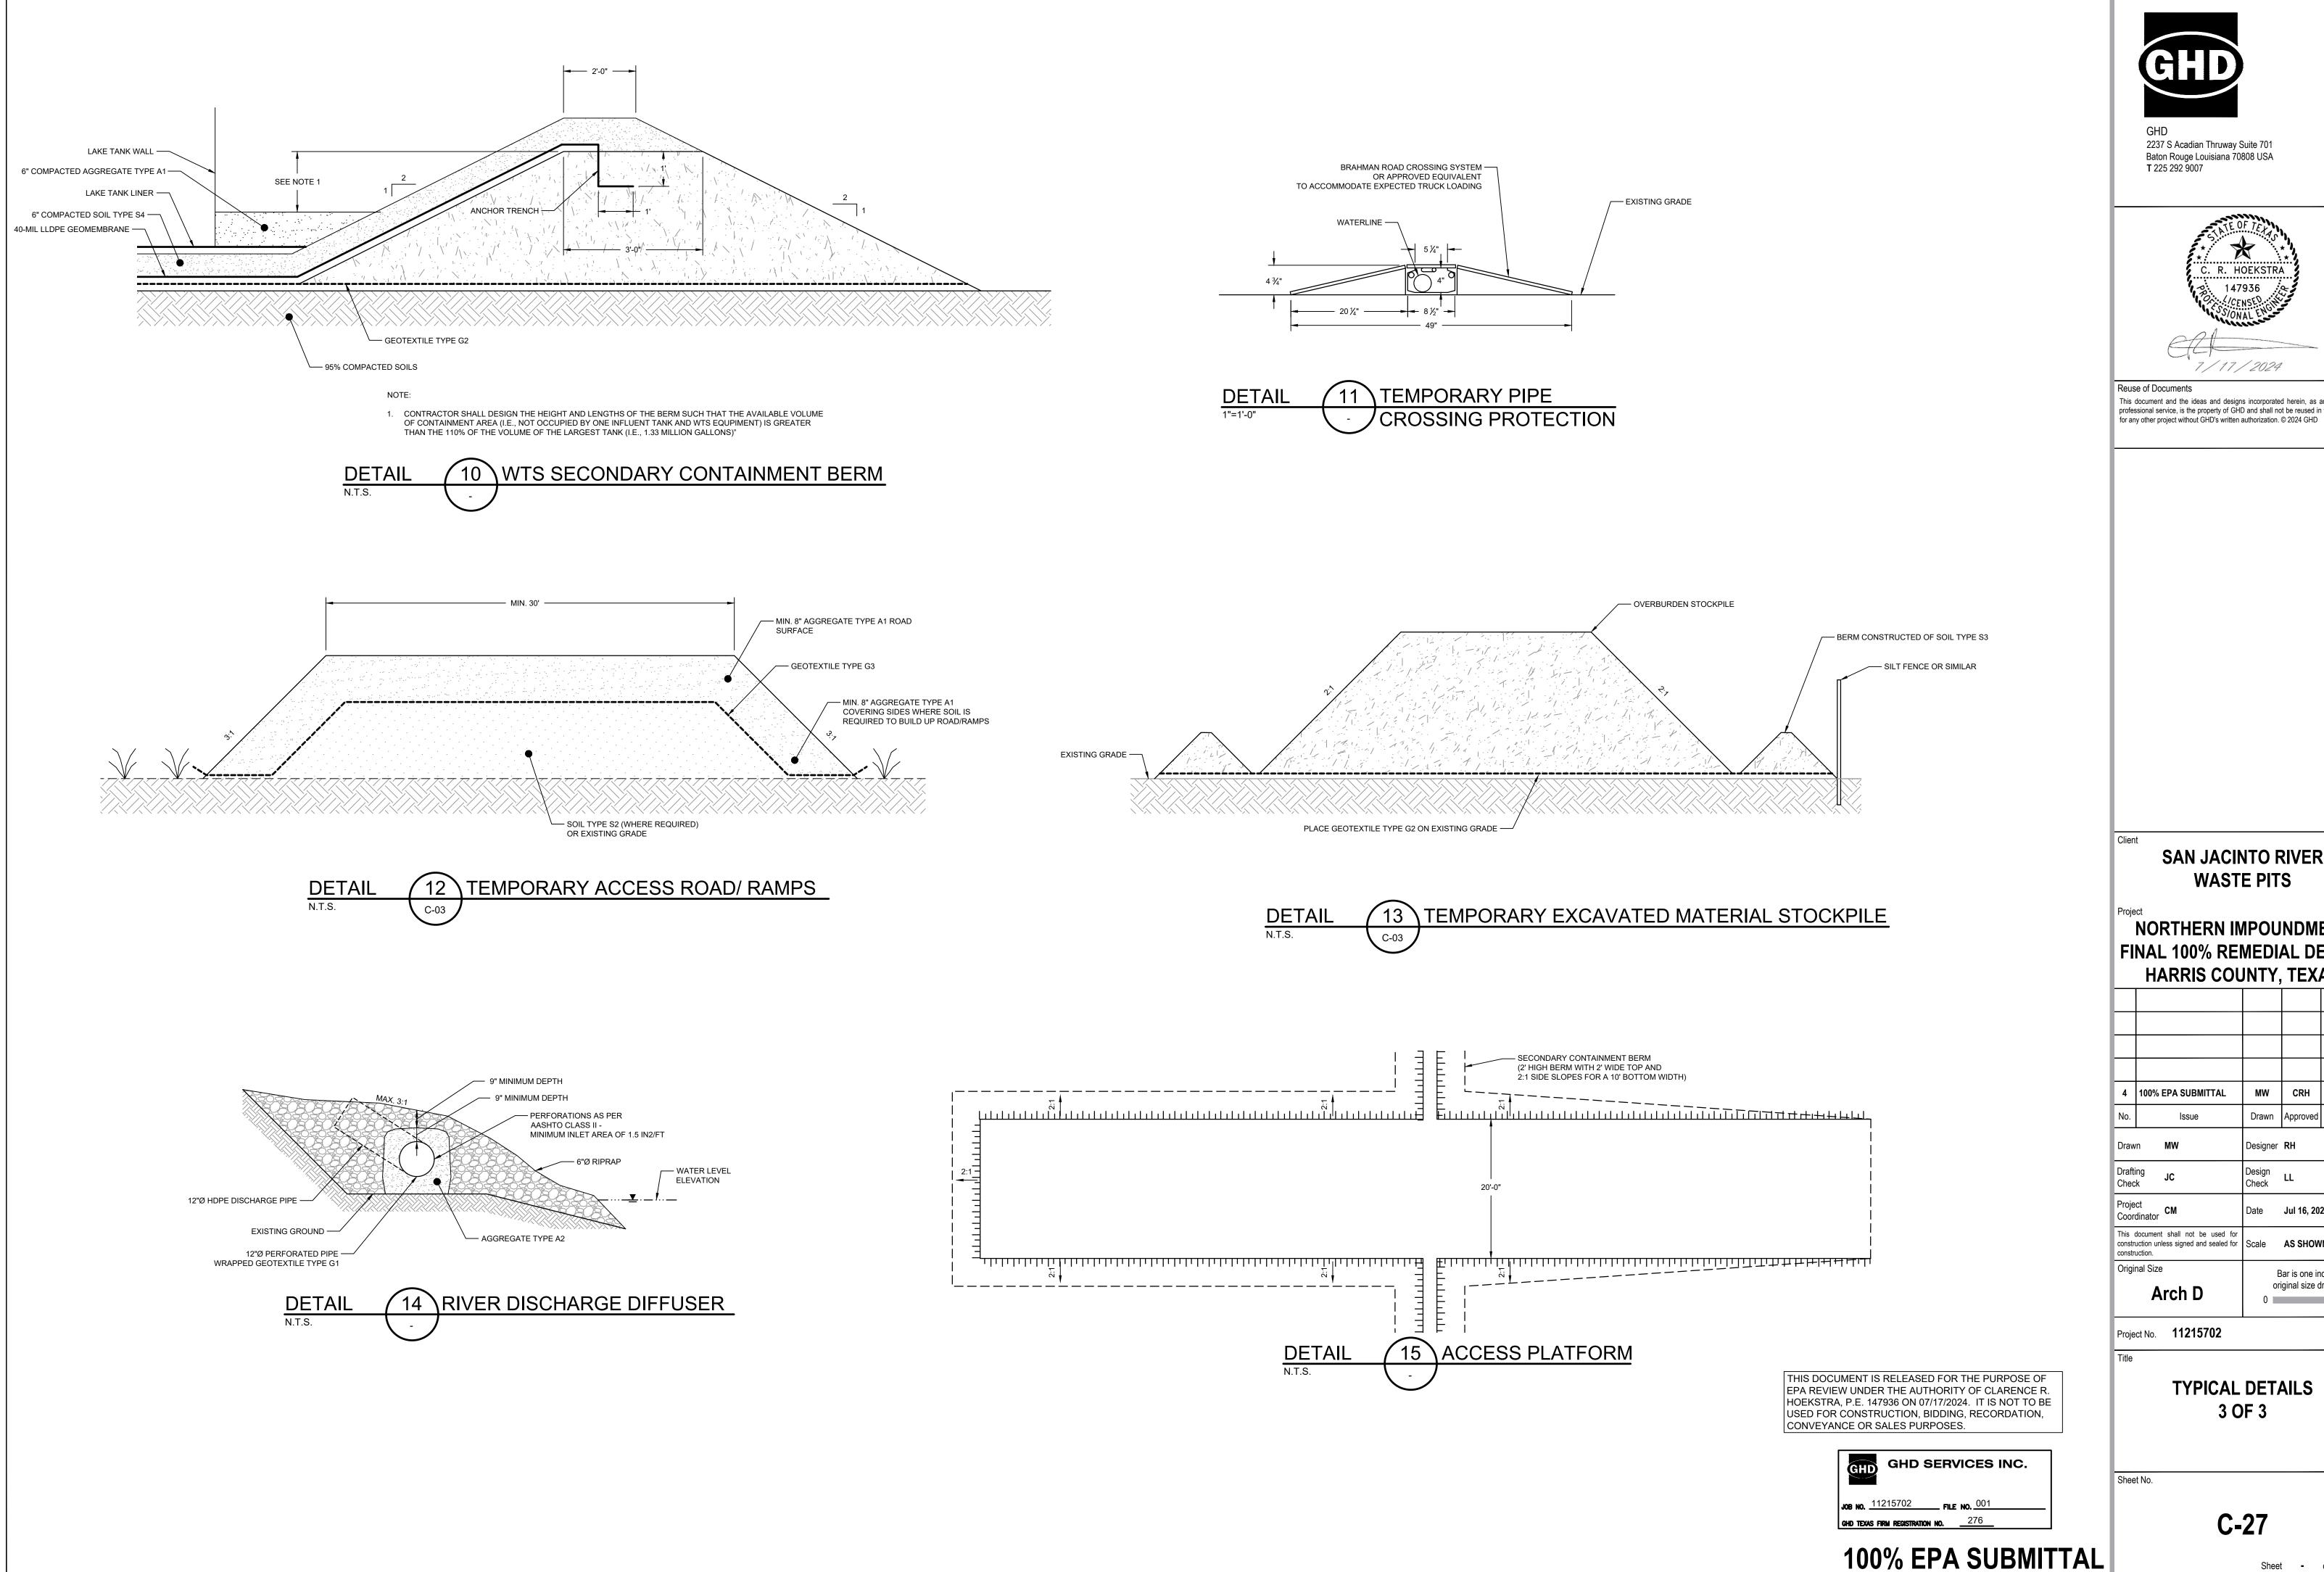

2237 S Acadian Thruway Suite 701 Baton Rouge Louisiana 70808 USA

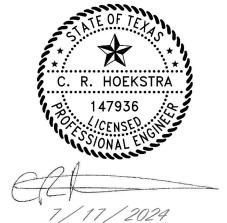

This document and the ideas and designs incorporated herein, as an instrument of professional service, is the property of GHD and shall not be reused in whole or in part

SAN JACINTO RIVER WASTE PITS


NORTHERN IMPOUNDMENT FINAL 100% REMEDIAL DESIGN HARRIS COUNTY, TEXAS


4	100% EPA SUBMITTAL	MW	CRH	07/17/202
No.	Issue	Drawn	Approved	Date
Draw	n MW	Designer	RH	
Drafti Chec	· .I(.	Design Check	LL	
Proje Coord	ct dinator CM	Date	Jul 16, 20	24
	document shall not be used for uction unless signed and sealed for uction.	Scale	AS SHOW	/N

TYPICAL DETAILS

C-27 Sheet - of -

Bar is one inch on original size drawing

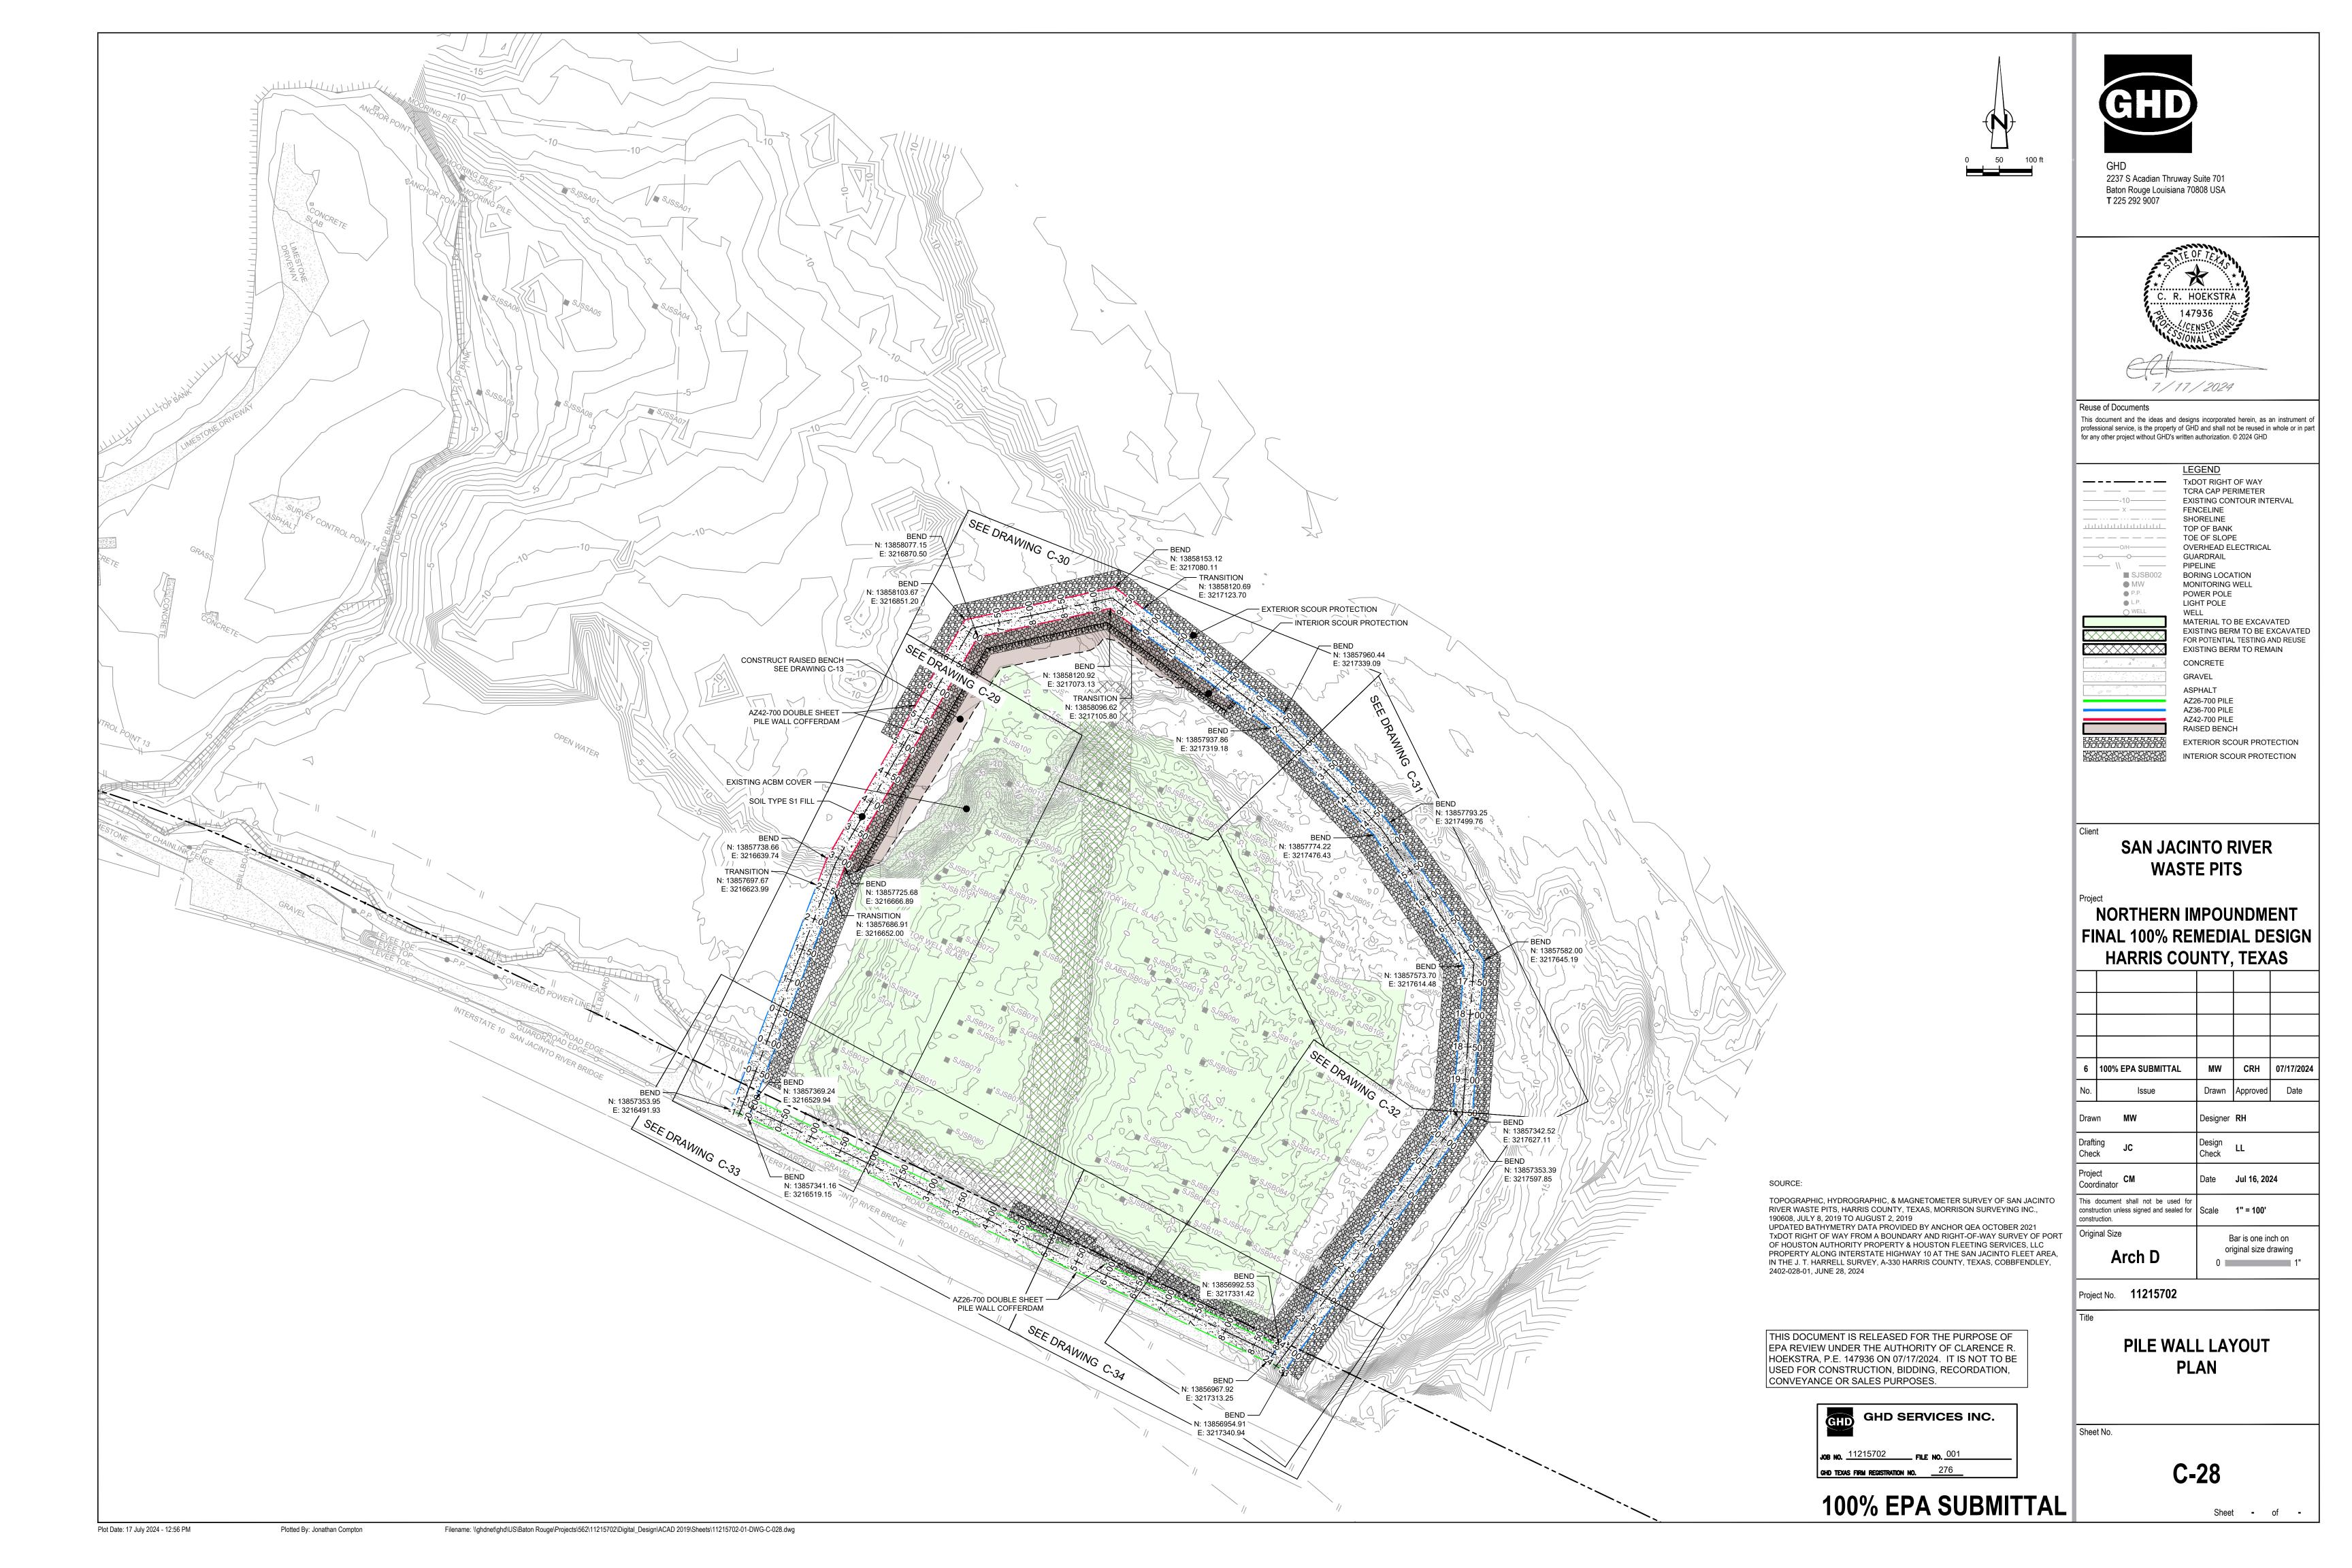

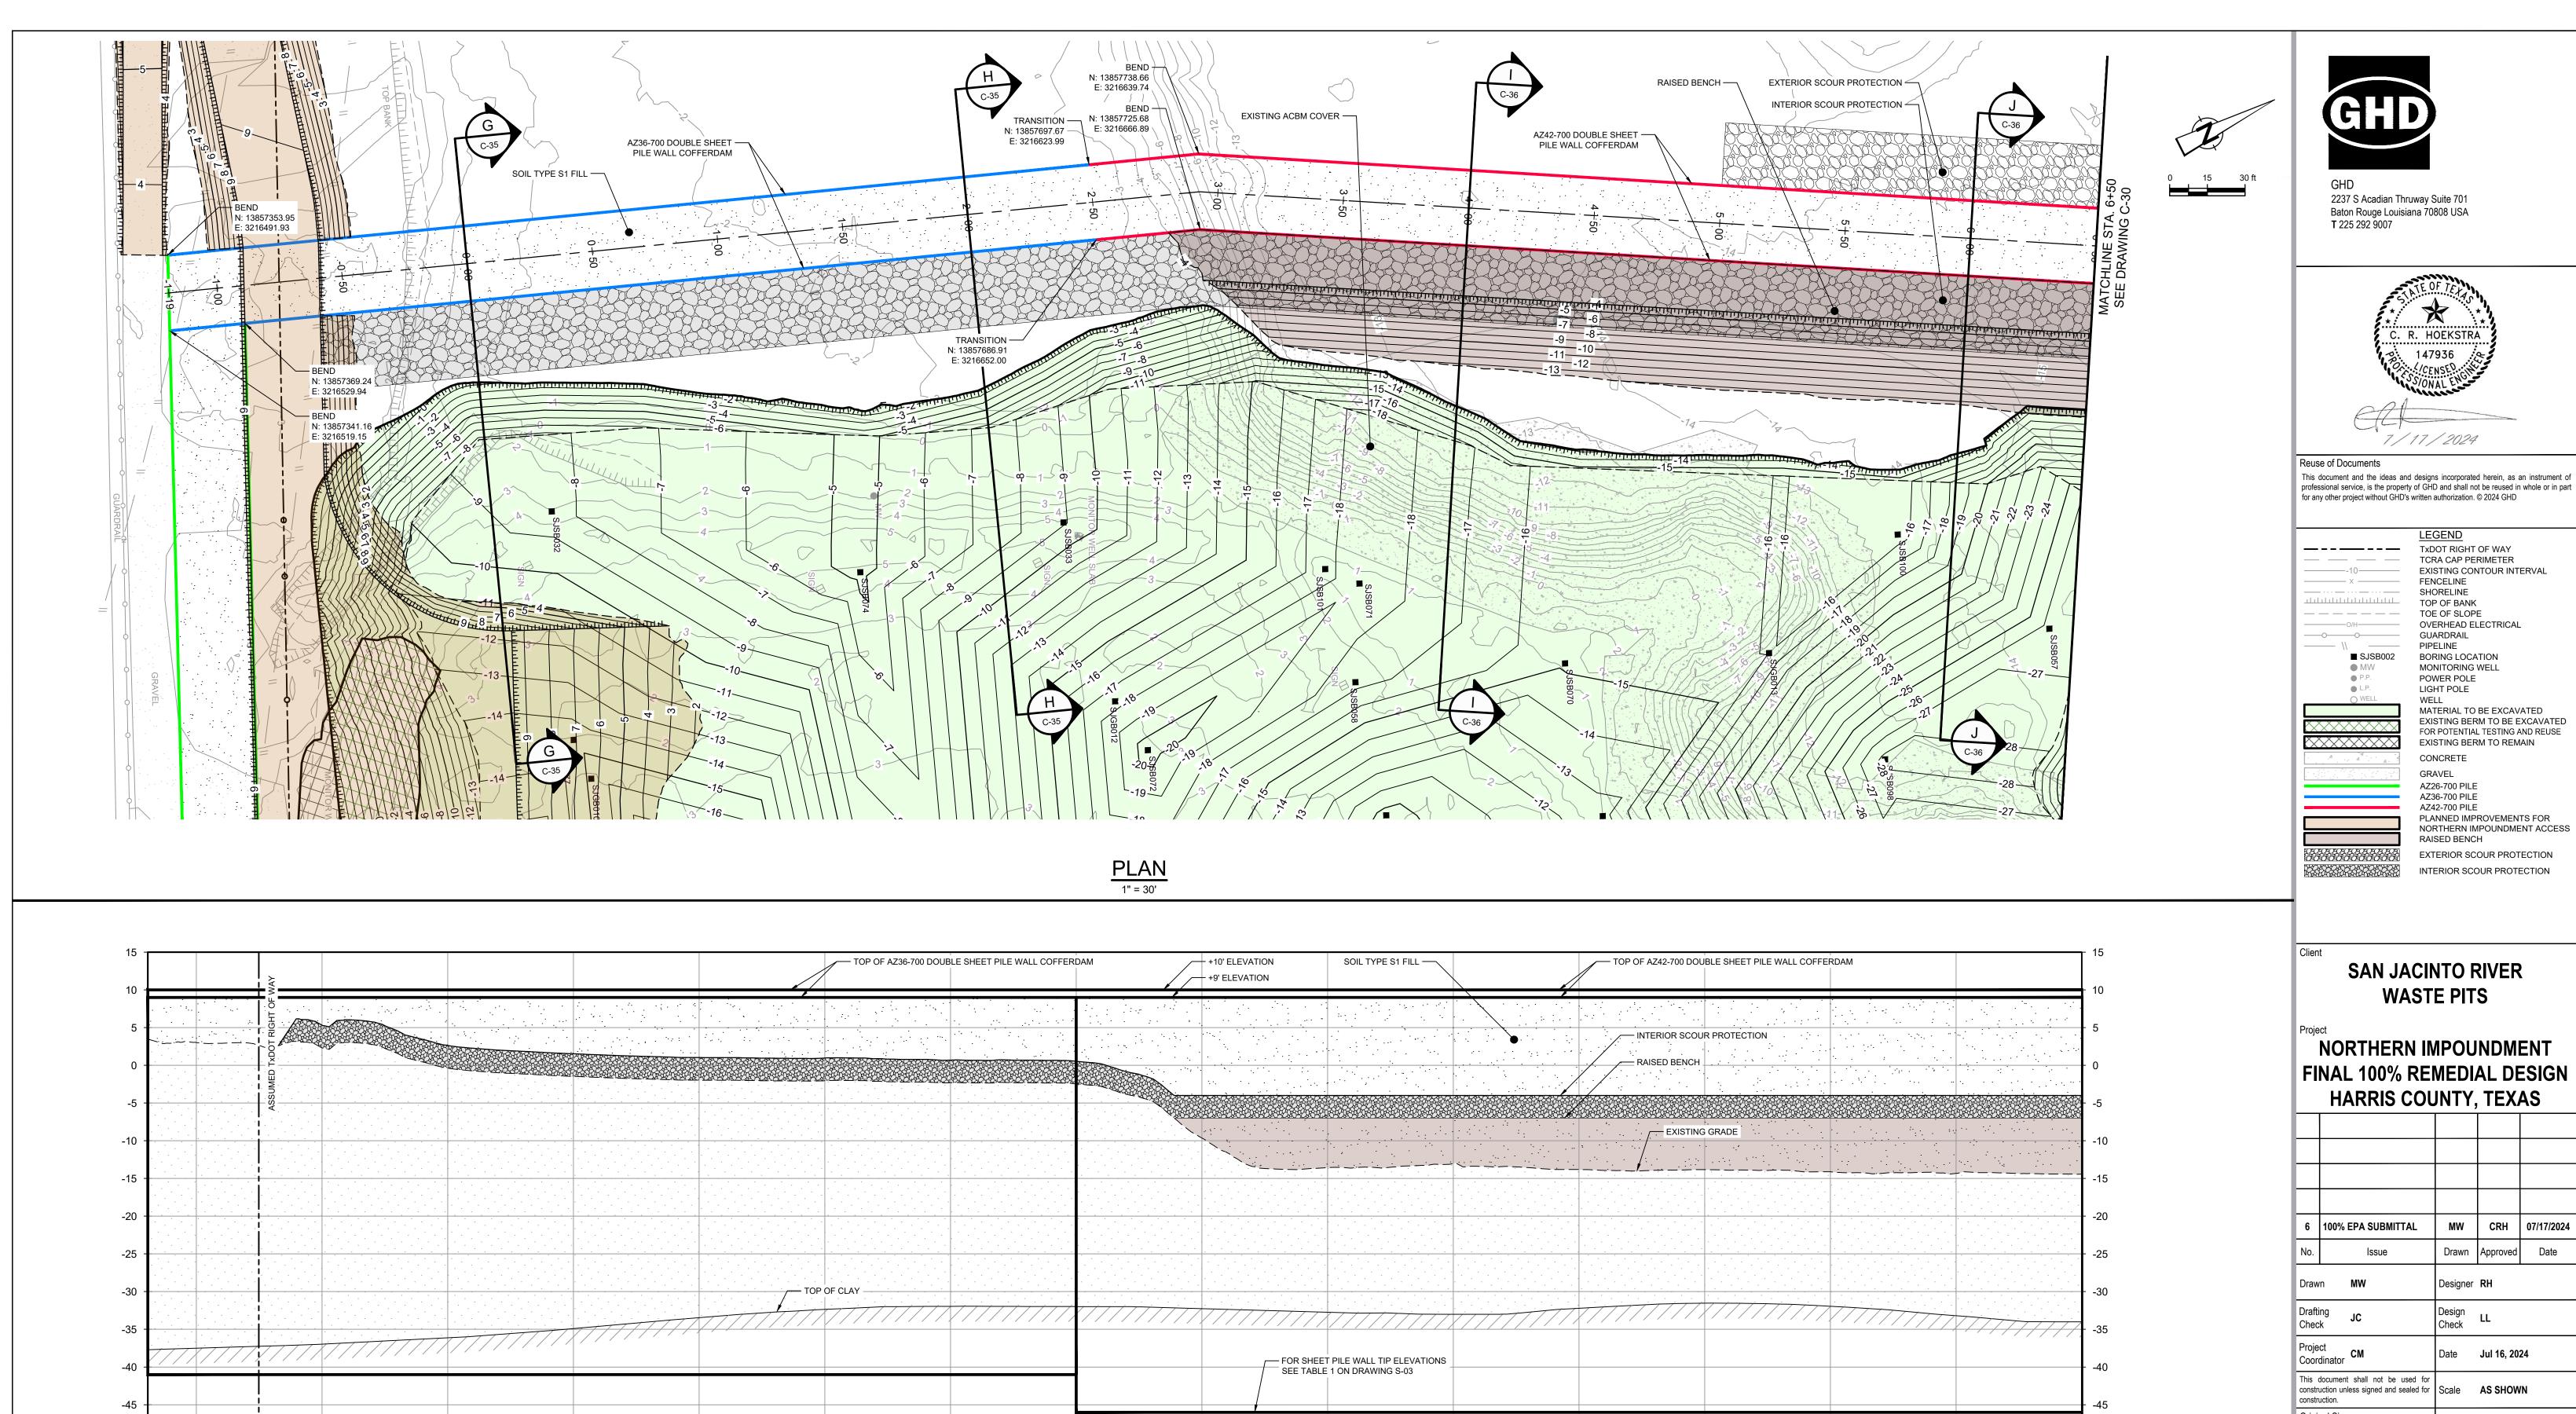

PROFILE

HORIZ: 1" = 30'

VERT: 1" = 10'

TOPOGRAPHIC, HYDROGRAPHIC, & MAGNETOMETER SURVEY OF SAN JACINTO RIVER WASTE PITS, HARRIS COUNTY, TEXAS, MORRISON SURVEYING INC., 190608, JULY 8, 2019 TO AUGUST 2, 2019 UPDATED BATHYMETRY DATA PROVIDED BY ANCHOR QEA OCTOBER 2021 TXDOT RIGHT OF WAY FROM A BOUNDARY AND RIGHT-OF-WAY SURVEY OF PORT OF HOUSTON AUTHORITY PROPERTY & HOUSTON FLEETING SERVICES, LLC PROPERTY ALONG INTERSTATE HIGHWAY 10 AT THE SAN JACINTO FLEET AREA. IN THE J. T. HARRELL SURVEY, A-330 HARRIS COUNTY, TEXAS, COBBFENDLEY, 2402-028-01, JUNE 28, 2024

1. FINAL EXCAVATION CONTOURS ARE SUBJECT TO CHANGE.

3. FRP BARRIER WALL NOT SHOWN FOR CLARITY.

THIS DOCUMENT IS RELEASED FOR THE PURPOSE OF EPA REVIEW UNDER THE AUTHORITY OF CLARENCE R. HOEKSTRA, P.E. 147936 ON 07/17/2024. IT IS NOT TO BE USED FOR CONSTRUCTION, BIDDING, RECORDATION, CONVEYANCE OR SALES PURPOSES.



EXIST.


÷ ELEA∵

STA

100% EPA SUBMITTAL

SAN JACINTO RIVER

NORTHERN IMPOUNDMENT FINAL 100% REMEDIAL DESIGN

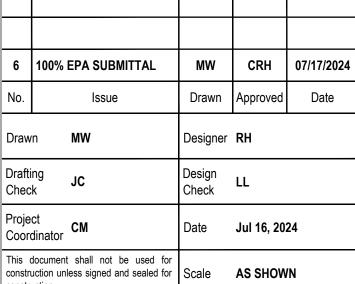

Original Size Arch D

Bar is one inch on original size drawing 0 1"

Project No. **11215702**

DOUBLE PILE WALL PLAN AND PROFILE 1 OF 4


Sheet No.


C-29


Sheet - of -


EXIST ELEV.


STA

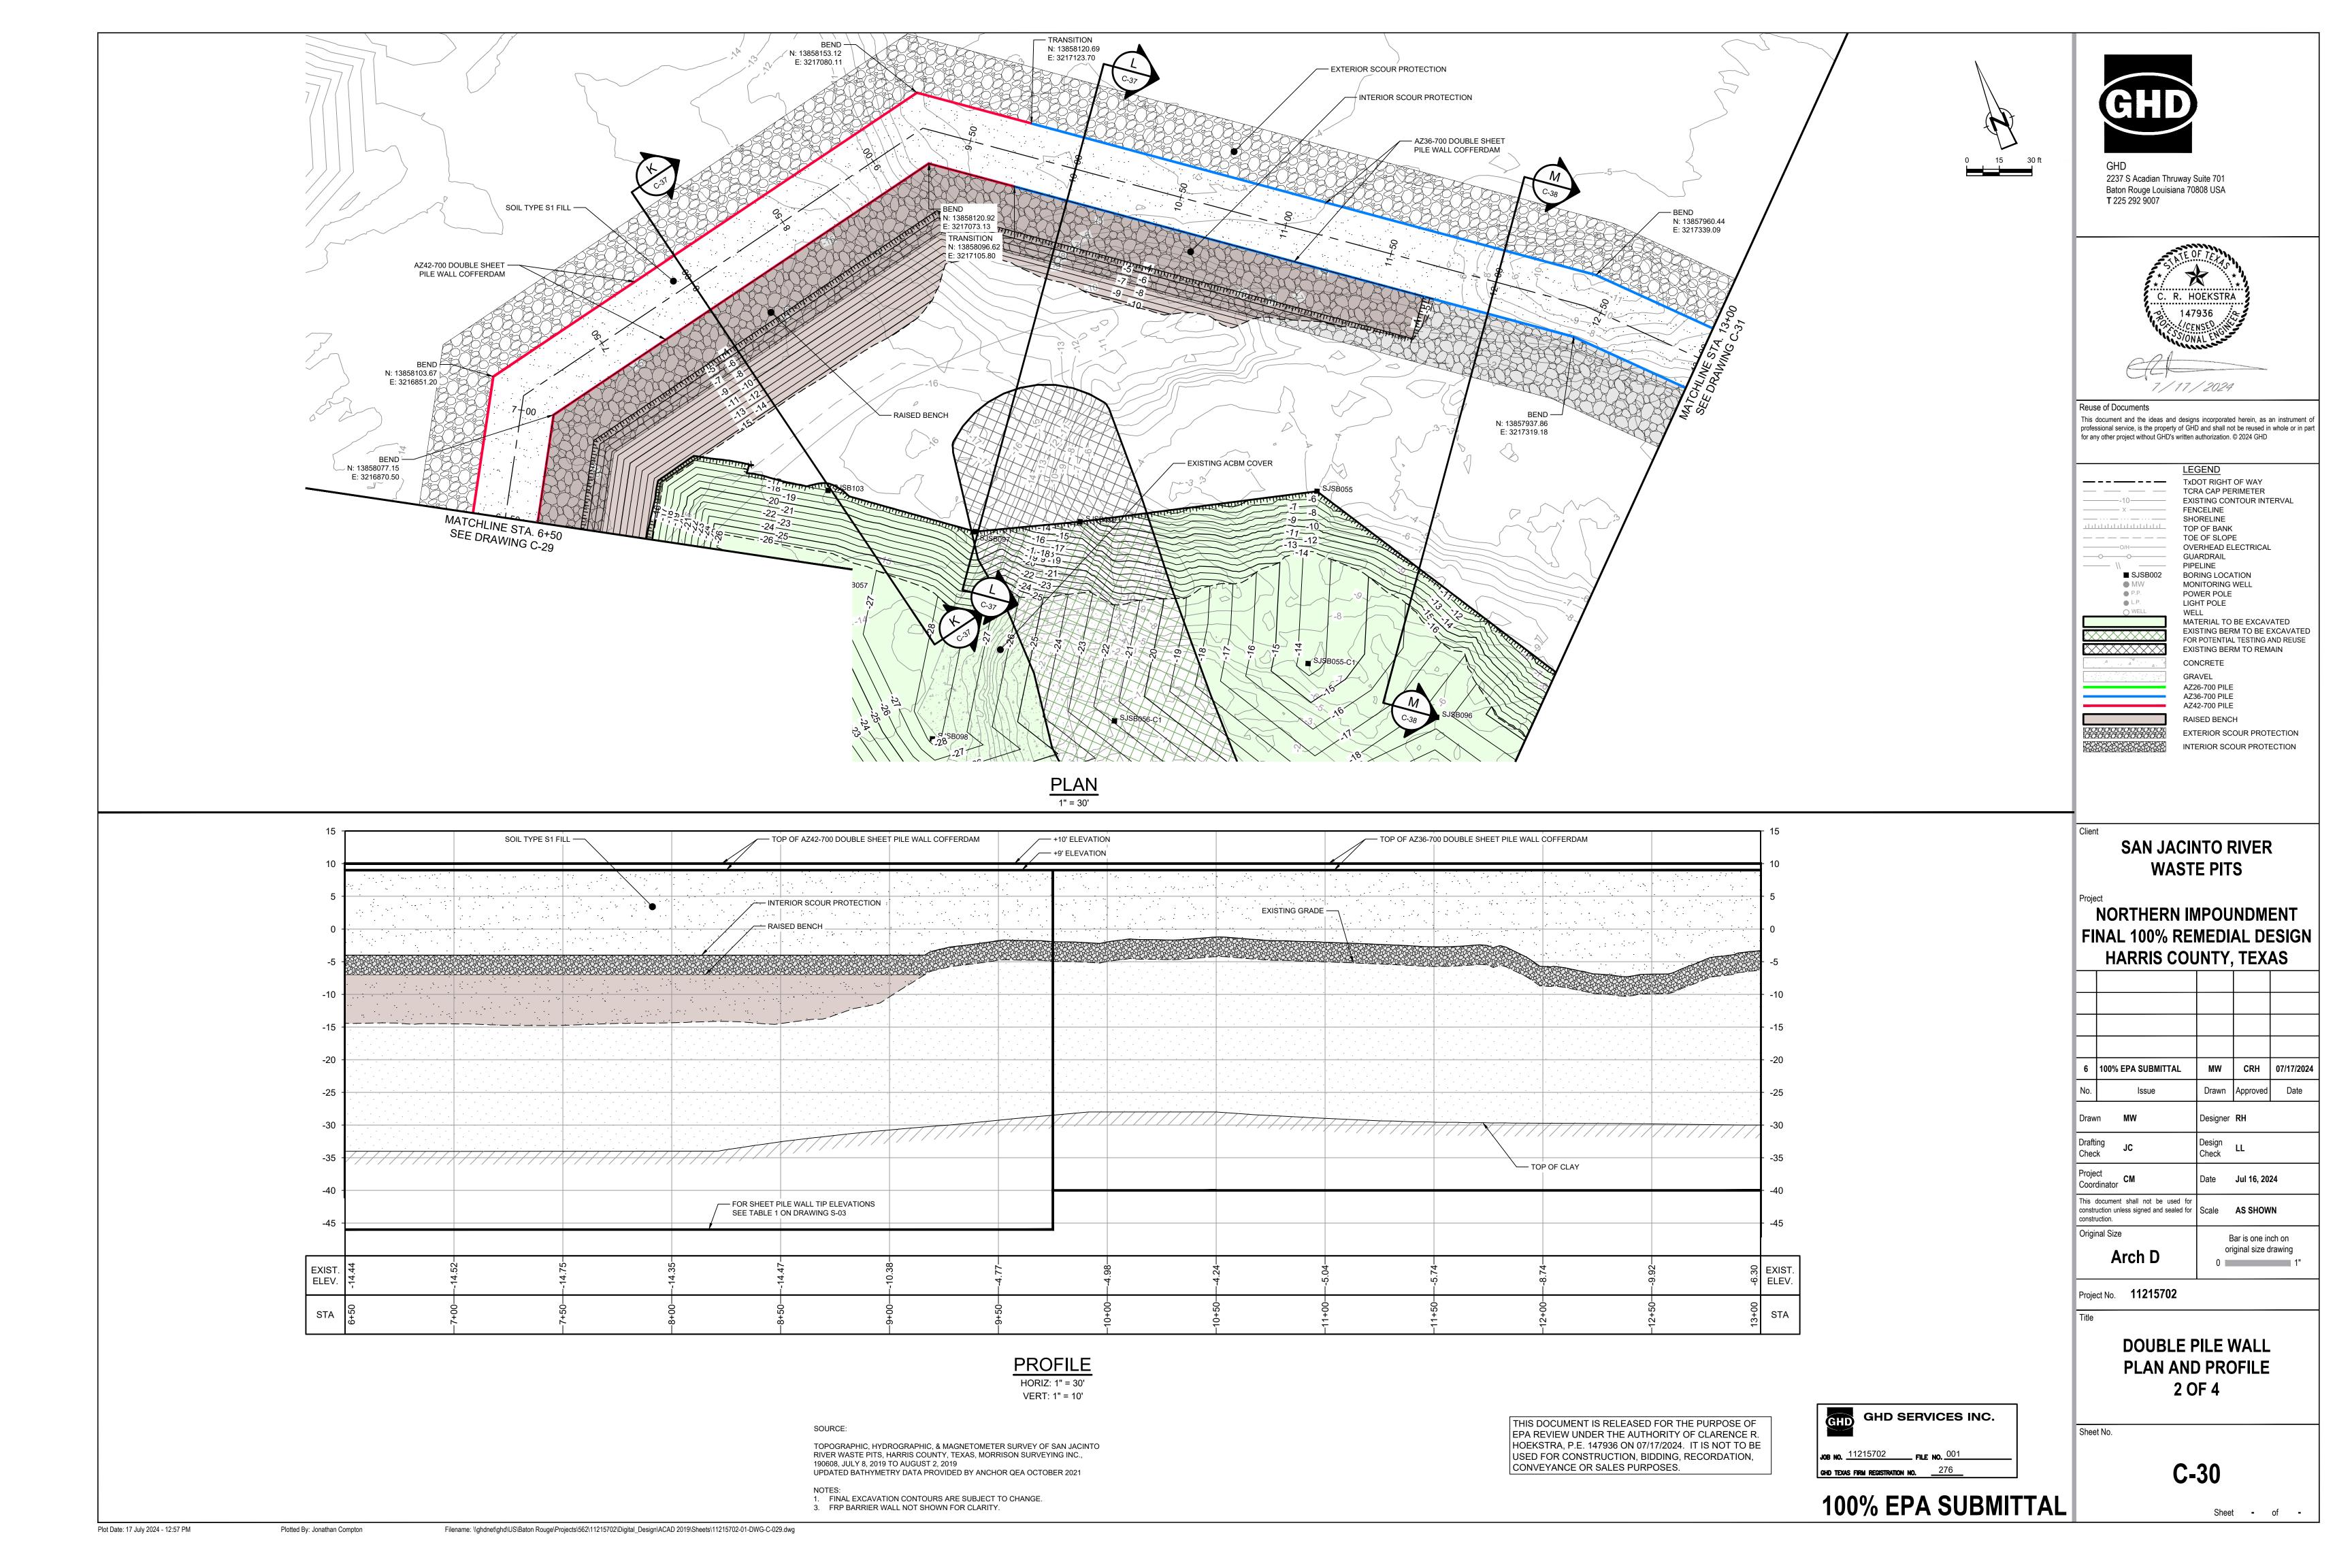

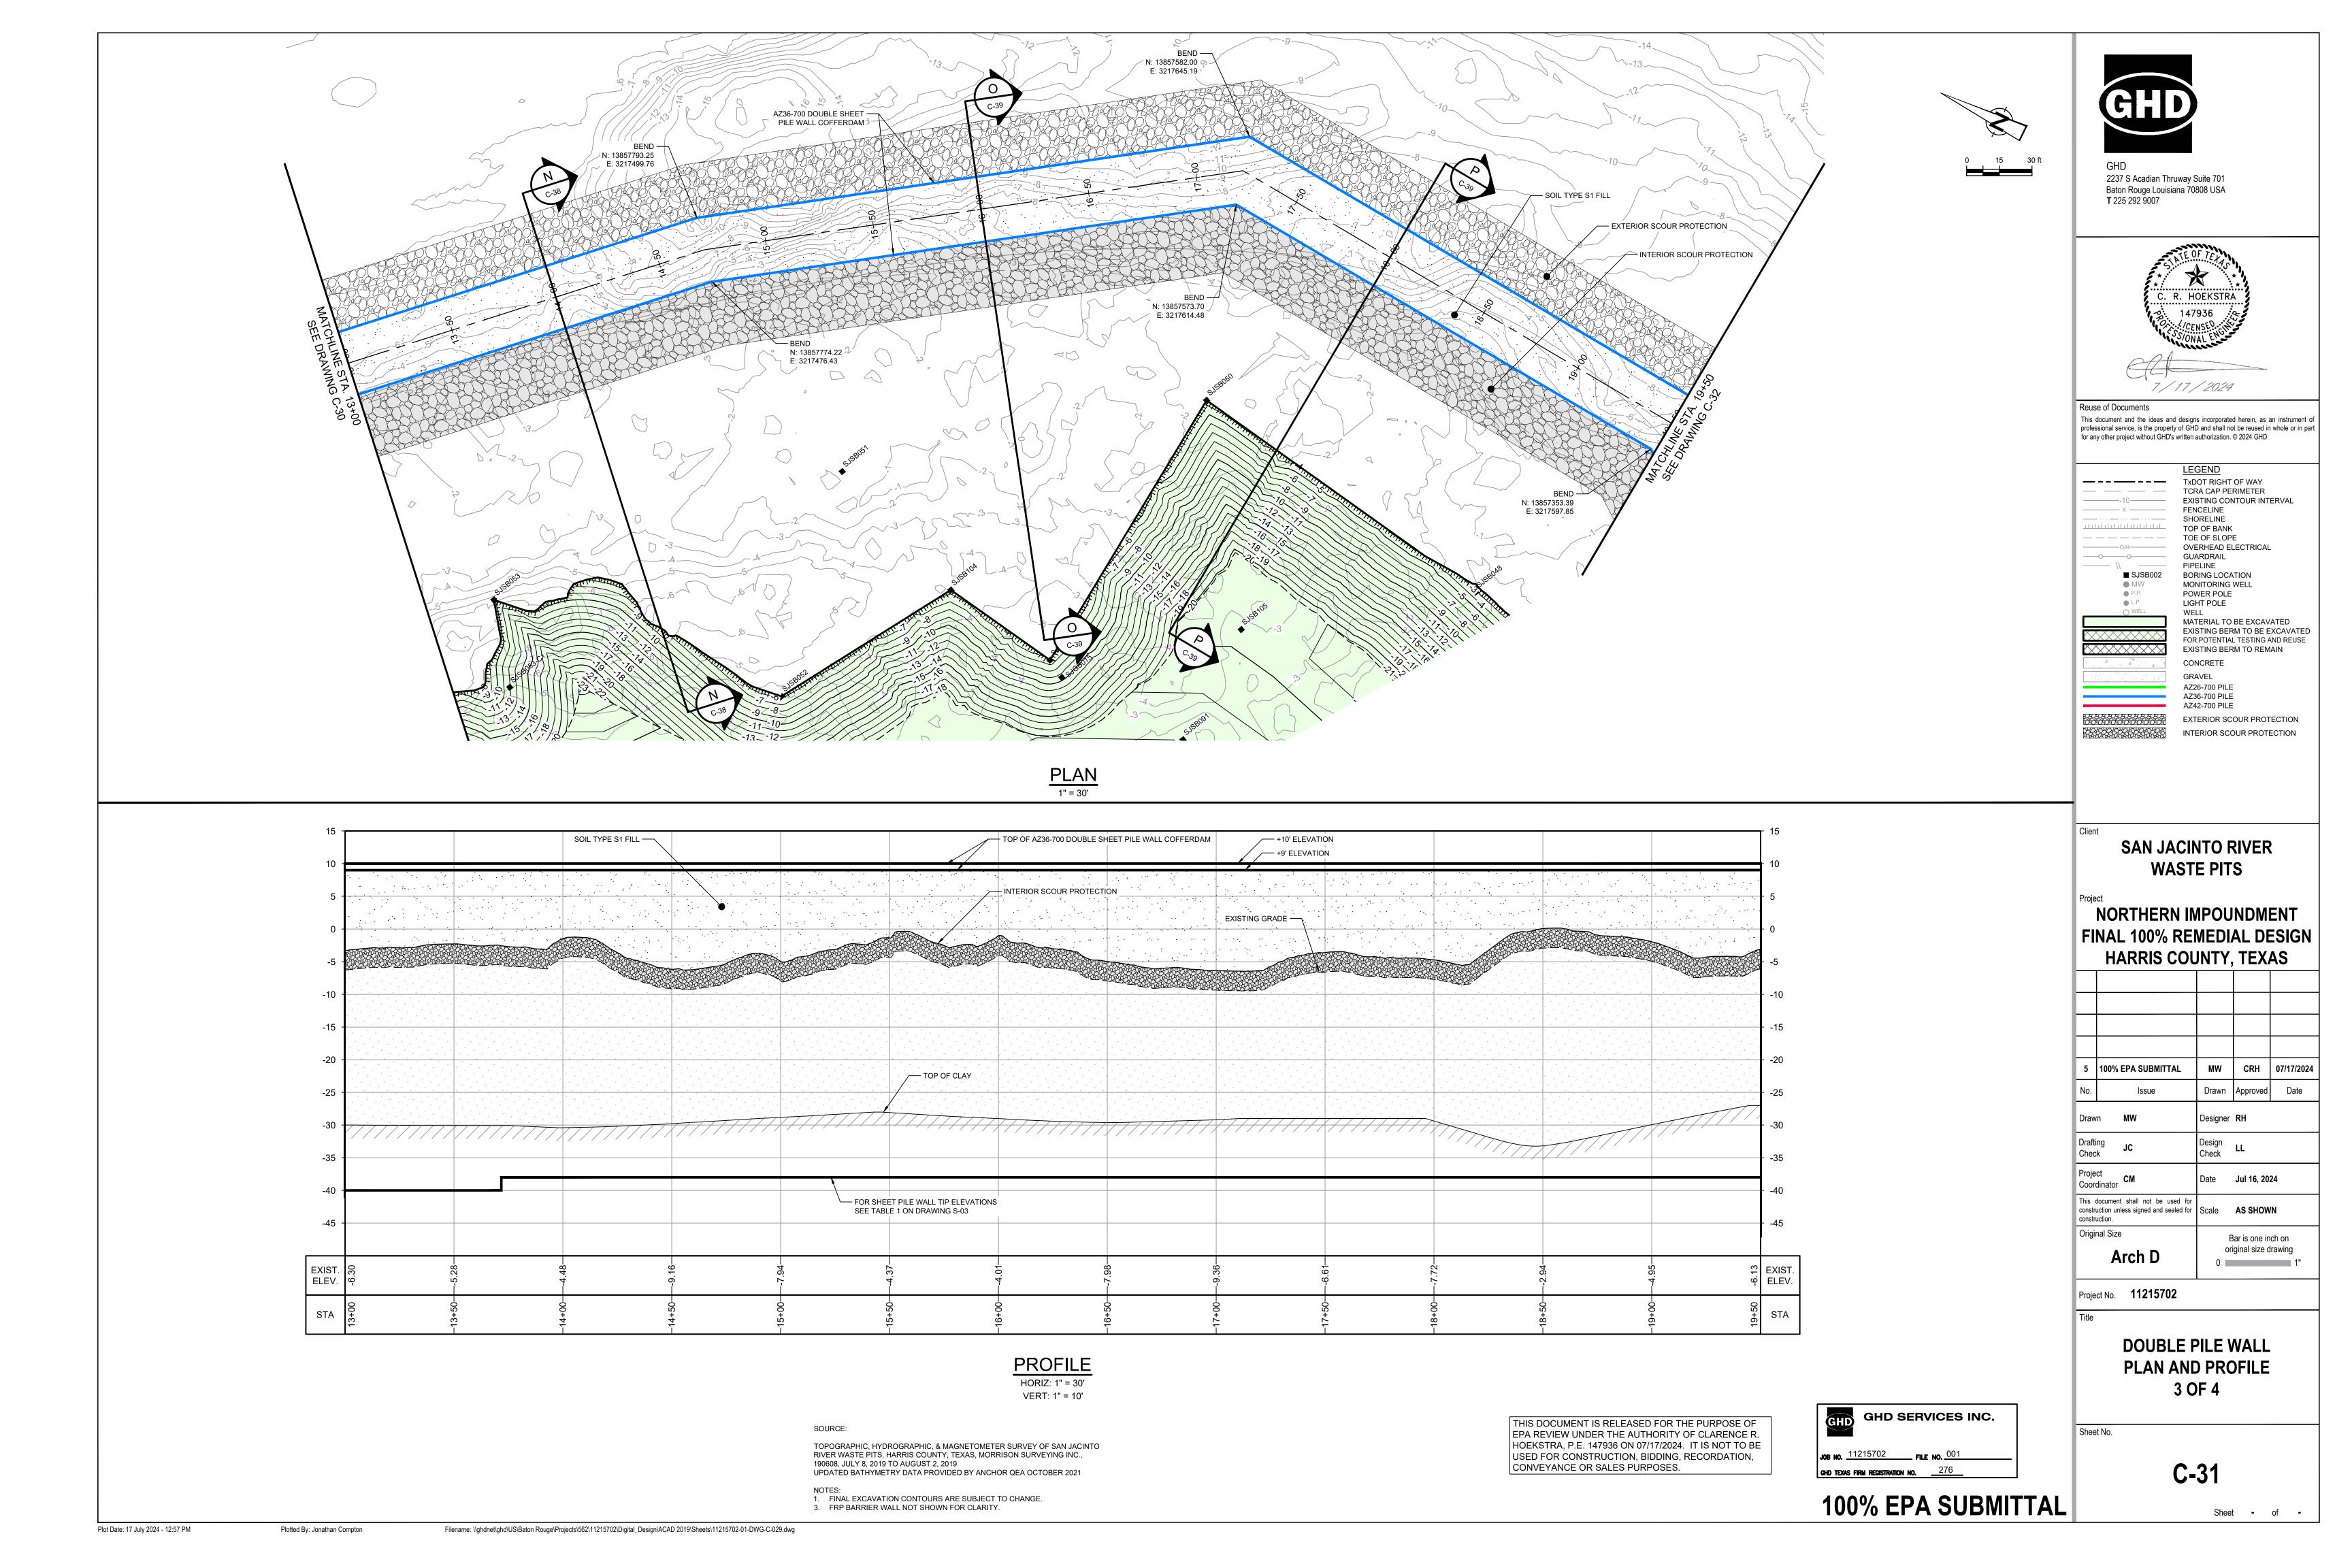

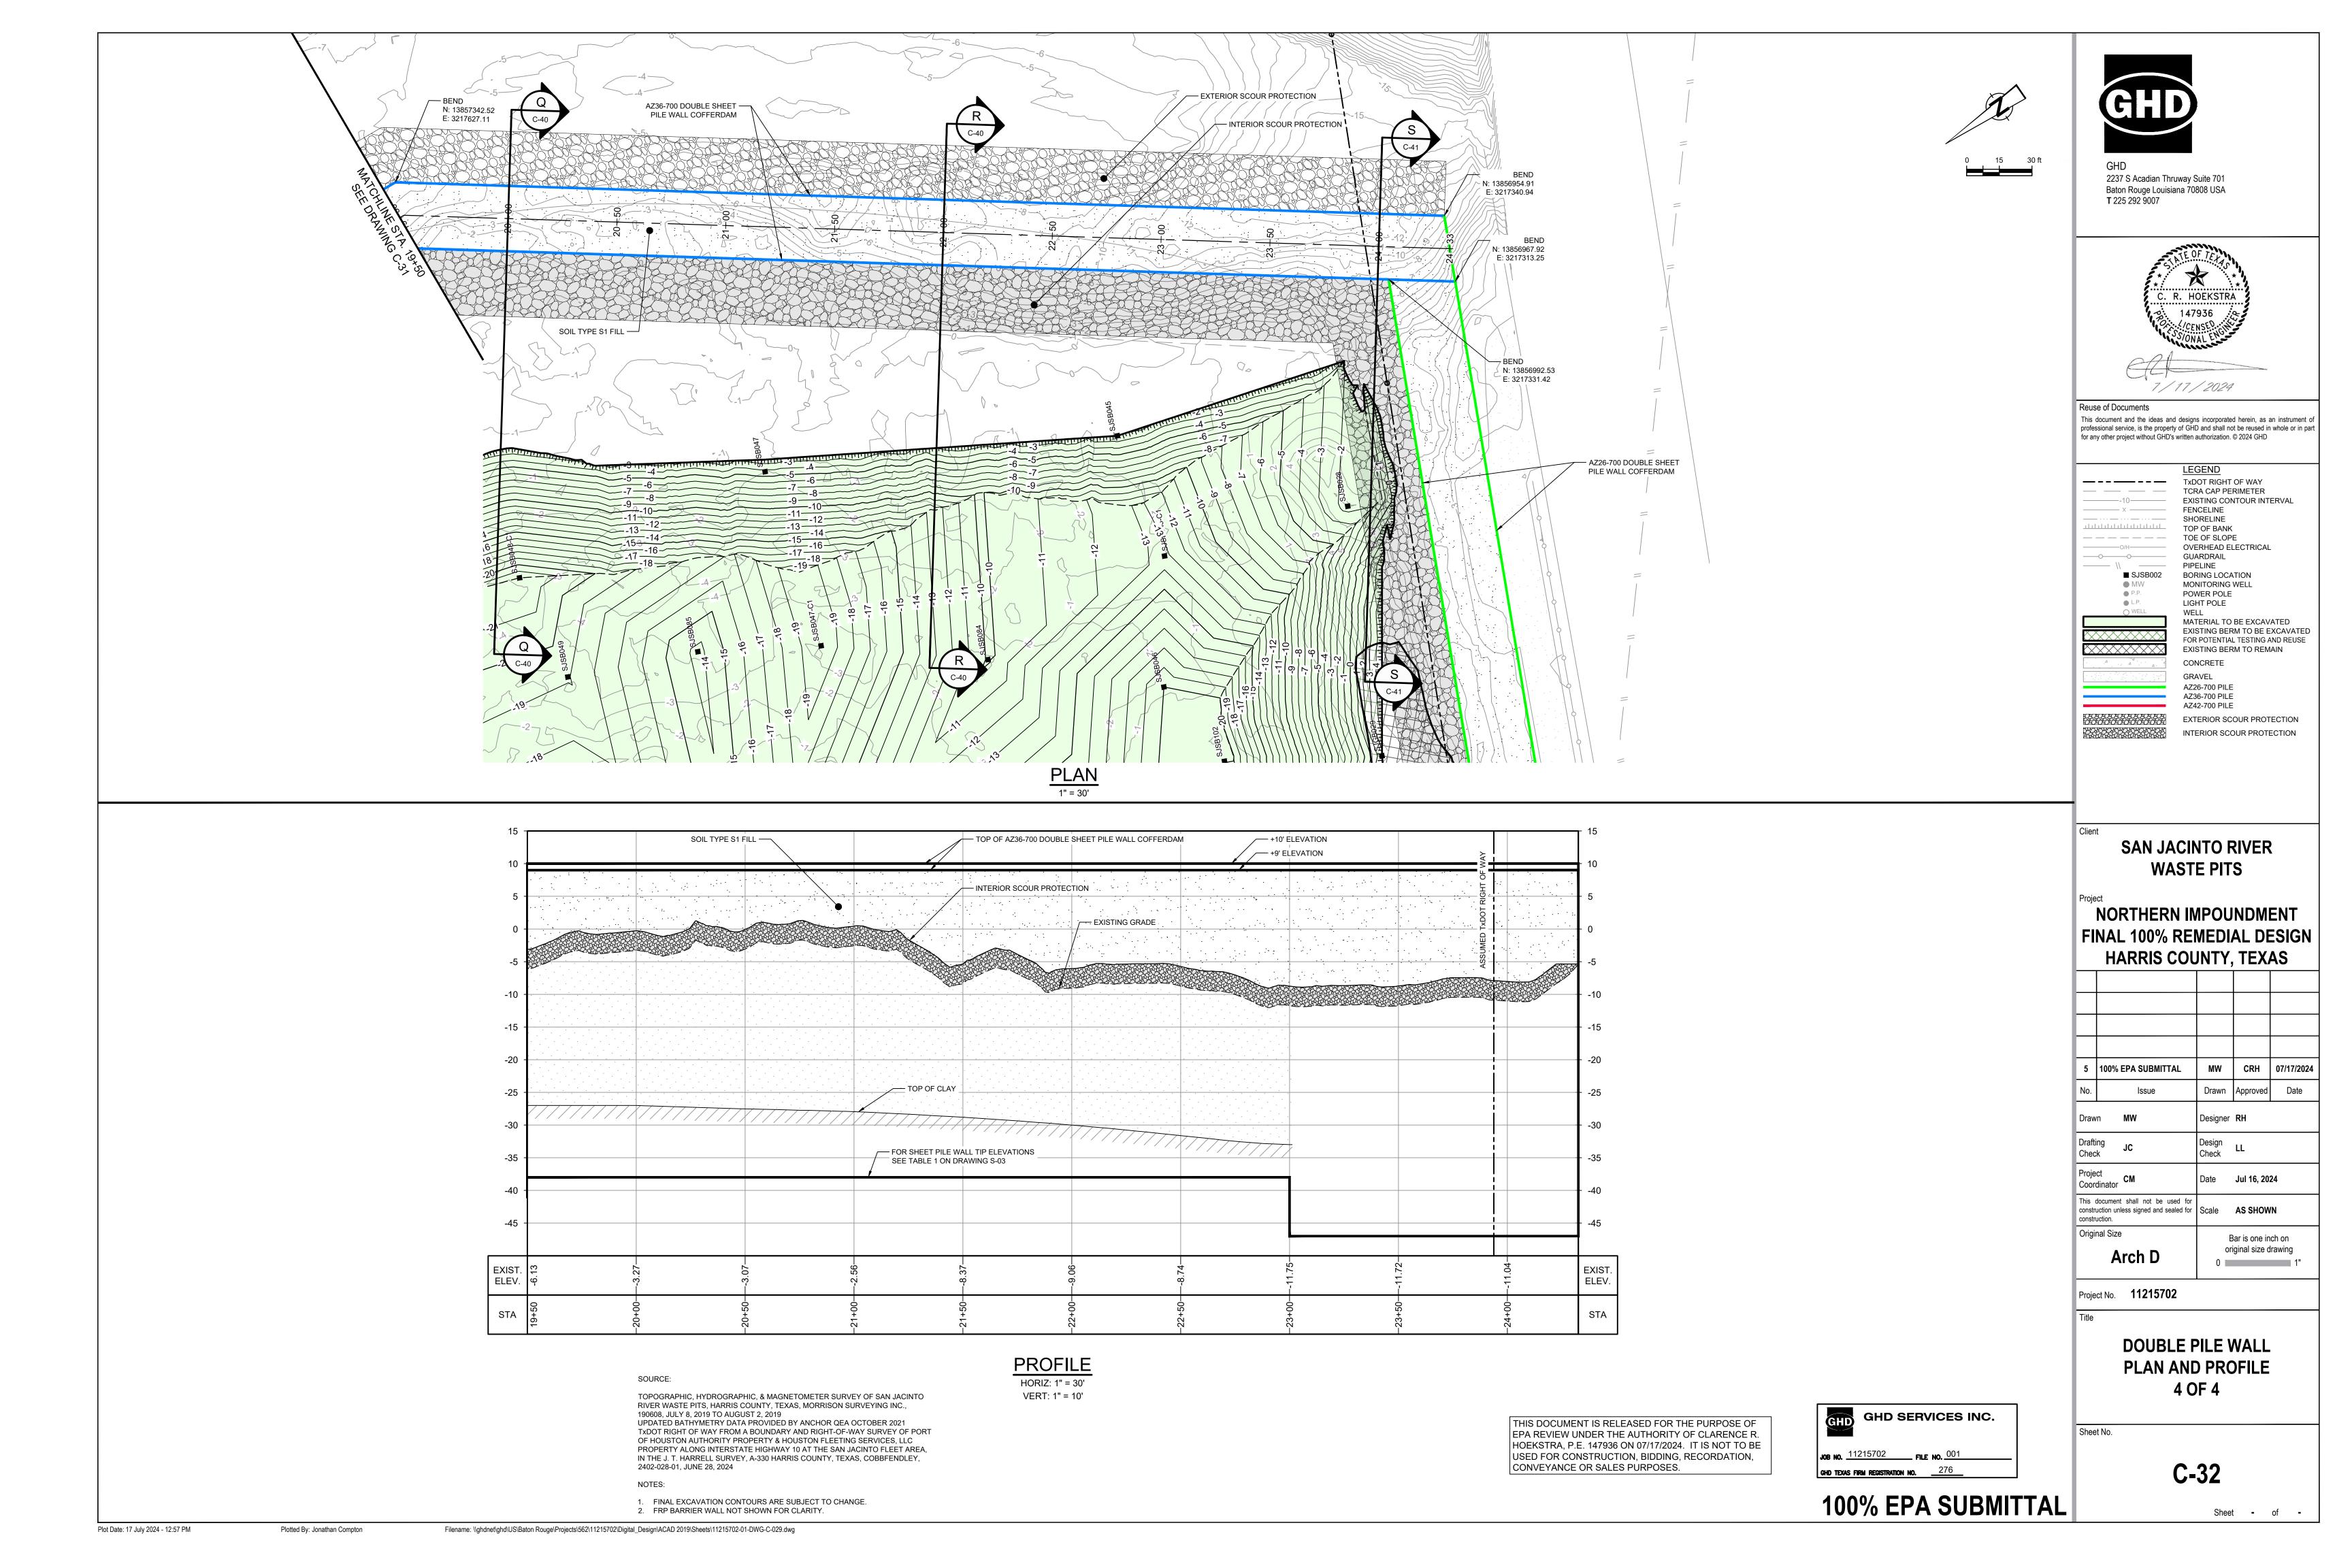

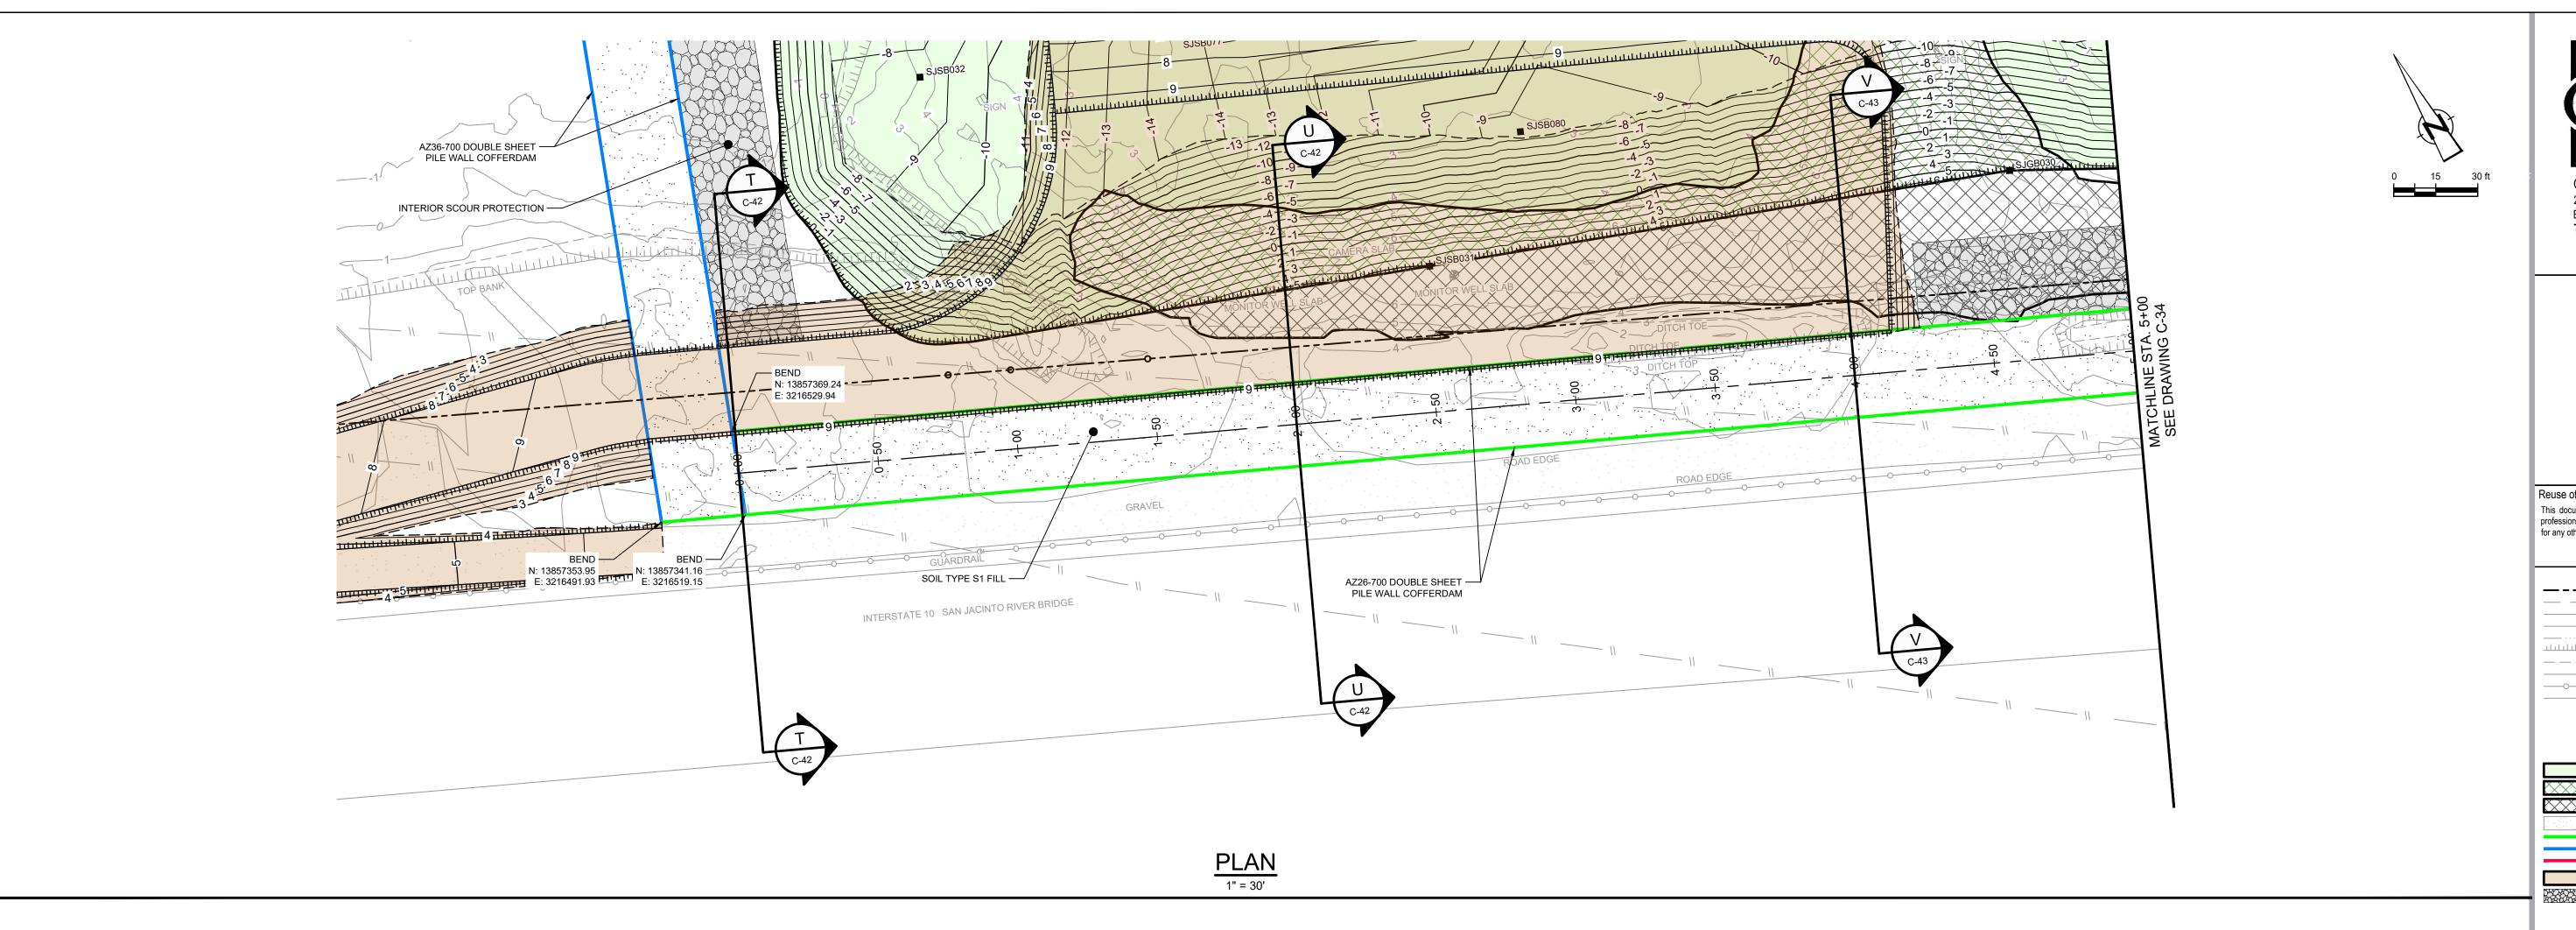

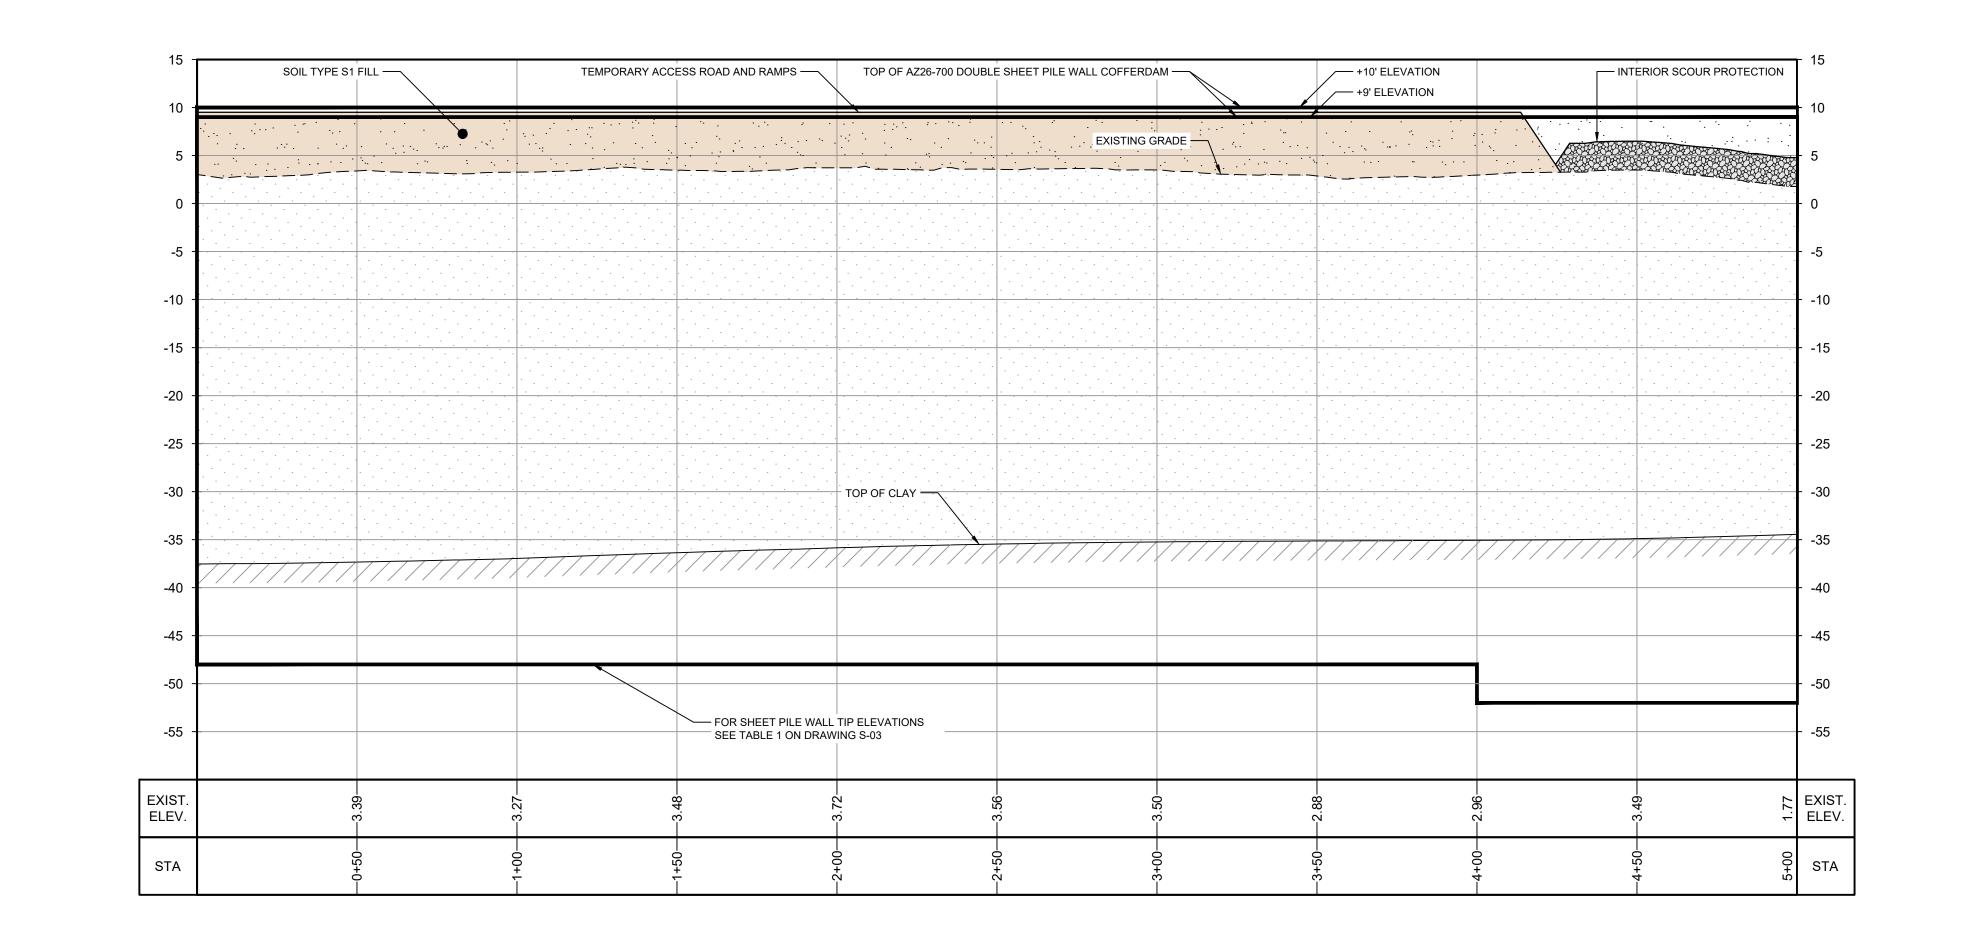

PROFILE

HORIZ: 1" = 30'

VERT: 1" = 10'

GHD SERVICES INC.

1. FINAL EXCAVATION CONTOURS ARE SUBJECT TO CHANGE.

THIS DOCUMENT IS RELEASED FOR THE PURPOSE OF

EPA REVIEW UNDER THE AUTHORITY OF CLARENCE R. HOEKSTRA, P.E. 147936 ON 07/17/2024. IT IS NOT TO BE

USED FOR CONSTRUCTION, BIDDING, RECORDATION,

CONVEYANCE OR SALES PURPOSES.

TOPOGRAPHIC, HYDROGRAPHIC, & MAGNETOMETER SURVEY OF SAN JACINTO RIVER WASTE PITS, HARRIS COUNTY, TEXAS, MORRISON SURVEYING INC.,

TXDOT RIGHT OF WAY FROM A BOUNDARY AND RIGHT-OF-WAY SURVEY OF PORT OF HOUSTON AUTHORITY PROPERTY & HOUSTON FLEETING SERVICES, LLC

PROPERTY ALONG INTERSTATE HIGHWAY 10 AT THE SAN JACINTO FLEET AREA, IN THE J. T. HARRELL SURVEY, A-330 HARRIS COUNTY, TEXAS, COBBFENDLEY,

UPDATED BATHYMETRY DATA PROVIDED BY ANCHOR QEA OCTOBER 2021

SOURCE:


190608, JULY 8, 2019 TO AUGUST 2, 2019

2402-028-01, JUNE 28, 2024

100% EPA SUBMITTAL



2237 S Acadian Thruway Suite 701 Baton Rouge Louisiana 70808 USA **T** 225 292 9007

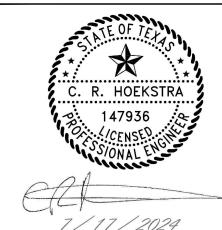

Reuse of Documents

This document and the ideas and designs incorporated herein, as an instrument of professional service, is the property of GHD and shall not be reused in whole or in part for any other project without GHD's written authorization. © 2024 GHD

> <u>LEGEND</u> **— – – — T**XDOT RIGHT OF WAY EXISTING CONTOUR INTERVAL FENCELINE __ _ _ _ TOE OF SLOPE MW

TOP OF BANK OVERHEAD ELECTRICAL **GUARDRAIL** PIPELINE ■ SJSB002 BORING LOCATION MONITORING WELL POWER POLE LIGHT POLE

> AZ36-700 PILE AZ42-700 PILE

MATERIAL TO BE EXCAVATED EXISTING BERM TO BE EXCAVATED FOR POTENTIAL TESTING AND REUSE EXISTING BERM TO REMAIN GRAVEL AZ26-700 PILE

PLANNED IMPROVEMENTS FOR NORTHERN IMPOUNDMENT ACCESS INTERIOR SCOUR PROTECTION

SAN JACINTO RIVER WASTE PITS

NORTHERN IMPOUNDMENT FINAL 100% REMEDIAL DESIGN HARRIS COUNTY, TEXAS

5	100% EPA SUBMITTAL	MW	CRH	07/17/2
No.	Issue	Drawn	Approved	Dat
Draw	n MW	Designer	RH	
Drafting JC Check		Design Check	LL	
Project CM Coordinator		Date	Jul 16, 2024	
This document shall not be used for construction unless signed and sealed for construction.		Scale	AS SHOW	/N

Original Size Arch D

Project No. **11215702**

PILE WALL PLAN AND PROFILE

1 OF 2

Bar is one inch on

original size drawing

Sheet - of -


Sheet No.


C-33

Plot Date: 17 July 2024 - 12:58 PM


Plotted By: Jonathan Compton

Filename: \\ghdnet\ghd\US\Baton Rouge\Projects\562\11215702\Digital_Design\ACAD 2019\Sheets\11215702-01-DWG-C-033.dwg

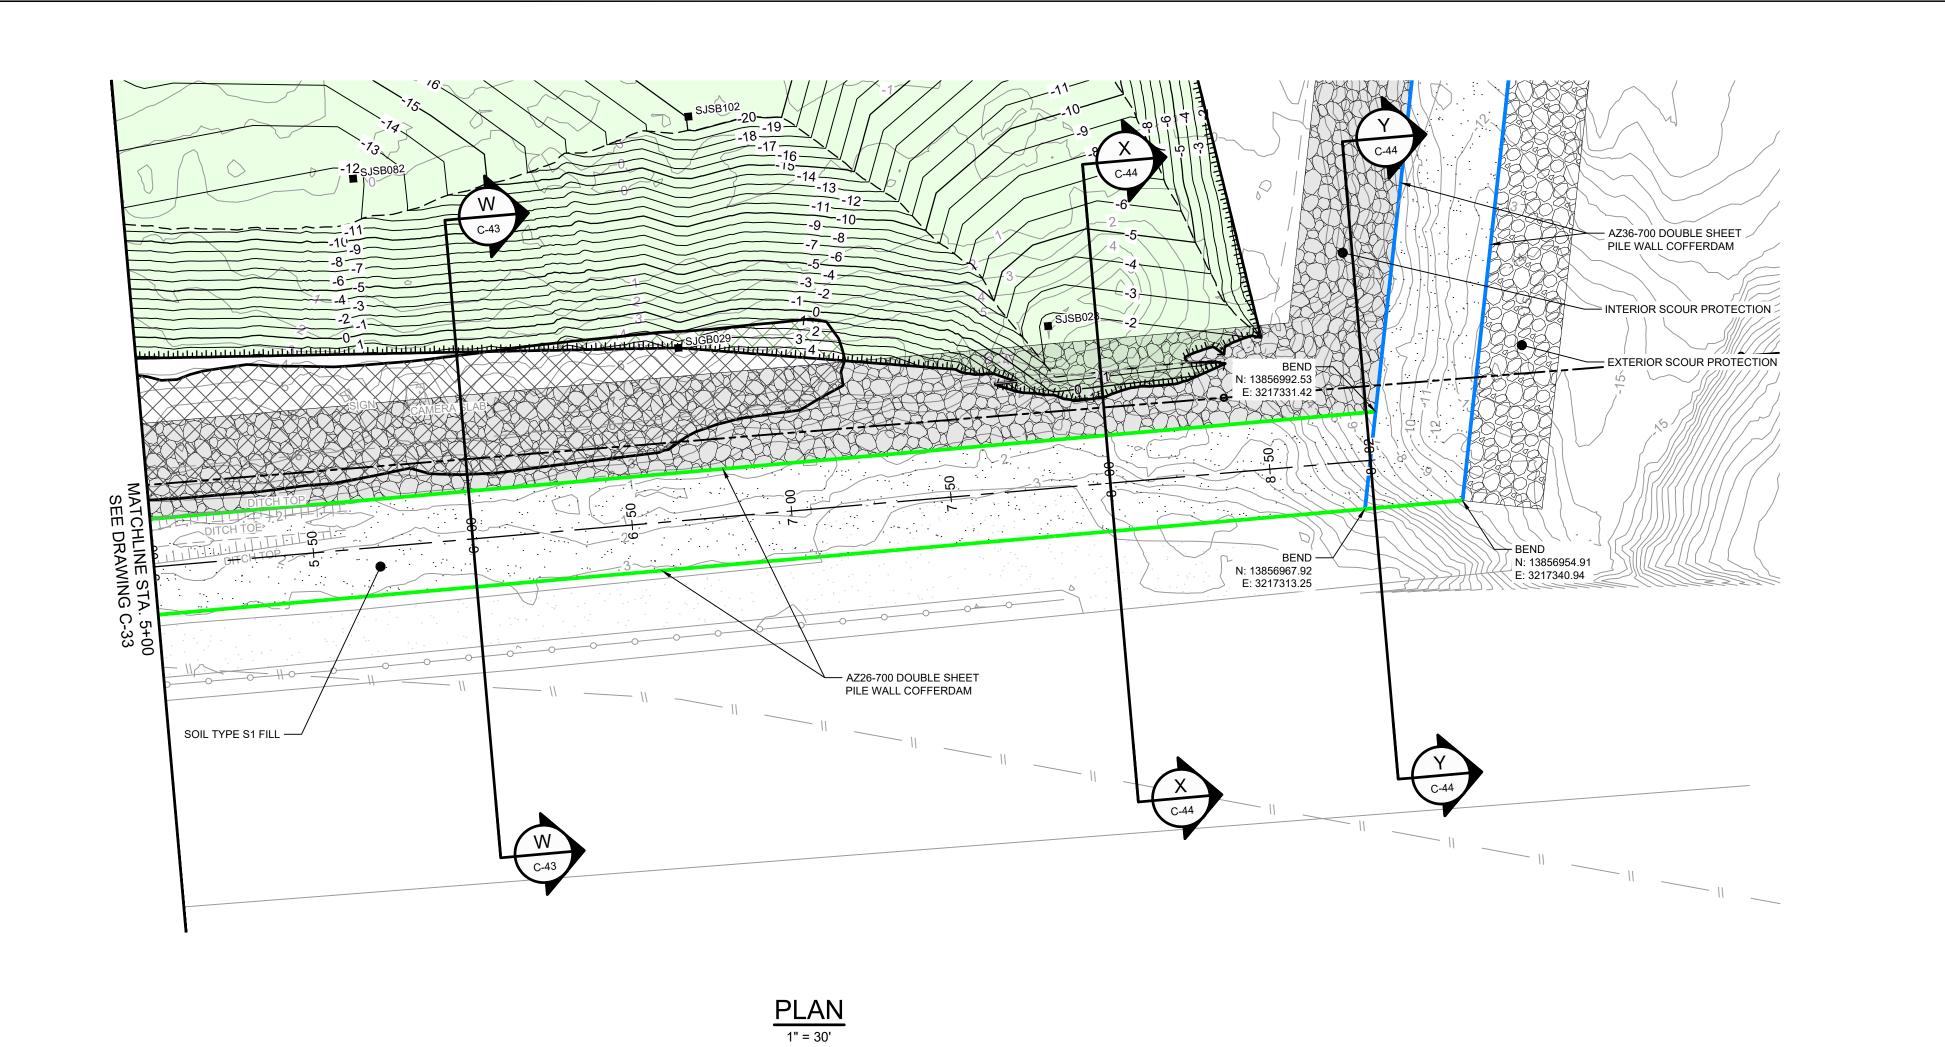

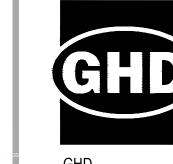

2237 S Acadian Thruway Suite 701 Baton Rouge Louisiana 70808 USA **T** 225 292 9007

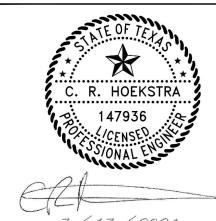

Reuse of Documents

This document and the ideas and designs incorporated herein, as an instrument of professional service, is the property of GHD and shall not be reused in whole or in part for any other project without GHD's written authorization. © 2024 GHD

<u>LEGEND</u> **— – – — T**XDOT RIGHT OF WAY EXISTING CONTOUR INTERVAL FENCELINE _____ SHORELINE TOP OF BANK __ _ _ _ TOE OF SLOPE ■ SJSB002 BORING LOCATION MW

OVERHEAD ELECTRICAL **GUARDRAIL** PIPELINE MONITORING WELL POWER POLE LIGHT POLE

MATERIAL TO BE EXCAVATED EXISTING BERM TO BE EXCAVATED FOR POTENTIAL TESTING AND REUSE EXISTING BERM TO REMAIN


GRAVEL

AZ26-700 PILE AZ36-700 PILE AZ42-700 PILE PLANNED IMPROVEMENTS FOR NORTHERN IMPOUNDMENT ACCESS EXTERIOR SCOUR PROTECTION

INTERIOR SCOUR PROTECTION

SAN JACINTO RIVER WASTE PITS

NORTHERN IMPOUNDMENT FINAL 100% REMEDIAL DESIGN HARRIS COUNTY, TEXAS

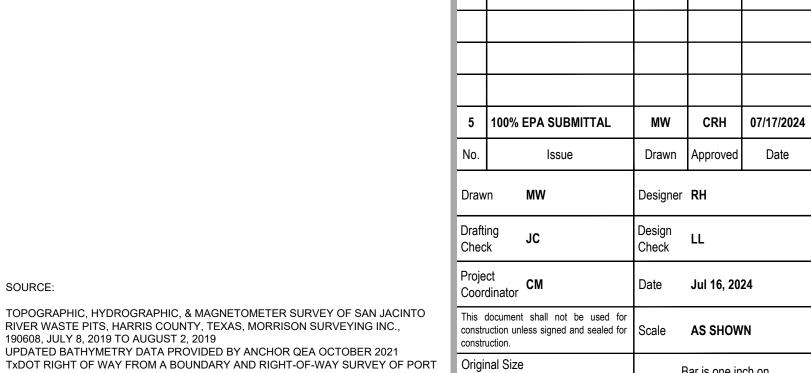

Project No. **11215702**

Arch D

PILE WALL PLAN AND PROFILE 2 OF 2

Bar is one inch on

0 1"

Sheet - of -

original size drawing

Sheet No.

C-34

100% EPA SUBMITTAL

TOPOGRAPHIC, HYDROGRAPHIC, & MAGNETOMETER SURVEY OF SAN JACINTO

RIVER WASTE PITS, HARRIS COUNTY, TEXAS, MORRISON SURVEYING INC., 190608, JULY 8, 2019 TO AUGUST 2, 2019

UPDATED BATHYMETRY DATA PROVIDED BY ANCHOR QEA OCTOBER 2021

1. FINAL EXCAVATION CONTOURS ARE SUBJECT TO CHANGE.

THIS DOCUMENT IS RELEASED FOR THE PURPOSE OF

EPA REVIEW UNDER THE AUTHORITY OF CLARENCE R. HOEKSTRA, P.E. 147936 ON 07/17/2024. IT IS NOT TO BE

USED FOR CONSTRUCTION, BIDDING, RECORDATION,

GHD SERVICES INC.

2. FRP BARRIER WALL NOT SHOWN FOR CLARITY.


CONVEYANCE OR SALES PURPOSES.

OF HOUSTON AUTHORITY PROPERTY & HOUSTON FLEETING SERVICES, LLC PROPERTY ALONG INTERSTATE HIGHWAY 10 AT THE SAN JACINTO FLEET AREA, IN THE J. T. HARRELL SURVEY, A-330 HARRIS COUNTY, TEXAS, COBBFENDLEY,

SOURCE:


NOTES:

2402-028-01, JUNE 28, 2024

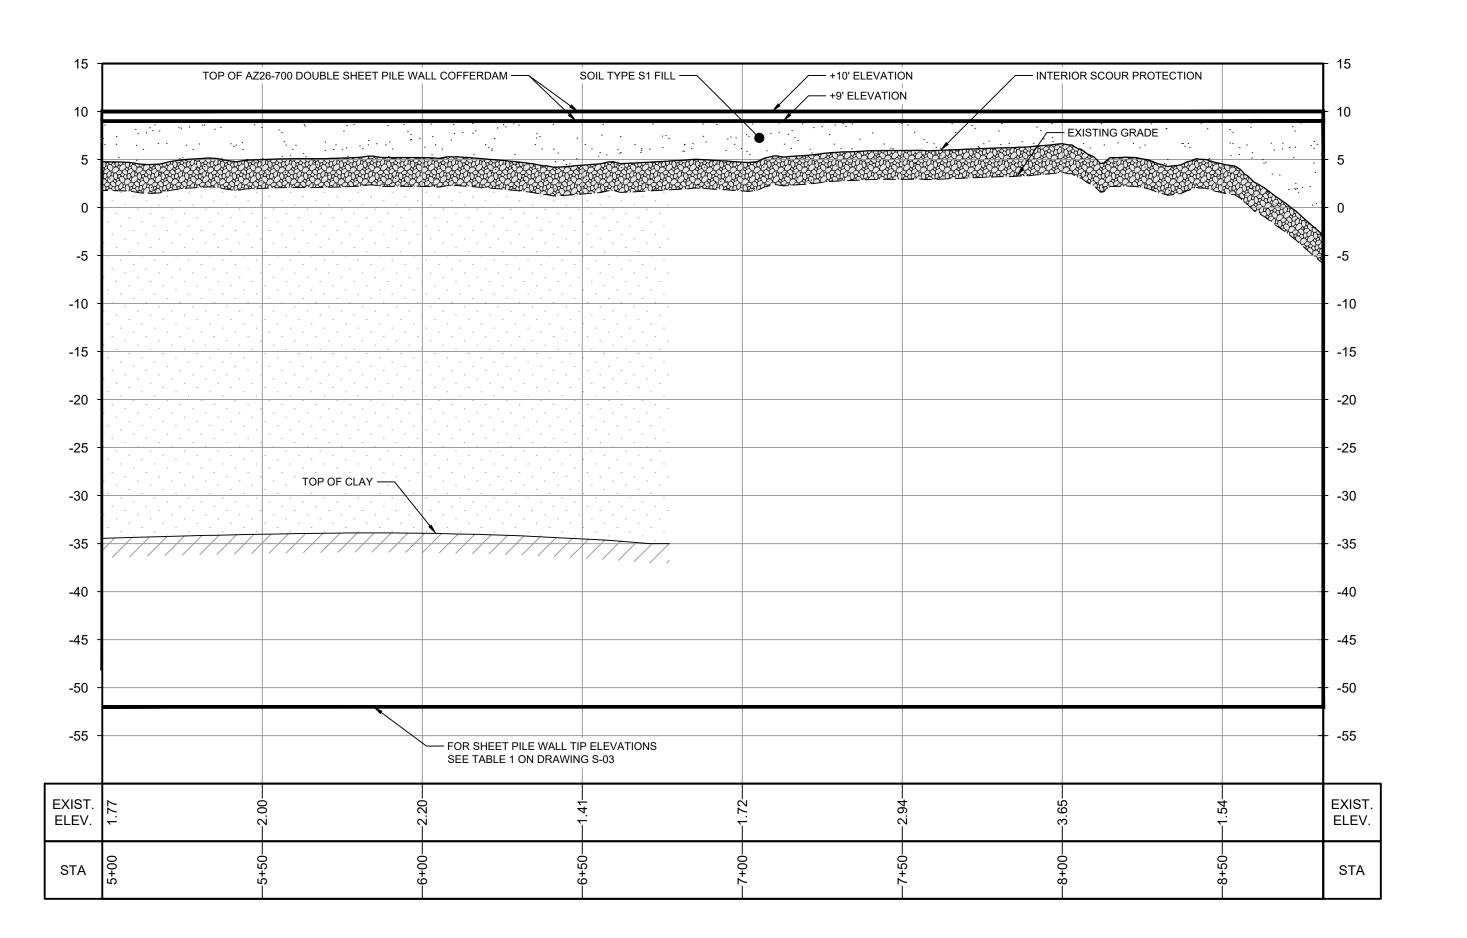


PROFILE HORIZ: 1" = 30' VERT: 1" = 10'

Plot Date: 17 July 2024 - 12:58 PM

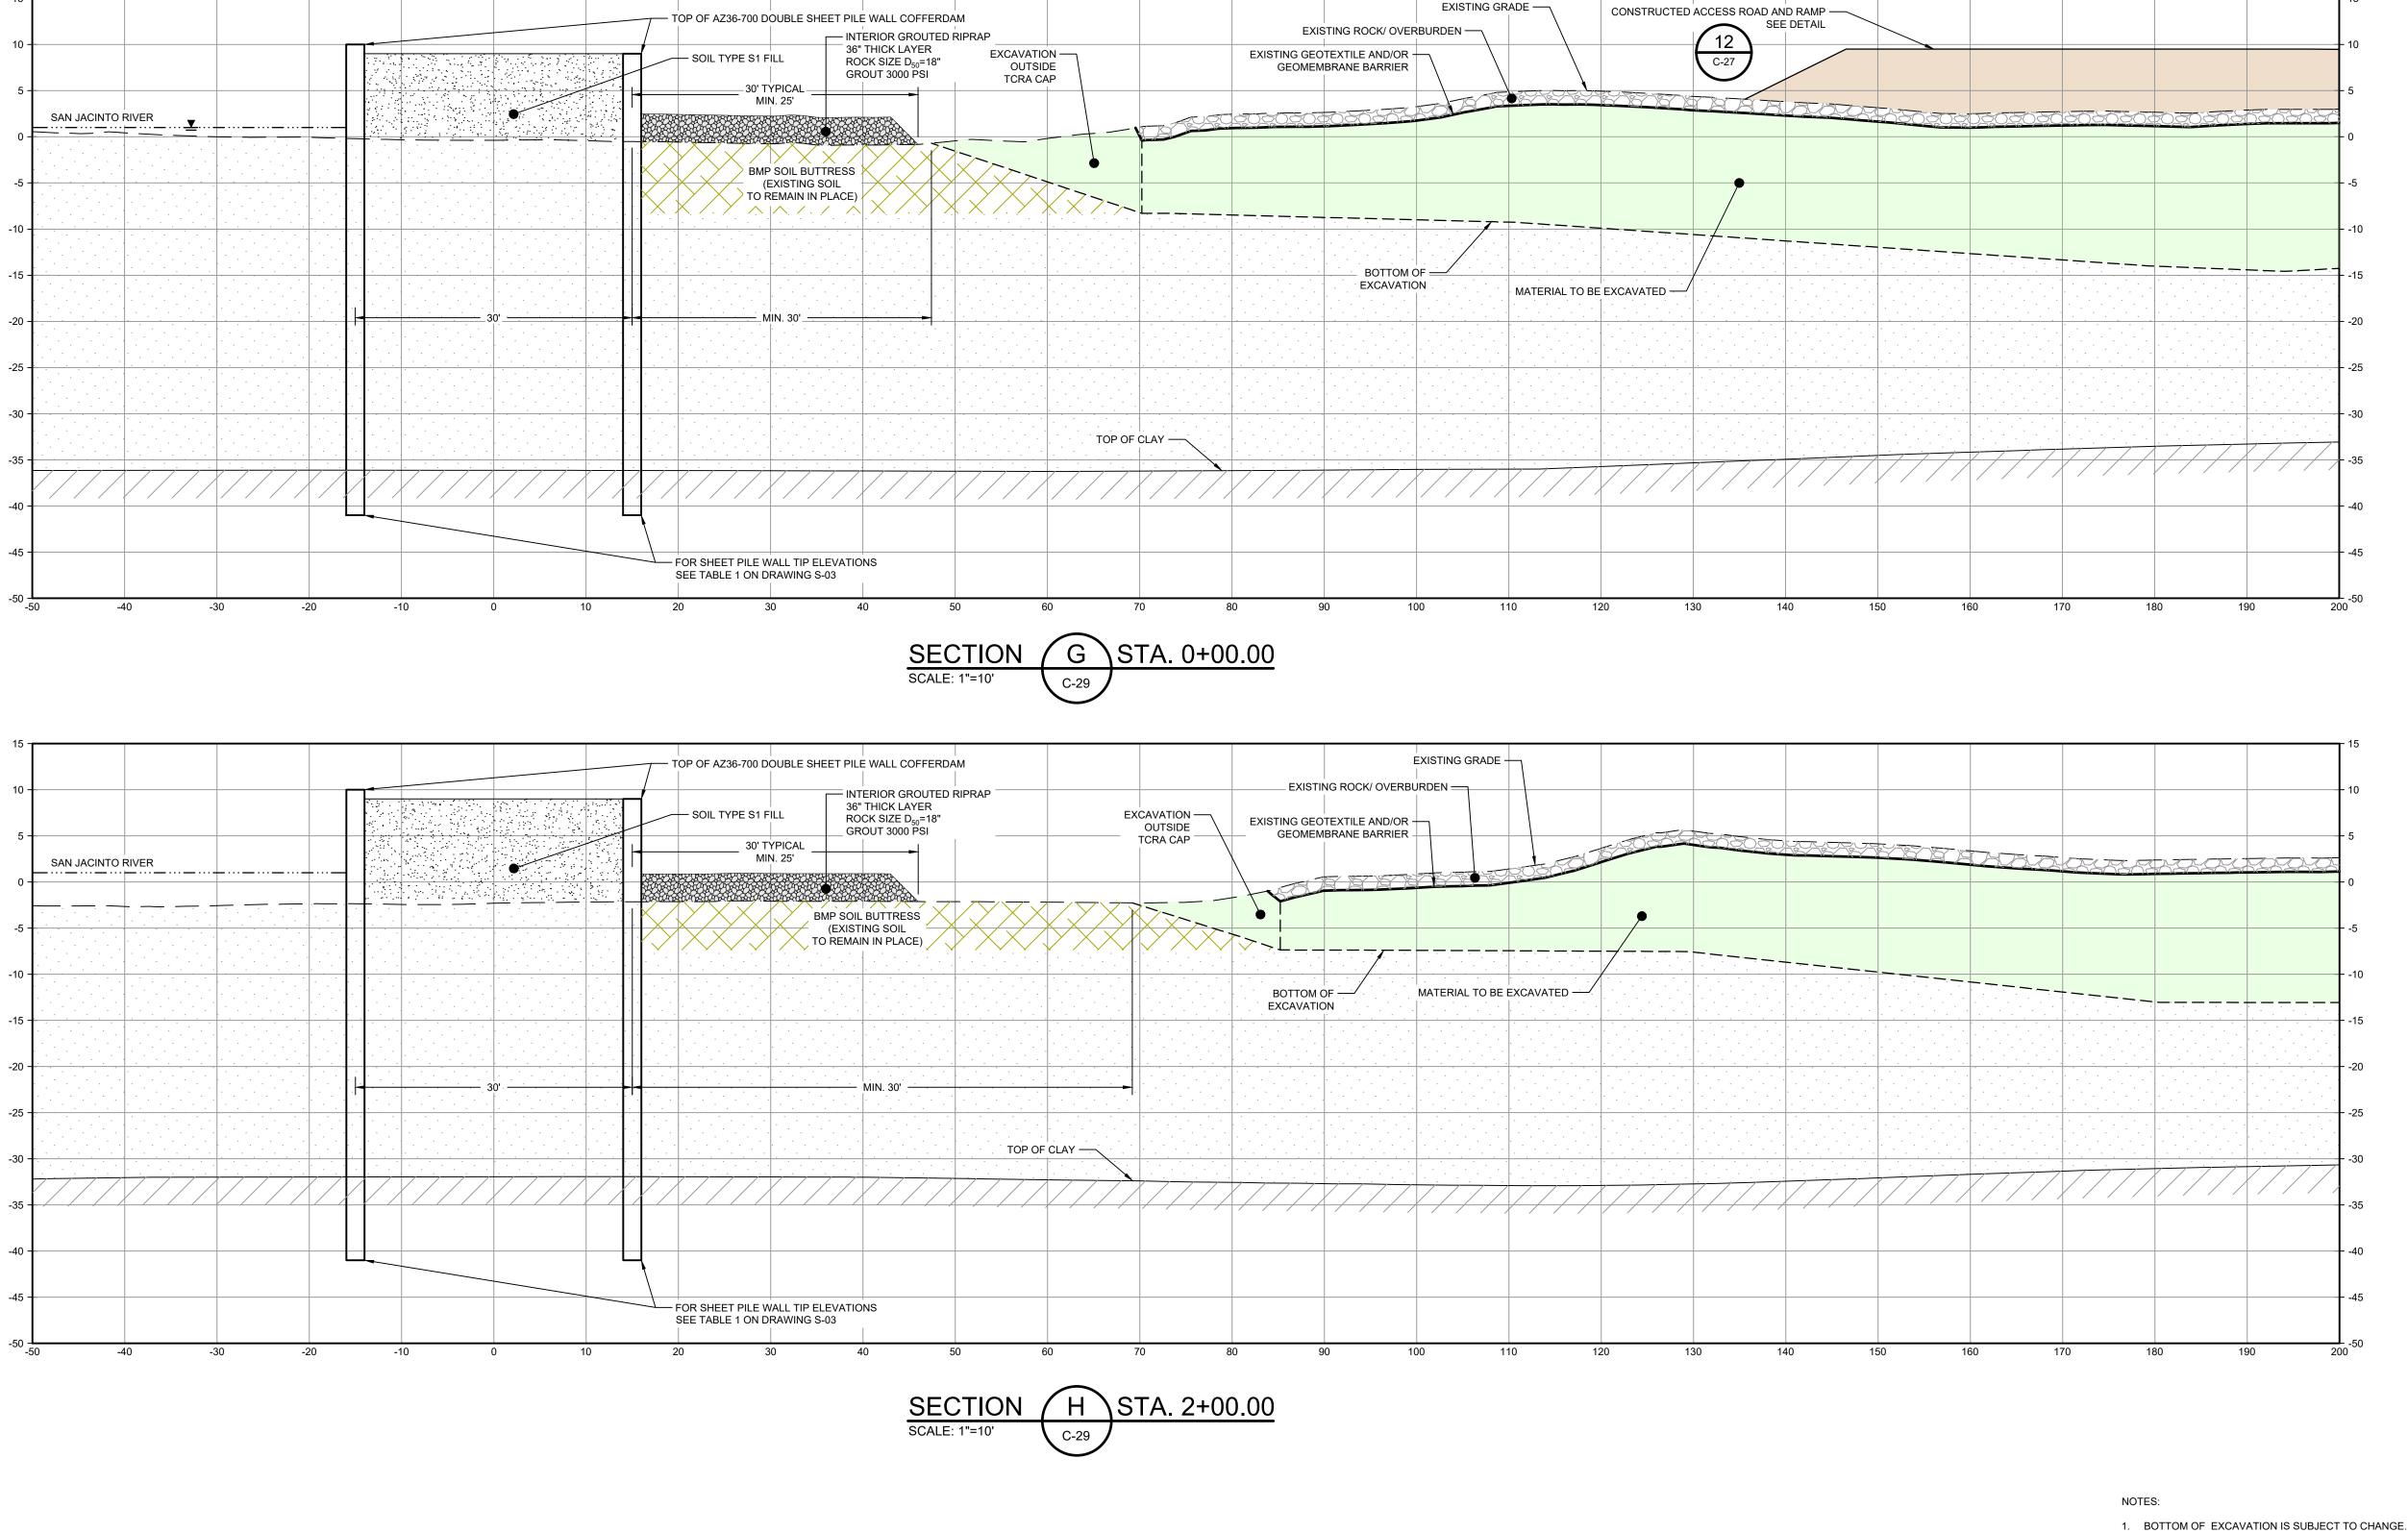

2237 S Acadian Thruway Suite 701 Baton Rouge Louisiana 70808 USA **T** 225 292 9007

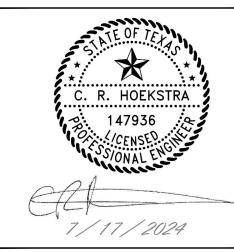


Reuse of Documents This document and the ideas and designs incorporated herein, as an instrument of professional service, is the property of GHD and shall not be reused in whole or in part for any other project without GHD's written authorization. © 2024 GHD

<u>LEGEND</u>

MATERIAL TO BE EXCAVATED BMP SOIL BUTTRESS (EXISTING SOIL TO REMAIN IN PLACE) PLANNED IMPROVEMENTS FOR NORTHERN IMPOUNDMENT ACCESS INTERIOR SCOUR PROTECTION

SAN JACINTO RIVER WASTE PITS

NORTHERN IMPOUNDMENT FINAL 100% REMEDIAL DESIGN HARRIS COUNTY, TEXAS

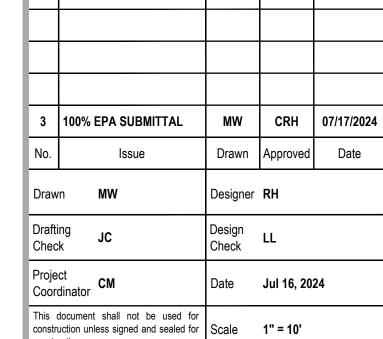

Original Size

Bar is one inch on original size drawing Arch D

Project No. **11215702**

DOUBLE PILE WALL SECTIONS 1 OF 7


Sheet No.

C-35

Sheet - of -

THIS DOCUMENT IS RELEASED FOR THE PURPOSE OF EPA REVIEW UNDER THE AUTHORITY OF CLARENCE R. HOEKSTRA, P.E. 147936 ON 07/17/2024. IT IS NOT TO BE USED FOR CONSTRUCTION, BIDDING, RECORDATION, CONVEYANCE OR SALES PURPOSES.



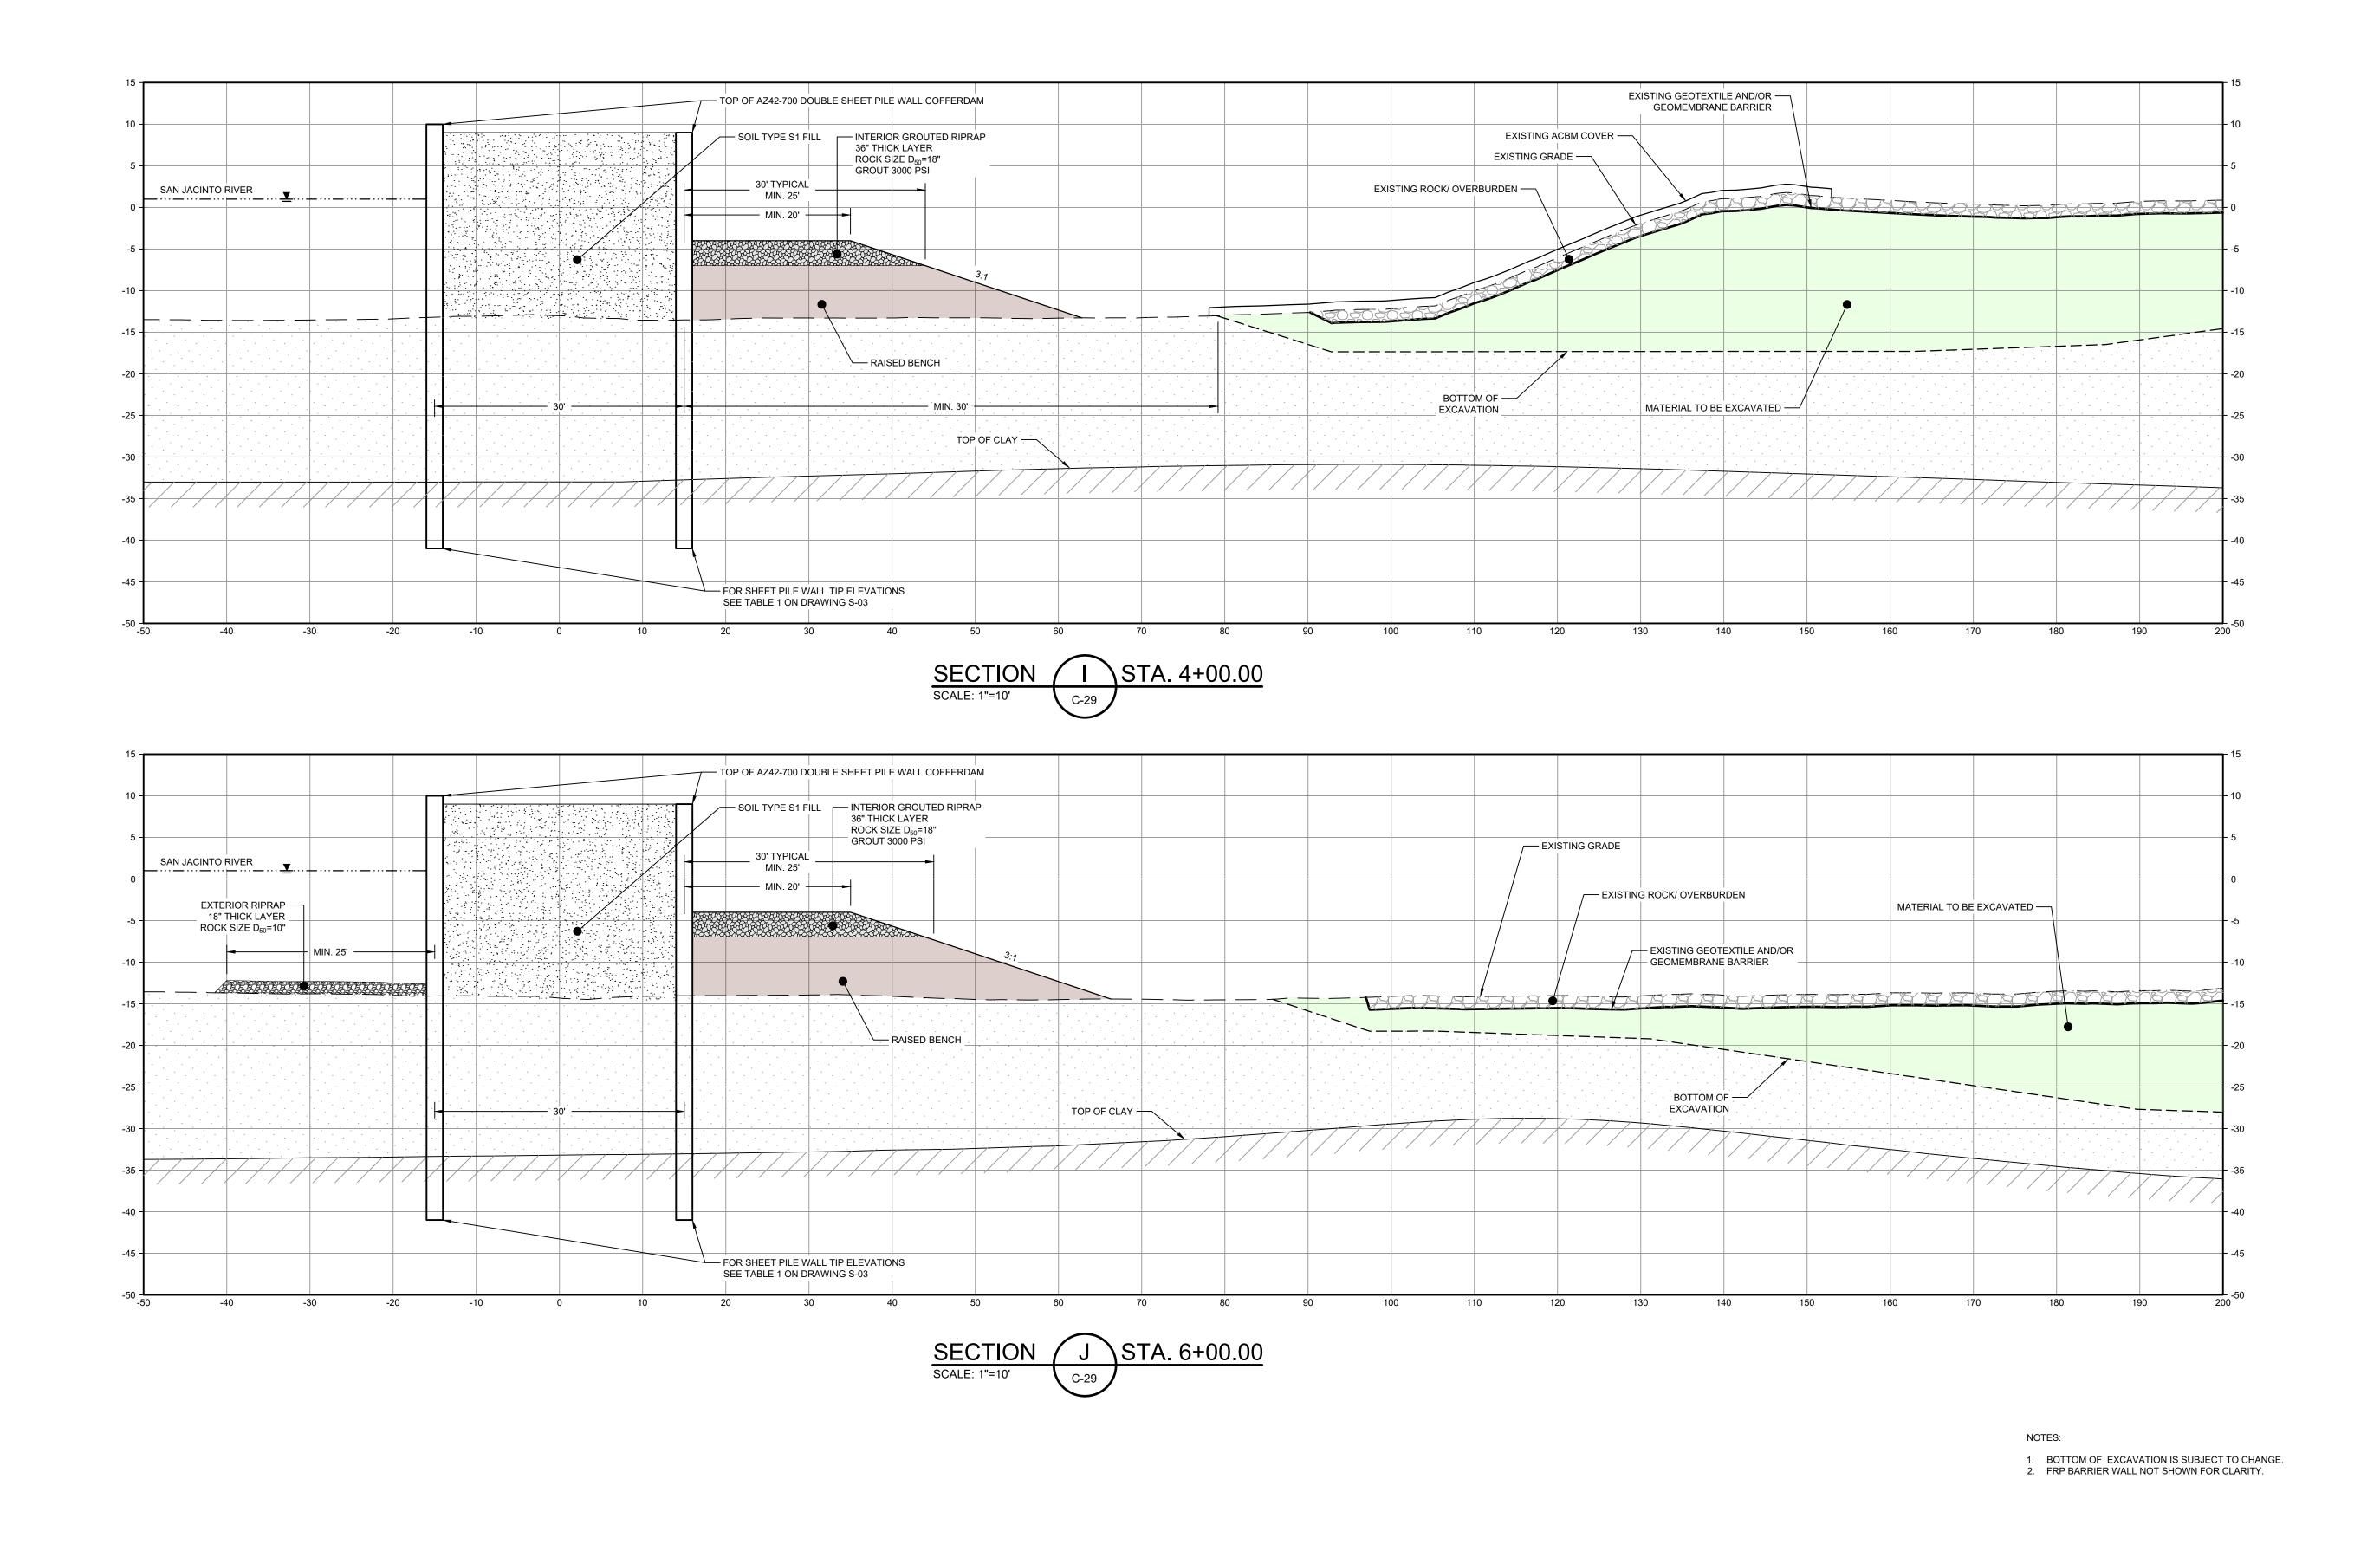

2237 S Acadian Thruway Suite 701 Baton Rouge Louisiana 70808 USA **T** 225 292 9007 C. R. HOEKSTRA

This document and the ideas and designs incorporated herein, as an instrument of

professional service, is the property of GHD and shall not be reused in whole or in part for any other project without GHD's written authorization. © 2024 GHD

Reuse of Documents

<u>LEGEND</u> MATERIAL TO BE EXCAVATED BMP SOIL BUTTRESS (EXISTING SOIL TO REMAIN IN PLACE) PLANNED IMPROVEMENTS FOR NORTHERN IMPOUNDMENT ACCESS EXTERIOR SCOUR PROTECTION INTERIOR SCOUR PROTECTION

SAN JACINTO RIVER WASTE PITS

NORTHERN IMPOUNDMENT FINAL 100% REMEDIAL DESIGN HARRIS COUNTY, TEXAS

MW CRH 07/17/2024 4 100% EPA SUBMITTAL Issue Drawn Designer RH

Drafting Check Coordinator CM Project Date **Jul 16, 2024** This document shall not be used for construction unless signed and sealed for Scale 1" = 10'

Original Size Arch D

Bar is one inch on original size drawing

Project No. **11215702**

DOUBLE PILE WALL SECTIONS 2 OF 7

Sheet No.

C-36

Sheet - of -


100% EPA SUBMITTAL

THIS DOCUMENT IS RELEASED FOR THE PURPOSE OF

EPA REVIEW UNDER THE AUTHORITY OF CLARENCE R. HOEKSTRA, P.E. 147936 ON 07/17/2024. IT IS NOT TO BE


GHD TEXAS FIRM REGISTRATION NO. 276

GHD SERVICES INC.

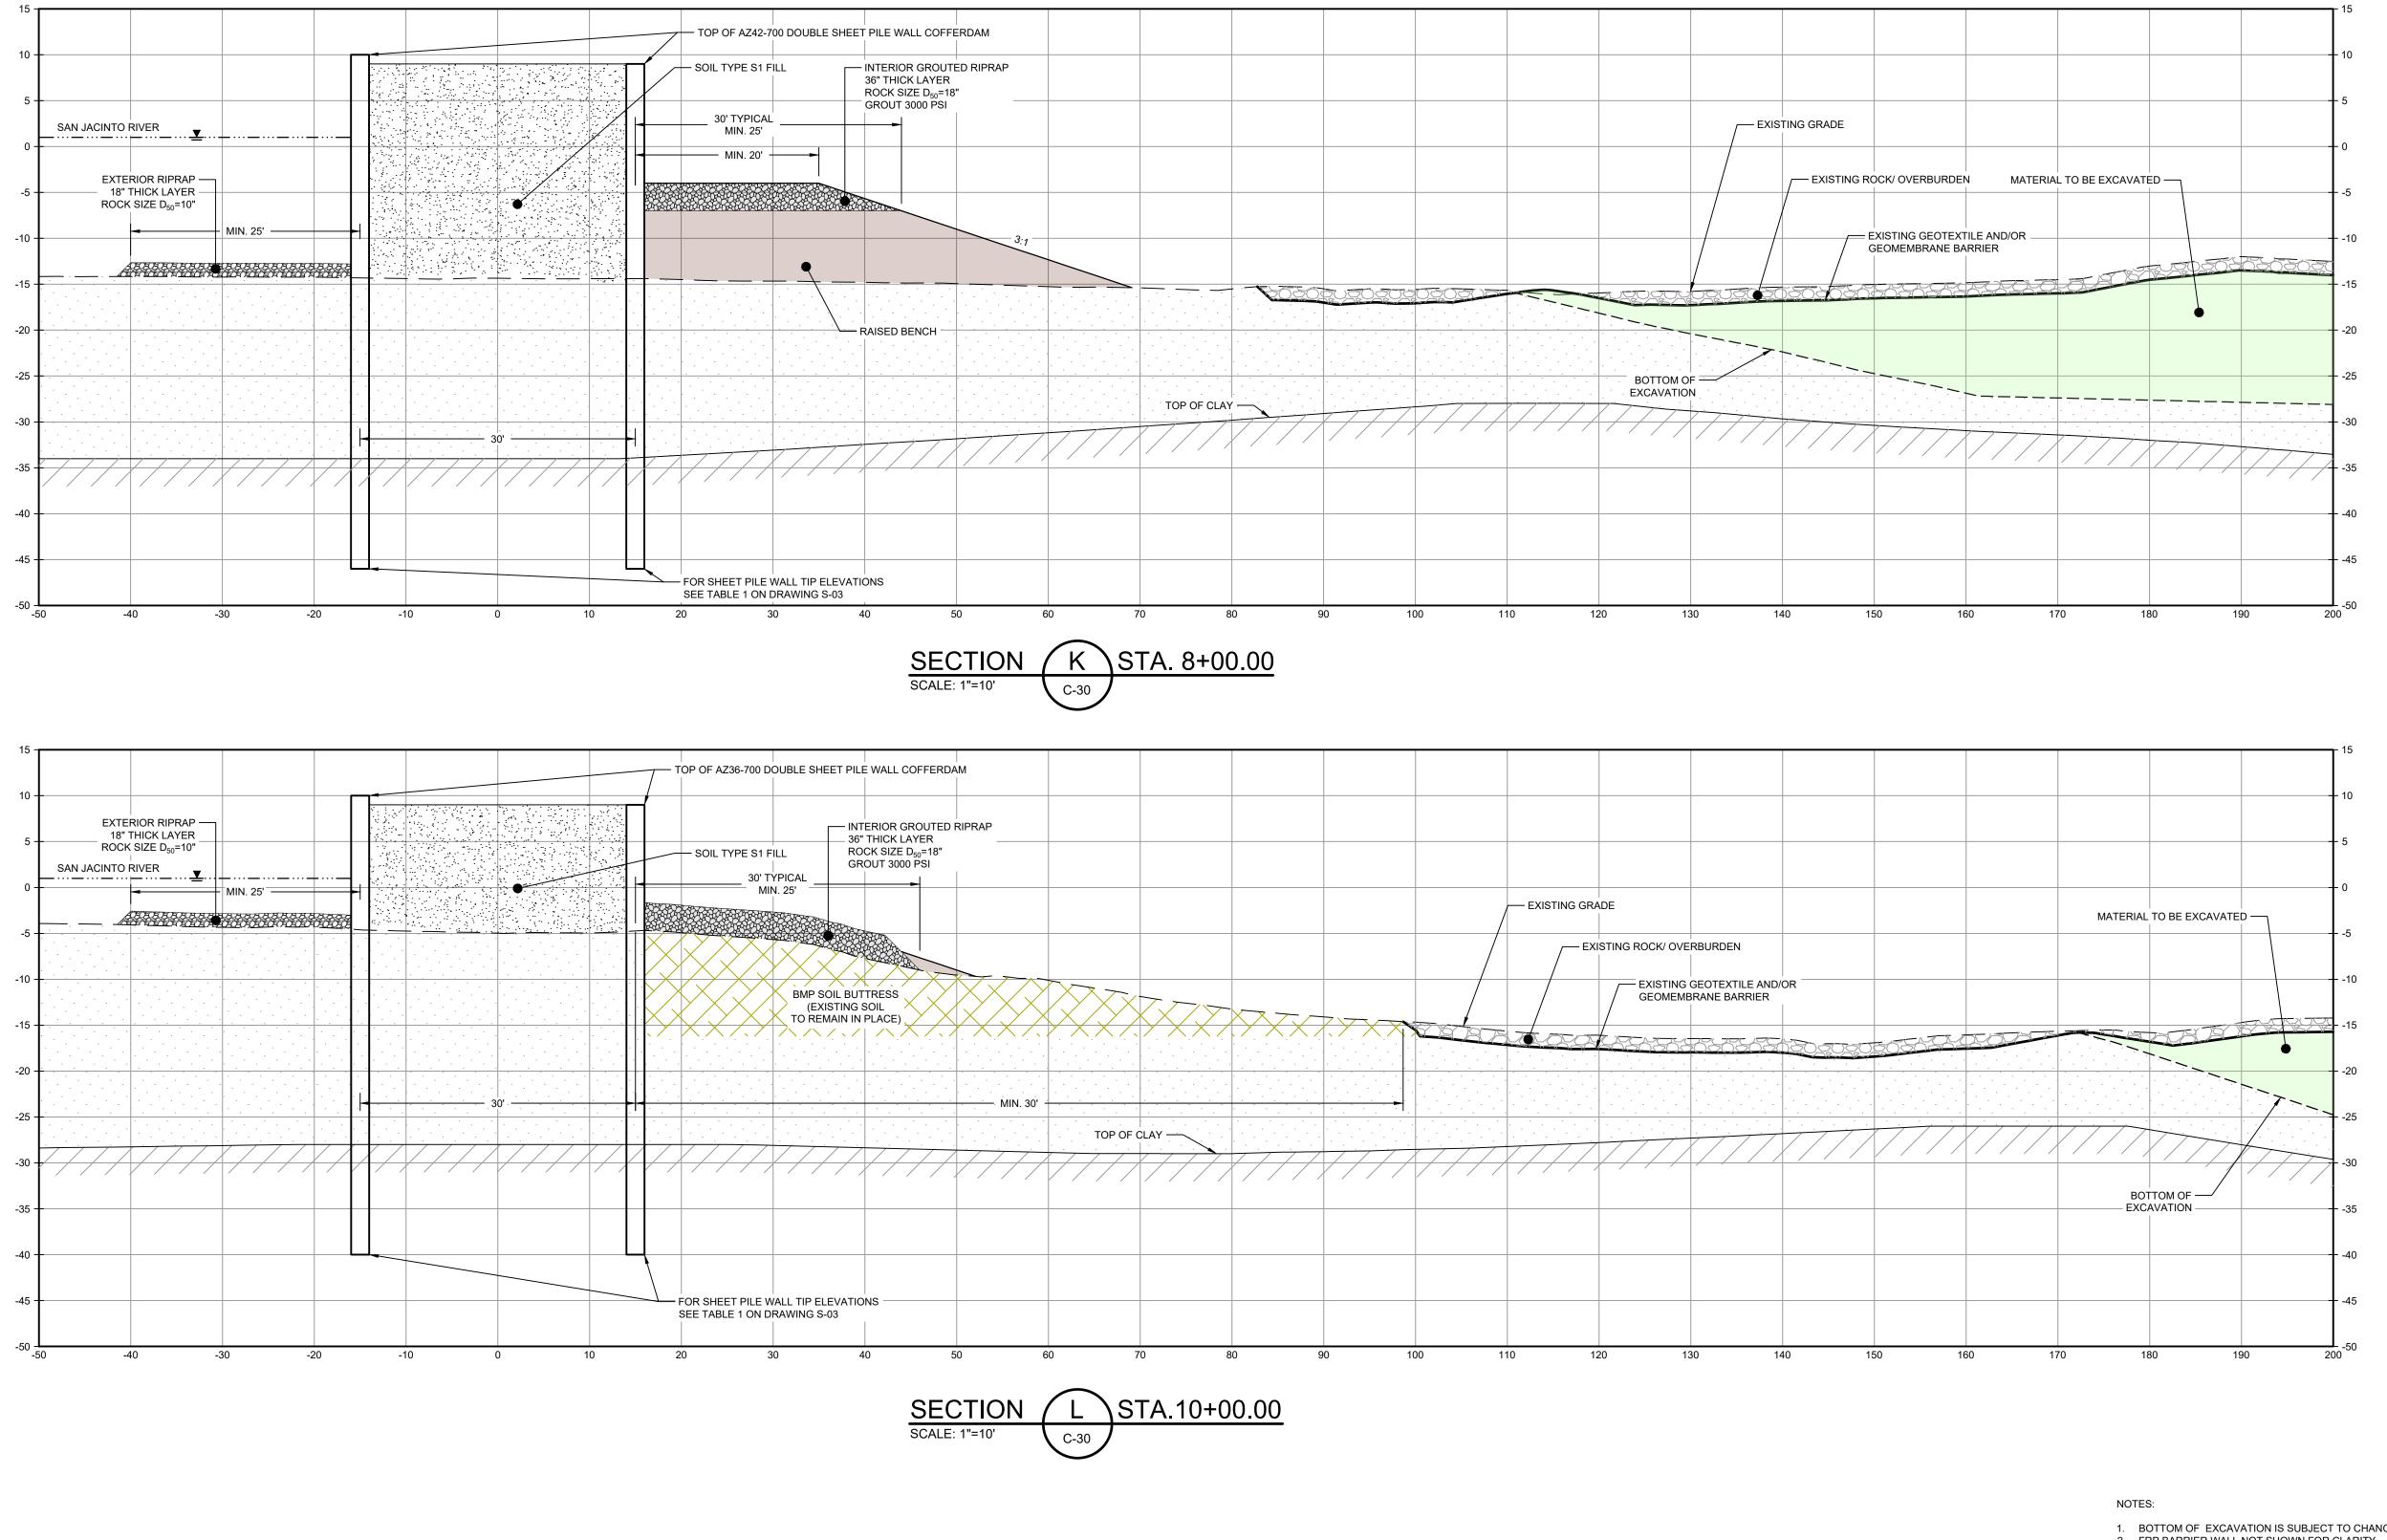

1. BOTTOM OF EXCAVATION IS SUBJECT TO CHANGE. 2. FRP BARRIER WALL NOT SHOWN FOR CLARITY.

THIS DOCUMENT IS RELEASED FOR THE PURPOSE OF EPA REVIEW UNDER THE AUTHORITY OF CLARENCE R. HOEKSTRA, P.E. 147936 ON 07/17/2024. IT IS NOT TO BE USED FOR CONSTRUCTION, BIDDING, RECORDATION, CONVEYANCE OR SALES PURPOSES.

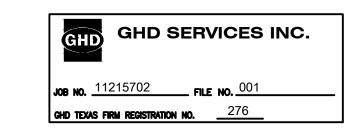

100% EPA SUBMITTAL




2237 S Acadian Thruway Suite 701 Baton Rouge Louisiana 70808 USA **T** 225 292 9007



Reuse of Documents

This document and the ideas and designs incorporated herein, as an instrument of professional service, is the property of GHD and shall not be reused in whole or in part for any other project without GHD's written authorization. © 2024 GHD

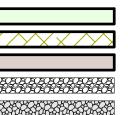

<u>LEGEND</u> MATERIAL TO BE EXCAVATED BMP SOIL BUTTRESS (EXISTING SOIL TO REMAIN IN PLACE) RAISED BENCH

EXTERIOR SCOUR PROTECTION INTERIOR SCOUR PROTECTION

SAN JACINTO RIVER WASTE PITS

NORTHERN IMPOUNDMENT FINAL 100% REMEDIAL DESIGN HARRIS COUNTY, TEXAS

4	100% EPA SUBMITTAL	MW	CRH	07/17/202
No.	Issue	Drawn	Approved	Date
Draw	Drawn MW		RH	
Draft	ing .IC	Design	П	

Check LL Project Coordinator CM Date **Jul 16, 2024** This document shall not be used for construction unless signed and sealed for Scale 1" = 10'

Original Size Arch D


Bar is one inch on original size drawing

Project No. **11215702**

DOUBLE PILE WALL SECTIONS 3 OF 7


Sheet No.

C-37

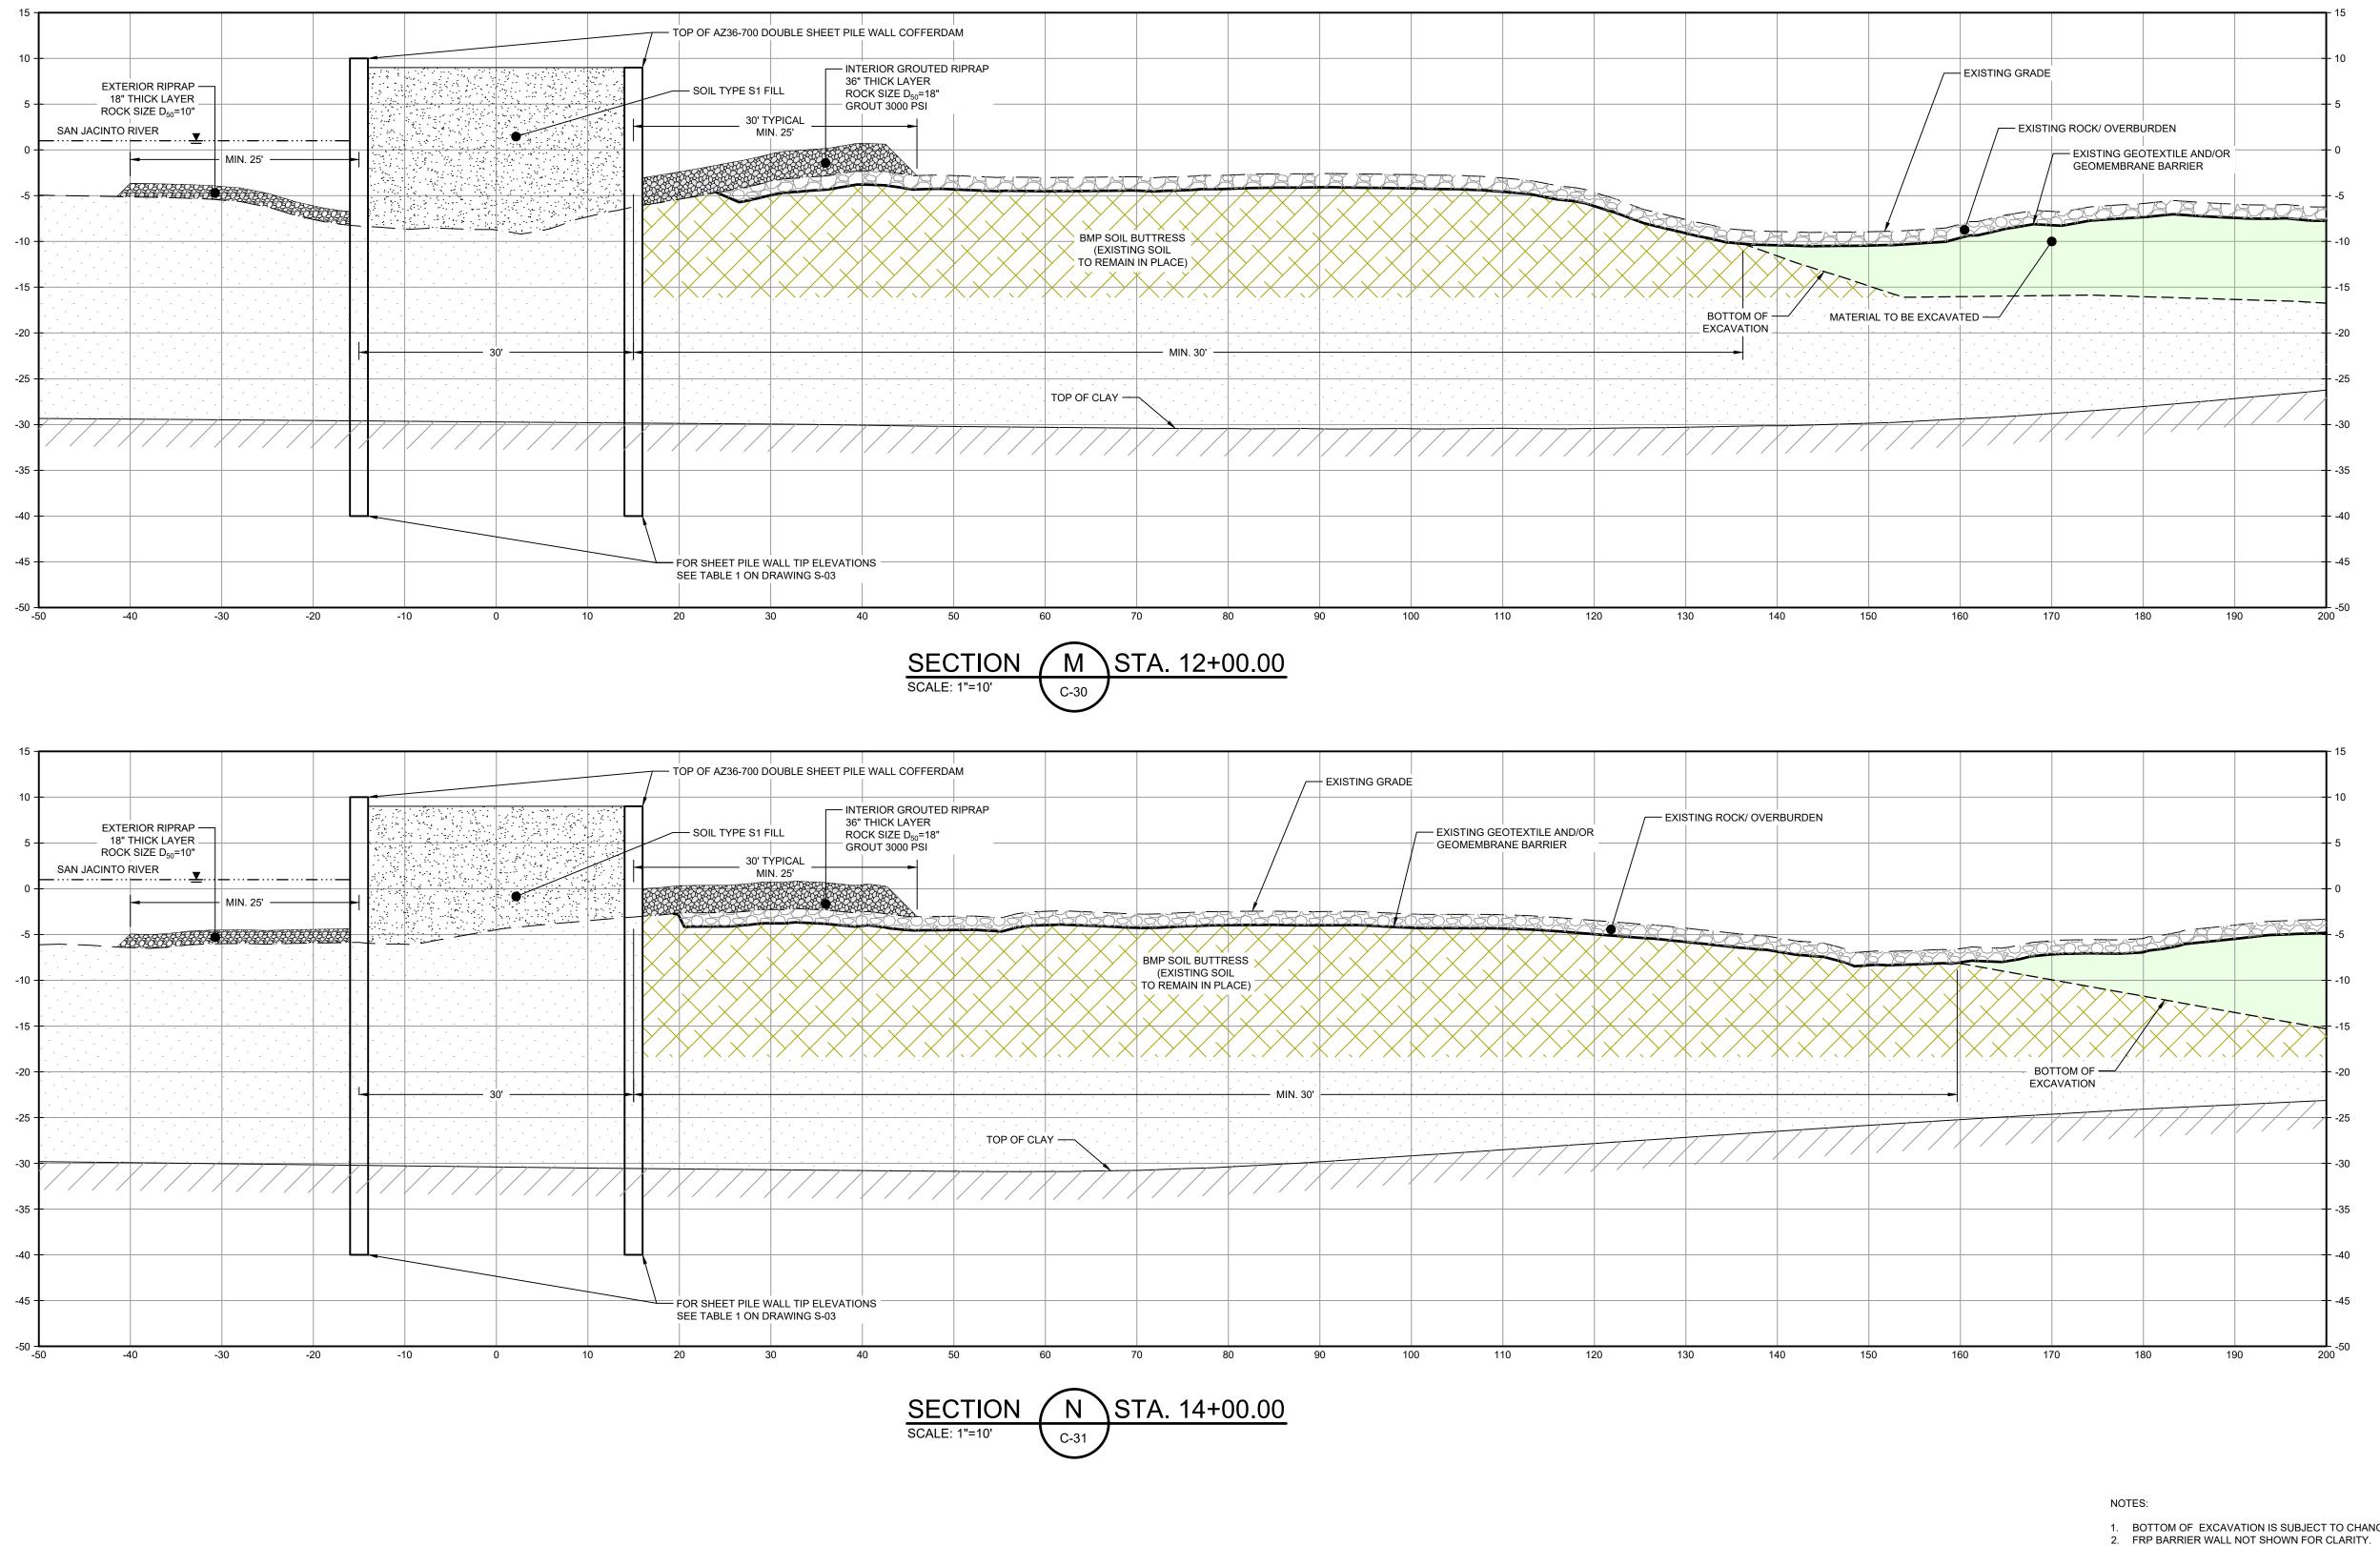

1. BOTTOM OF EXCAVATION IS SUBJECT TO CHANGE.

THIS DOCUMENT IS RELEASED FOR THE PURPOSE OF EPA REVIEW UNDER THE AUTHORITY OF CLARENCE R. HOEKSTRA, P.E. 147936 ON 07/17/2024. IT IS NOT TO BE USED FOR CONSTRUCTION, BIDDING, RECORDATION, CONVEYANCE OR SALES PURPOSES.

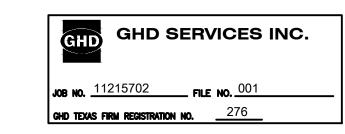

100% EPA SUBMITTAL



2237 S Acadian Thruway Suite 701 Baton Rouge Louisiana 70808 USA **T** 225 292 9007



Reuse of Documents


This document and the ideas and designs incorporated herein, as an instrument of professional service, is the property of GHD and shall not be reused in whole or in part for any other project without GHD's written authorization. © 2024 GHD

<u>LEGEND</u>

MATERIAL TO BE EXCAVATED BMP SOIL BUTTRESS (EXISTING SOIL TO REMAIN IN PLACE) EXTERIOR SCOUR PROTECTION INTERIOR SCOUR PROTECTION

SAN JACINTO RIVER **WASTE PITS**

NORTHERN IMPOUNDMENT FINAL 100% REMEDIAL DESIGN HARRIS COUNTY, TEXAS

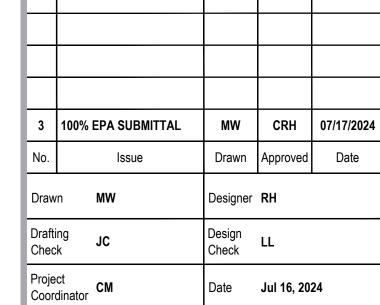

This document shall not be used for construction unless signed and sealed for Scale 1" = 10' Original Size

Bar is one inch on original size drawing Arch D


Date **Jul 16, 2024**

Project No. **11215702**

DOUBLE PILE WALL SECTIONS 4 OF 7


Sheet No.

C-38

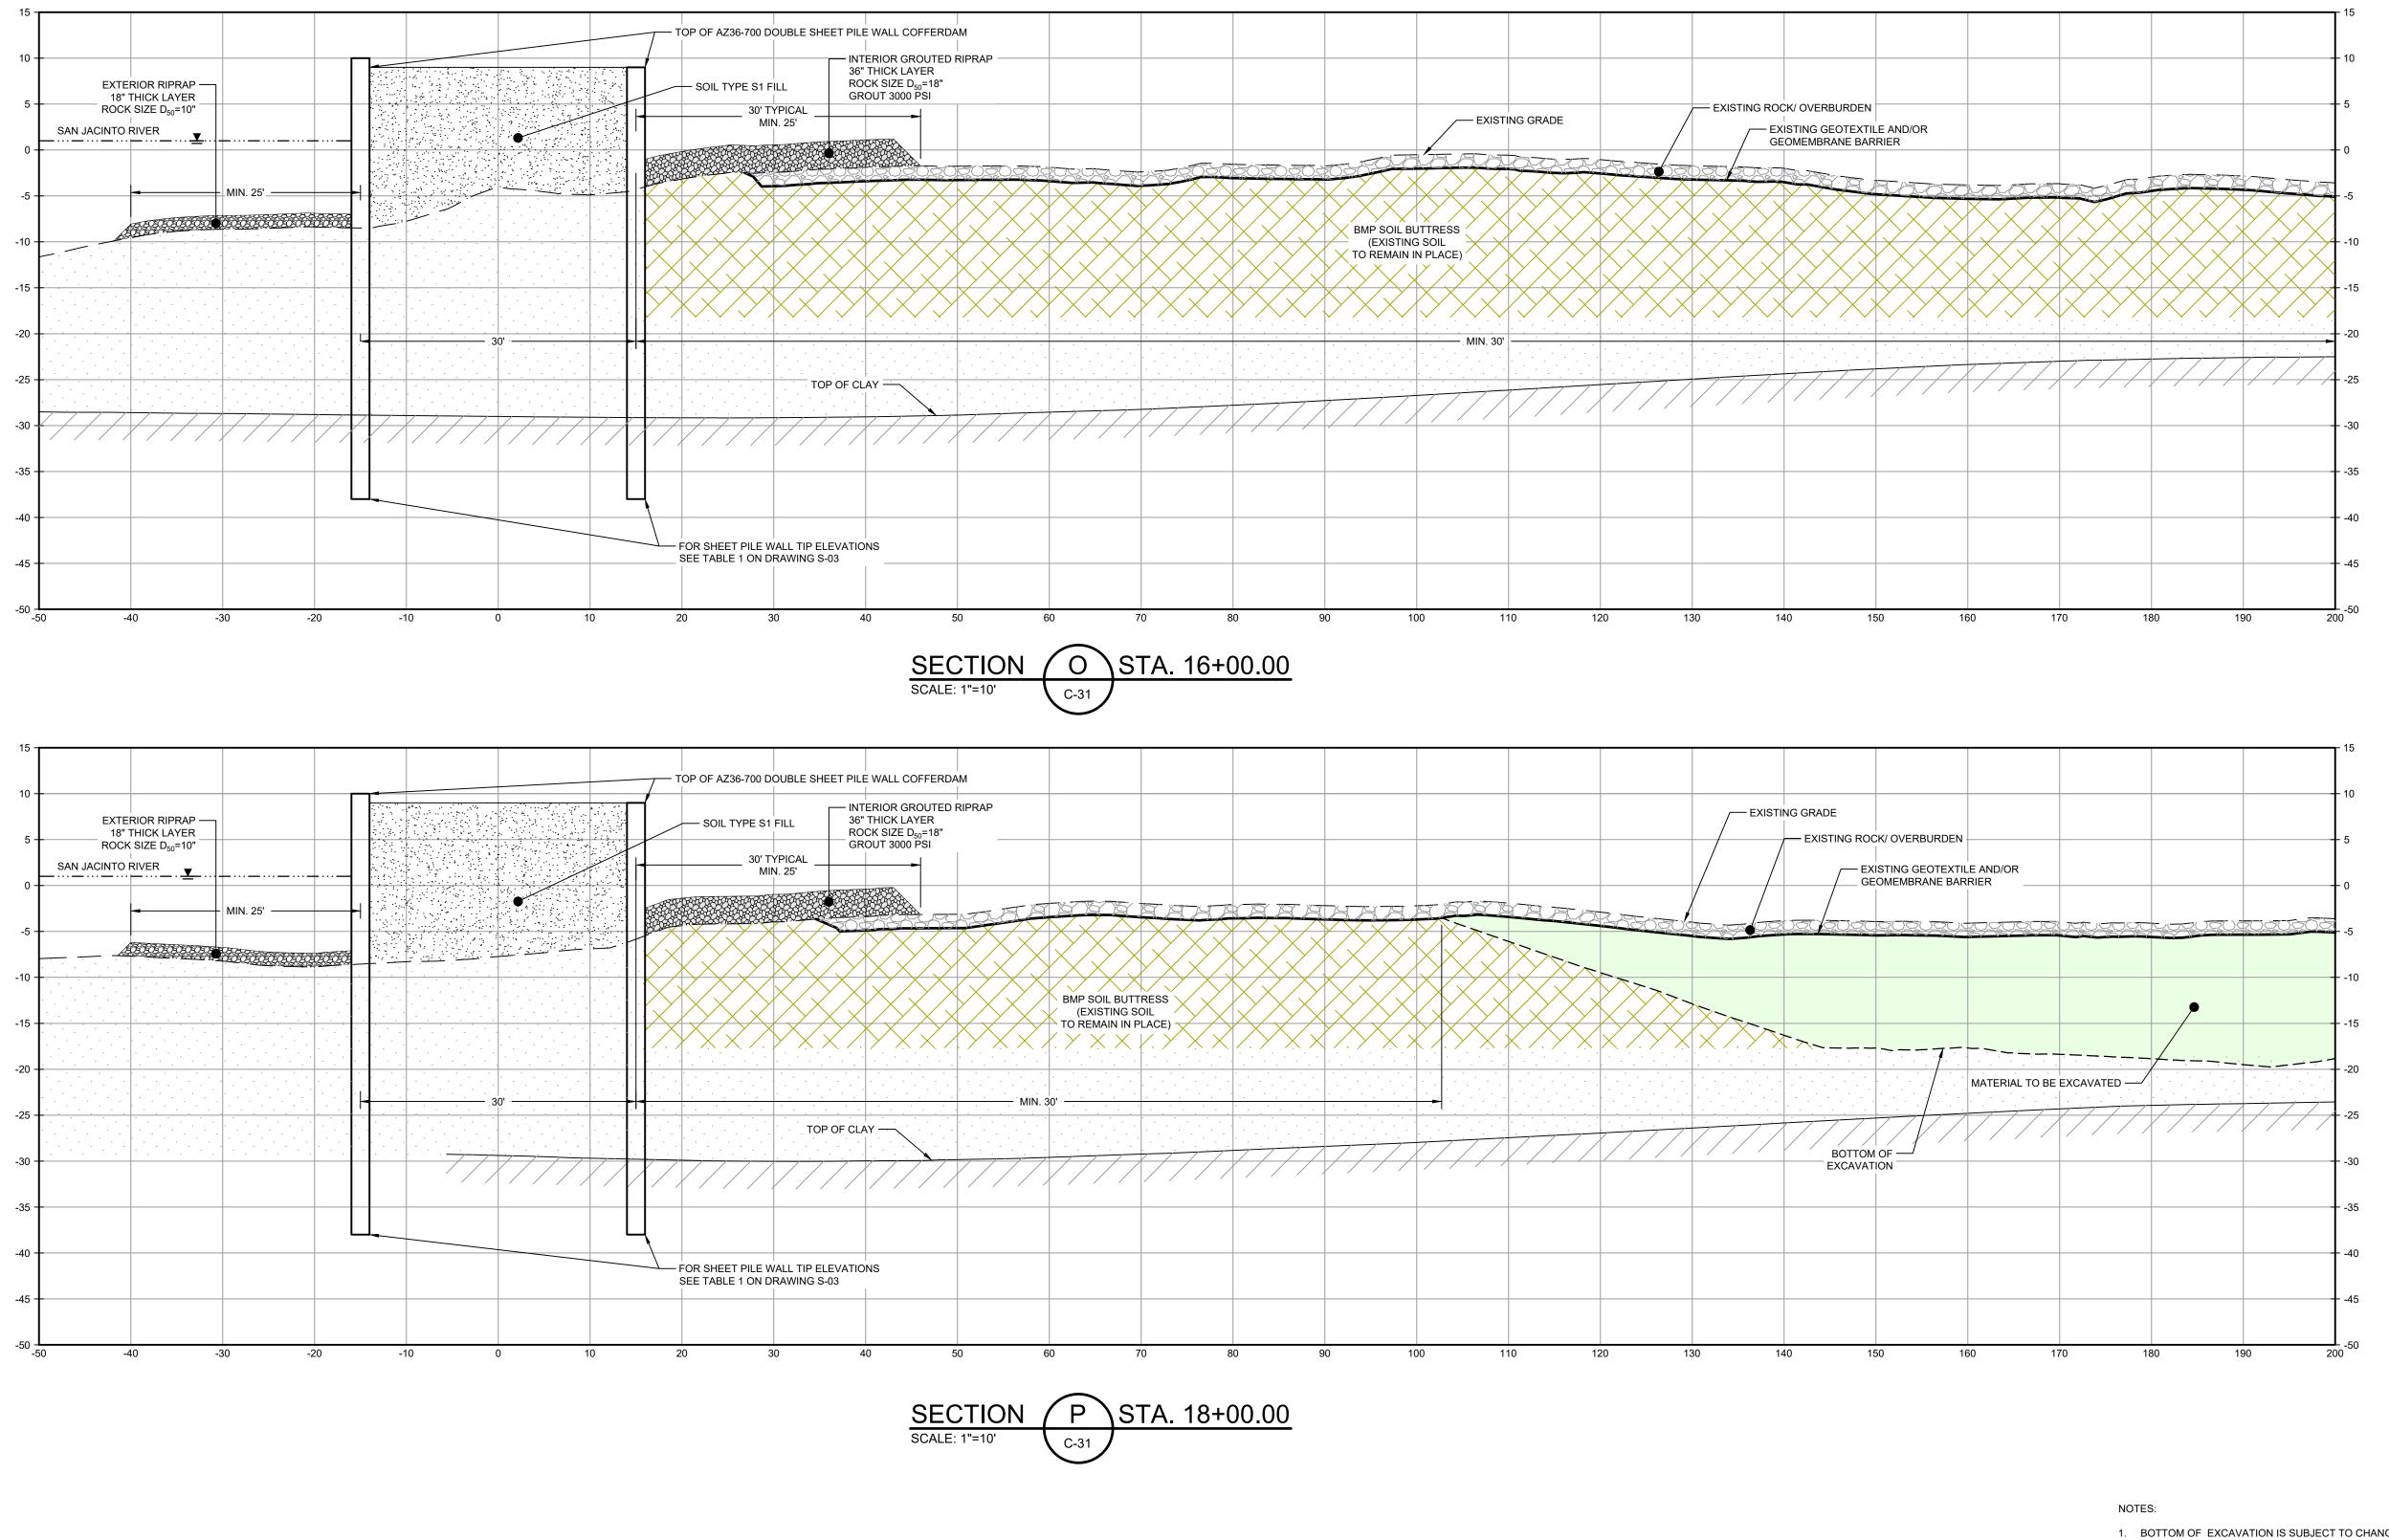

1. BOTTOM OF EXCAVATION IS SUBJECT TO CHANGE. 2. FRP BARRIER WALL NOT SHOWN FOR CLARITY.

THIS DOCUMENT IS RELEASED FOR THE PURPOSE OF EPA REVIEW UNDER THE AUTHORITY OF CLARENCE R. HOEKSTRA, P.E. 147936 ON 07/17/2024. IT IS NOT TO BE USED FOR CONSTRUCTION, BIDDING, RECORDATION, CONVEYANCE OR SALES PURPOSES.

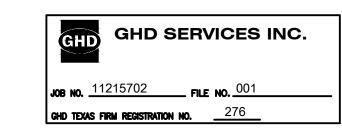

100% EPA SUBMITTAL




2237 S Acadian Thruway Suite 701 Baton Rouge Louisiana 70808 USA **T** 225 292 9007



Reuse of Documents

This document and the ideas and designs incorporated herein, as an instrument of professional service, is the property of GHD and shall not be reused in whole or in part for any other project without GHD's written authorization. © 2024 GHD

<u>LEGEND</u>

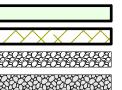

MATERIAL TO BE EXCAVATED BMP SOIL BUTTRESS (EXISTING SOIL TO REMAIN IN PLACE) EXTERIOR SCOUR PROTECTION INTERIOR SCOUR PROTECTION

SAN JACINTO RIVER **WASTE PITS**

NORTHERN IMPOUNDMENT FINAL 100% REMEDIAL DESIGN HARRIS COUNTY, TEXAS

3	100% EPA SUBMITTAL	MW	CRH	07/17/20
No.	Issue	Drawn	Approved	Date
Draw	n MW	Designer	RH	
Drafti Chec	· .II.	Design Check	LL	
Proje Coor	ct dinator	Date	Jul 16, 20	24
constr	document shall not be used for uction unless signed and sealed for	Scale	1" = 10'	

Original Size

Bar is one inch on original size drawing Arch D

Project No. **11215702**

DOUBLE PILE WALL SECTIONS 5 OF 7

Sheet No.


C-39

Sheet - of -


Plot Date: 17 July 2024 - 12:59 PM

Plotted By: Jonathan Compton

Filename: \\ghdnet\ghd\US\Baton Rouge\Projects\562\11215702\Digital_Design\ACAD 2019\Sheets\11215702-01-DWG-C-035.dwg

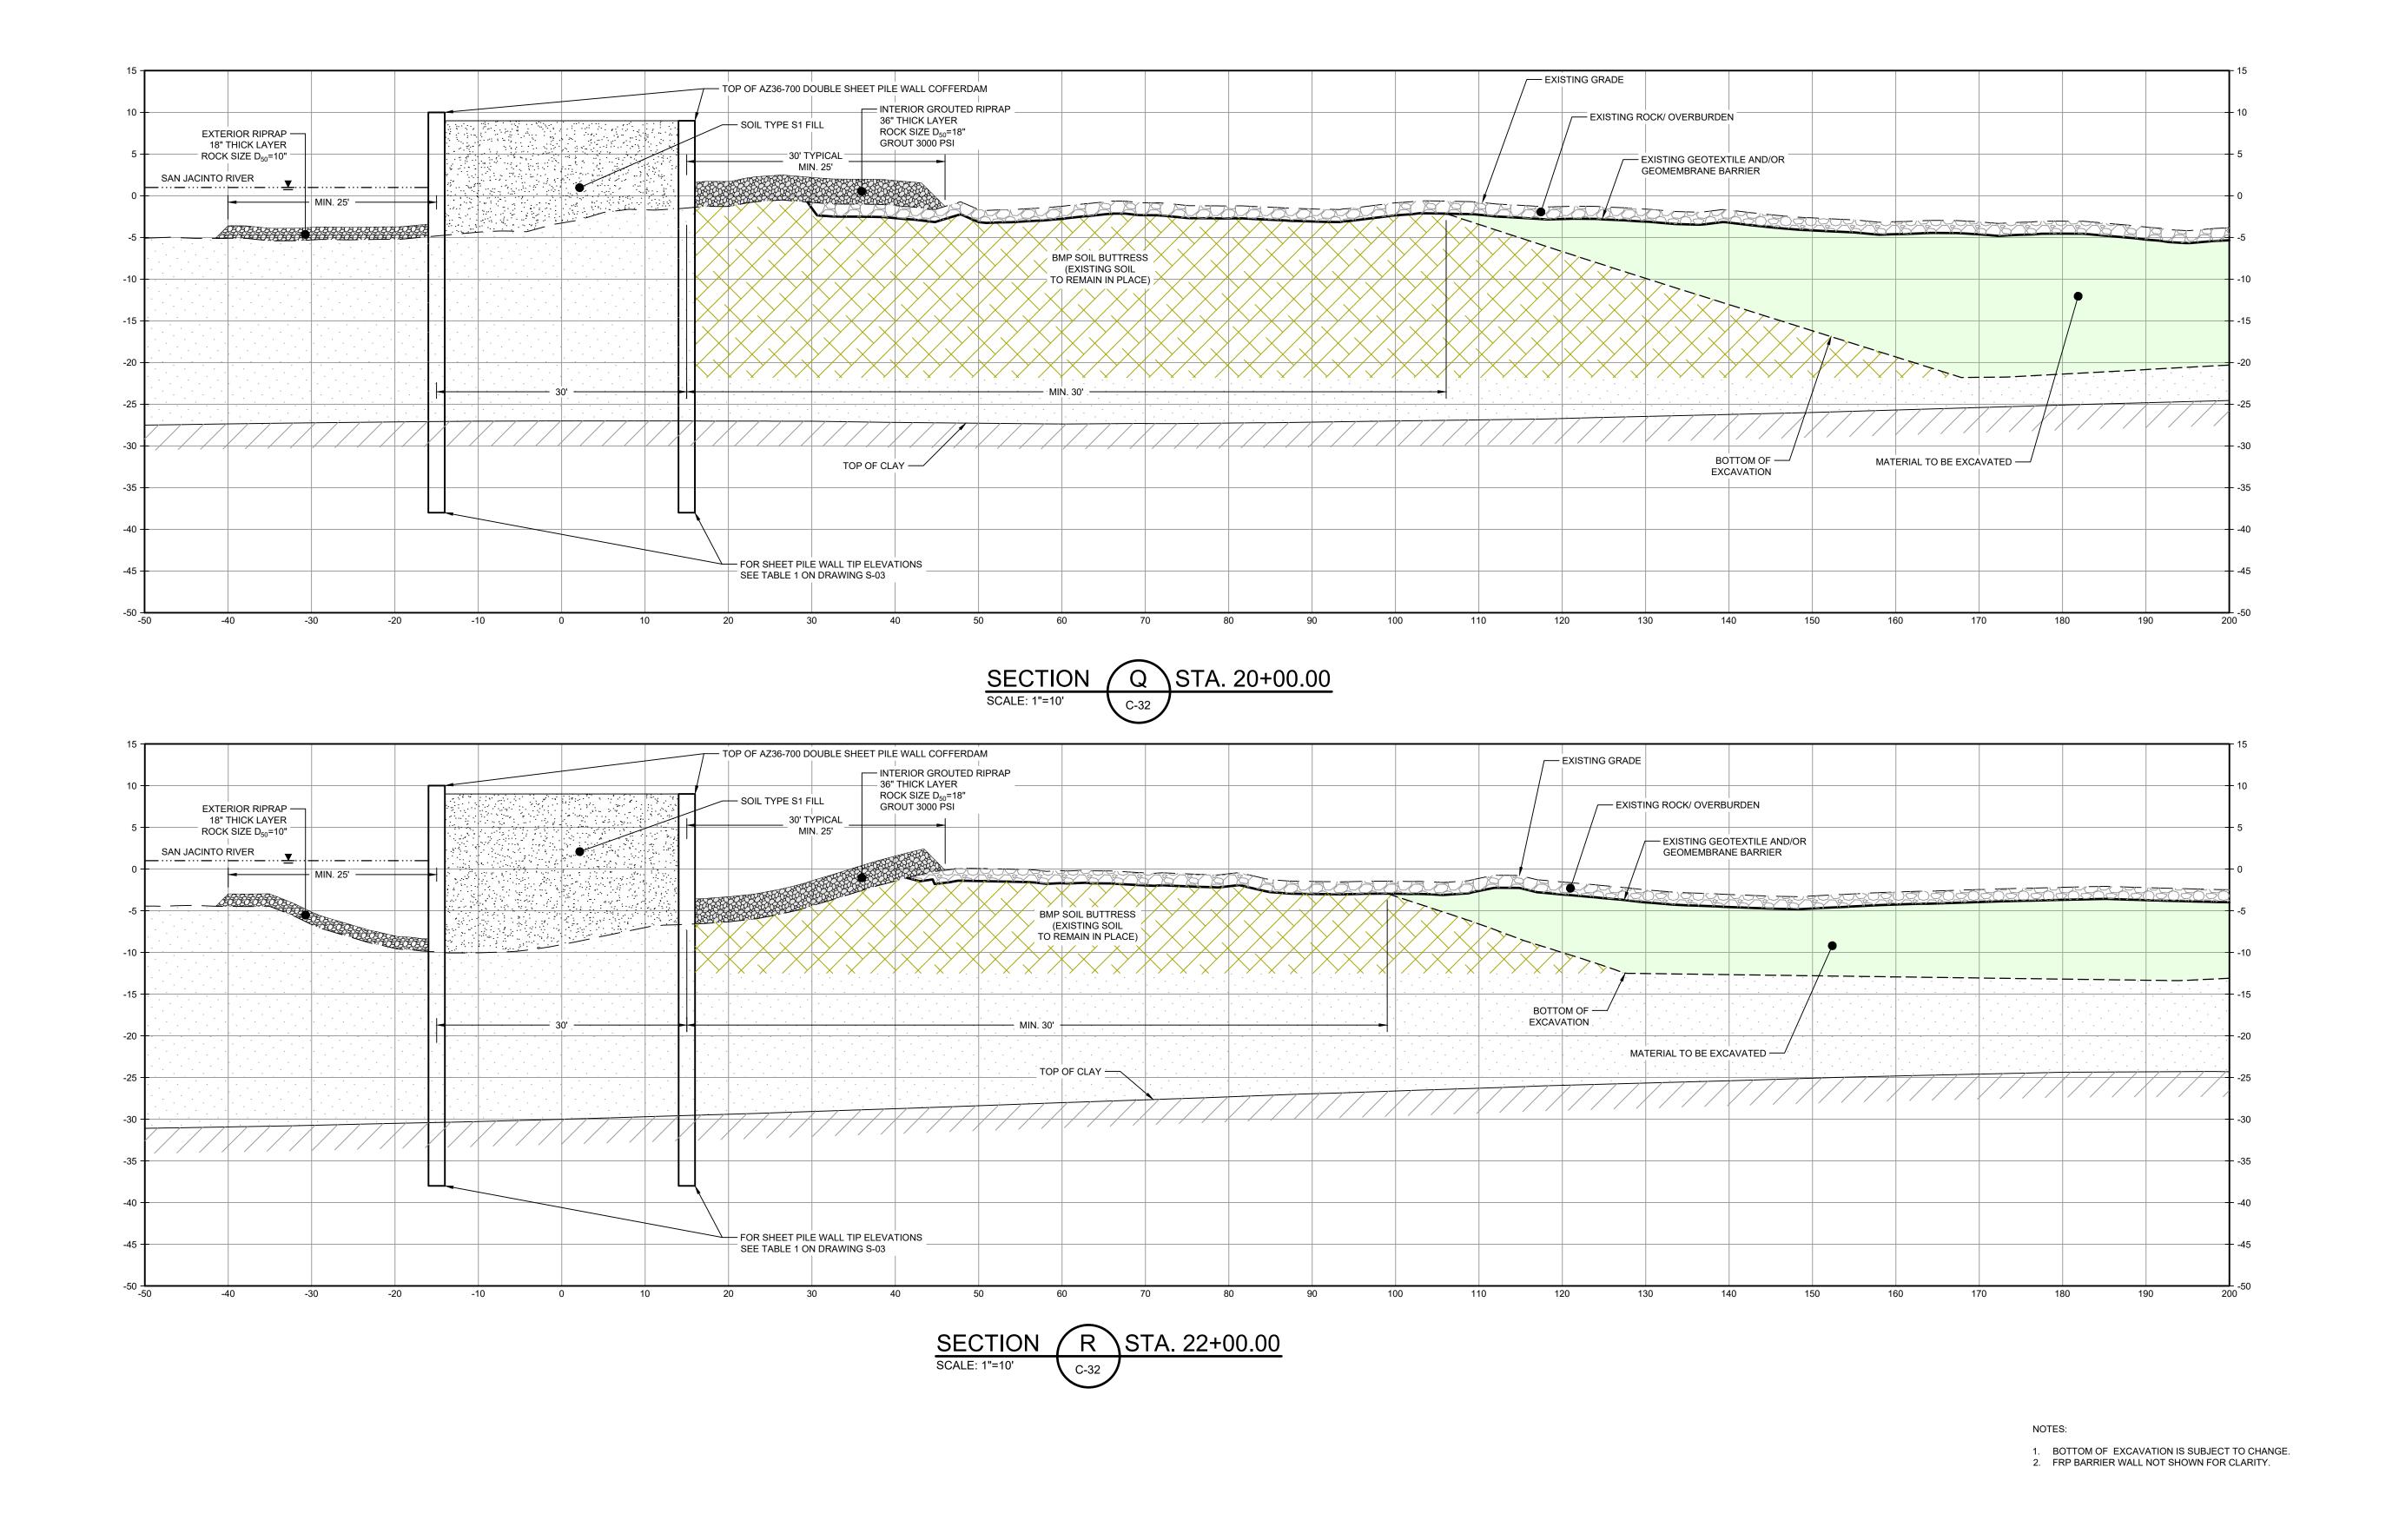

2237 S Acadian Thruway Suite 701 Baton Rouge Louisiana 70808 USA **T** 225 292 9007

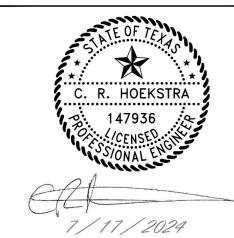

Reuse of Documents This document and the ideas and designs incorporated herein, as an instrument of

professional service, is the property of GHD and shall not be reused in whole or in part for any other project without GHD's written authorization. © 2024 GHD


<u>LEGEND</u>

MATERIAL TO BE EXCAVATED BMP SOIL BUTTRESS (EXISTING SOIL TO REMAIN IN PLACE) EXTERIOR SCOUR PROTECTION INTERIOR SCOUR PROTECTION

SAN JACINTO RIVER

WASTE PITS

NORTHERN IMPOUNDMENT FINAL 100% REMEDIAL DESIGN HARRIS COUNTY, TEXAS

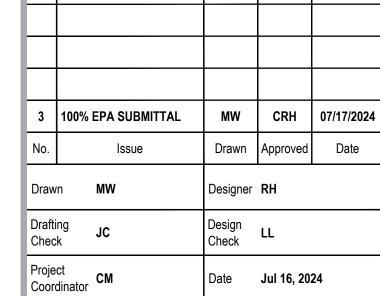

This document shall not be used for construction unless signed and sealed for Scale 1" = 10'

Original Size

Bar is one inch on original size drawing Arch D

Project No. **11215702**

THIS DOCUMENT IS RELEASED FOR THE PURPOSE OF

EPA REVIEW UNDER THE AUTHORITY OF CLARENCE R. HOEKSTRA, P.E. 147936 ON 07/17/2024. IT IS NOT TO BE

USED FOR CONSTRUCTION, BIDDING, RECORDATION,

GHD TEXAS FIRM REGISTRATION NO. 276

GHD SERVICES INC.

100% EPA SUBMITTAL

CONVEYANCE OR SALES PURPOSES.

DOUBLE PILE WALL SECTIONS 6 OF 7

Sheet No.


C-40

Sheet - of -

Plotted By: Jonathan Compton


Plot Date: 17 July 2024 - 12:59 PM

Filename: \\ghdnet\ghd\US\Baton Rouge\Projects\562\11215702\Digital_Design\ACAD 2019\Sheets\11215702-01-DWG-C-035.dwg

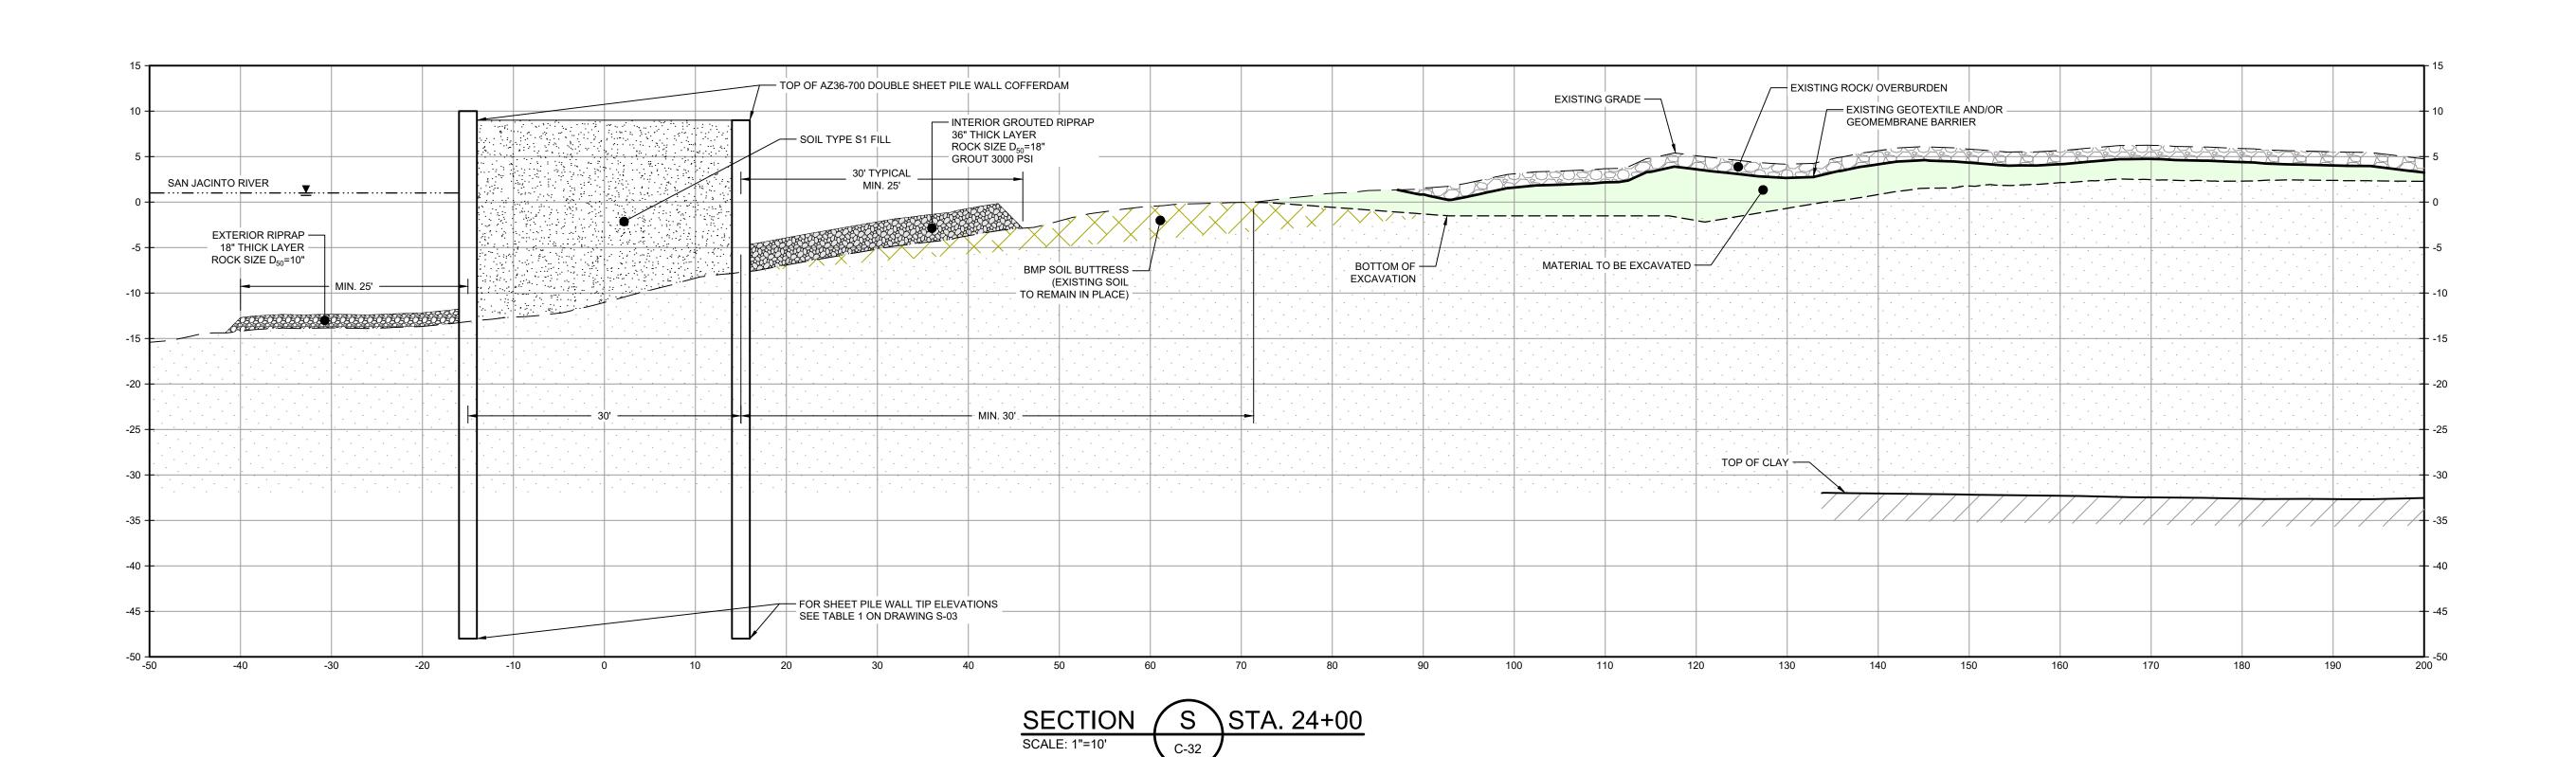

1. BOTTOM OF EXCAVATION IS SUBJECT TO CHANGE. 2. FRP BARRIER WALL NOT SHOWN FOR CLARITY.

THIS DOCUMENT IS RELEASED FOR THE PURPOSE OF EPA REVIEW UNDER THE AUTHORITY OF CLARENCE R. HOEKSTRA, P.E. 147936 ON 07/17/2024. IT IS NOT TO BE USED FOR CONSTRUCTION, BIDDING, RECORDATION, CONVEYANCE OR SALES PURPOSES.

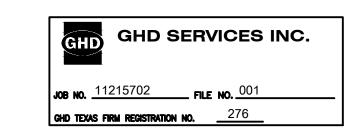

100% EPA SUBMITTAL



2237 S Acadian Thruway Suite 701 Baton Rouge Louisiana 70808 USA **T** 225 292 9007



Reuse of Documents

This document and the ideas and designs incorporated herein, as an instrument of professional service, is the property of GHD and shall not be reused in whole or in part for any other project without GHD's written authorization. © 2024 GHD

<u>LEGEND</u>

MATERIAL TO BE EXCAVATED BMP SOIL BUTTRESS (EXISTING SOIL TO REMAIN IN PLACE) EXTERIOR SCOUR PROTECTION INTERIOR SCOUR PROTECTION

SAN JACINTO RIVER WASTE PITS

NORTHERN IMPOUNDMENT FINAL 100% REMEDIAL DESIGN HARRIS COUNTY, TEXAS

3	100% EPA SUBMITTAL	MW	CRH	07/17
No.	Issue	Drawn	Approved	Da
Draw	n MW	Designer	RH	
Drafti Chec	· .II.	Design Check	LL	
Proje Coor	ct dinator CM	Date	Jul 16, 20	24
constr	document shall not be used for uction unless signed and sealed for uction.	Scale	1" = 10'	

Original Size Arch D


Bar is one inch on original size drawing


Project No. **11215702**


DOUBLE PILE WALL SECTIONS 7 OF 7

Sheet No.

C-41

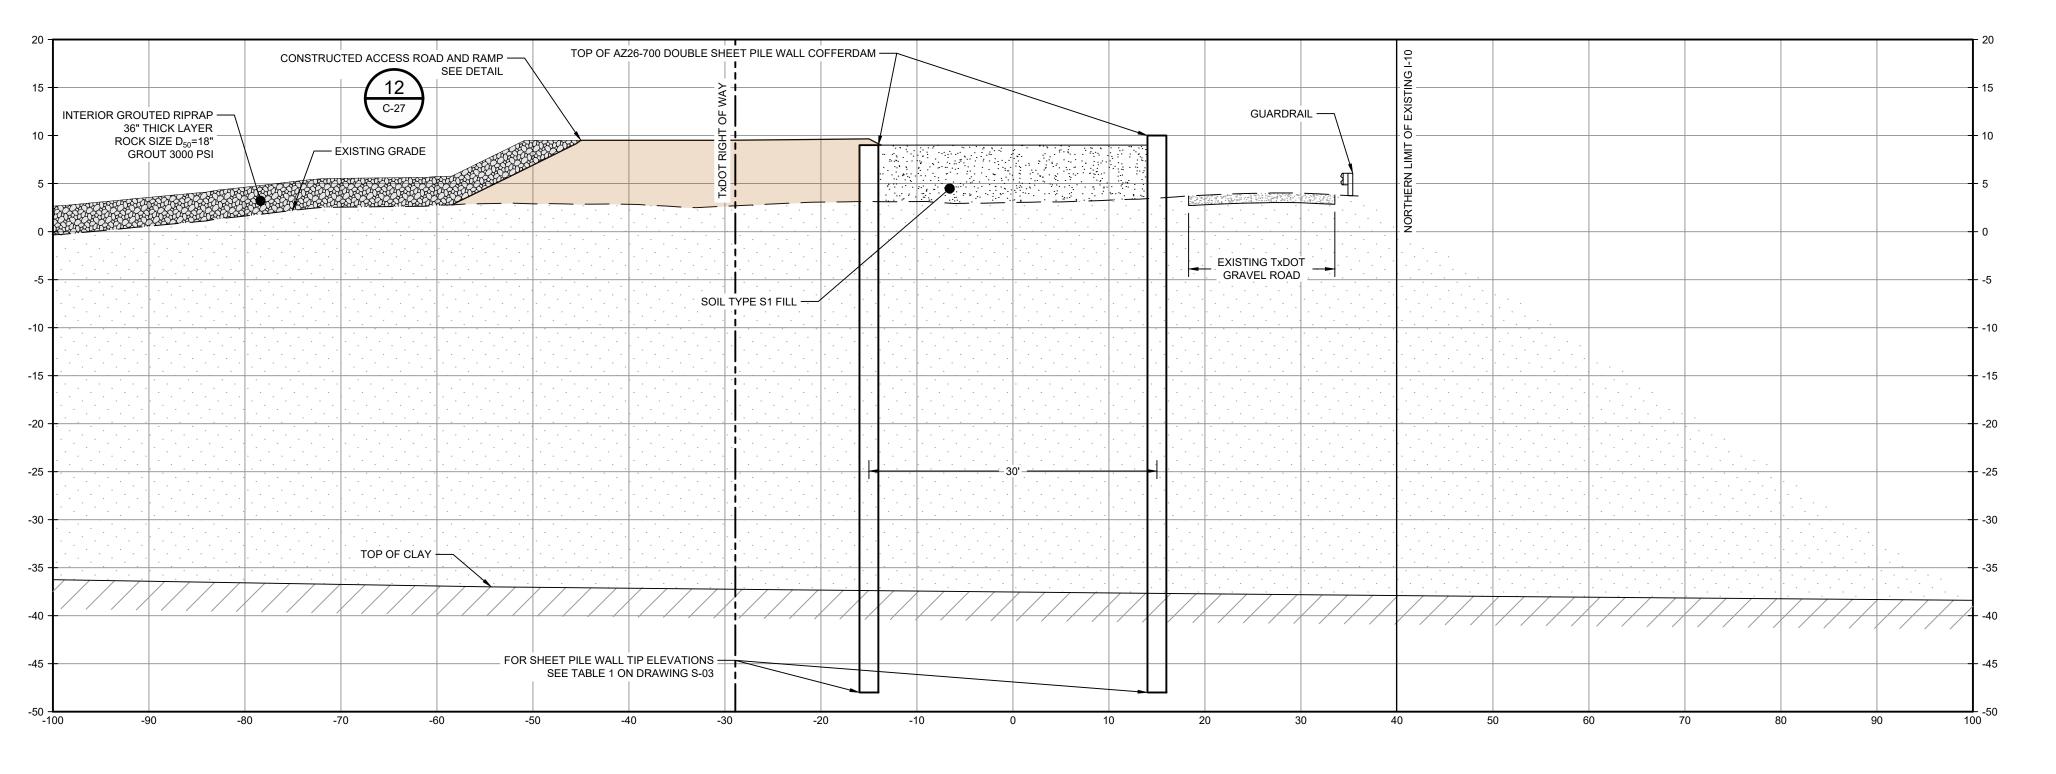

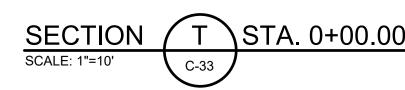

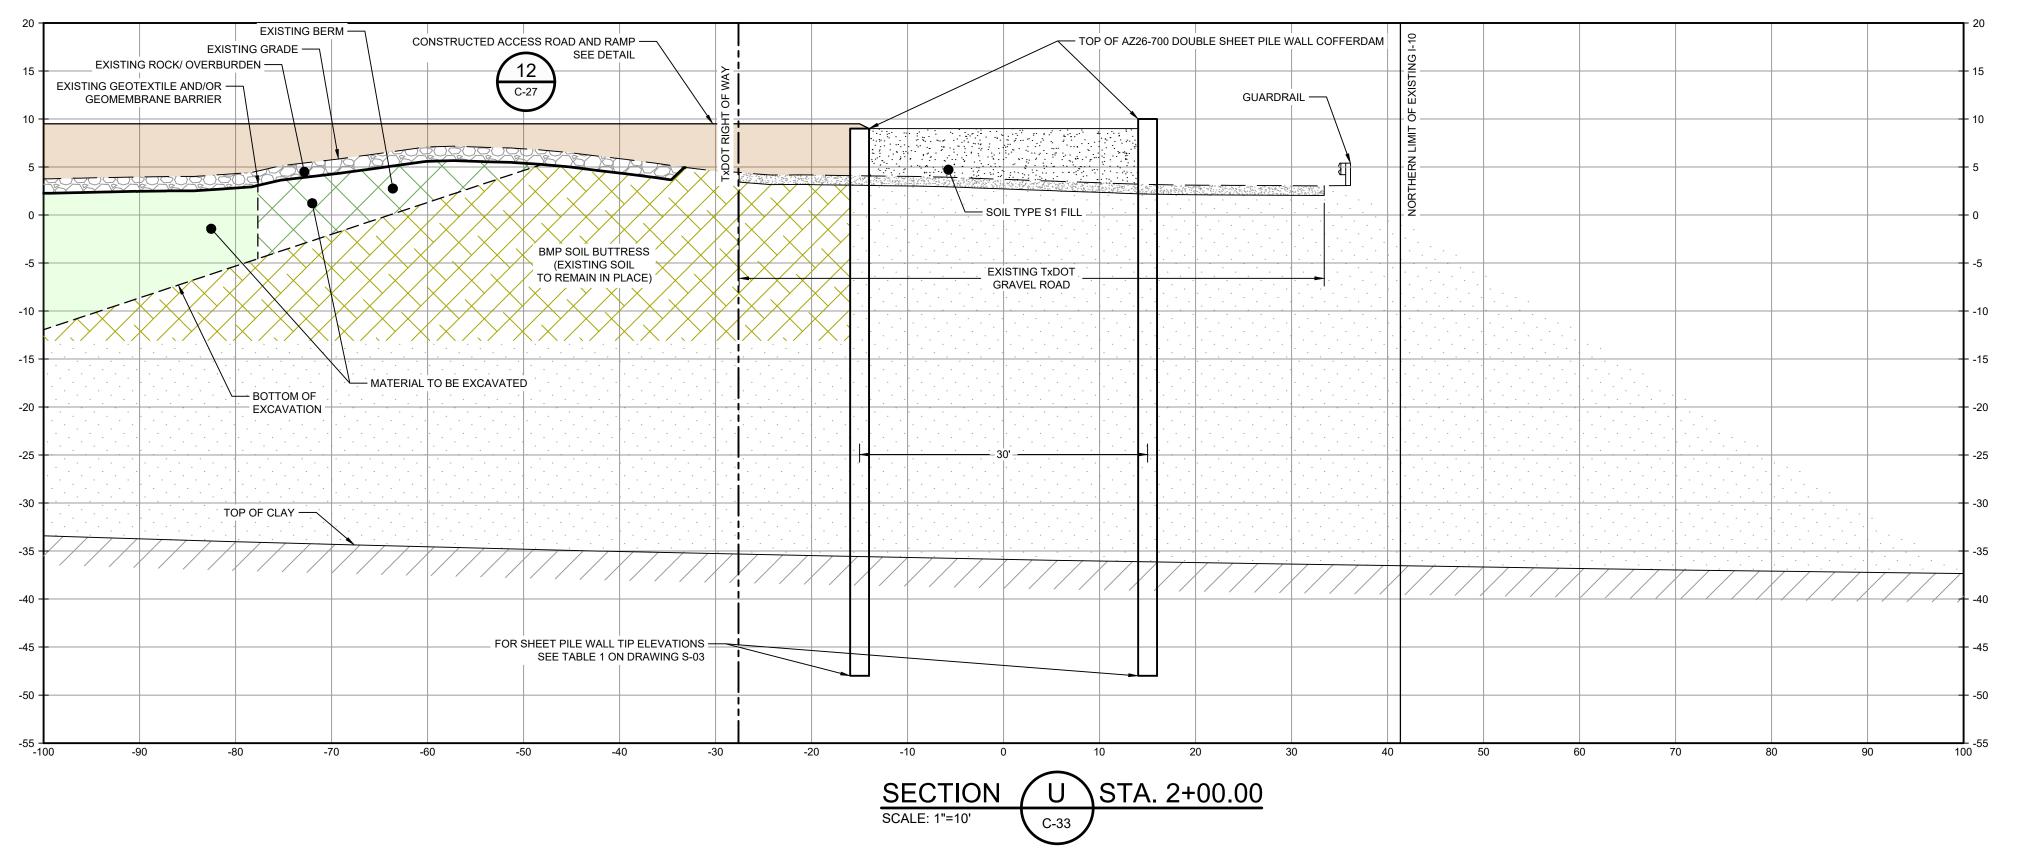


TXDOT RIGHT OF WAY FROM A BOUNDARY AND RIGHT-OF-WAY SURVEY OF PORT OF HOUSTON AUTHORITY PROPERTY & HOUSTON FLEETING SERVICES, LLC PROPERTY ALONG INTERSTATE HIGHWAY 10 AT THE SAN JACINTO FLEET AREA, IN THE J. T. HARRELL SURVEY, A-330 HARRIS COUNTY, TEXAS, COBBFENDLEY, 2402-028-01, JUNE 28, 2024

NOTES:

1. BOTTOM OF EXCAVATION IS SUBJECT TO CHANGE.


THIS DOCUMENT IS RELEASED FOR THE PURPOSE OF EPA REVIEW UNDER THE AUTHORITY OF CLARENCE R. HOEKSTRA, P.E. 147936 ON 07/17/2024. IT IS NOT TO BE USED FOR CONSTRUCTION, BIDDING, RECORDATION, CONVEYANCE OR SALES PURPOSES.

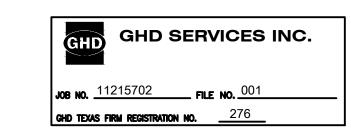

100% EPA SUBMITTAL




2237 S Acadian Thruway Suite 701 Baton Rouge Louisiana 70808 USA **T** 225 292 9007

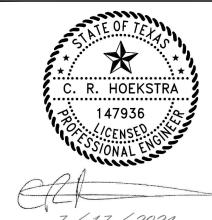

Reuse of Documents

This document and the ideas and designs incorporated herein, as an instrument of professional service, is the property of GHD and shall not be reused in whole or in part for any other project without GHD's written authorization. © 2024 GHD

<u>LEGEND</u>

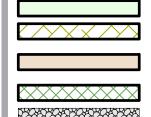

MATERIAL TO BE EXCAVATED BMP SOIL BUTTRESS (EXISTING SOIL TO REMAIN IN PLACE) PLANNED IMPROVEMENTS FOR NORTHERN IMPOUNDMENT ACCESS EXISTING BERM TO BE EXCAVATED FOR POTENTIAL TESTING AND REUSE INTERIOR SCOUR PROTECTION

SAN JACINTO RIVER WASTE PITS

NORTHERN IMPOUNDMENT FINAL 100% REMEDIAL DESIGN HARRIS COUNTY, TEXAS

ı					
ı					
ı					
ı	3	100% EPA SUBMITTAL	MW	CRH	07/17/20
ı	No.	Issue	Drawn	Approved	Date
l	Draw	n MW	Designer	RH	
ı	Drafti Chec	· .I(.	Design Check	LL	
		Project CM Coordinator		Jul 16, 2024	
	constr	document shall not be used for uction unless signed and sealed for uction.	Scale	1" = 10'	

Original Size Arch D


Bar is one inch on original size drawing


Project No. **11215702**


SOUTH WALL SECTIONS 1 OF 3

Sheet No.

C-42

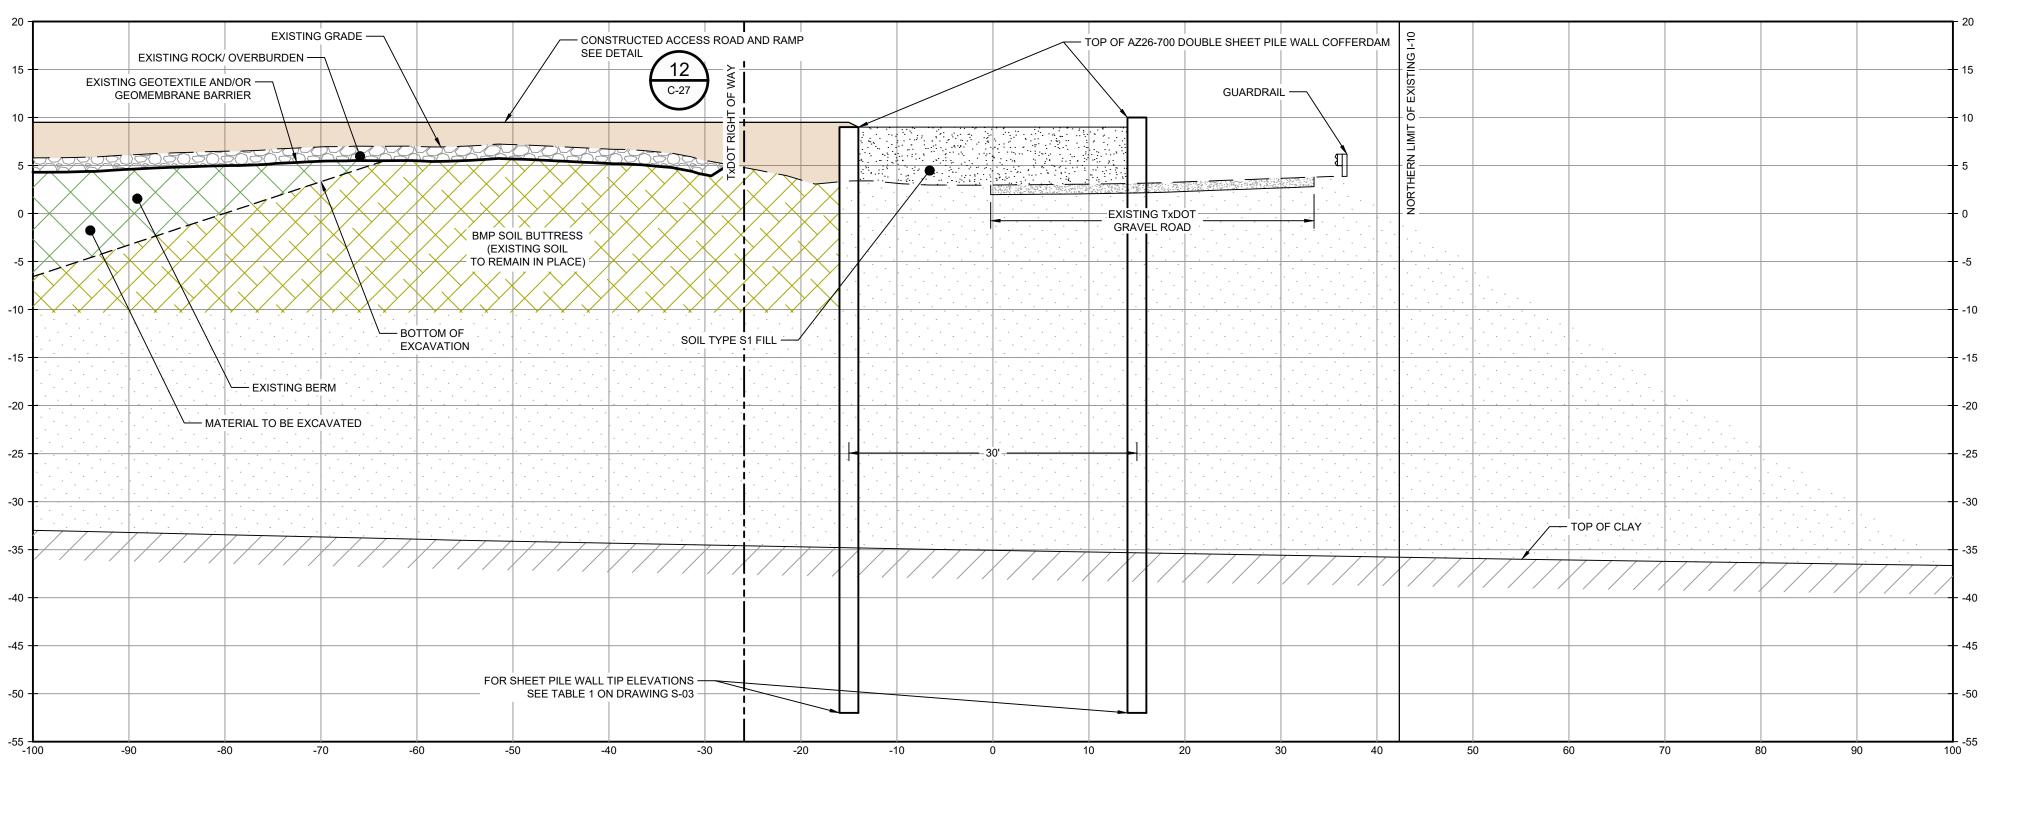

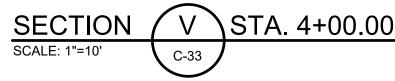

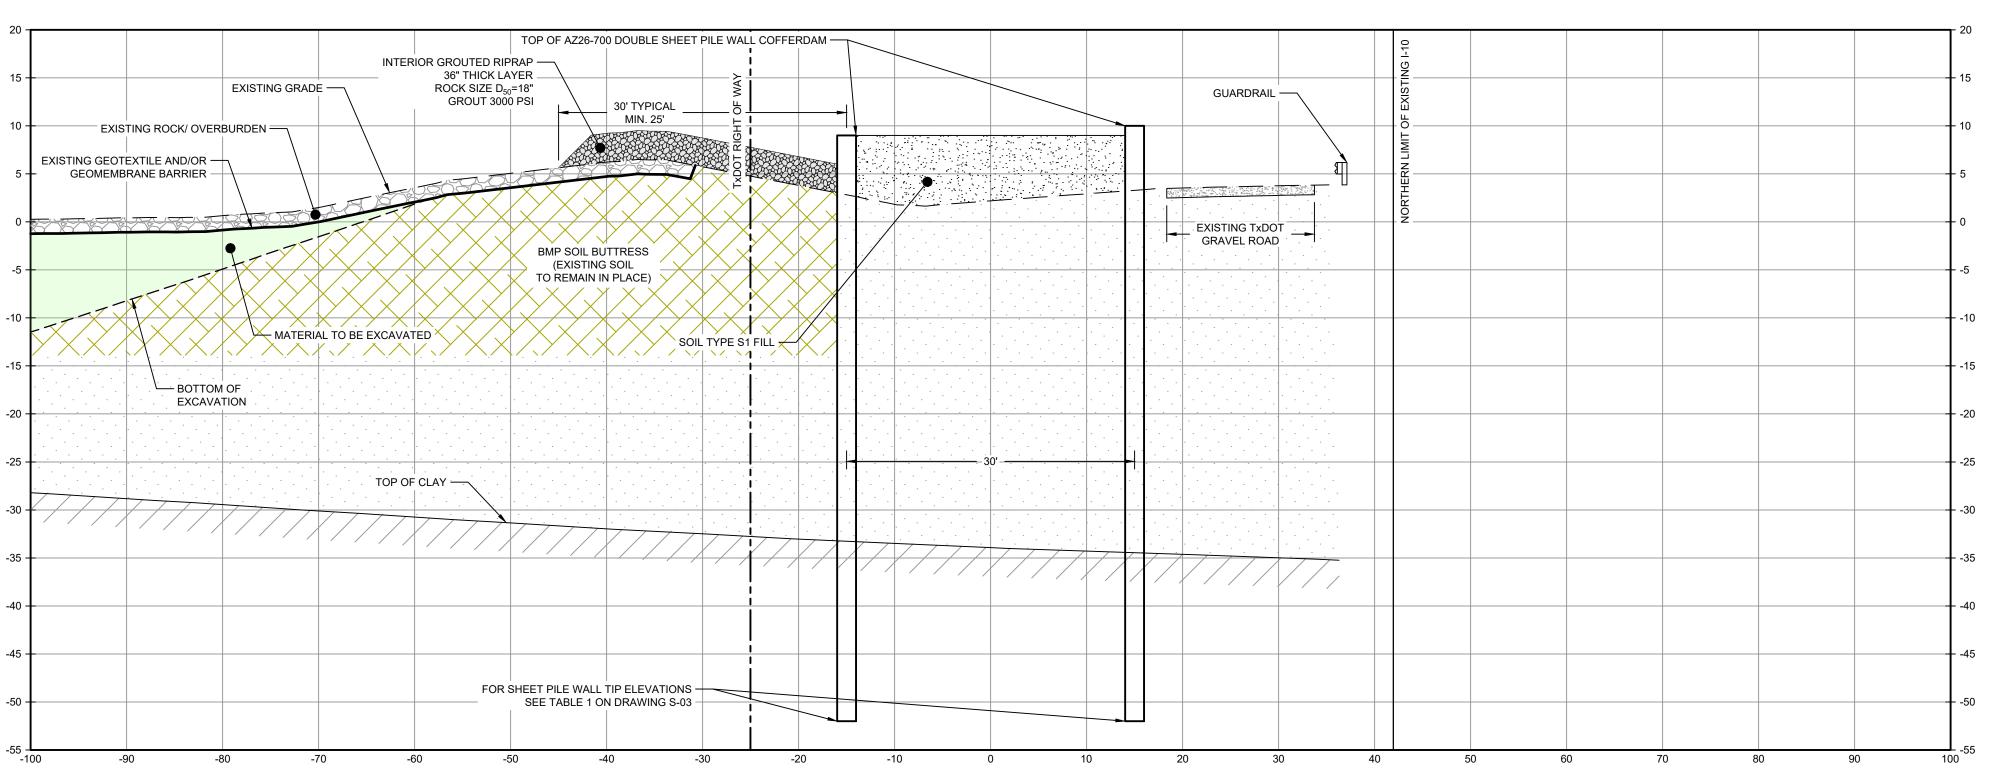

SOURCE:

TXDOT RIGHT OF WAY FROM A BOUNDARY AND RIGHT-OF-WAY SURVEY OF PORT OF HOUSTON AUTHORITY PROPERTY & HOUSTON FLEETING SERVICES, LLC PROPERTY ALONG INTERSTATE HIGHWAY 10 AT THE SAN JACINTO FLEET AREA, IN THE J. T. HARRELL SURVEY, A-330 HARRIS COUNTY, TEXAS, COBBFENDLEY, 2402-028-01, JUNE 28, 2024

NOTES:

1. BOTTOM OF EXCAVATION IS SUBJECT TO CHANGE.

THIS DOCUMENT IS RELEASED FOR THE PURPOSE OF EPA REVIEW UNDER THE AUTHORITY OF CLARENCE R. HOEKSTRA, P.E. 147936 ON 07/17/2024. IT IS NOT TO BE USED FOR CONSTRUCTION, BIDDING, RECORDATION, CONVEYANCE OR SALES PURPOSES.



100% EPA SUBMITTAL




2237 S Acadian Thruway Suite 701 Baton Rouge Louisiana 70808 USA **T** 225 292 9007



Reuse of Documents

This document and the ideas and designs incorporated herein, as an instrument of professional service, is the property of GHD and shall not be reused in whole or in part for any other project without GHD's written authorization. © 2024 GHD

<u>LEGEND</u>

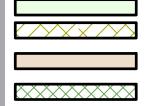

MATERIAL TO BE EXCAVATED BMP SOIL BUTTRESS (EXISTING SOIL TO REMAIN IN PLACE) PLANNED IMPROVEMENTS FOR NORTHERN IMPOUNDMENT ACCESS EXISTING BERM TO BE EXCAVATED FOR POTENTIAL TESTING AND REUSE INTERIOR SCOUR PROTECTION

Client

SAN JACINTO RIVER WASTE PITS

NORTHERN IMPOUNDMENT FINAL 100% REMEDIAL DESIGN HARRIS COUNTY, TEXAS

3	100% EPA SUBMITTAL	MW	CRH	07/17/20
No.	Issue	Drawn	Approved	Date
Draw	n MW	Designer	RH	
Drafting JC Check		Design Check	LL	
Proje Coor	ct dinator	Date	Jul 16, 20	24

This document shall not be used for construction unless signed and sealed for Scale 1" = 10'

Original Size

original size drawing Arch D 0 1"


Bar is one inch on


Project No. **11215702**

SOUTH WALL SECTIONS 2 OF 3

Sheet No.

C-43

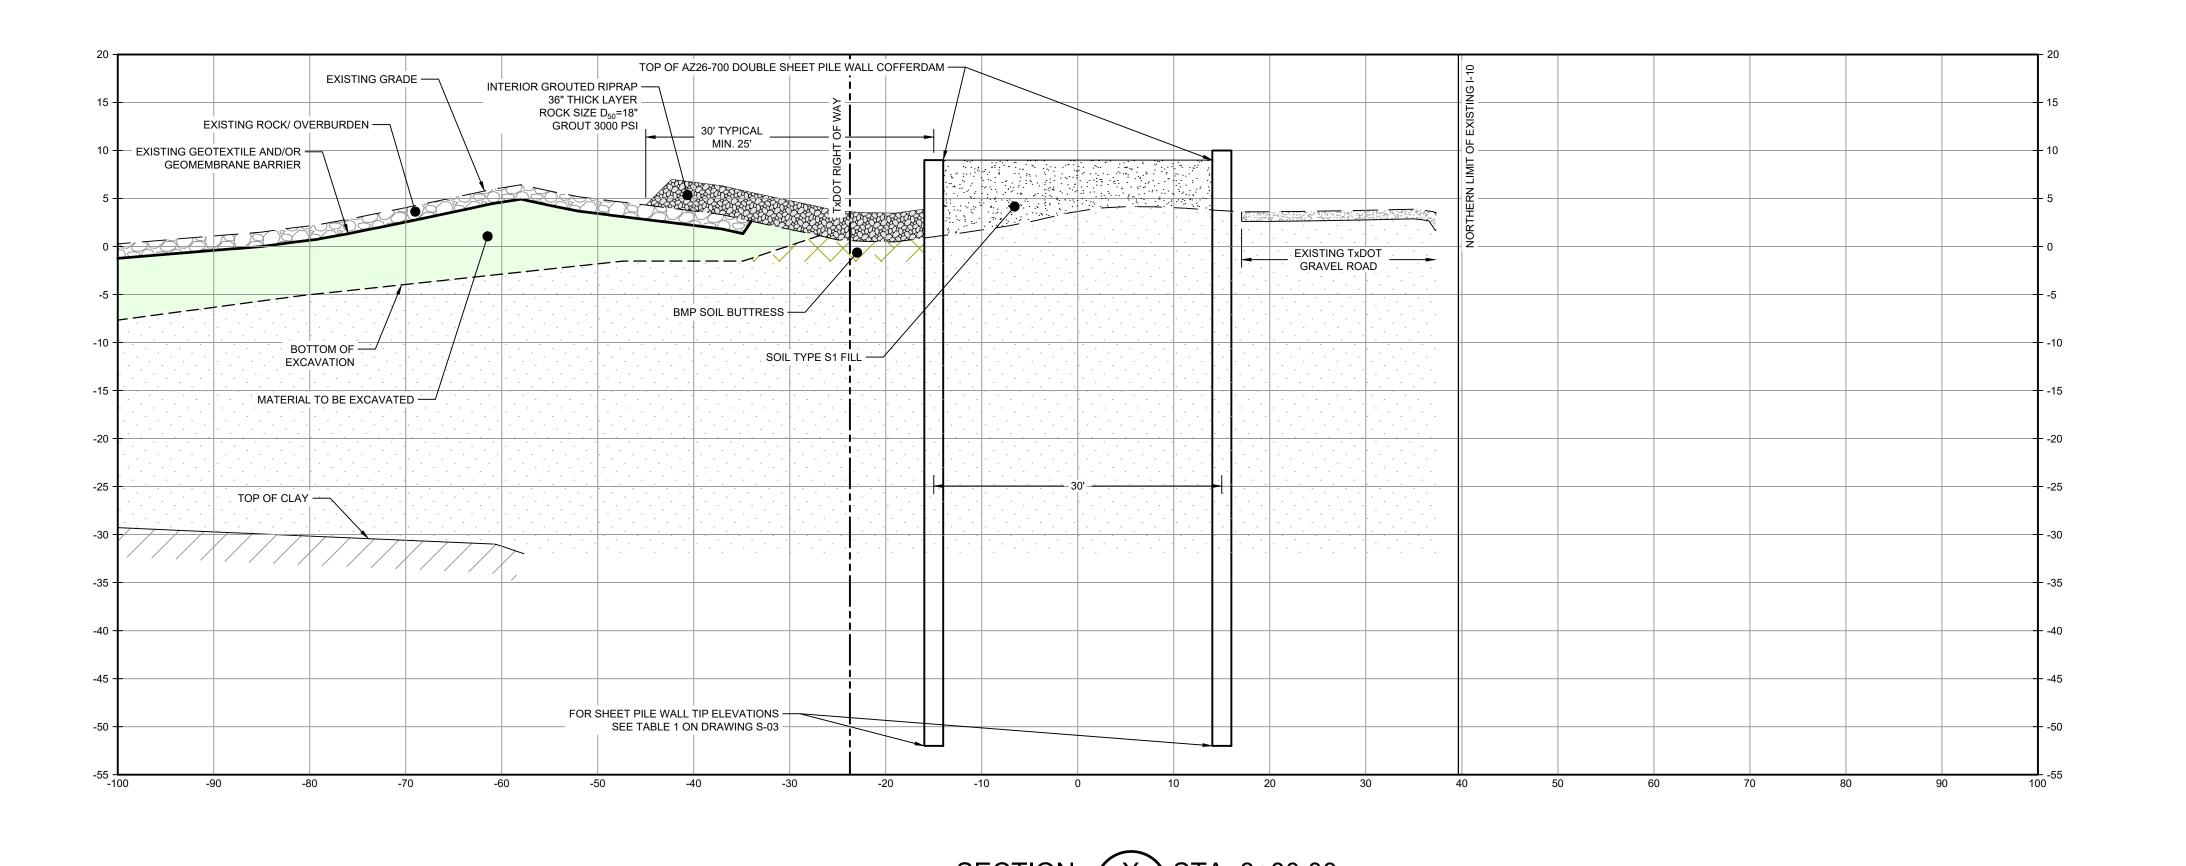

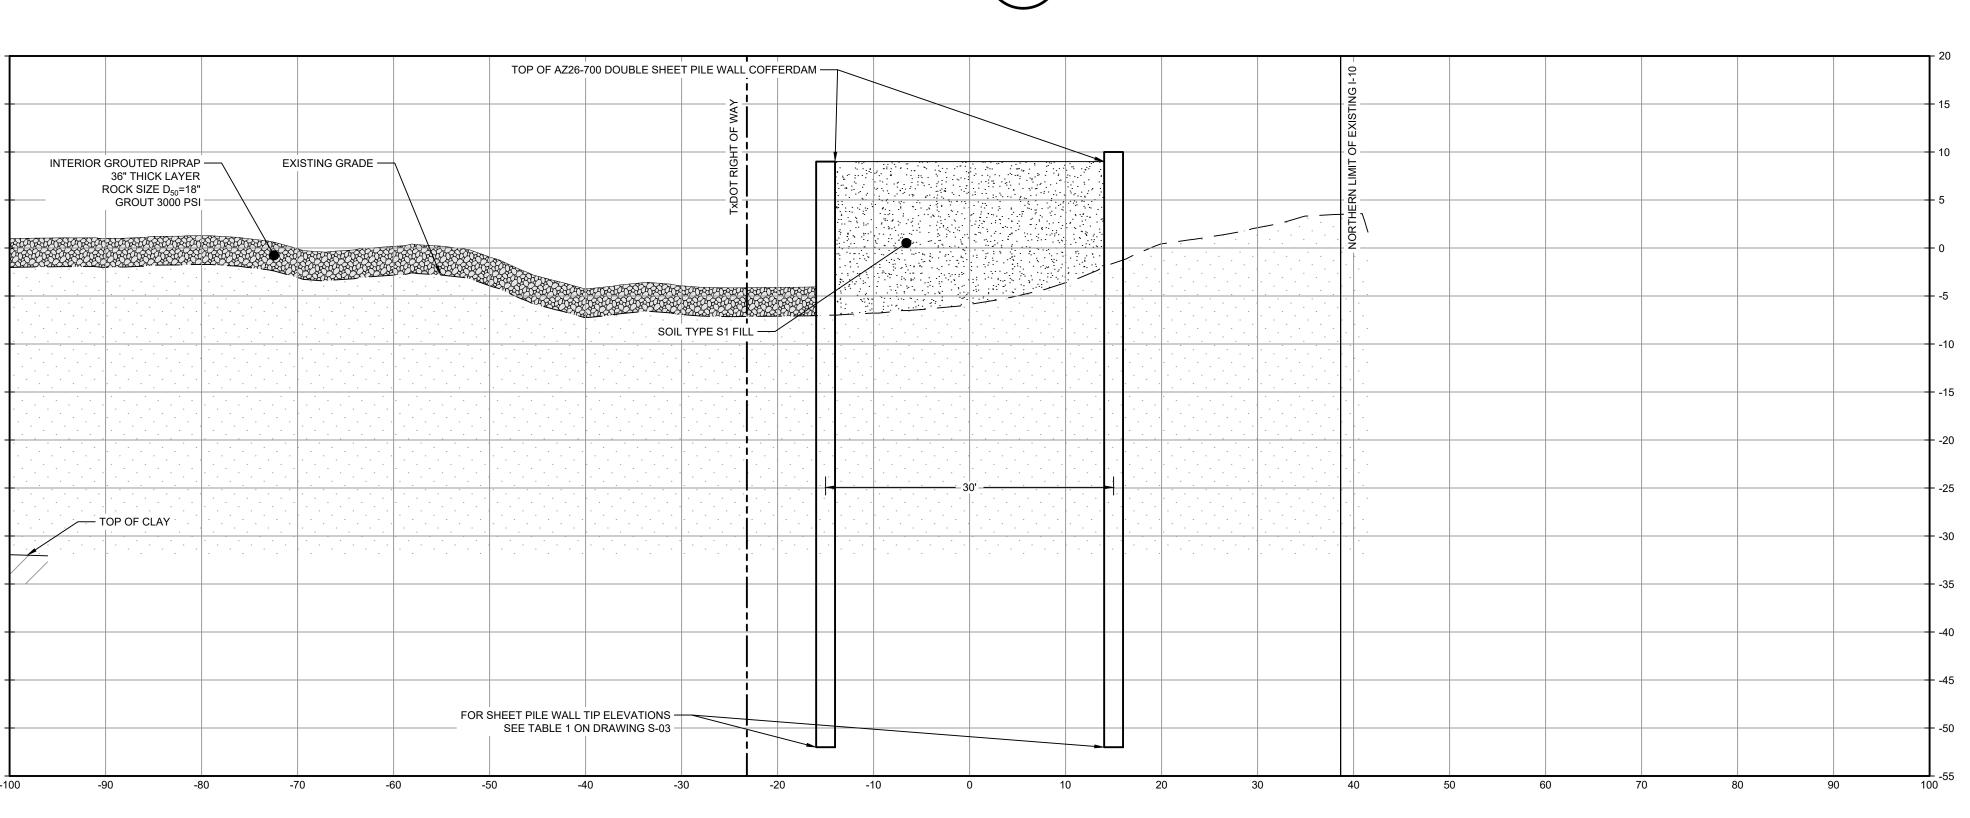

SOURCE:

TXDOT RIGHT OF WAY FROM A BOUNDARY AND RIGHT-OF-WAY SURVEY OF PORT OF HOUSTON AUTHORITY PROPERTY & HOUSTON FLEETING SERVICES, LLC PROPERTY ALONG INTERSTATE HIGHWAY 10 AT THE SAN JACINTO FLEET AREA, IN THE J. T. HARRELL SURVEY, A-330 HARRIS COUNTY, TEXAS, COBBFENDLEY, 2402-028-01, JUNE 28, 2024

NOTES:

1. BOTTOM OF EXCAVATION IS SUBJECT TO CHANGE.

THIS DOCUMENT IS RELEASED FOR THE PURPOSE OF EPA REVIEW UNDER THE AUTHORITY OF CLARENCE R. HOEKSTRA, P.E. 147936 ON 07/17/2024. IT IS NOT TO BE USED FOR CONSTRUCTION, BIDDING, RECORDATION, CONVEYANCE OR SALES PURPOSES.



100% EPA SUBMITTAL




2237 S Acadian Thruway Suite 701 Baton Rouge Louisiana 70808 USA **T** 225 292 9007



Reuse of Documents

This document and the ideas and designs incorporated herein, as an instrument of professional service, is the property of GHD and shall not be reused in whole or in part for any other project without GHD's written authorization. © 2024 GHD

<u>LEGEND</u>

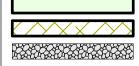

MATERIAL TO BE EXCAVATED BMP SOIL BUTTRESS (EXISTING SOIL TO REMAIN IN PLACE) INTERIOR SCOUR PROTECTION

SAN JACINTO RIVER WASTE PITS

NORTHERN IMPOUNDMENT FINAL 100% REMEDIAL DESIGN HARRIS COUNTY, TEXAS

3	100% EPA SUBMITTAL	MW	CRH	07/17
No.	Issue	Drawn	Approved	Da
Draw	n MW	Designer	RH	
Drafti Chec	· .II.	Design Check	LL	
Proje Coor	ct dinator CM	Date	Jul 16, 20	24
	document shall not be used for uction unless signed and sealed for	Scale	1" = 10'	

Original Size Bar is one inch on original size drawing Arch D

Project No. **11215702**

SOUTH WALL SECTIONS 3 OF 3

Sheet No.


C-44


Sheet - of -


Plot Date: 17 July 2024 - 12:59 PM


Plotted By: Jonathan Compton


Filename: \\ghd\net\ghd\US\Baton Rouge\Projects\562\11215702\Digital_Design\ACAD 2019\Sheets\11215702-01-DWG-C-035.dwg

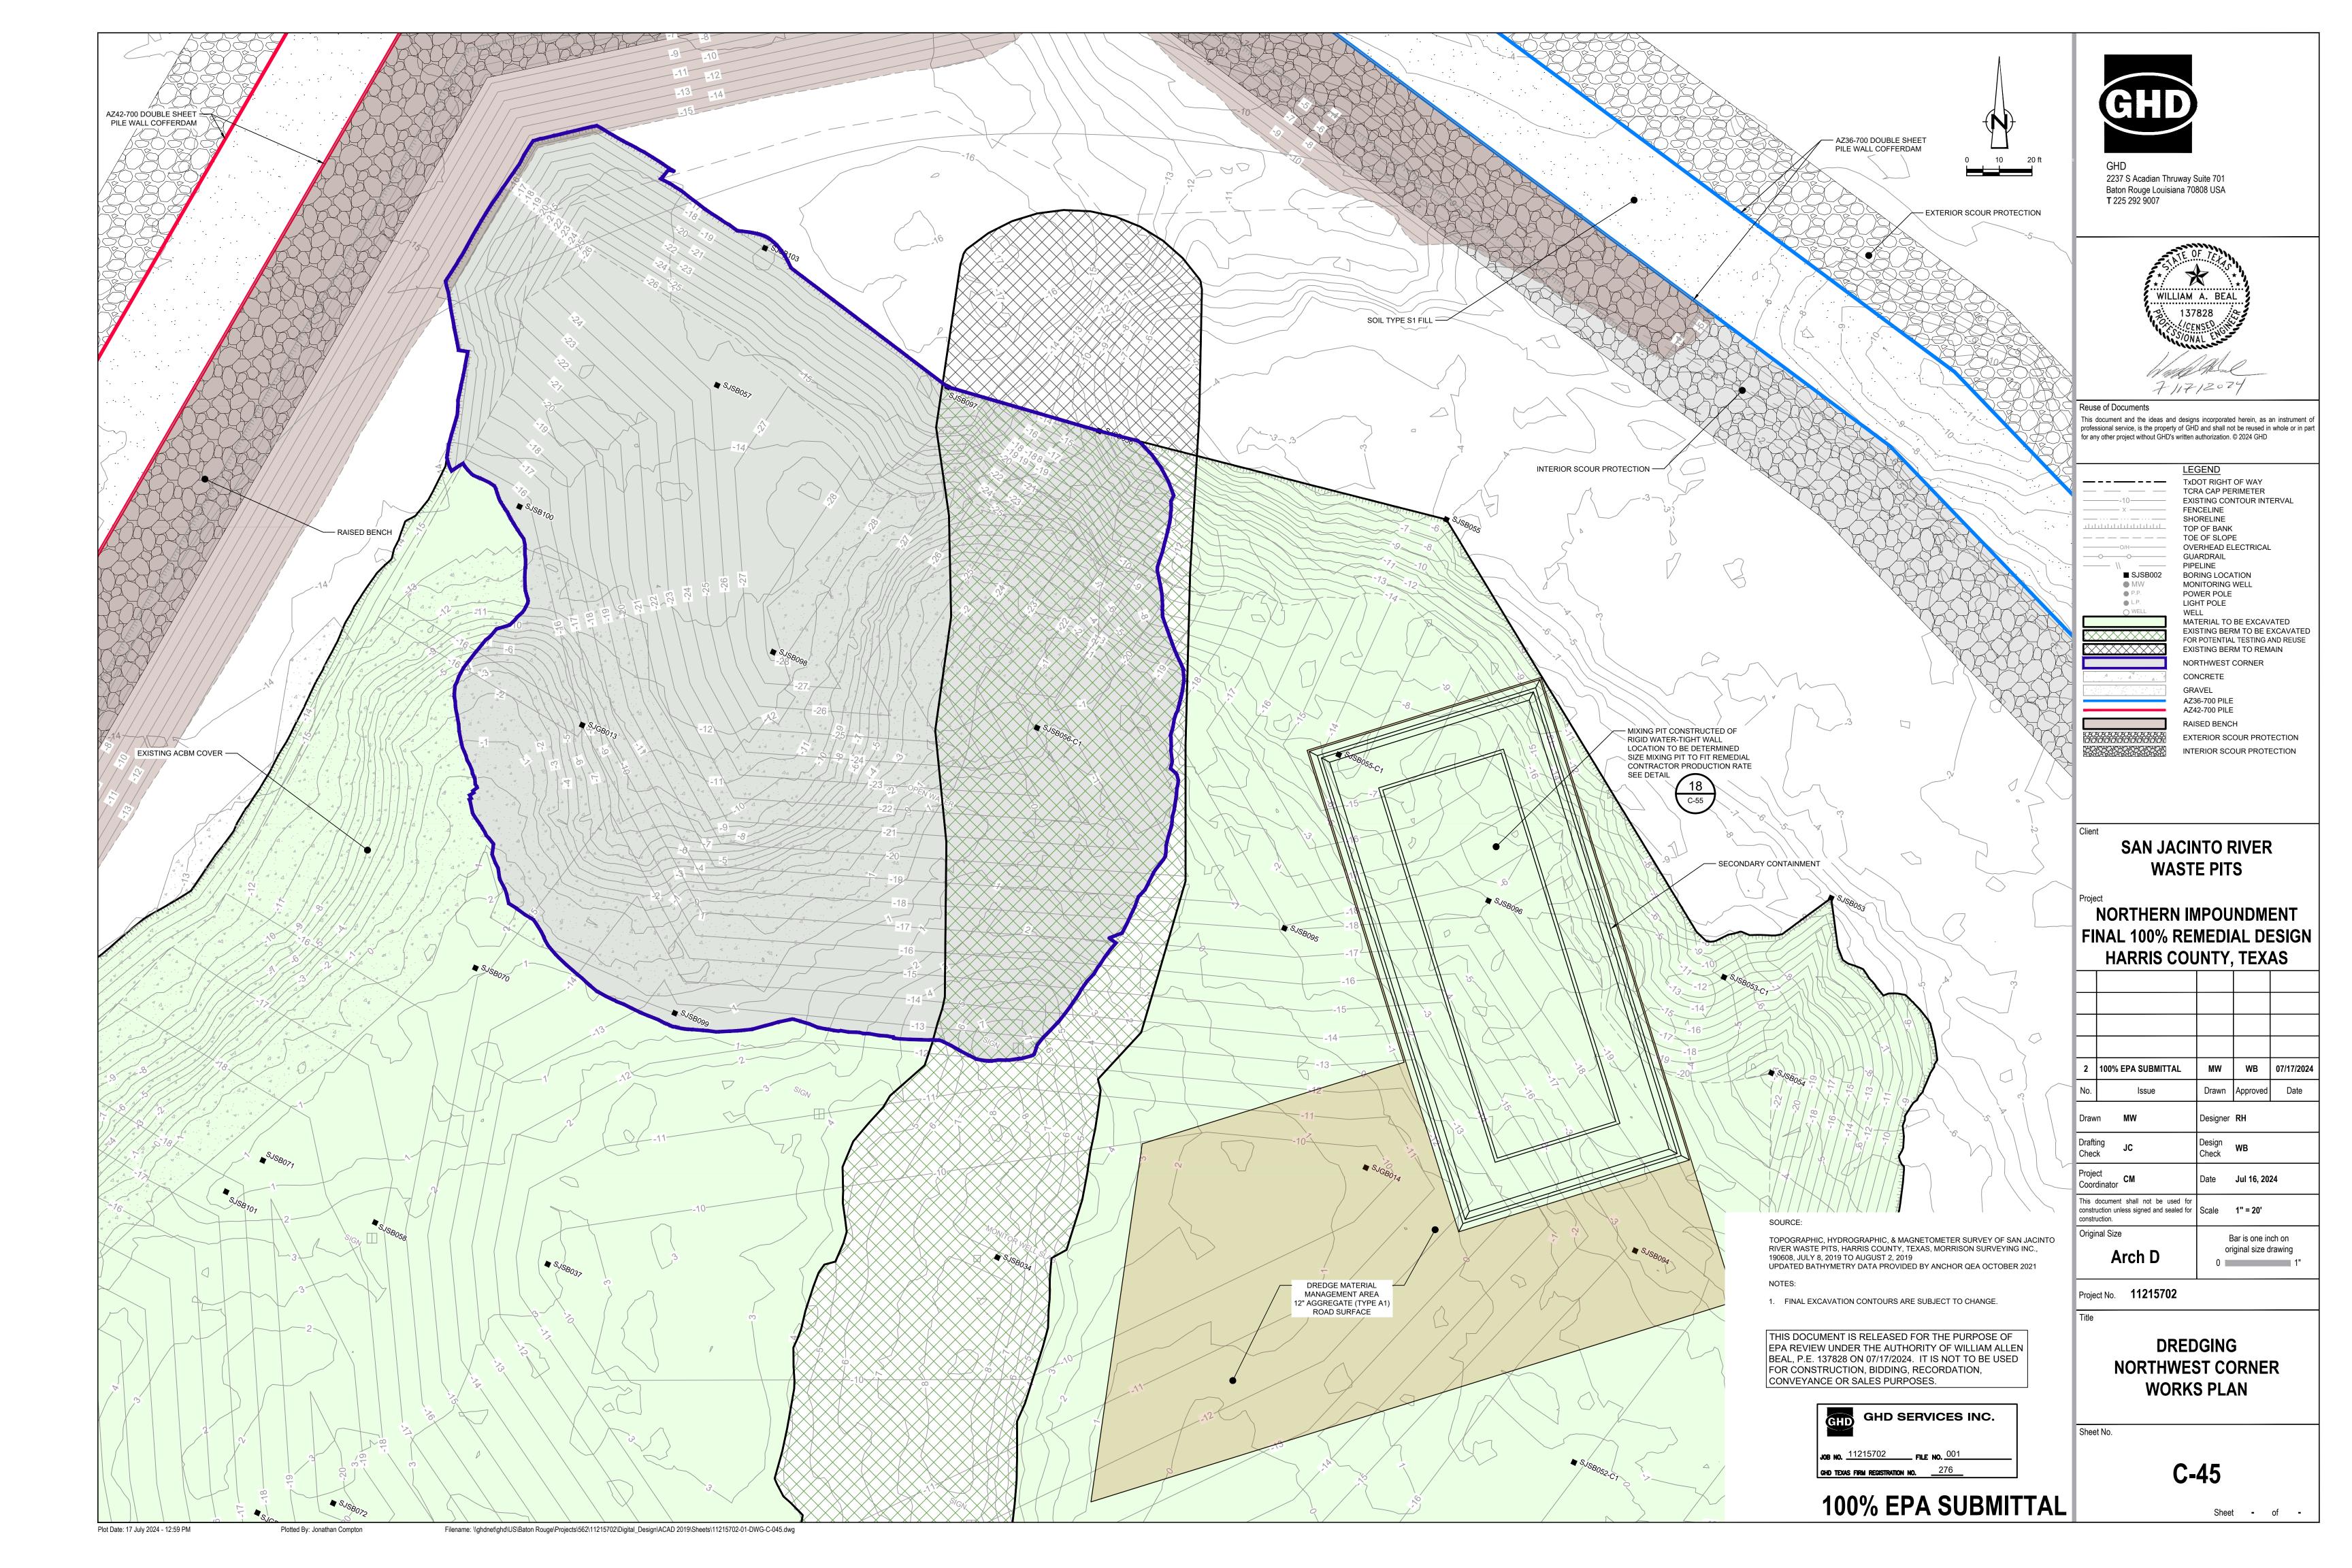

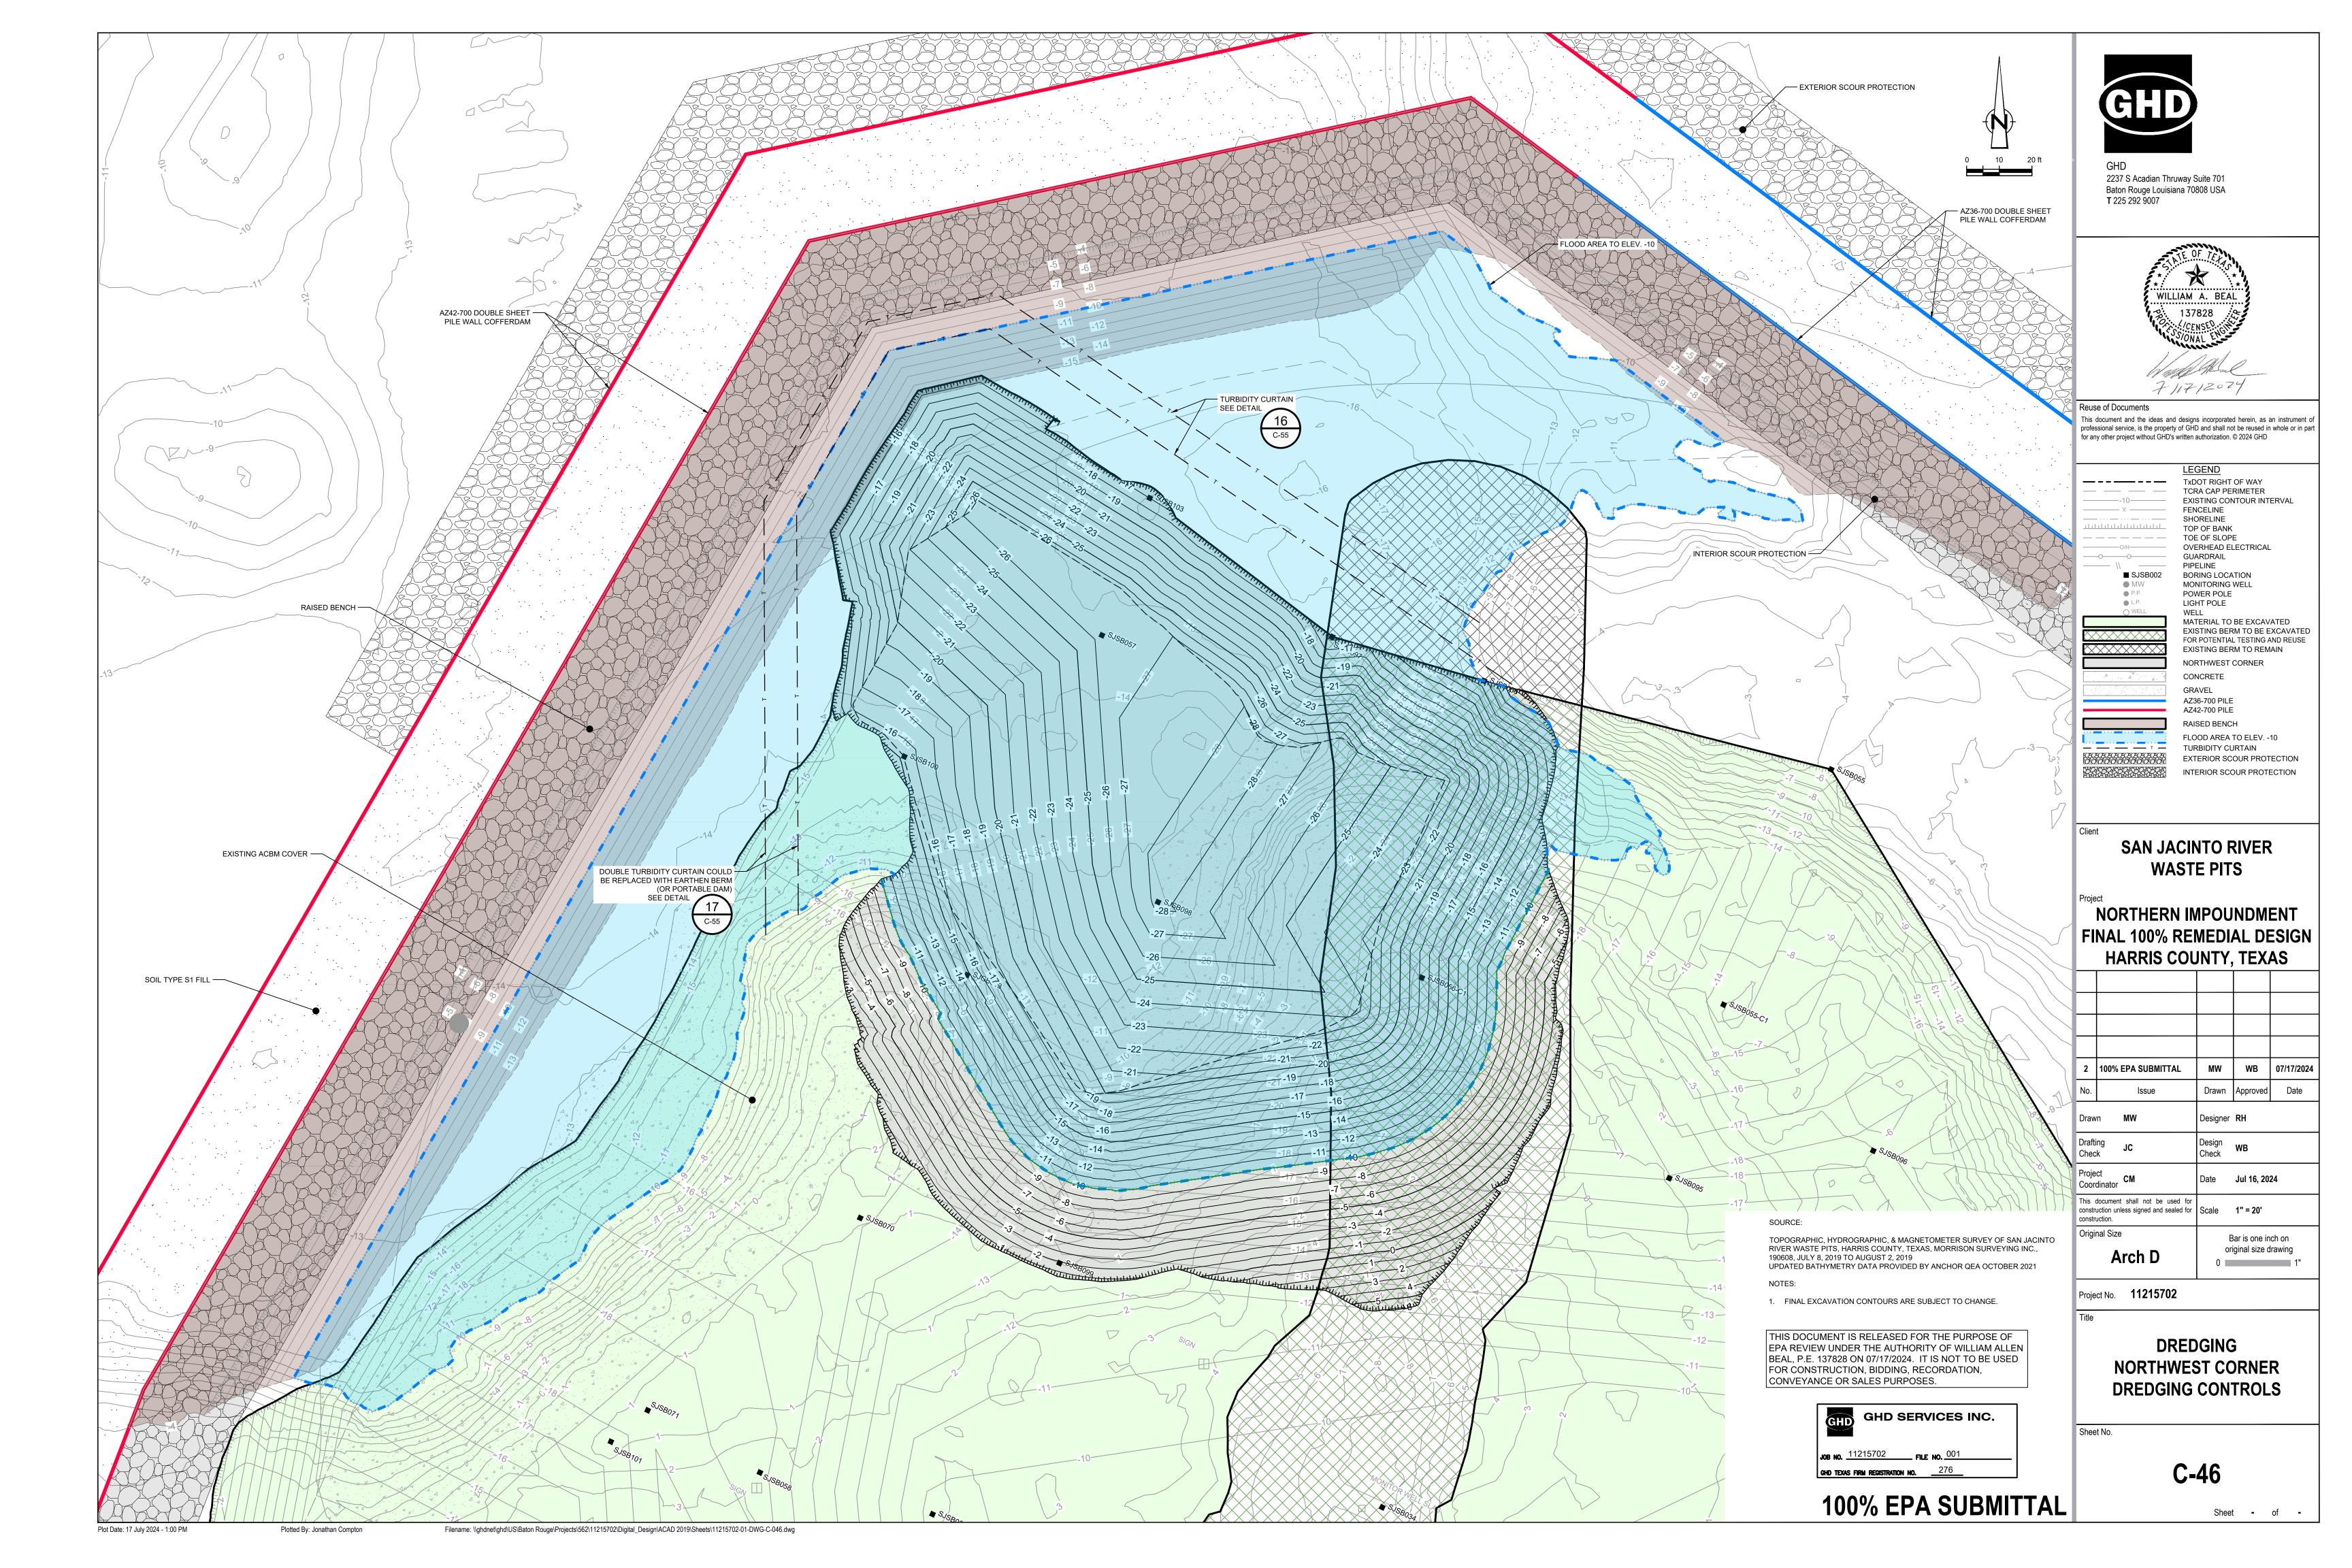

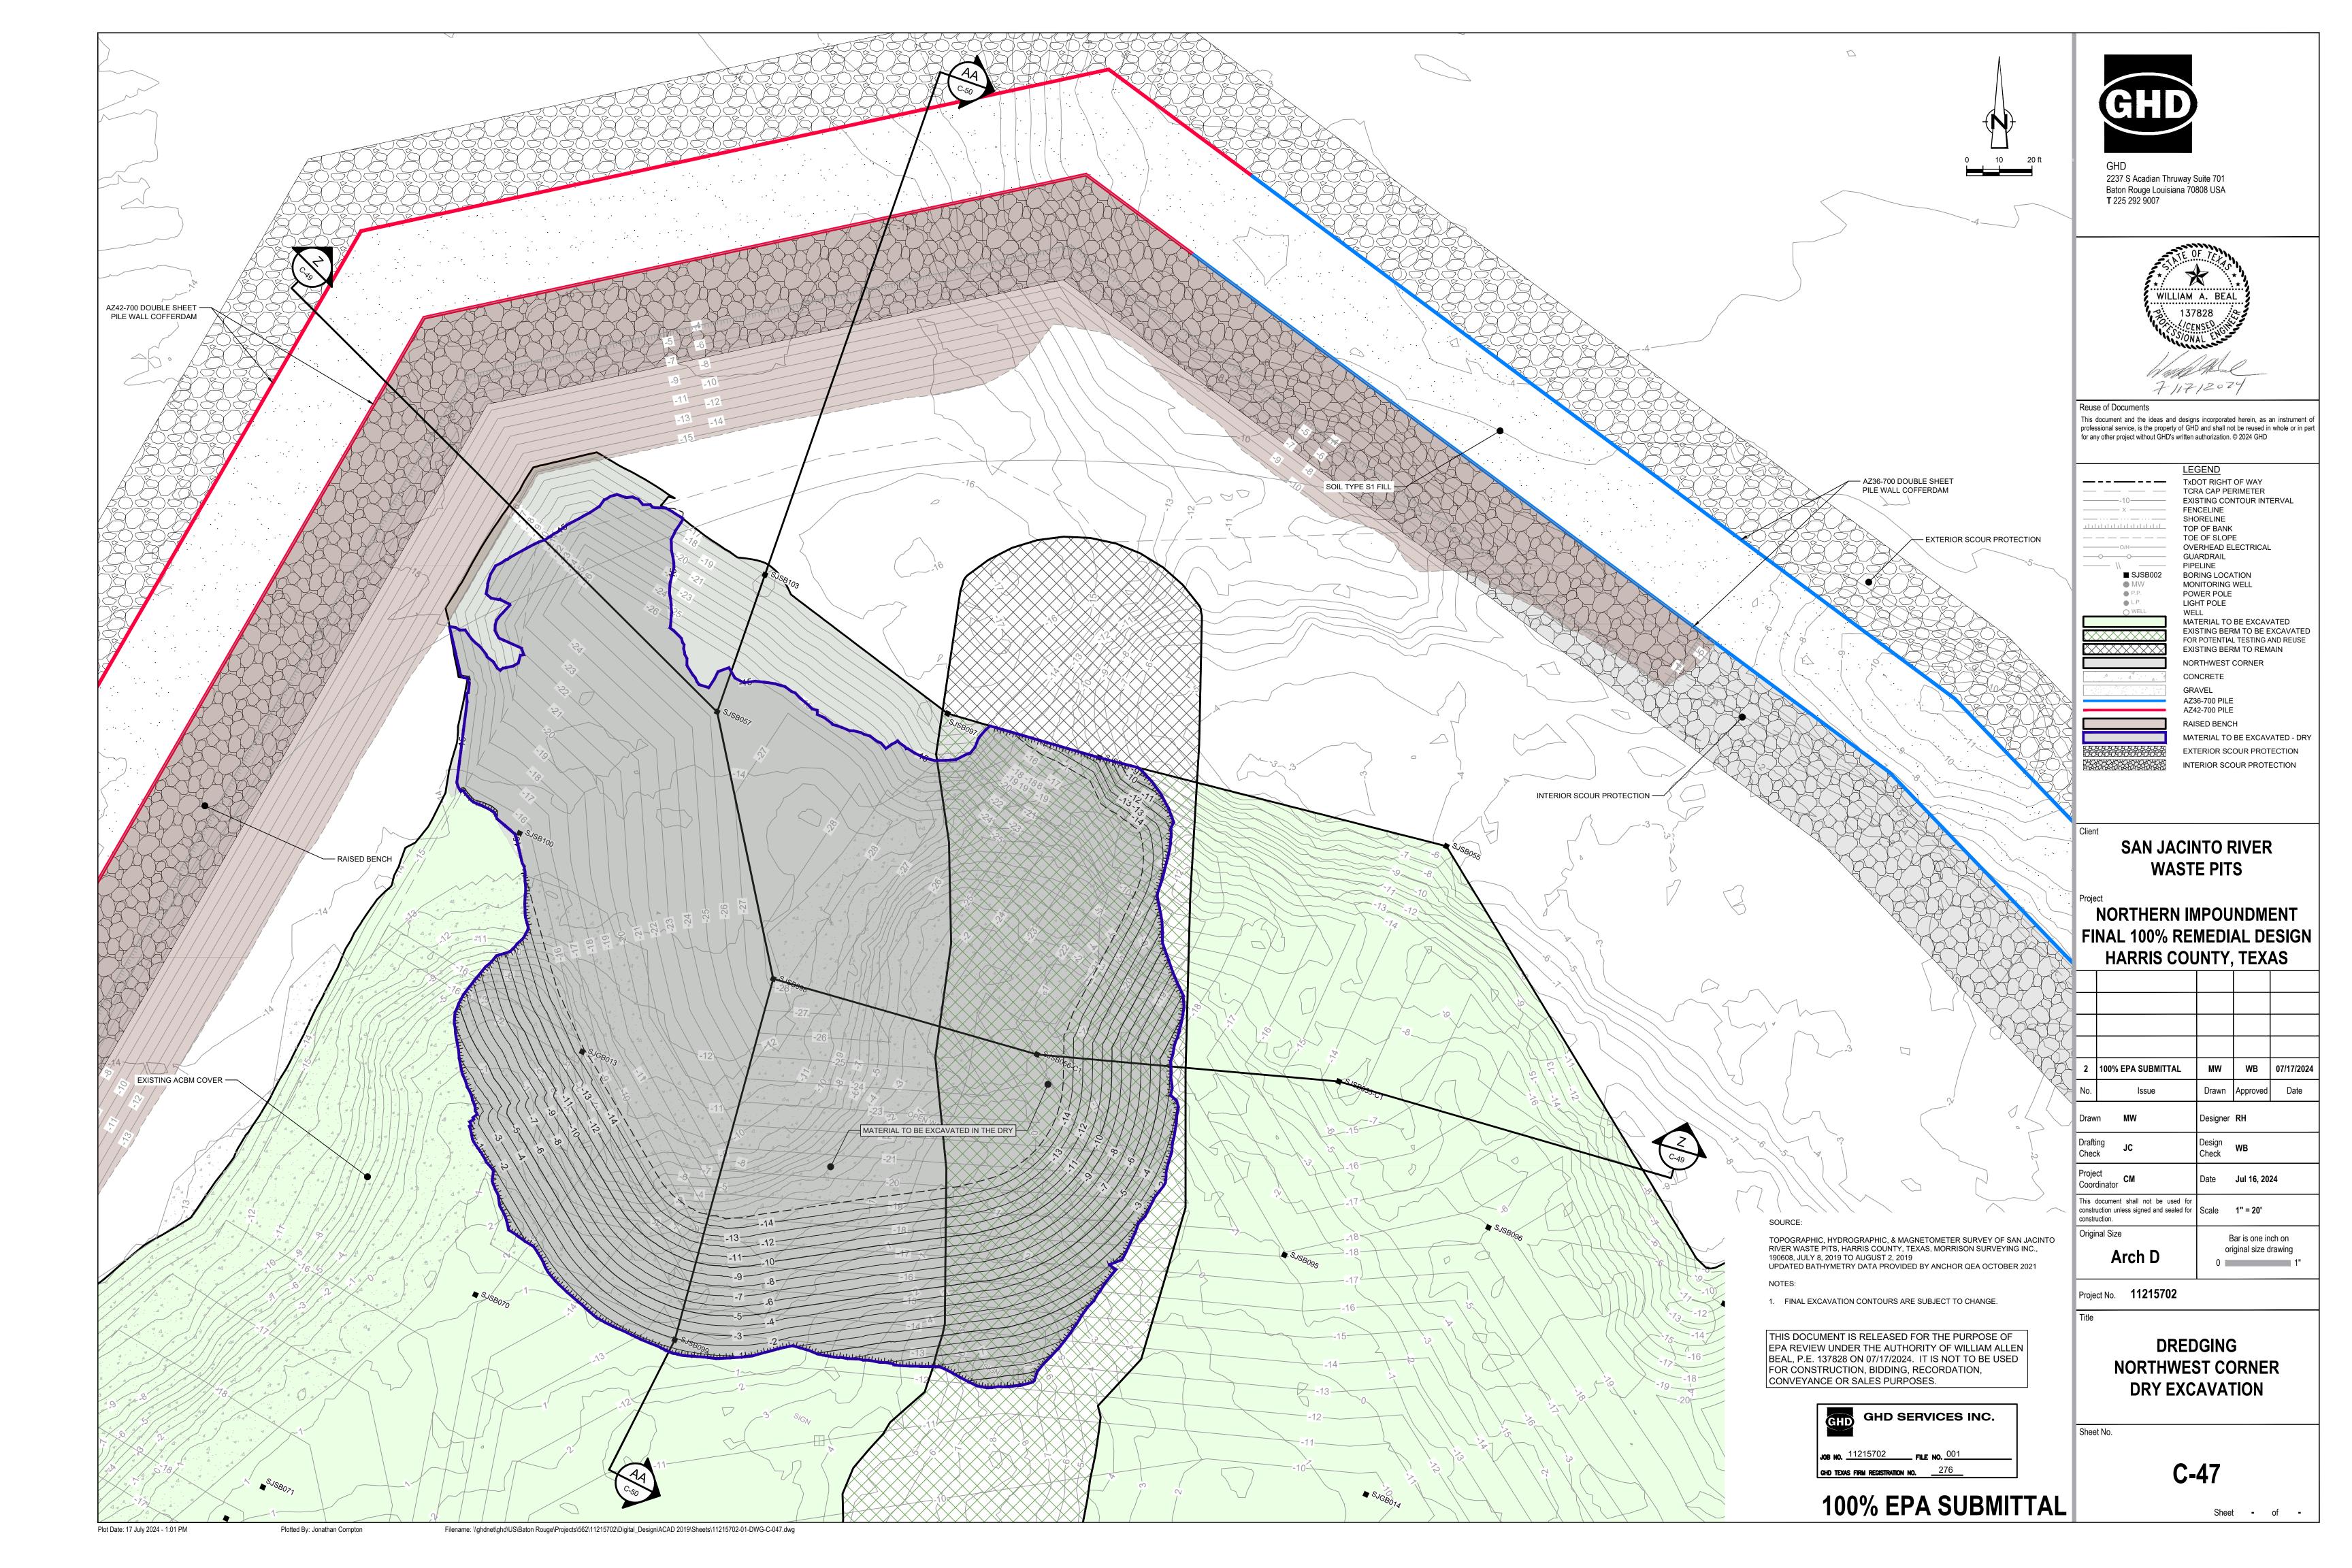

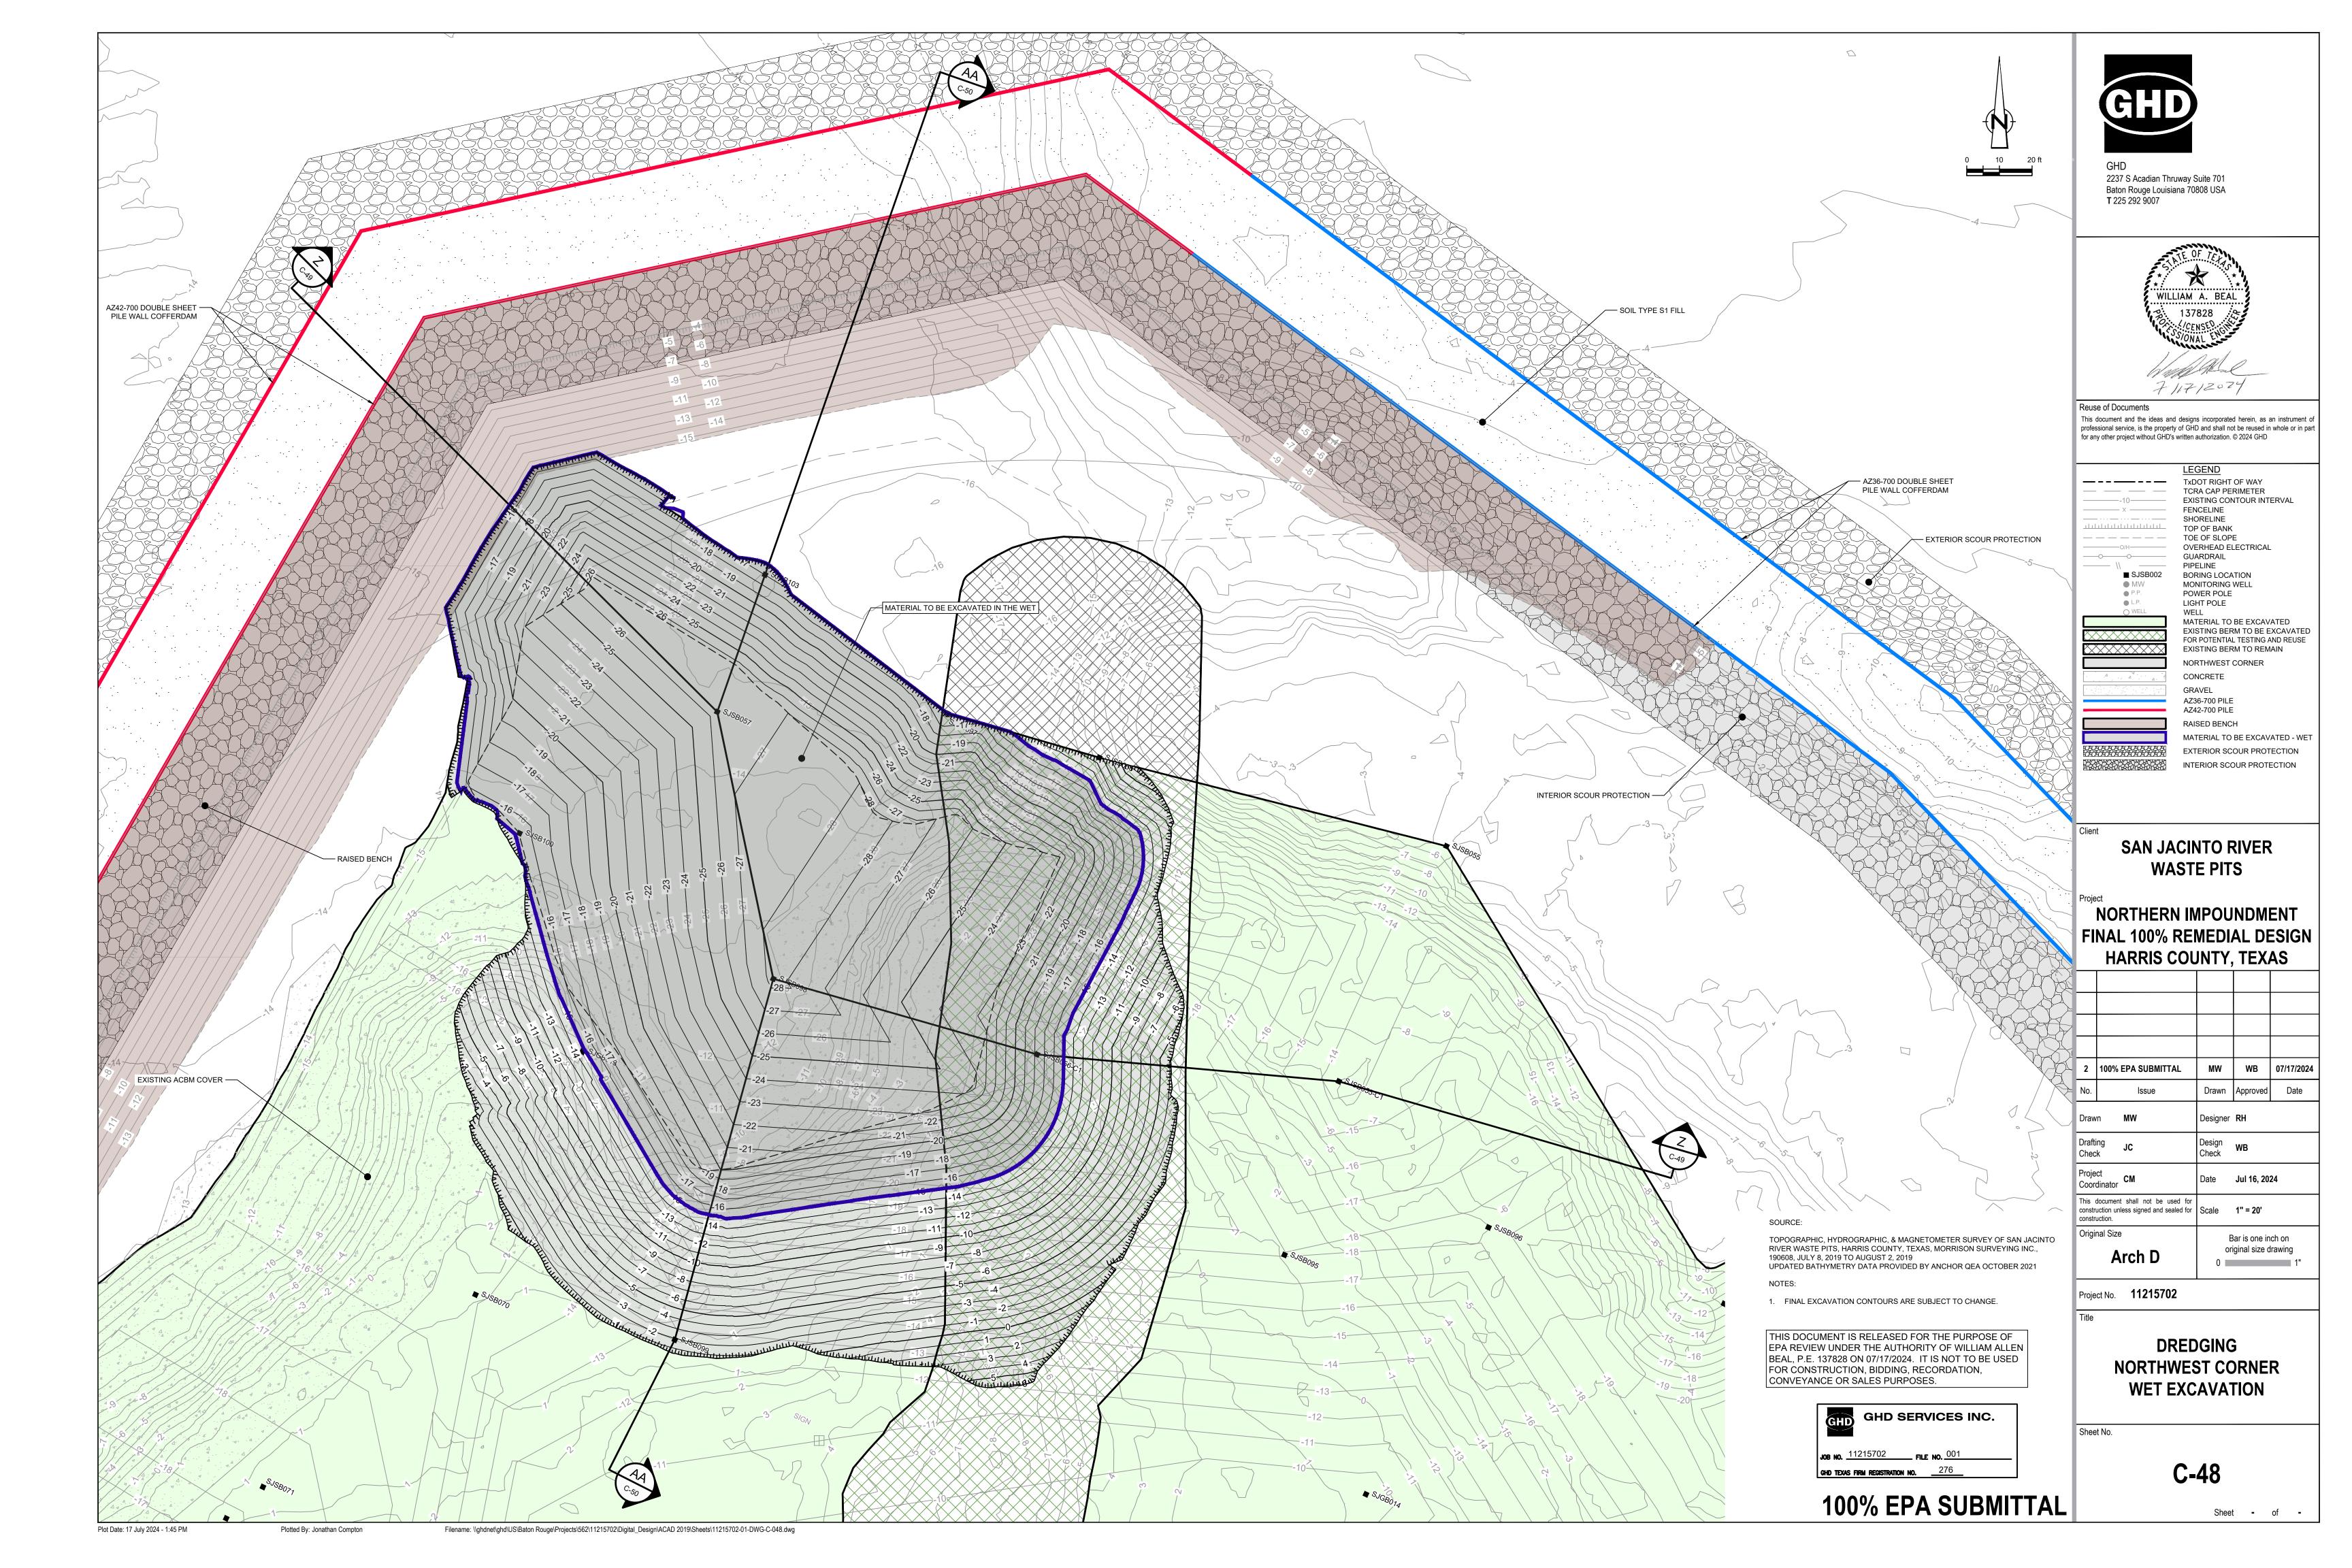

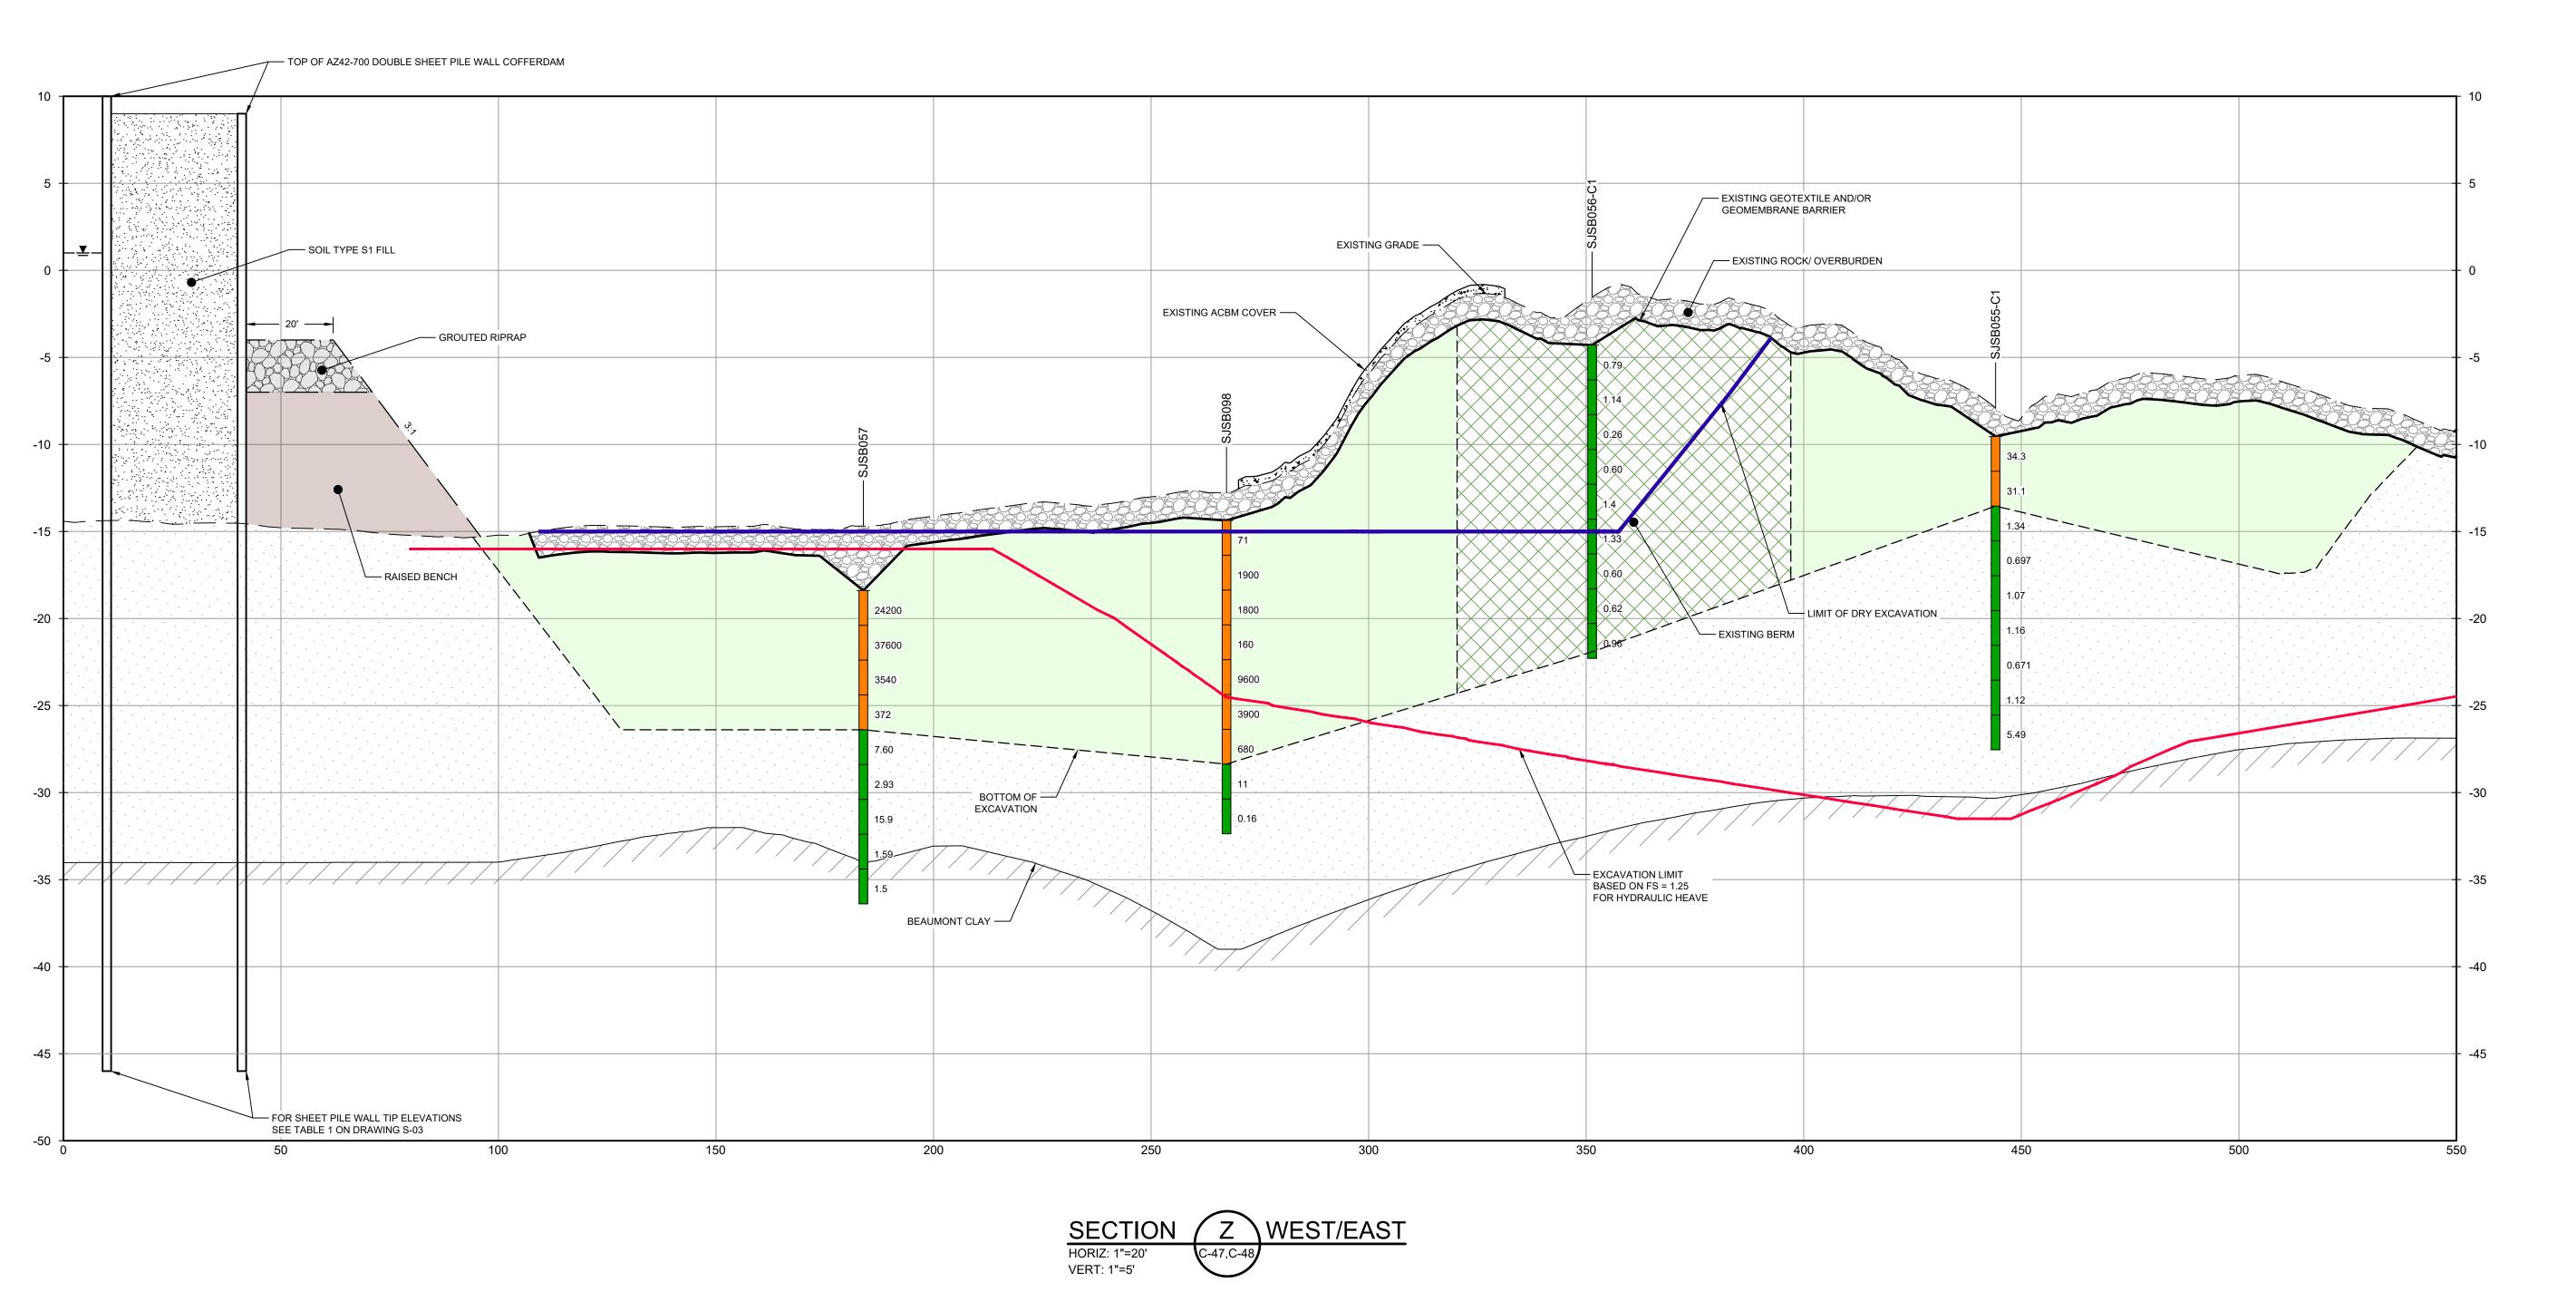

 BOTTOM OF EXCAVATION IS SUBJECT TO CHANGE.
 SCOUR PROTECTION ON INTERIOR AND EXTERIOR SIDE OF COFFERDAM NOT SHOWN. SEE DRAWINGS C-28 TO C-44 FOR LIMITS OF RIPRAP.


THIS DOCUMENT IS RELEASED FOR THE PURPOSE OF EPA REVIEW UNDER THE AUTHORITY OF WILLIAM ALLEN BEAL, P.E. 137828 ON 07/17/2024. IT IS NOT TO BE USED FOR CONSTRUCTION, BIDDING, RECORDATION, CONVEYANCE OR SALES PURPOSES.



100% EPA SUBMITTAL



2237 S Acadian Thruway Suite 701 Baton Rouge Louisiana 70808 USA **T** 225 292 9007

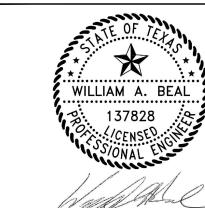

Reuse of Documents

This document and the ideas and designs incorporated herein, as an instrument of professional service, is the property of GHD and shall not be reused in whole or in part for any other project without GHD's written authorization. © 2024 GHD


SOILS WITH CONCENTRATIONS <30 ng/kg $TEQ_{DF,M}$ TCDD

SOILS WITH CONCENTRATIONS >30 ng/kg TEQ_{DF,M} TCDD EXCAVATION LIMIT BASED ON FS = 1.25 FOR HYDRAULIC HEAVE MATERIAL TO BE EXCAVATED

EXISTING BERM TO BE EXCAVATED FOR POTENTIAL TESTING AND REUSE

SAN JACINTO RIVER WASTE PITS

NORTHERN IMPOUNDMENT FINAL 100% REMEDIAL DESIGN HARRIS COUNTY, TEXAS

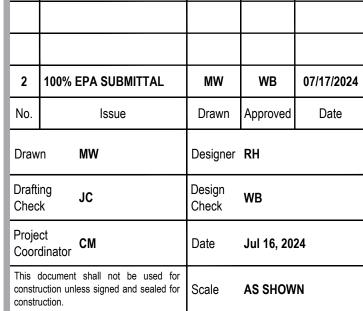

Original Size Arch D

Project No. **11215702**


DREDGING NORTHWEST CORNER SECTIONS 1 OF 2

Sheet No.

C-49


Sheet - of -

Bar is one inch on original size drawing

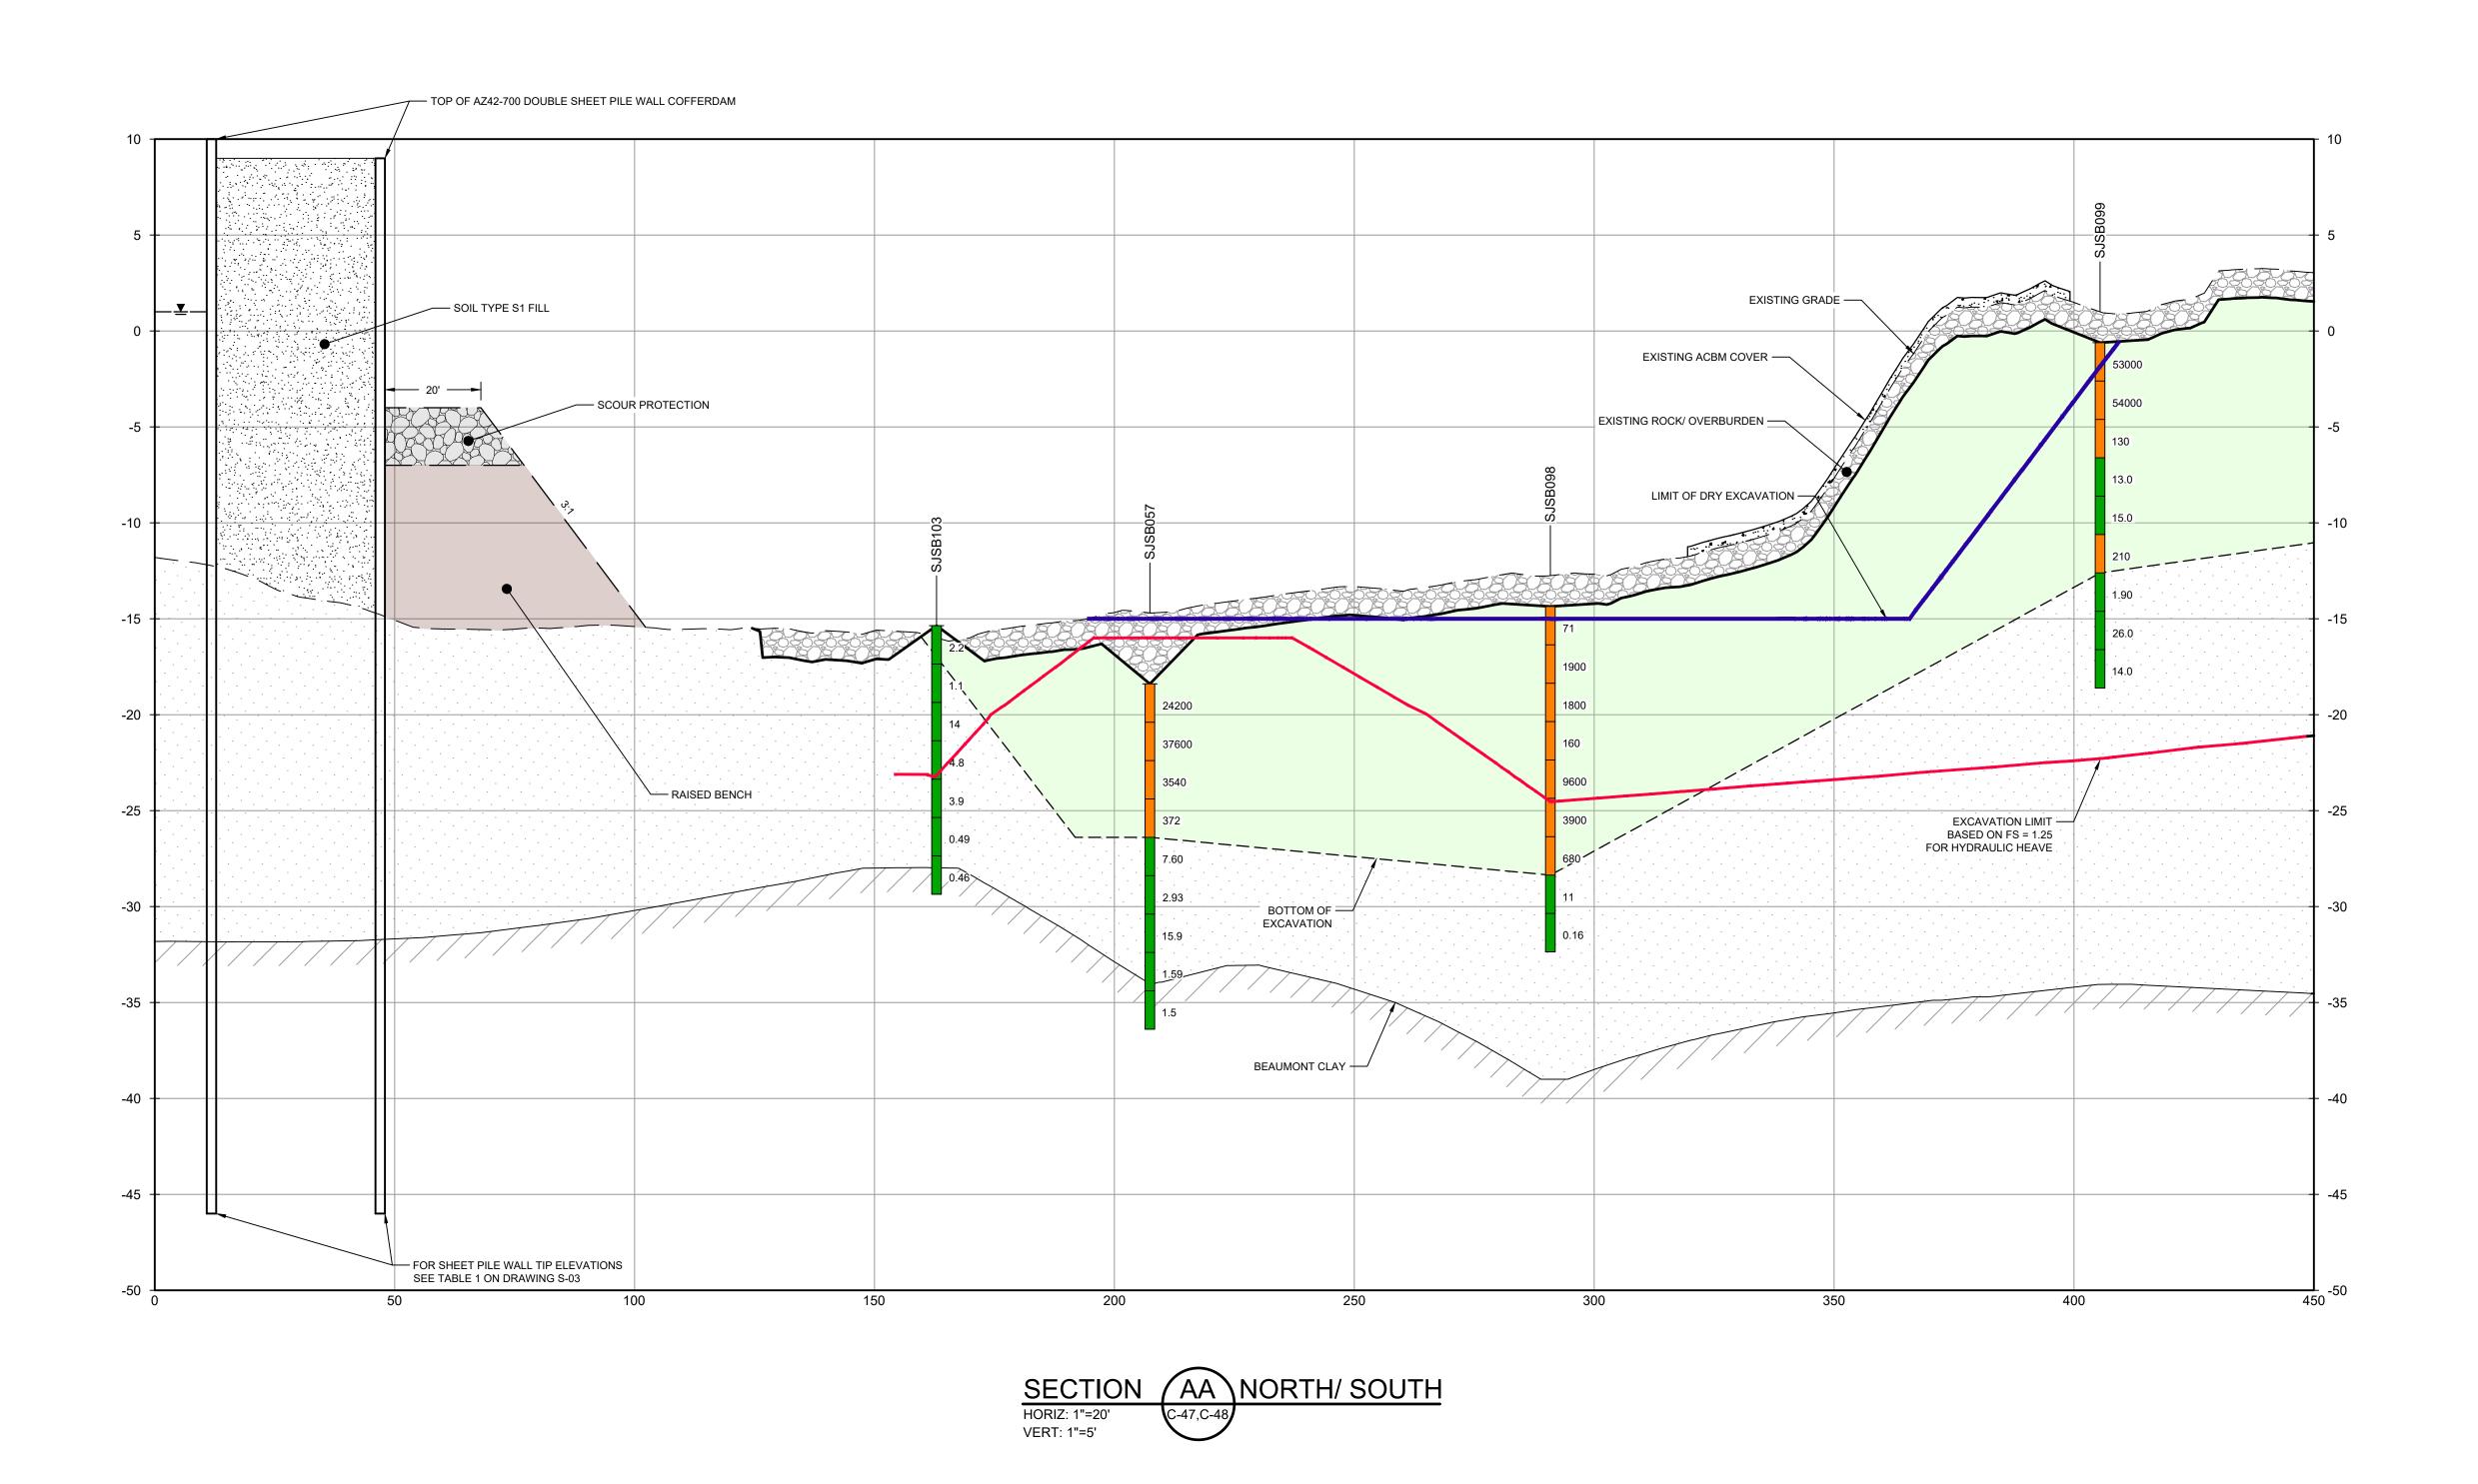

 BOTTOM OF EXCAVATION IS SUBJECT TO CHANGE.
 SCOUR PROTECTION ON INTERIOR AND EXTERIOR SIDE OF COFFERDAM NOT SHOWN. SEE DRAWINGS C-28 TO C-44 FOR LIMITS OF RIPRAP.

THIS DOCUMENT IS RELEASED FOR THE PURPOSE OF EPA REVIEW UNDER THE AUTHORITY OF WILLIAM ALLEN BEAL, P.E. 137828 ON 07/17/2024. IT IS NOT TO BE USED FOR CONSTRUCTION, BIDDING, RECORDATION, CONVEYANCE OR SALES PURPOSES.

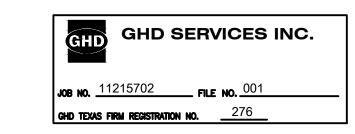

100% EPA SUBMITTAL



GHD
2237 S Acadian Thruway Suite 701
Baton Rouge Louisiana 70808 USA
T 225 292 9007



Reuse of Documents

This document and the ideas and designs incorporated herein, as an instrument of professional service, is the property of GHD and shall not be reused in whole or in part for any other project without GHD's written authorization. © 2024 GHD

SOILS WITH CONCENTRATIONS
<30 ng/kg TEQ_{DF,M} TCDD

SO <30 SO >30

SOILS WITH CONCENTRATIONS
>30 ng/kg TEQ_{DF,M} TCDD

EXCAVATION LIMIT BASED ON
FS = 1.25 FOR HYDRAULIC HEAVE
MATERIAL TO BE EXCAVATED

EXISTING BERM TO BE EXCAVATED
FOR POTENTIAL TESTING AND REUSE

SAN JACINTO RIVER
WASTE PITS

NORTHERN IMPOUNDMENT FINAL 100% REMEDIAL DESIGN HARRIS COUNTY, TEXAS

2 100% EPA SUBMITTAL MW WB 07/17/2024

No. Issue Drawn Approved Date

Drawn MW Designer RH

Drafting Check JC Design Check WB

This document shall not be used for construction unless signed and sealed for construction.

Original Size

Bar is one inch or construction described as a sealed for construction.

Project Coordinator CM

Arch D

Bar is one inch on original size drawing

0 11

Date **Jul 16, 2024**

Project No. **11215702**

Title

DREDGING
NORTHWEST CORNER
SECTIONS 2 OF 2

Sheet No.


C-50


Sheet - of -

Plot Date: 17 July 2024 - 1:02 PM

Plotted By: Jonathan Compton

Filename: \\ghdnet\ghd\US\Baton Rouge\Projects\562\11215702\Digital_Design\ACAD 2019\Sheets\11215702-01-DWG-C-049.dwg

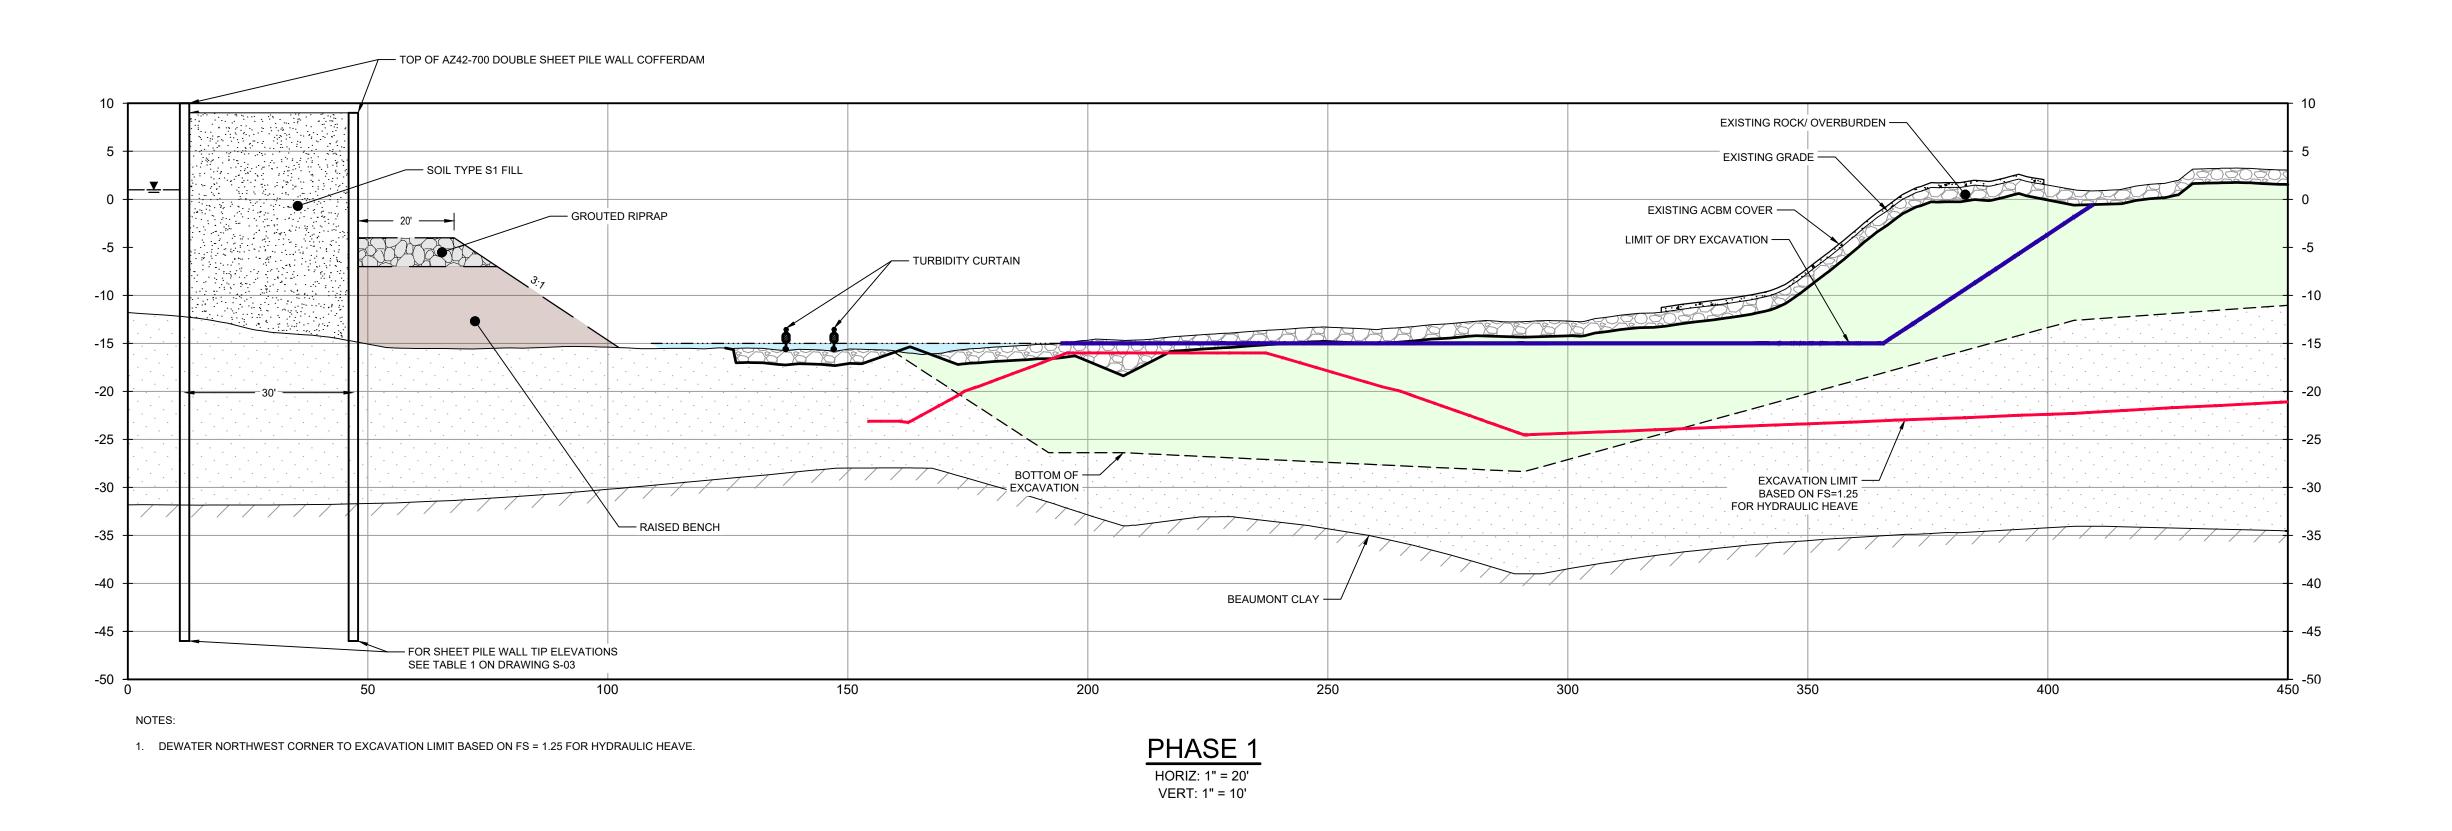

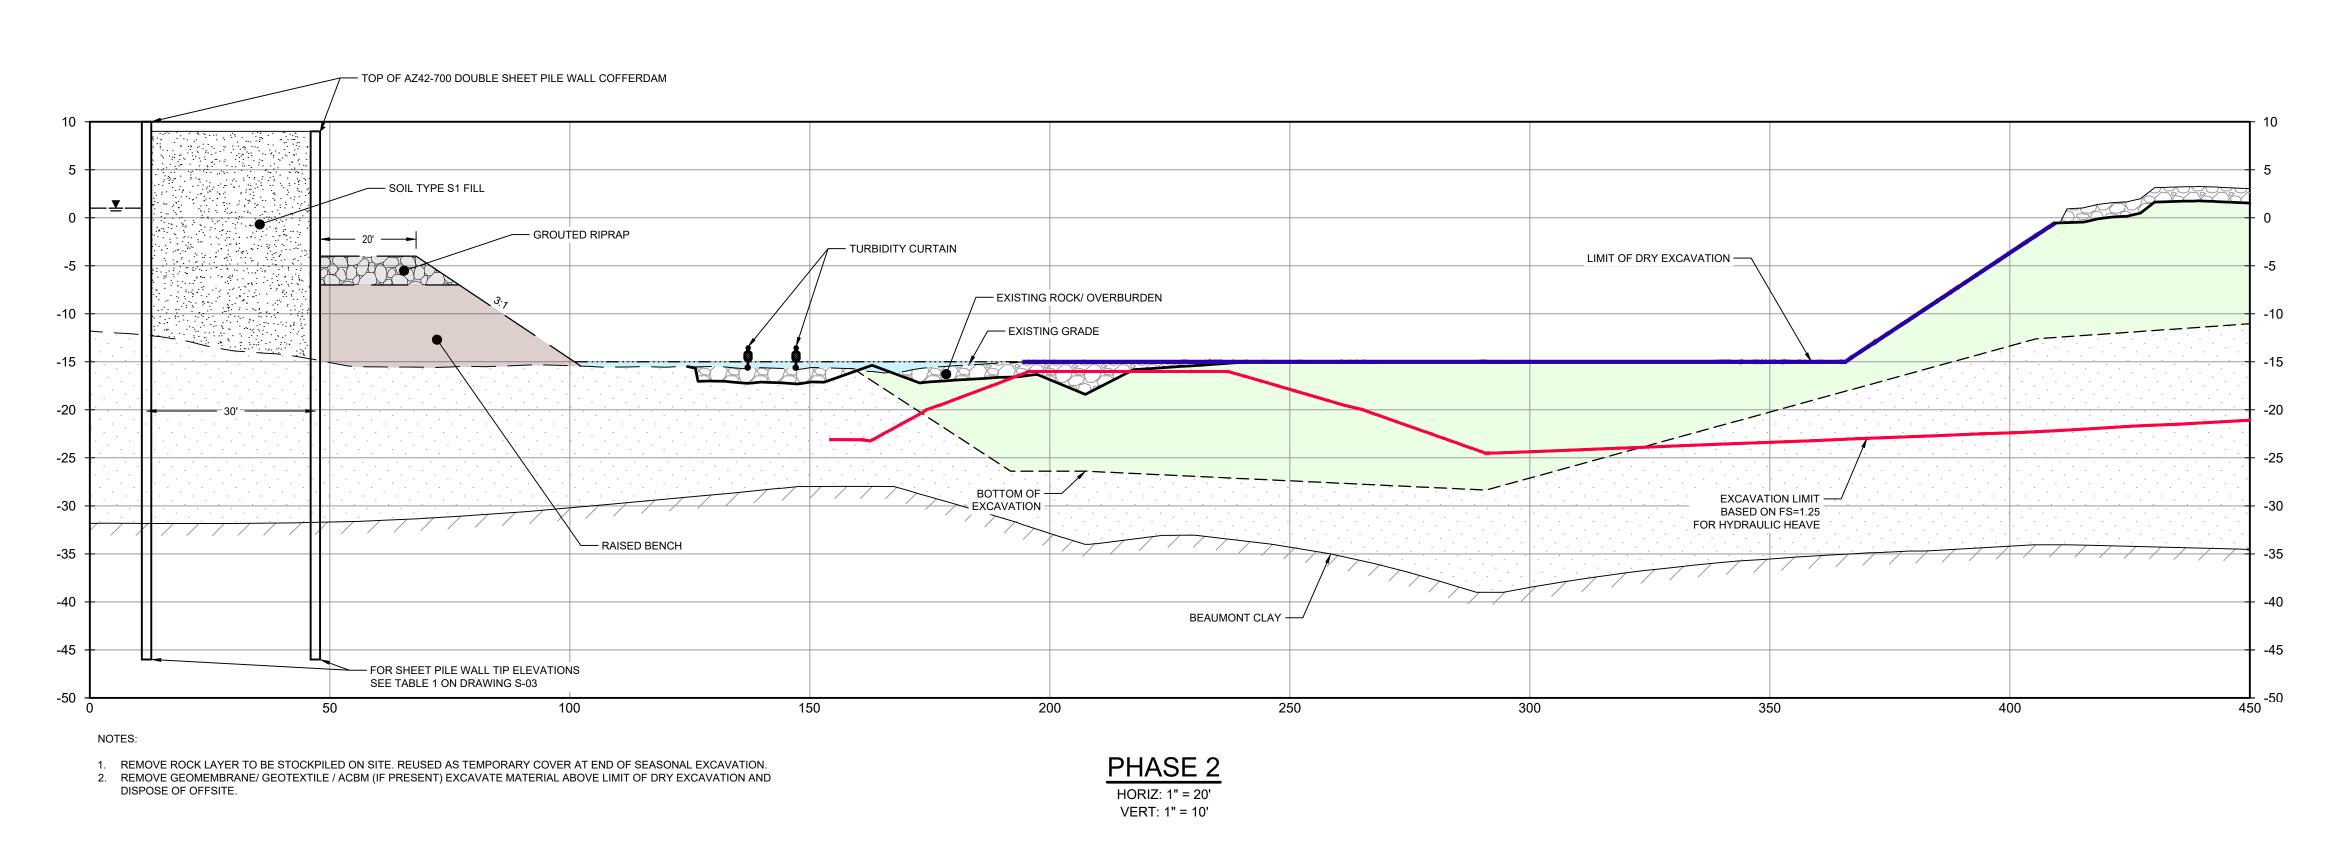

 BOTTOM OF EXCAVATION IS SUBJECT TO CHANGE.
 SCOUR PROTECTION ON INTERIOR AND EXTERIOR SIDE OF COFFERDAM NOT SHOWN. SEE DRAWINGS C-28 TO C-44 FOR LIMITS OF RIPRAP.


THIS DOCUMENT IS RELEASED FOR THE PURPOSE OF EPA REVIEW UNDER THE AUTHORITY OF WILLIAM ALLEN BEAL, P.E. 137828 ON 07/17/2024. IT IS NOT TO BE USED FOR CONSTRUCTION, BIDDING, RECORDATION, CONVEYANCE OR SALES PURPOSES.



100% EPA SUBMITTAL



2237 S Acadian Thruway Suite 701 Baton Rouge Louisiana 70808 USA **T** 225 292 9007

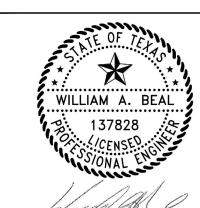


Reuse of Documents This document and the ideas and designs incorporated herein, as an instrument of professional service, is the property of GHD and shall not be reused in whole or in part for any other project without GHD's written authorization. © 2024 GHD

<u>LEGEND</u>

EXCAVATION LIMIT BASED ON FS = 1.25 FOR HYDRAULIC HEAVE MATERIAL TO BE EXCAVATED

SAN JACINTO RIVER WASTE PITS

NORTHERN IMPOUNDMENT FINAL 100% REMEDIAL DESIGN HARRIS COUNTY, TEXAS

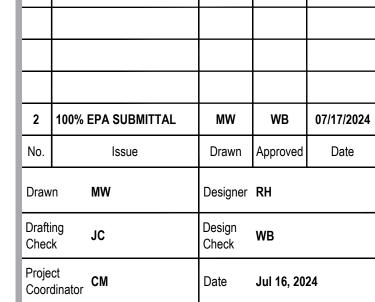

Original Size Bar is one inch on original size drawing Arch D


This document shall not be used for construction unless signed and sealed for Scale AS SHOWN


Project No. **11215702**

DREDGING NORTHWEST CORNER **SEQUENCING 1 OF 3**

Sheet No.

C-51

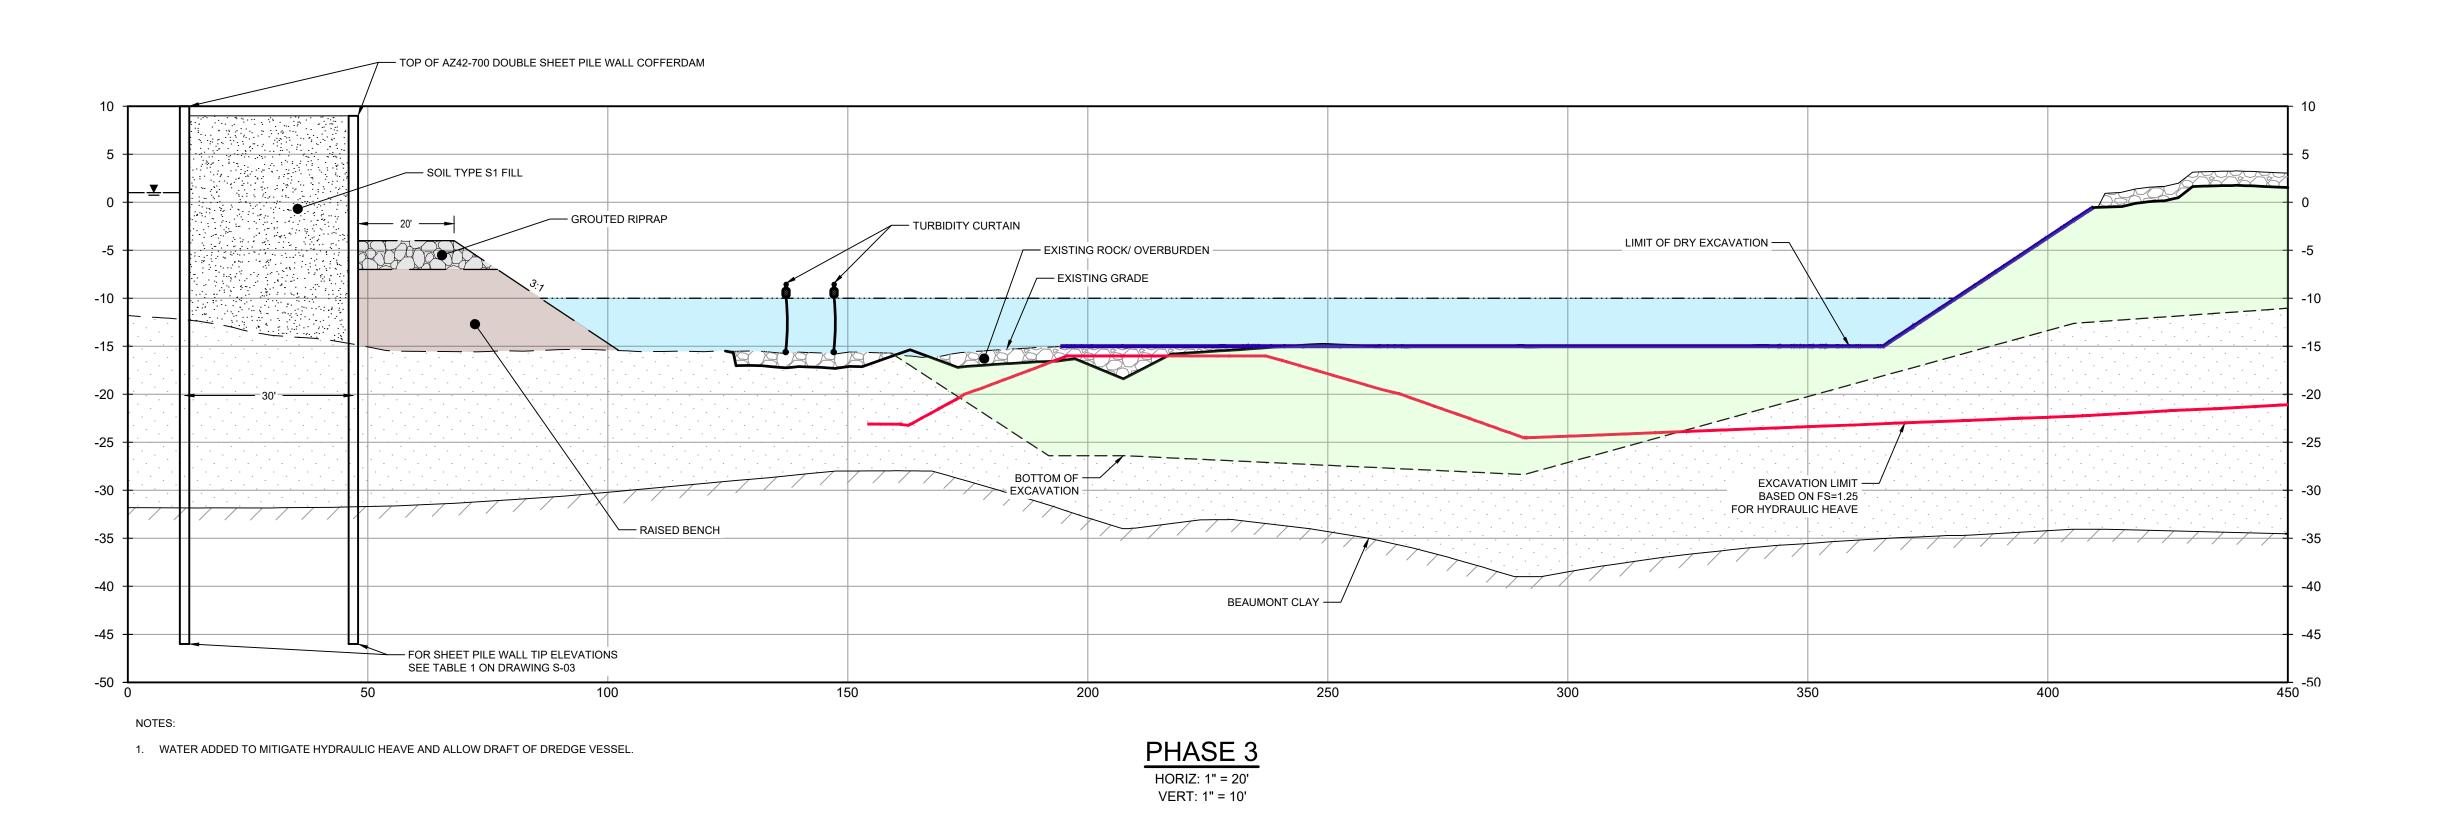

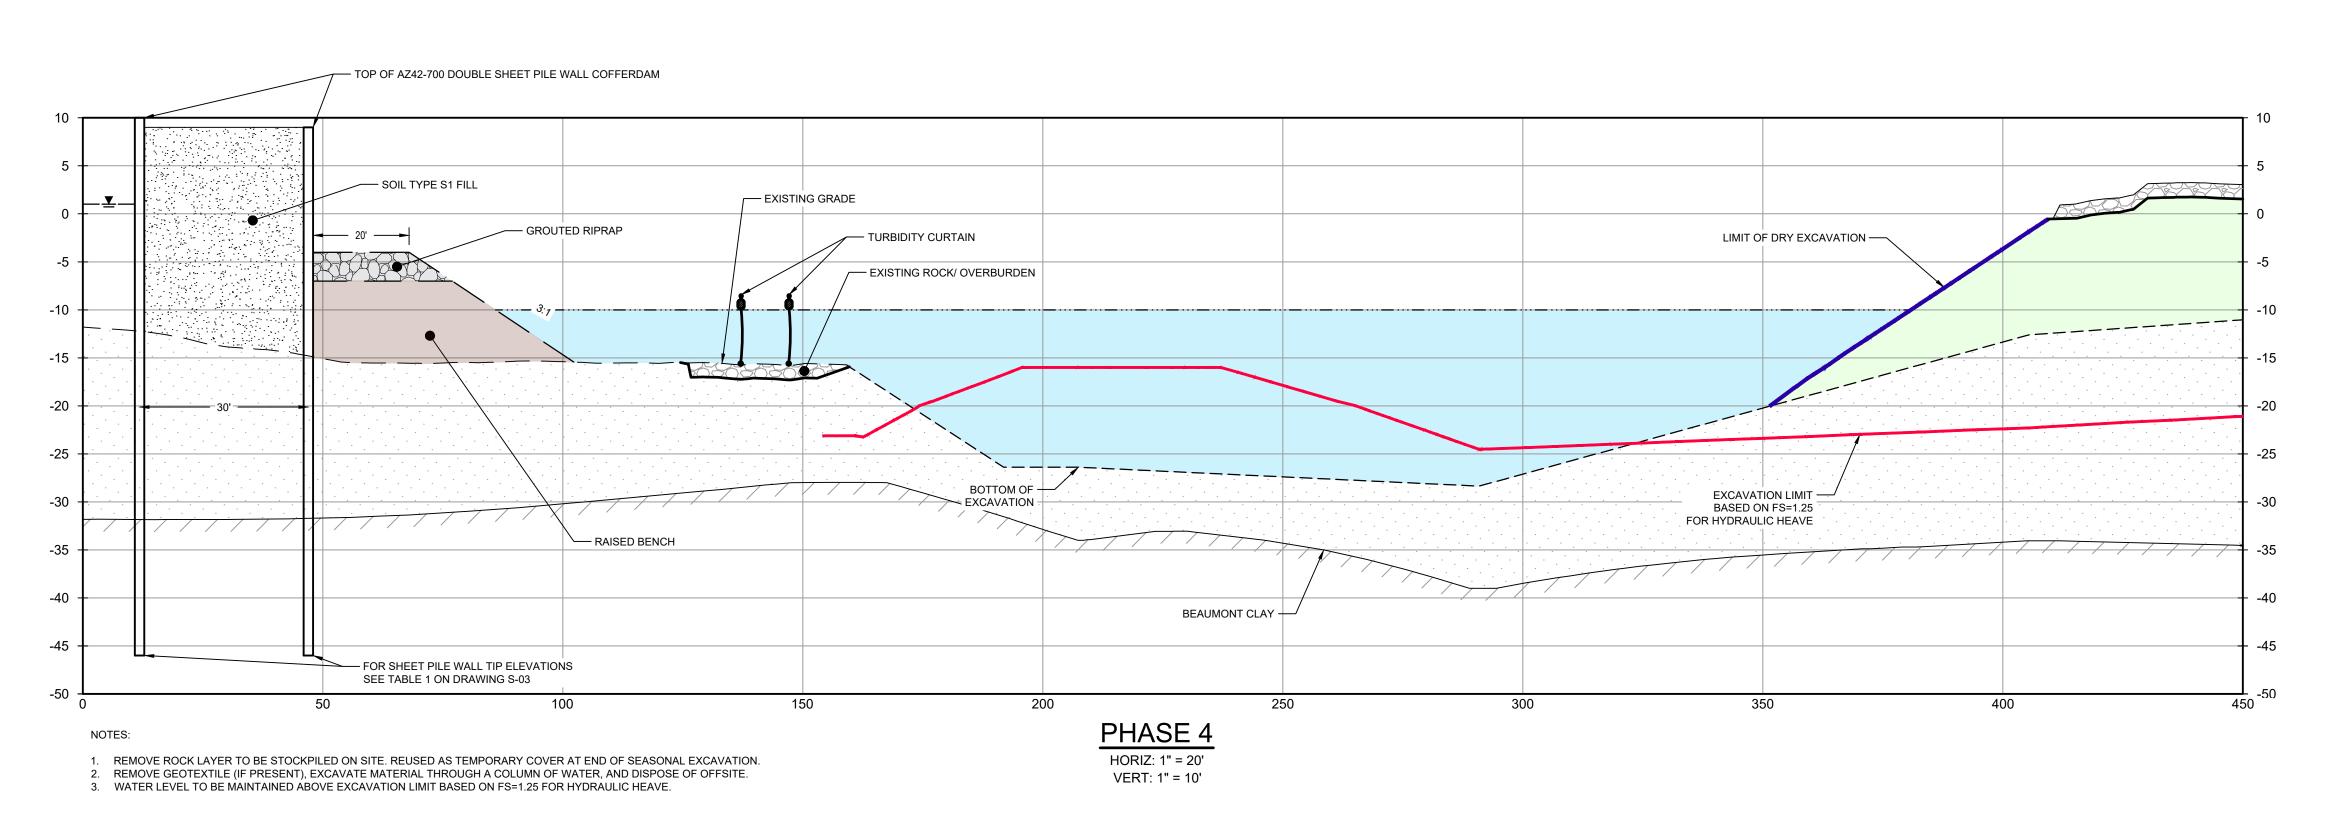

 BOTTOM OF EXCAVATION IS SUBJECT TO CHANGE.
 SCOUR PROTECTION ON INTERIOR AND EXTERIOR SIDE OF COFFERDAM NOT SHOWN. SEE DRAWINGS C-28 TO C-44 FOR LIMITS OF RIPRAP.

THIS DOCUMENT IS RELEASED FOR THE PURPOSE OF EPA REVIEW UNDER THE AUTHORITY OF WILLIAM ALLEN BEAL, P.E. 137828 ON 07/17/2024. IT IS NOT TO BE USED FOR CONSTRUCTION, BIDDING, RECORDATION, CONVEYANCE OR SALES PURPOSES.




100% EPA SUBMITTAL



T 225 292 9007

Baton Rouge Louisiana 70808 USA

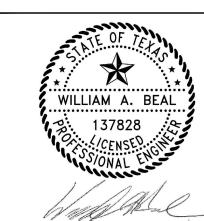

Reuse of Documents


This document and the ideas and designs incorporated herein, as an instrument of professional service, is the property of GHD and shall not be reused in whole or in part for any other project without GHD's written authorization. © 2024 GHD

<u>LEGEND</u>

EXCAVATION LIMIT BASED ON FS = 1.25 FOR HYDRAULIC HEAVE MATERIAL TO BE EXCAVATED

SAN JACINTO RIVER WASTE PITS

NORTHERN IMPOUNDMENT FINAL 100% REMEDIAL DESIGN HARRIS COUNTY, TEXAS

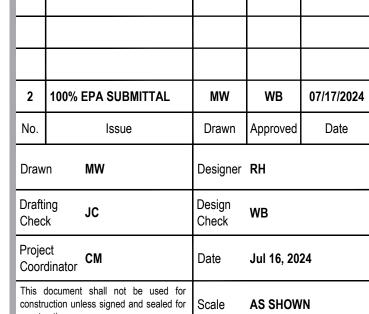

Original Size

Arch D

Arch D

original size drawing

0

1

Project No. **11215702**

Title


DREDGING
NORTHWEST CORNER
SEQUENCING 2 OF 3


Sheet No.

C-52

Sheet - of -

Bar is one inch on

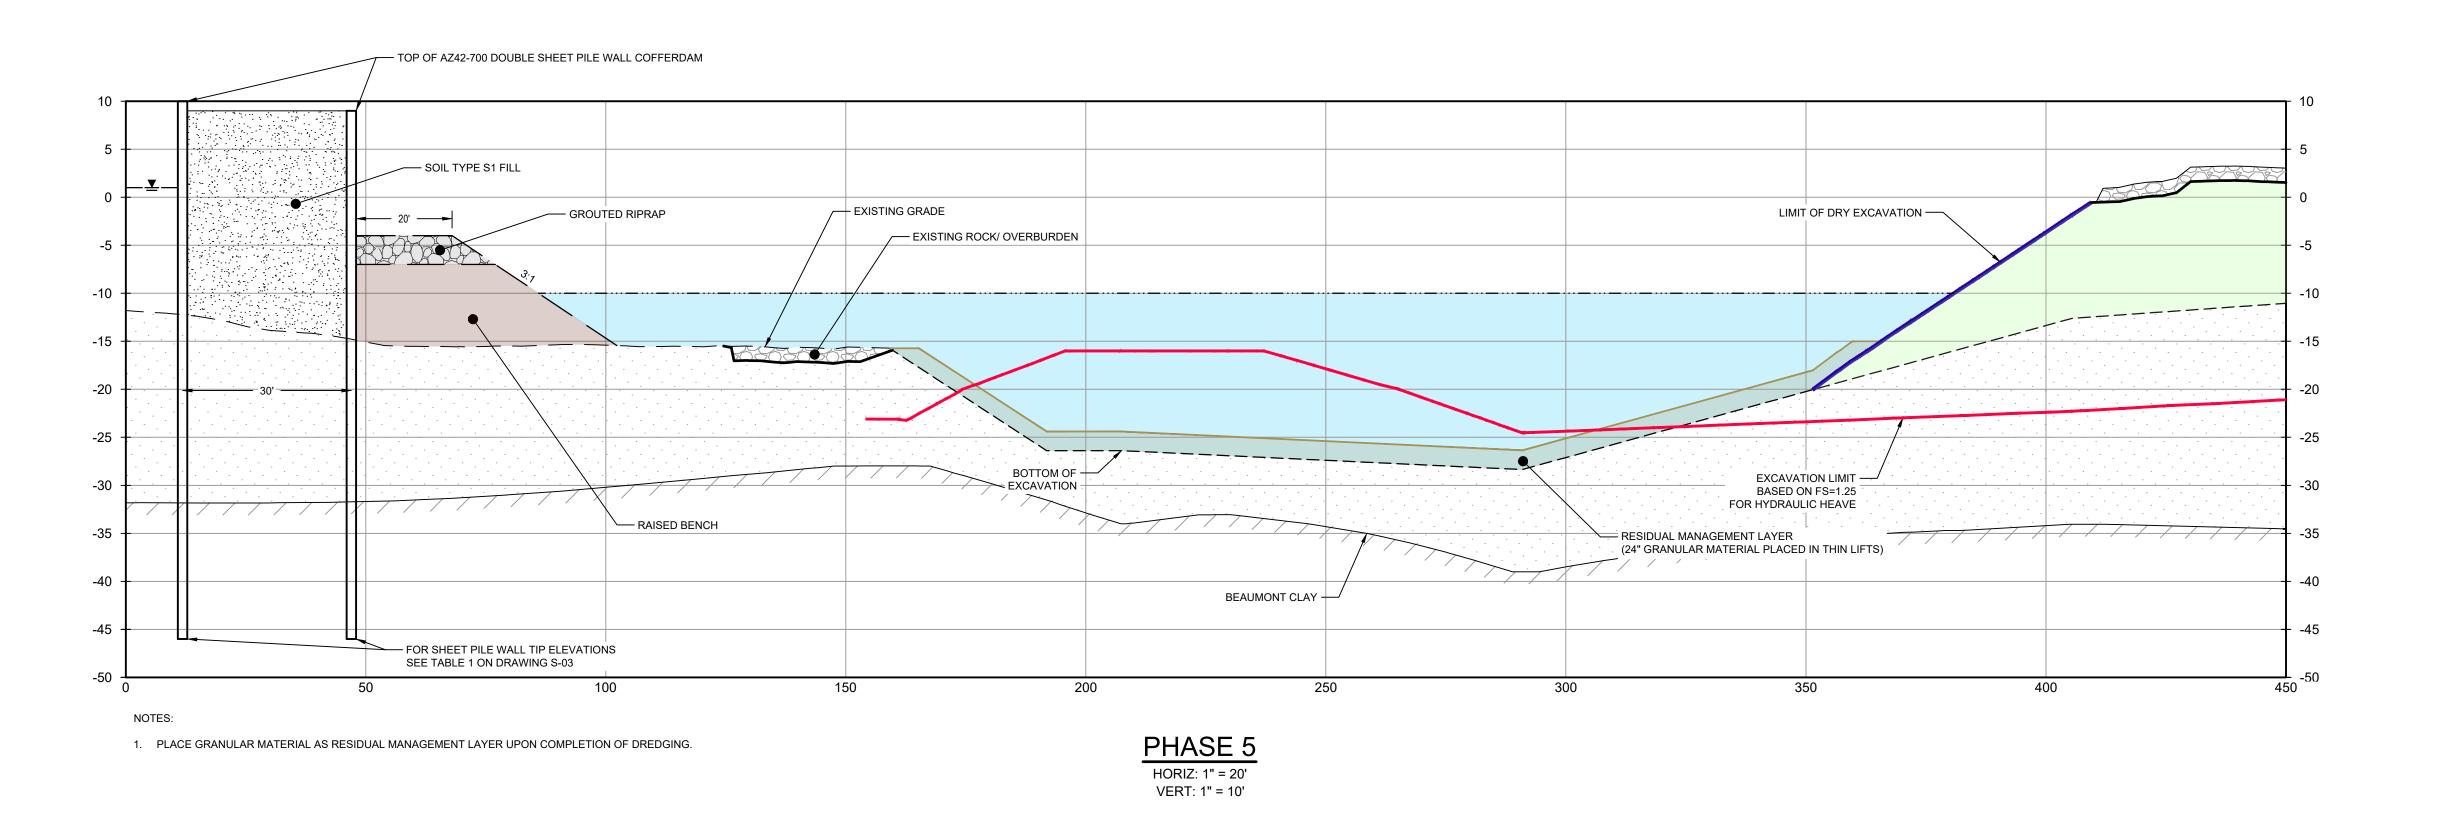

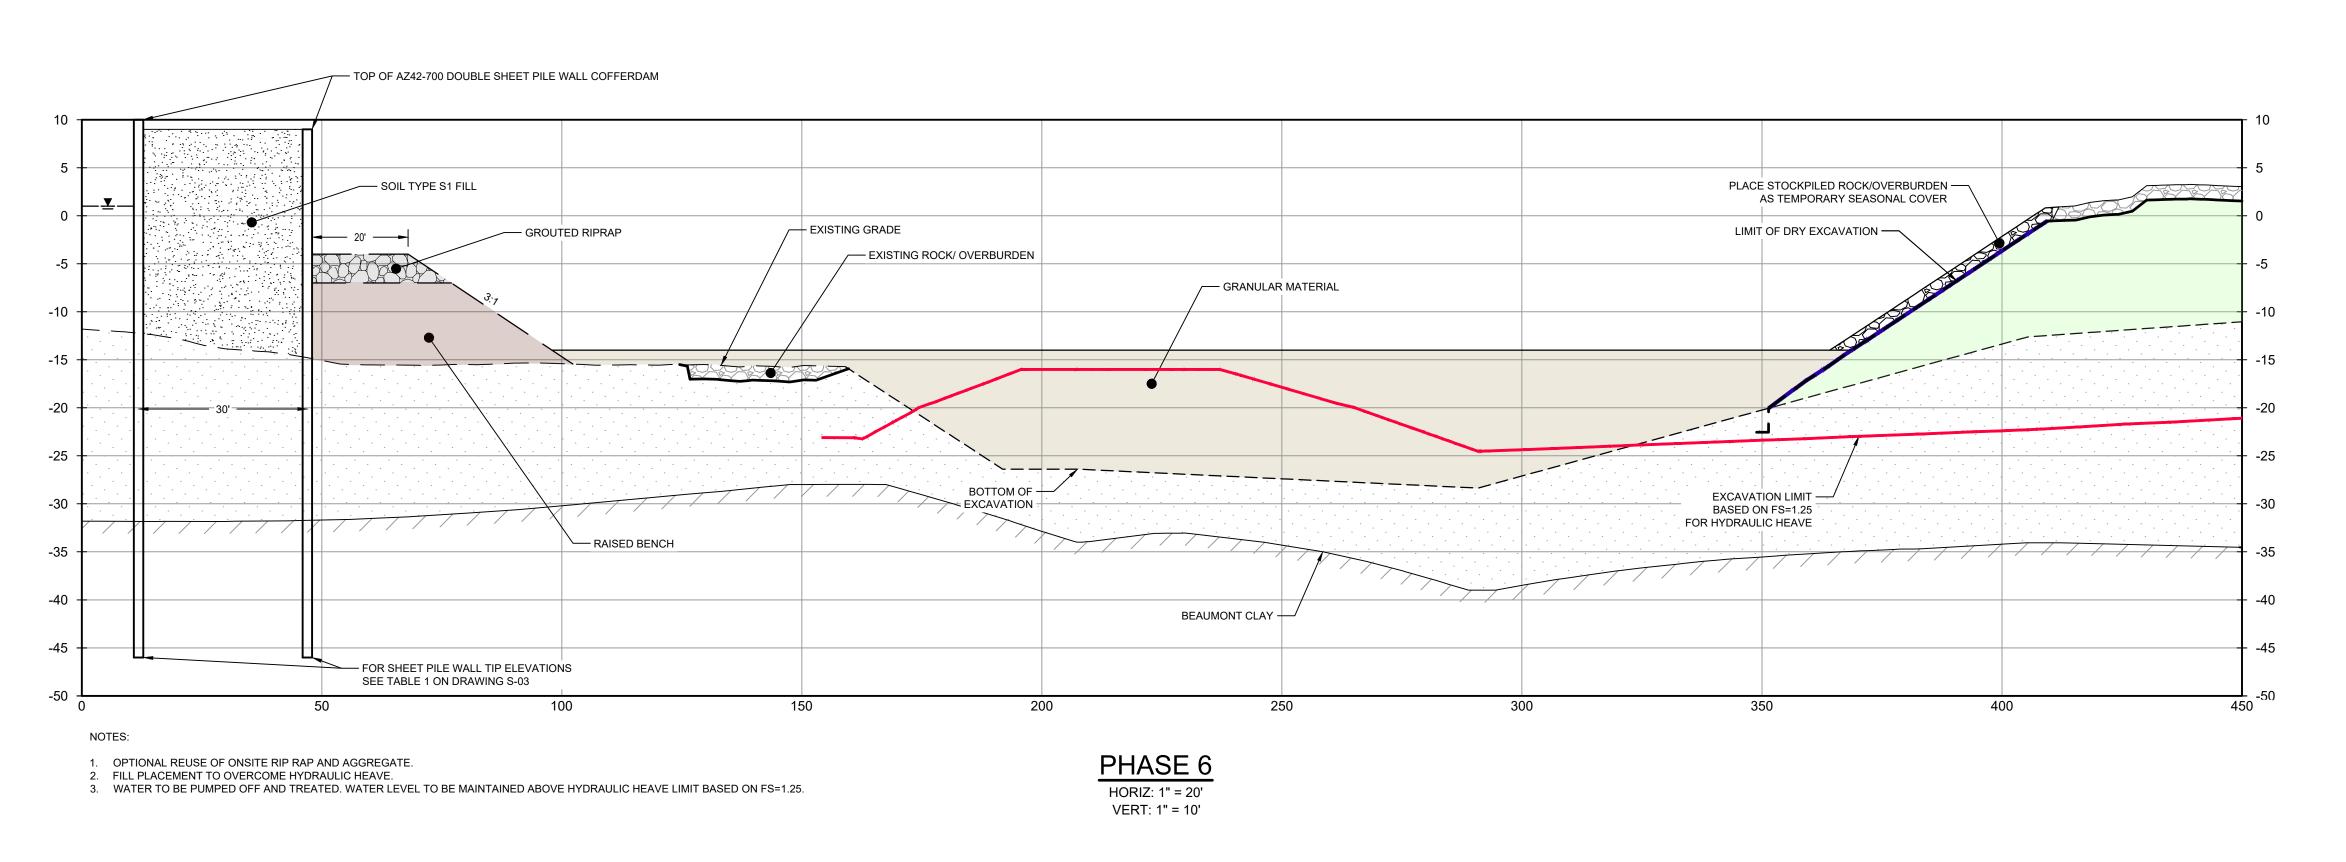

 BOTTOM OF EXCAVATION IS SUBJECT TO CHANGE.
 SCOUR PROTECTION ON INTERIOR AND EXTERIOR SIDE OF COFFERDAM NOT SHOWN. SEE DRAWINGS C-28 TO C-44 FOR LIMITS OF RIPRAP.


THIS DOCUMENT IS RELEASED FOR THE PURPOSE OF EPA REVIEW UNDER THE AUTHORITY OF WILLIAM ALLEN BEAL, P.E. 137828 ON 07/17/2024. IT IS NOT TO BE USED FOR CONSTRUCTION, BIDDING, RECORDATION, CONVEYANCE OR SALES PURPOSES.



100% EPA SUBMITTAL



2237 S Acadian Thruway Suite 701 Baton Rouge Louisiana 70808 USA **T** 225 292 9007

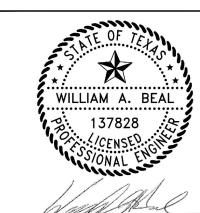

Reuse of Documents

This document and the ideas and designs incorporated herein, as an instrument of professional service, is the property of GHD and shall not be reused in whole or in part for any other project without GHD's written authorization. © 2024 GHD


<u>LEGEND</u>



EXCAVATION LIMIT BASED ON FS = 1.25 FOR HYDRAULIC HEAVE MATERIAL TO BE EXCAVATED GRANULAR MATERIAL

SAN JACINTO RIVER WASTE PITS

NORTHERN IMPOUNDMENT FINAL 100% REMEDIAL DESIGN HARRIS COUNTY, TEXAS

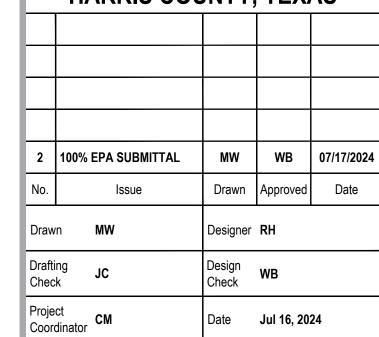

This document shall not be used for construction unless signed and sealed for Scale AS SHOWN Original Size

Bar is one inch on original size drawing Arch D

Date **Jul 16, 2024**

Project No. **11215702**

DREDGING NORTHWEST CORNER **SEQUENCING 3 OF 3**

Sheet No.


C-53


Sheet - of -


Plot Date: 17 July 2024 - 1:02 PM

Plotted By: Jonathan Compton


Filename: \\ghdnet\ghd\US\Baton Rouge\Projects\562\11215702\Digital_Design\ACAD 2019\Sheets\11215702-01-DWG-C-051.dwg

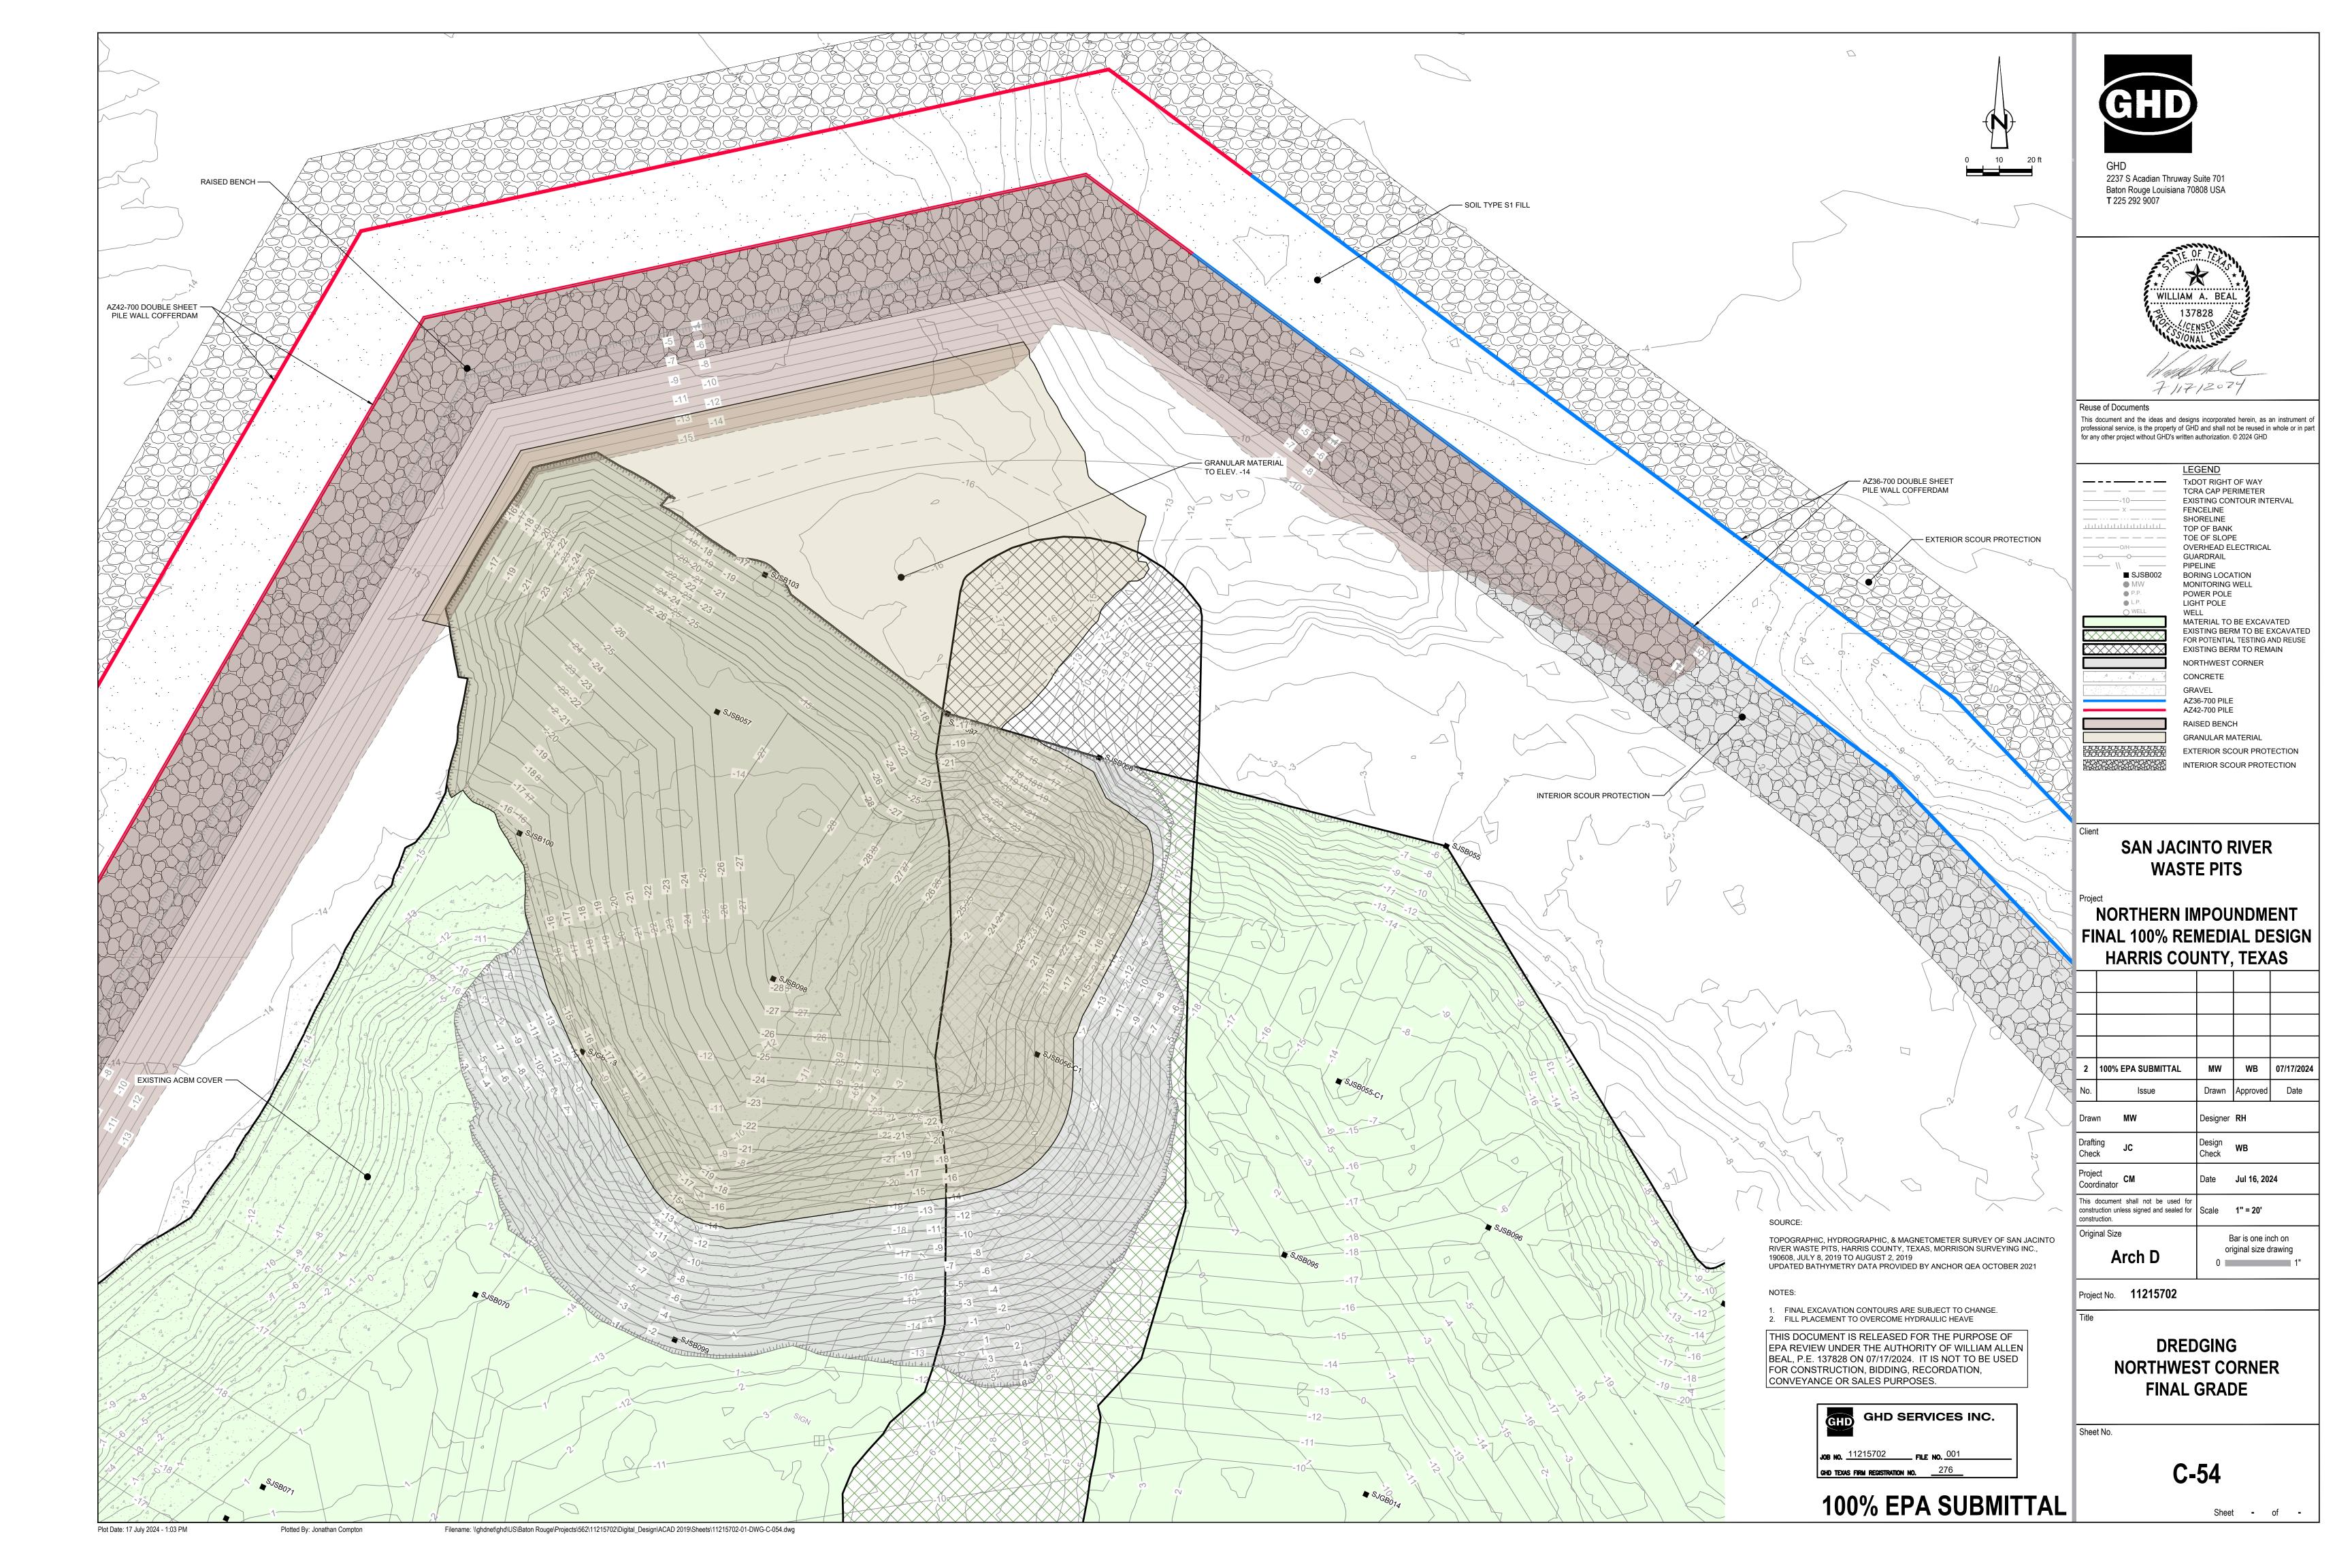

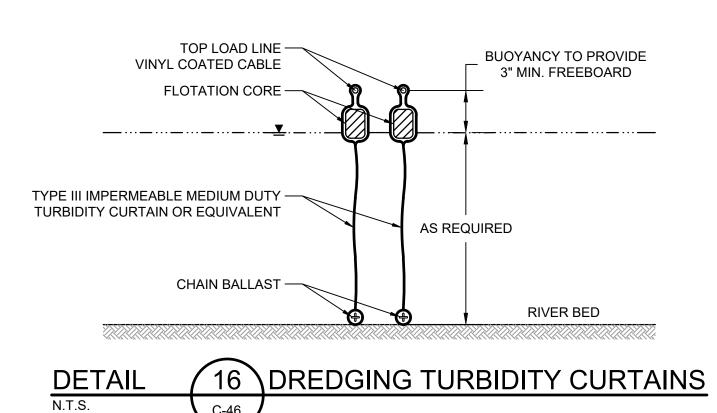


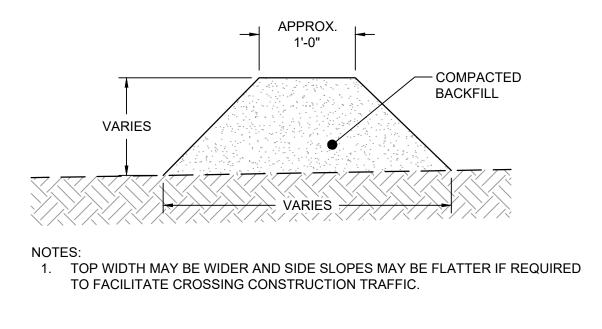



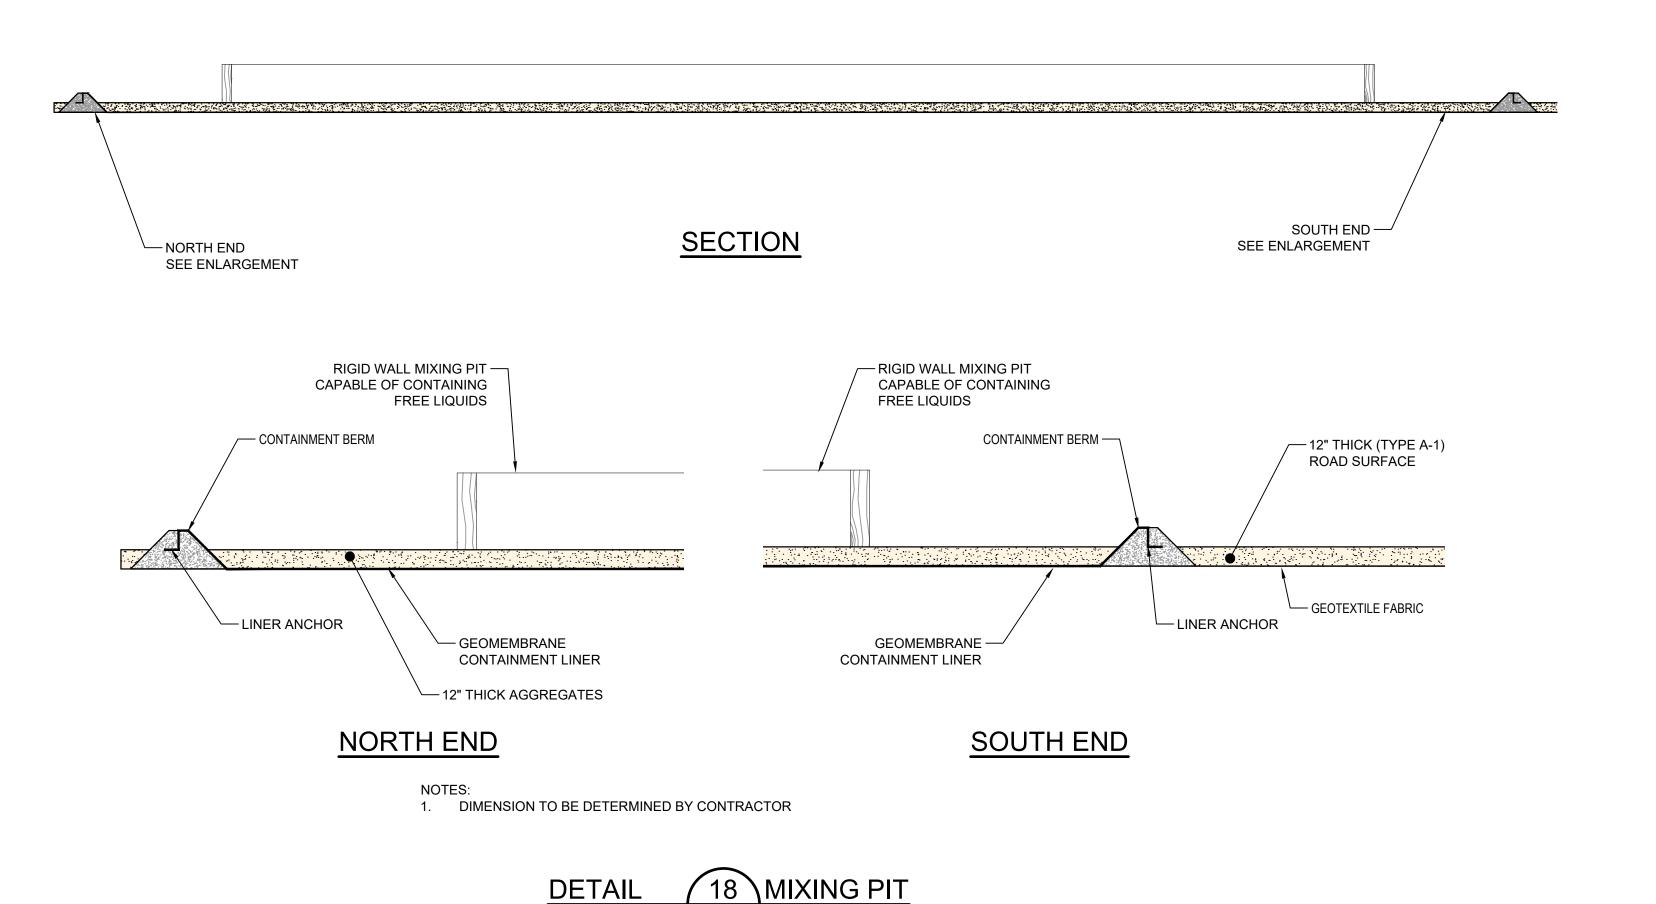

THIS DOCUMENT IS RELEASED FOR THE PURPOSE OF EPA REVIEW UNDER THE AUTHORITY OF WILLIAM ALLEN

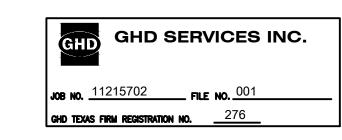

BEAL, P.E. 137828 ON 07/17/2024. IT IS NOT TO BE USED


FOR CONSTRUCTION, BIDDING, RECORDATION,

CONVEYANCE OR SALES PURPOSES.

100% EPA SUBMITTAL



GHD
2237 S Acadian Thruway Suite 701
Baton Rouge Louisiana 70808 USA
T 225 292 9007

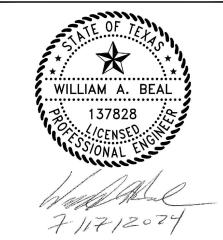

Reuse of Documents

This document and the ideas and designs incorporated herein, as an instrument of professional service, is the property of GHD and shall not be reused in whole or in part for any other project without GHD's written authorization. © 2024 GHD

SAN JACINTO RIVER
WASTE PITS

NORTHERN IMPOUNDMENT FINAL 100% REMEDIAL DESIGN HARRIS COUNTY, TEXAS

г				
2	100% EPA SUBMITTAL	MW	WB	07/17
No.	Issue	Drawn	Approved	Da
Draw	n MW	Designer	RH	
Draft Chec	· .II.	Design Check	WB	
Proje Coor	ct dinator CM	Date	Jul 16, 202	24
constr	document shall not be used for uction unless signed and sealed for uction.	Scale	AS SHOW	/N
Origi	nal Size	В	Bar is one in	ch on

Project No. **11215702**

Arch D

Title


DREDGING NORTHWEST CORNER DREDGING DETAILS


Sheet No.

C-55

Sheet - of -

Bar is one inch on original size drawing

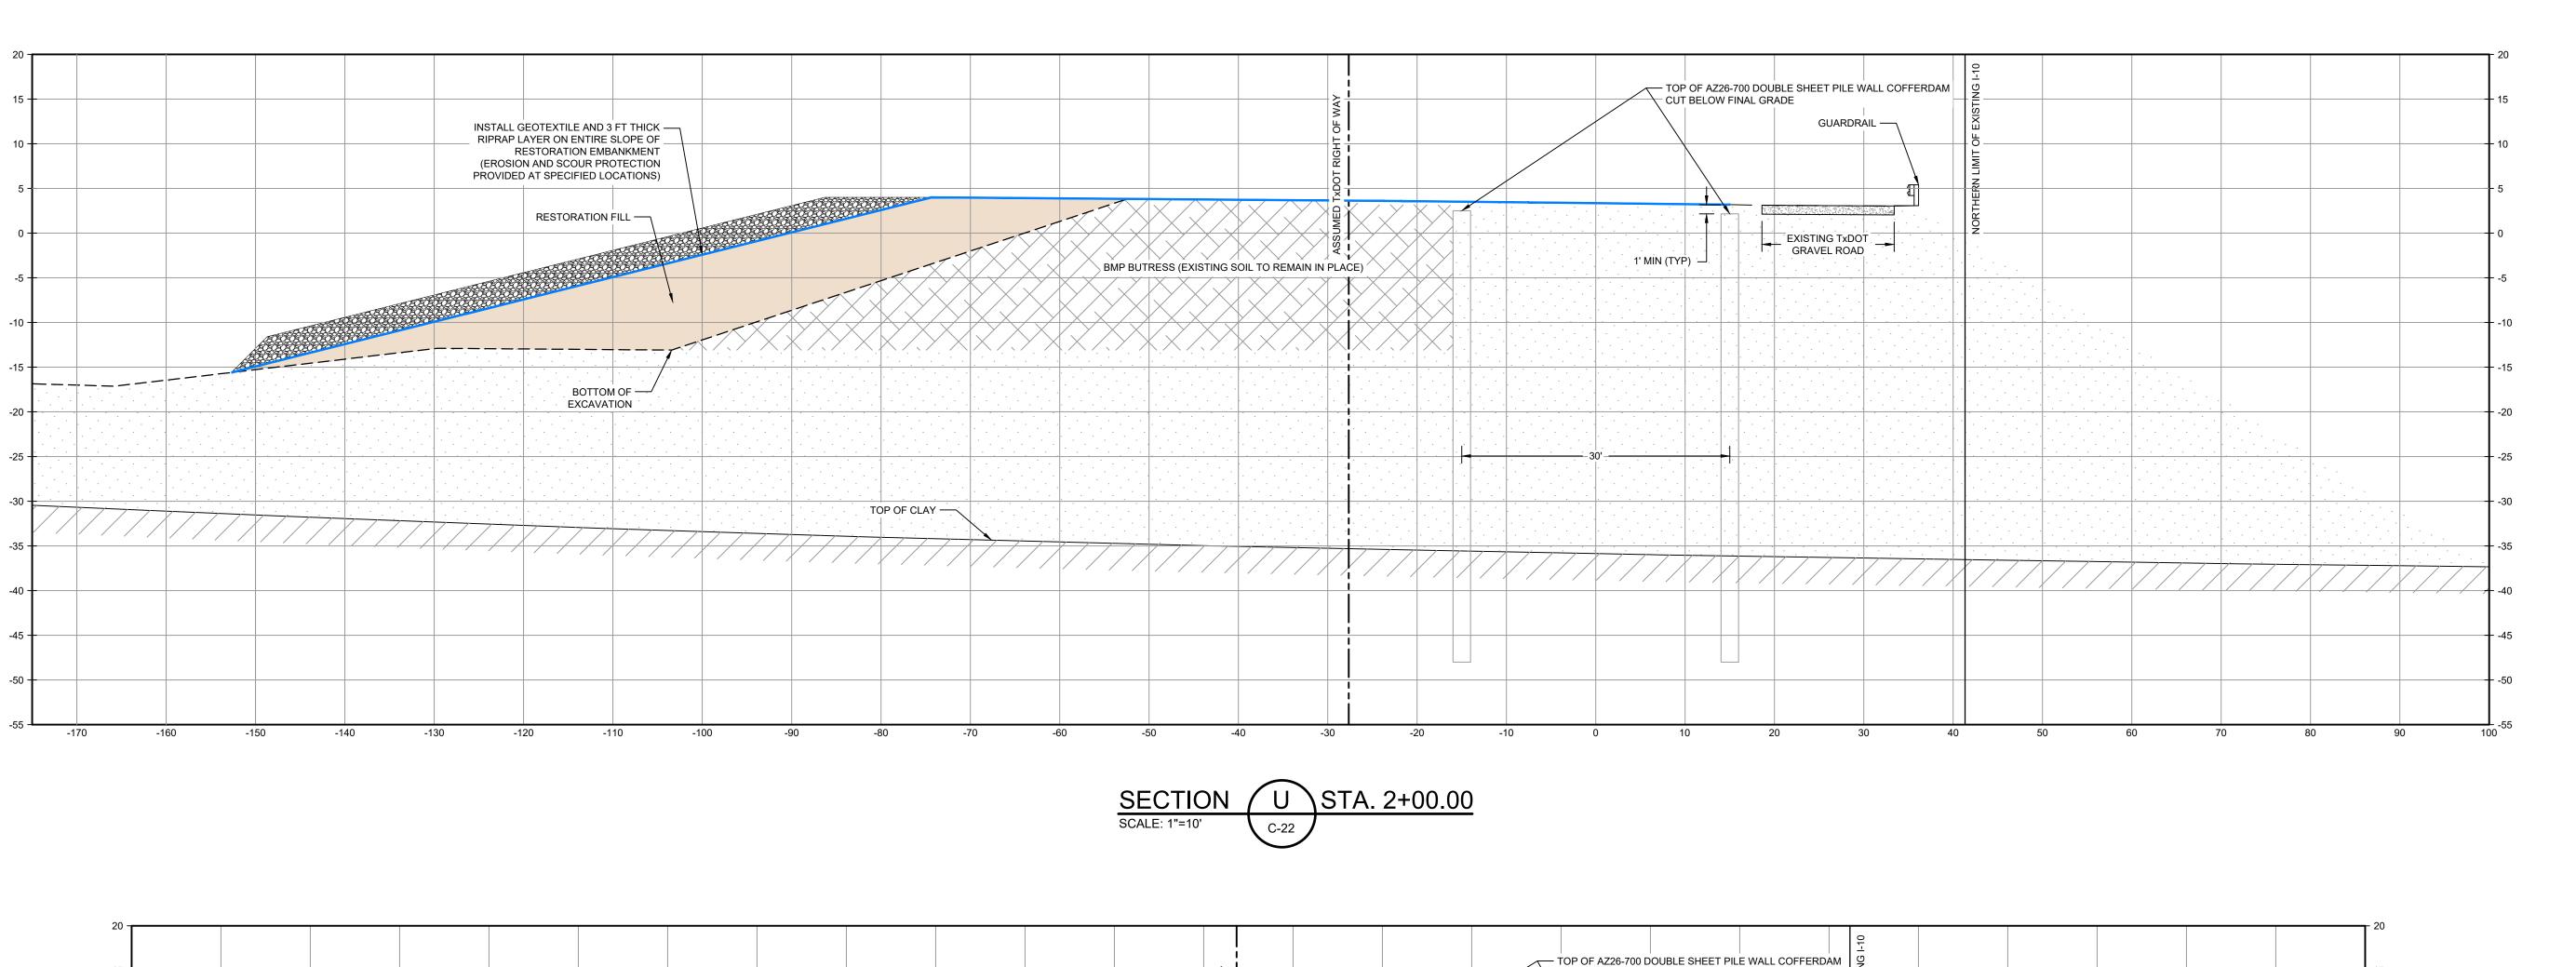

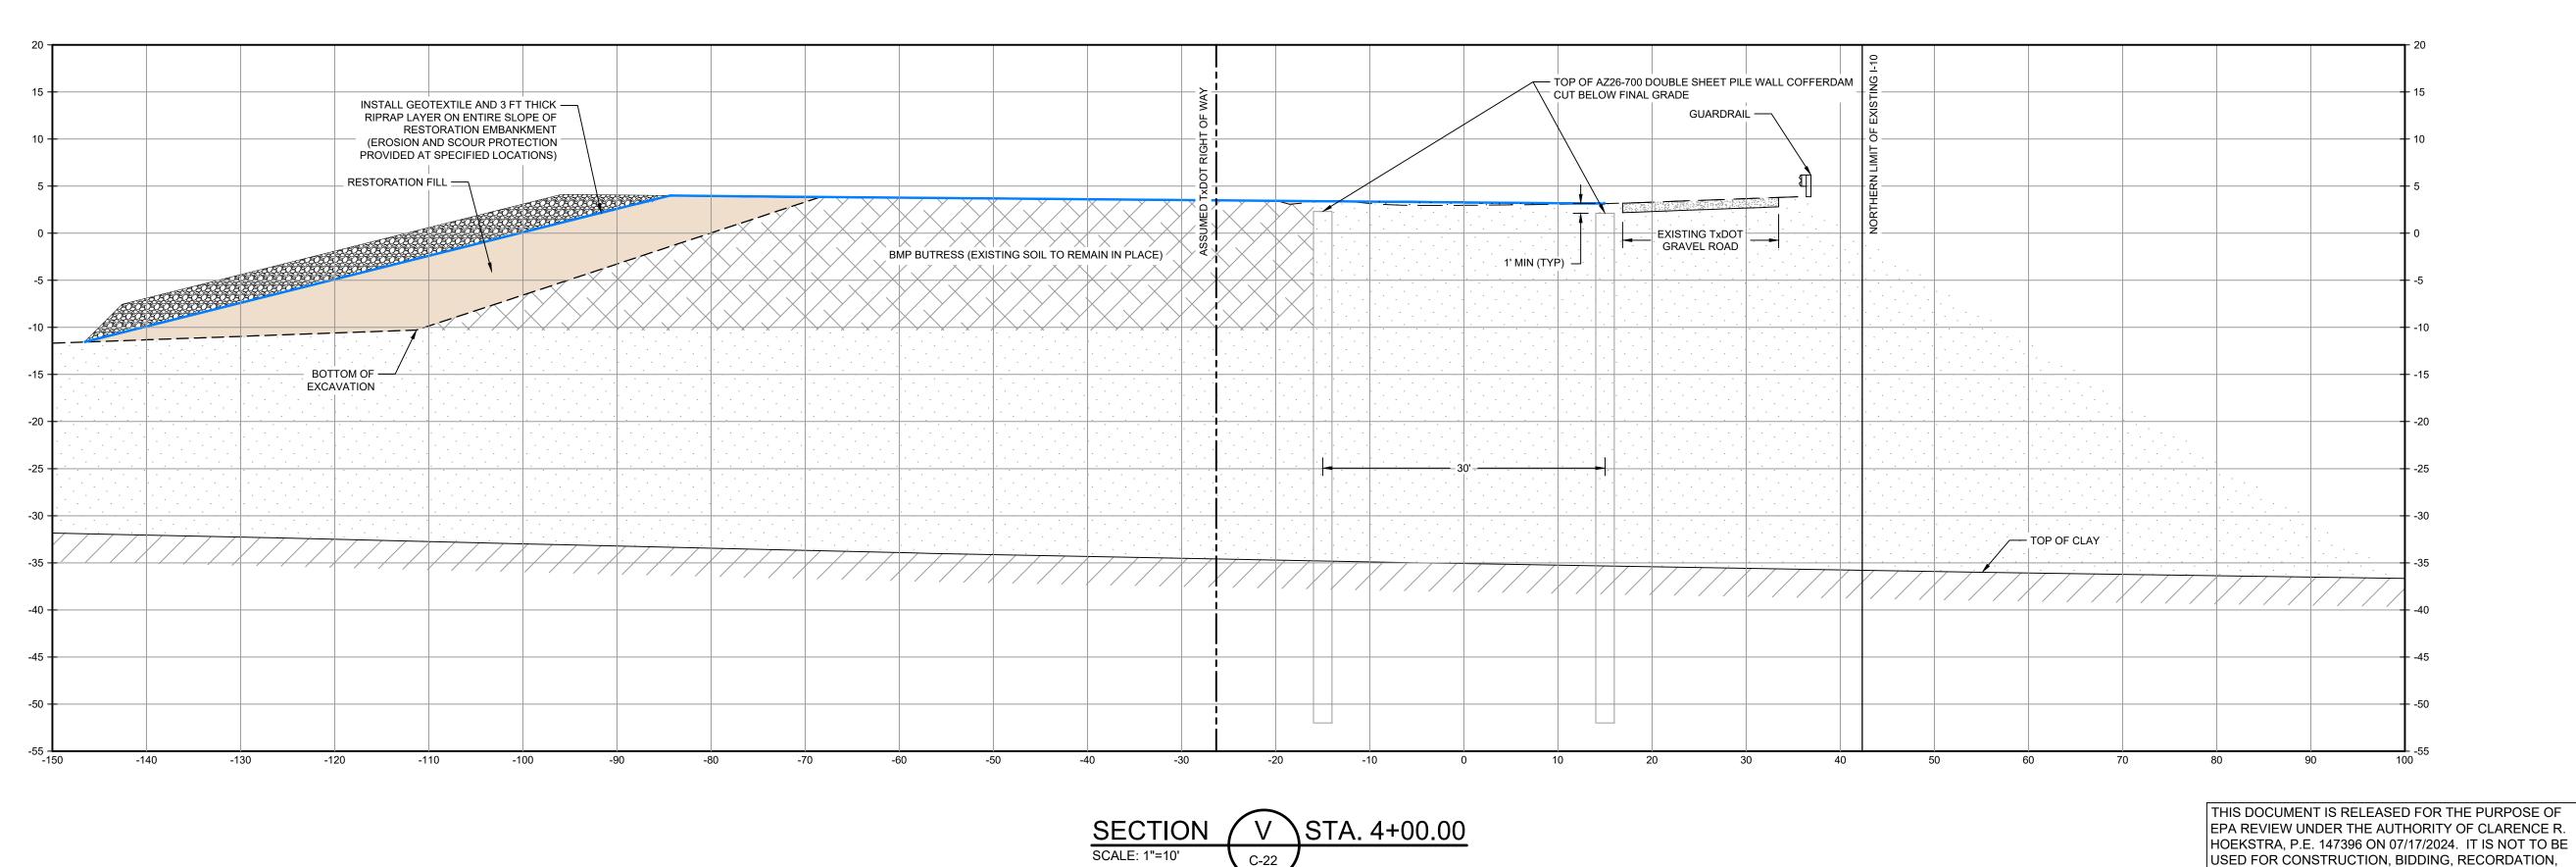

WB 07/17/2024 MW 100% EPA SUBMITTAL Drawn Issue Designer RH Check Project Coordinator Date Jul 17, 2024

This document shall not be used for construction unless signed and sealed for Scale AS SHOWN Original Size

2237 S Acadian Thruway Suite 701 Baton Rouge Louisiana 70808 USA

C. R. HOEKSTRA

This document and the ideas and designs incorporated herein, as an instrument of

professional service, is the property of GHD and shall not be reused in whole or in part

<u>LEGEND</u>

(NOT SHOWN)

SAN JACINTO RIVER

WASTE PITS

NORTHERN IMPOUNDMENT

FINAL 100% REMEDIAL DESIGN

HARRIS COUNTY, TEXAS

RESTORED AREA INCLUDING SOIL BACKFILL AND EROSION CONTROL

RESTORATION EMBANKMENT

for any other project without GHD's written authorization. © 2024 GHD

T 225 292 9007

Reuse of Documents

Arch D

Project No. **11215702**

RESTORATION SECTIONS 1 OF 2

Bar is one inch on original size drawing

0 1"

Sheet - of -

Sheet No.

C-56

NOTES: 1. BOTTOM OF EXCAVATION IS SUBJECT TO CHANGE.

2402-028-01, JUNE 28, 2024

TXDOT RIGHT OF WAY FROM A BOUNDARY AND RIGHT-OF-WAY SURVEY OF PORT OF HOUSTON AUTHORITY PROPERTY & HOUSTON FLEETING SERVICES, LLC

PROPERTY ALONG INTERSTATE HIGHWAY 10 AT THE SAN JACINTO FLEET AREA, IN THE J. T. HARRELL SURVEY, A-330 HARRIS COUNTY, TEXAS, COBBFENDLEY,


100% EPA SUBMITTAL


GHD SERVICES INC.

GHD TEXAS FIRM REGISTRATION NO. 276

CONVEYANCE OR SALES PURPOSES.

Plot Date: 17 July 2024 - 1:04 PM

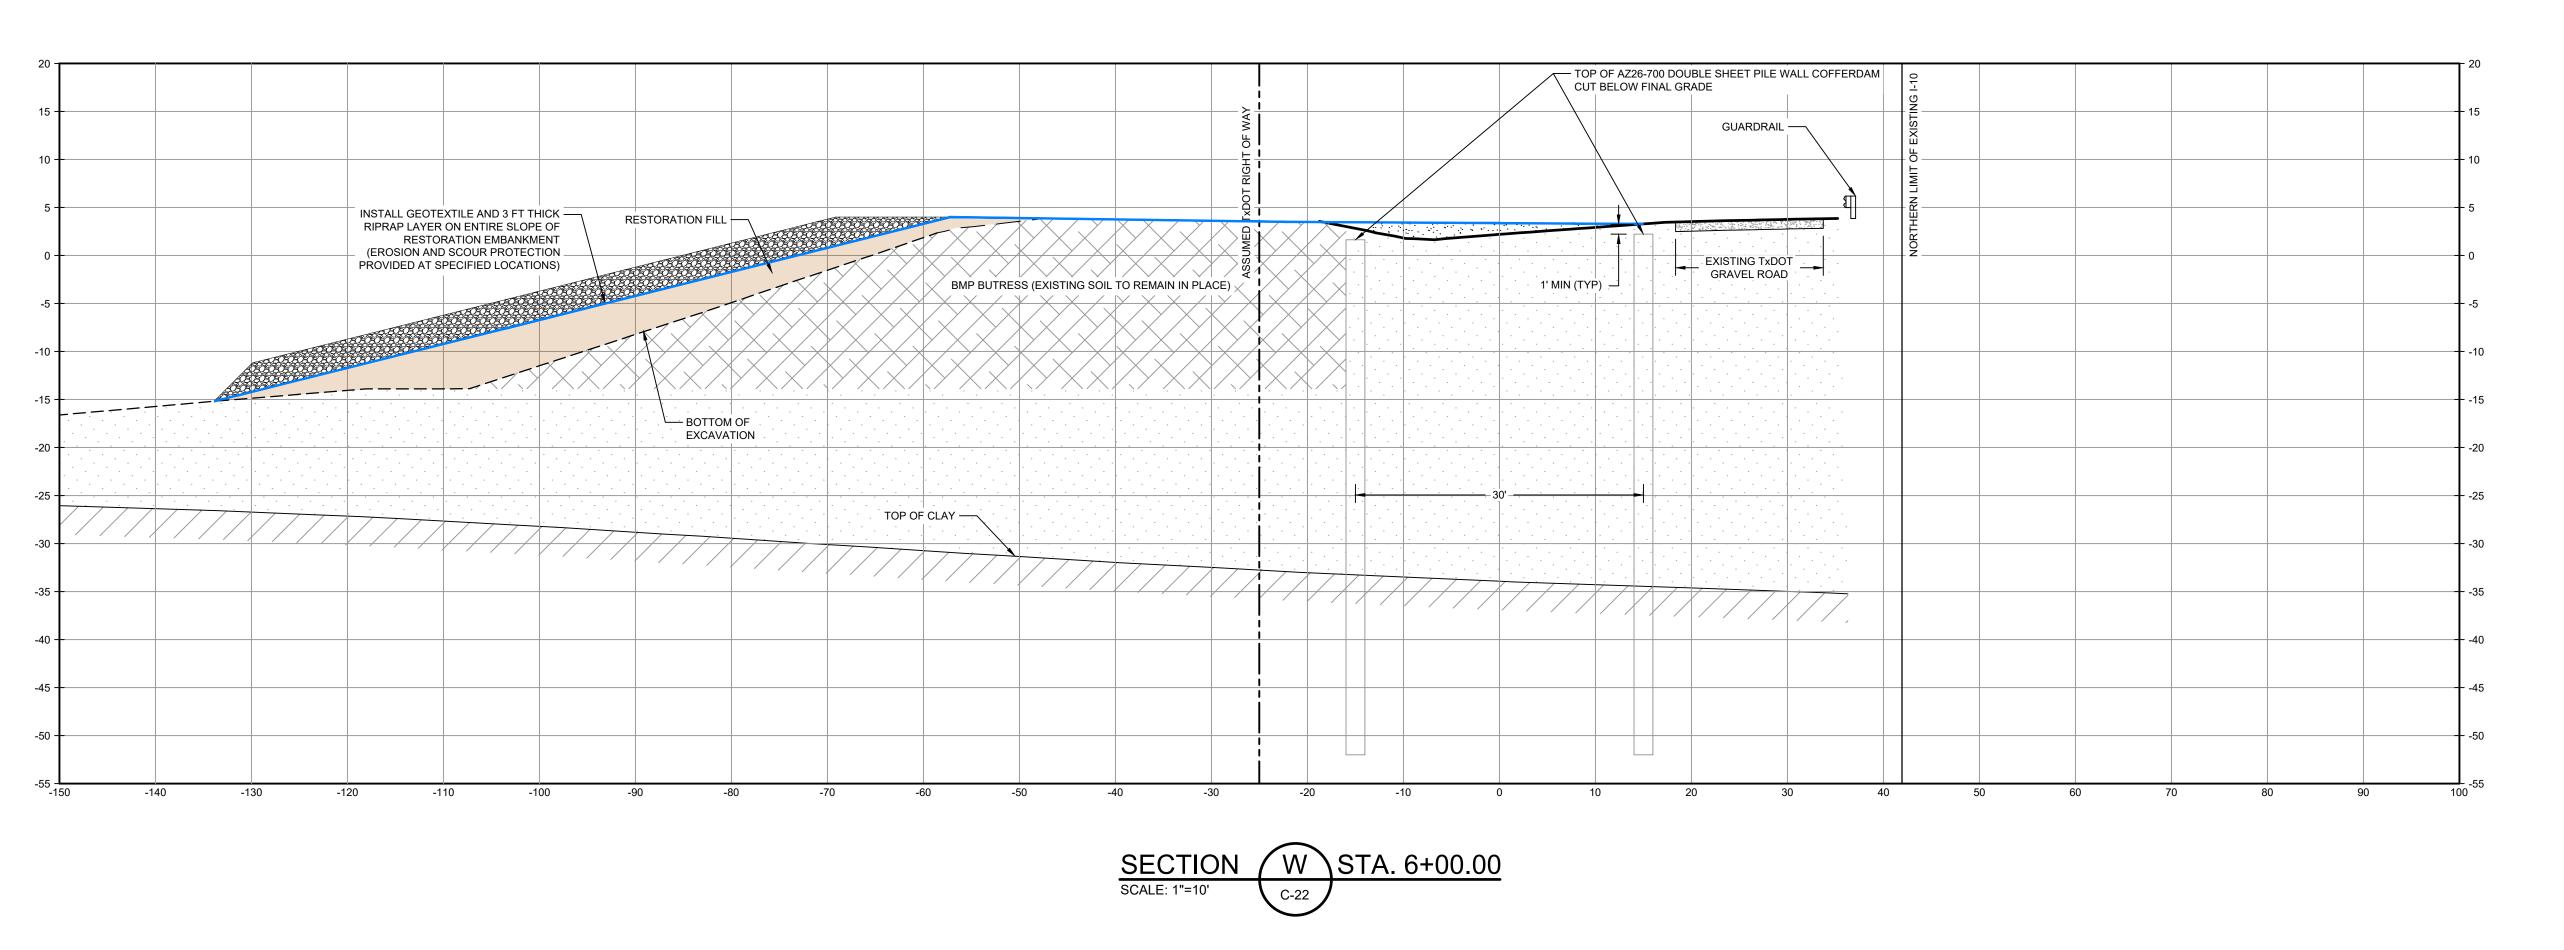

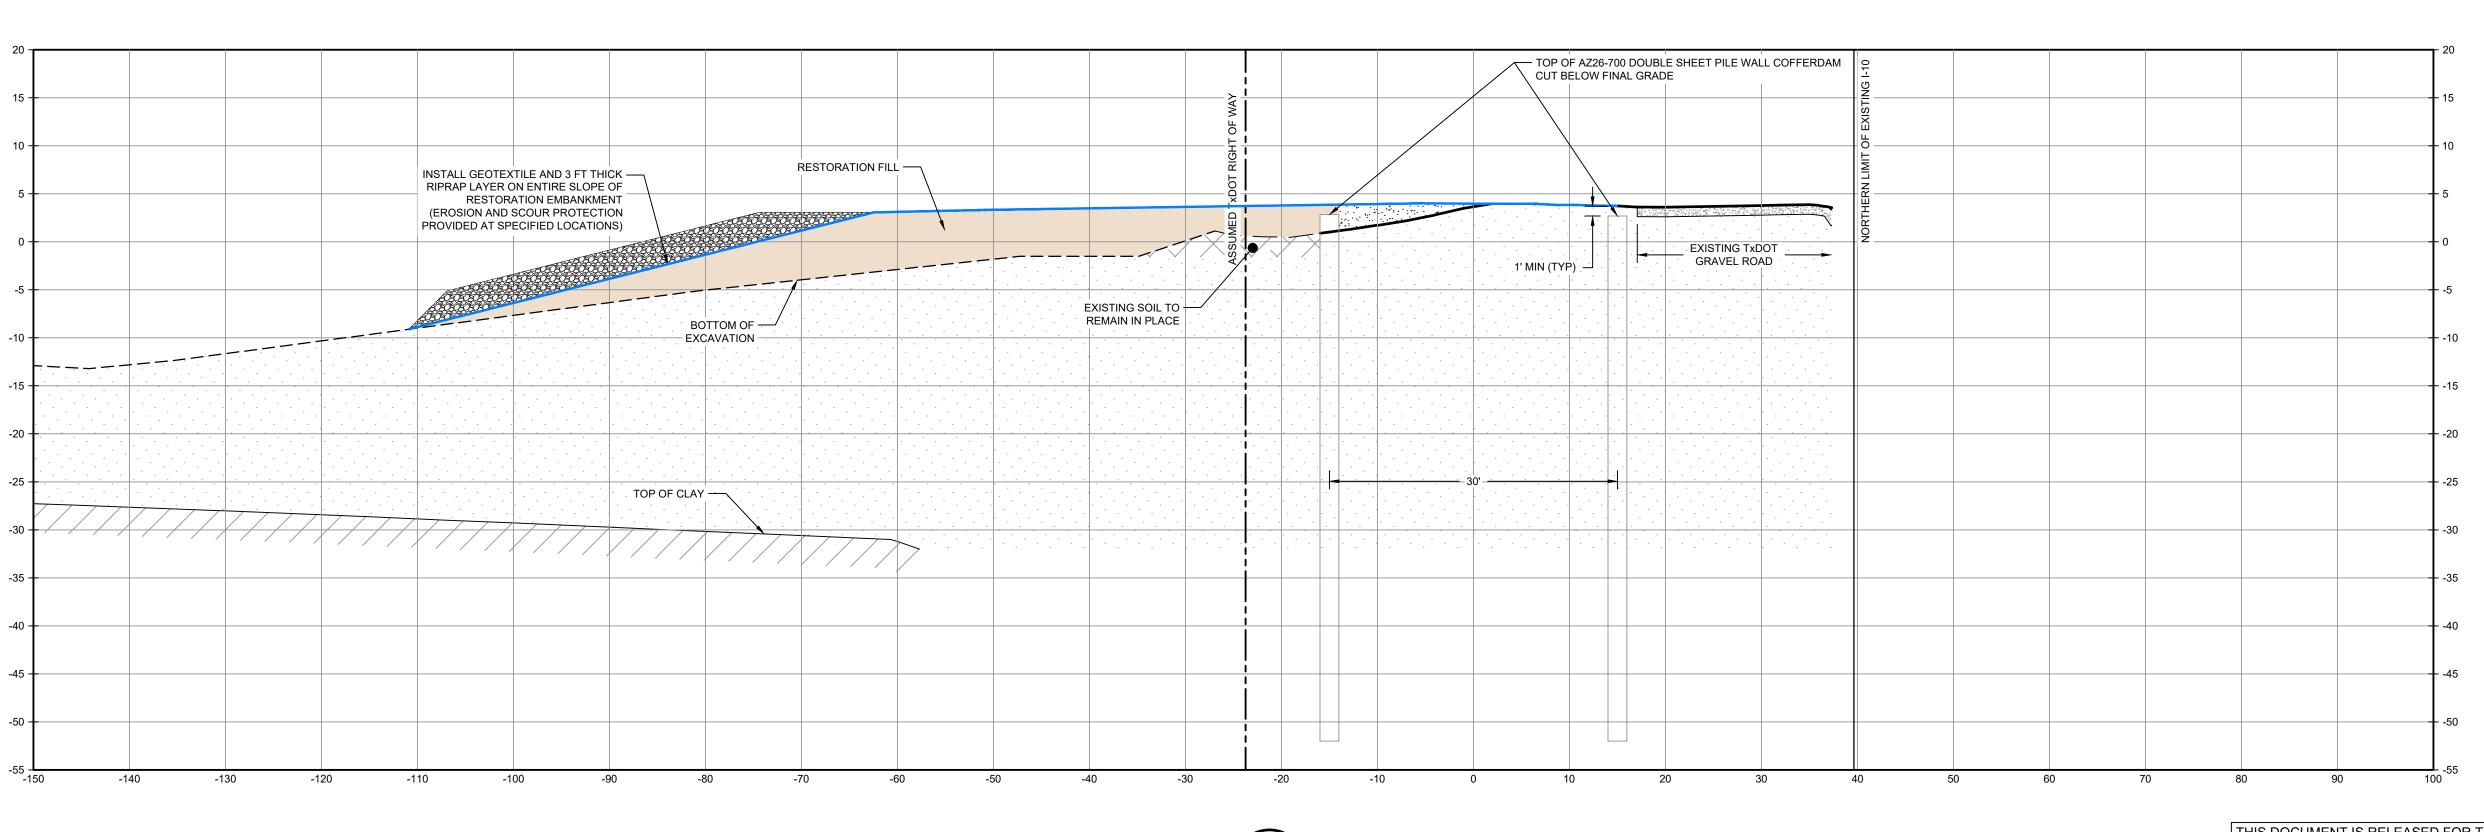


SECTION X STA. 8+00.00
SCALE: 1"=10" C-22

THIS DOCUMENT IS RELEASED FOR THE PURPOSE OF EPA REVIEW UNDER THE AUTHORITY OF CLARENCE R. HOEKSTRA, P.E. 147396 ON 07/17/2024. IT IS NOT TO BE USED FOR CONSTRUCTION, BIDDING, RECORDATION, CONVEYANCE OR SALES PURPOSES.

SOURCE:
TXDOT RIGHT OF WAY FROM A BOUNDARY AND RIGHT-OF-WAY SURVEY OF PORT
OF HOUSTON AUTHORITY PROPERTY & HOUSTON FLEETING SERVICES, LLC
PROPERTY ALONG INTERSTATE HIGHWAY 10 AT THE SAN JACINTO FLEET AREA,
IN THE J. T. HARRELL SURVEY, A-330 HARRIS COUNTY, TEXAS, COBBFENDLEY,
2402-028-01, JUNE 28, 2024

NOTES:


1. BOTTOM OF EXCAVATION IS SUBJECT TO CHANGE.

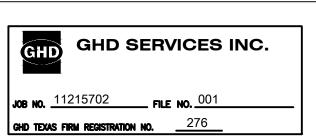

100% EPA SUBMITTAL

GHD

2237 S Acadian Thruway Suite 701 Baton Rouge Louisiana 70808 USA T 225 292 9007

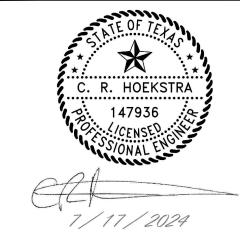

Reuse of Documents

This document and the ideas and designs incorporated herein, as an instrument of professional service, is the property of GHD and shall not be reused in whole or in part for any other project without GHD's written authorization. © 2024 GHD

LEGEND

RESTORED AREA INCLUDING SOIL BACKFILL AND EROSION CONTROL (NOT SHOWN) RESTORATION EMBANKMENT

Client

SAN JACINTO RIVER WASTE PITS

NORTHERN IMPOUNDMENT FINAL 100% REMEDIAL DESIGN HARRIS COUNTY, TEXAS



Original Size

Arch D

Bar is one inch on original size drawing

0

11

This document shall not be used for construction unless signed and sealed for Scale AS SHOWN

Project No. **11215702**

Title

RESTORATION SECTIONS 2 OF 2

Sheet No.

C-57

<u>GENERAL</u>

- 1. VERIFY ALL DIMENSIONS AND EXISTING CONDITIONS BEFORE COMMENCING WORK. REPORT ANY DISCREPANCIES AND/OR INCONSISTENCIES TO THE OWNER FOR CLARIFICATION.
- 2. TEMPORARILY BRACE PILES AFTER DRIVING UNTIL TIE RODS ARE INSTALLED.

CODES AND GUIDELINES

- ASCE MINIMUM DESIGN LOADS AND ASSOCIATED CRITERIA FOR BUILDING AND OTHER STRUCTURES, ASCE 7, 2016
- USACE ENGINEERING MANUAL, DESIGN OF SHEET PILE WALLS BY UNITED STATES ARMY CORPS OF ENGINEERS, EM 1110 2 2504
- AMERICAN INSTITUTE OF STEEL CONTRACTORS, STEEL CONSTRUCTION MANUAL 15TH EDITION, AISC 360-16. • USACE HURRICANE AND STORM DAMAGE RISK REDUCTION SYSTEM DESIGN GUIDELINES, UPDATED JUNE 2012.
- AMERICAN ASSOCIATION OF STATE HIGHWAY AND TRANSPORTATION OFFICIALS, LRFD BRIDGE DESIGN SPECIFICATIONS, 2012.

MATERIALS

STEEL:

 BARS AND C, MC, AND L SHAPES ASTM A36, GALV, UNO

 SHEET PILE ASTM A572. GRADE 60 ASTM A252, GRADE 3 MODIFIED TO MEET ASTM A572 GRADE 55 PIPE PILES

 TIE ROD ASSEMBLY THREADED BARS GRADE 80 KSI BEARING PLATE ASTM A572/A588 GRADE 50 HARDENED WASHER ASTM F436

 GALVANIZED BOLTS FOR SPLICE CONNECTIONS ASTM A325 WITH A563 NUTS AND HARDENED WASHER

STRUCTURAL STEEL AND MISCELLANEOUS METAL

HEX NUT WITH JAM NUT

- 1. WELDING SHALL CONFORM TO "STRUCTURAL WELDING CODE STEEL" (AWS D1.1).
- 2. PROVIDE 1" DIAMETER BLEED HOLES IN WALERS AT 10'-0" ON CENTER MAX, AVOID CONTACT WITH SPLICE PLATE CONNECTION.

ASTM 108/S576

FRP BARRIER WALL

PIPE PILE FENDER WALERS BOLTS NUTS

WASHERS

SPECIFICATION 31 62 23 SPECIFICATION 06 71 13 ASTM A193 316L STAINLESS STEEL GRADE B8M ASTM F594 TYPE 316L STAINLESS STEEL 316L STAINLESS STEEL

CONSTRUCTION SEQUENCE

SECTION C1

1. INSTALL LEFT AND RIGHT SHEET PILE WALL 2. INSTALL FILL UP TO EL. +3 FT UNIFORMLY OVER MIN 10 DAYS

3. INSTALL TIE ROD AT ELEVATION NOTED ON SHEET S-03 4. INSTALL FILL UP TO EL. +9 FT UNIFORMLY OVER MIN 6 DAYS

5. MINIMUM TIME FOR DEWATERING TO EXISTING MUDLINE: 4 DAYS 6. MINIMUM TIME FOR EXCAVATING TO 50% DEPTH: 17 DAYS

7. MINIMUM TIME FOR DEWATERING TO FINAL LEVEL: 3 DAYS 8. MINIMUM TIME FOR EXCAVATING TO 100% DEPTH: 14 DAYS

SECTION C2

1. INSTALL LEFT AND RIGHT SHEET PILE WALL 2. INSTALL FILL UP TO EL. -7 FT UNIFORMLY OVER MIN 7 DAYS

3. INSTALL TIE ROD AT ELEVATION NOTED ON SHEET S-03 4. INSTALL FILL UP TO EL. -1 FT UNIFORMLY OVER MIN 7 DAYS 5. INSTALL FILL UP TO EL. +5 FT UNIFORMLY OVER MIN 7 DAYS

6. INSTALL FILL UP TO EL. +9 FT UNIFORMLY OVER MIN 7 DAYS 7. INSTALL RAISED BENCH TO EL -9 FT, SLOPED AT 4H:1V AND WAIT 7 DAYS.

8. INSTALL RAISED BENCH FROM EL -9 FT TO EL -4 FT, SLOPED AT 4H:1V, TOP WIDTH

OF MIN 20-FT AND WAIT 7 DAYS BEFORE DEWATERING. 9. MINIMUM TIME FOR DEWATERING TO EXISTING MUDLINE: 4 DAYS 10. MINIMUM TIME FOR EXCAVATING TO 50% DEPTH: 17 DAYS

11. MINIMUM TIME FOR DEWATERING TO FINAL LEVEL: 3 DAYS 12. MINIMUM TIME FOR EXCAVATING TO 100% DEPTH: 14 DAYS

SECTION C3

1. INSTALL LEFT AND RIGHT SHEET PILE WALL

2. INSTALL FILL UP TO EL. +0 FT UNIFORMLY OVER MIN 10 DAYS 3. INSTALL TIE ROD AT ELEVATION NOTED ON SHEET S-03

4. INSTALL FILL UP TO EL. +3 FT UNIFORMLY OVER MIN 3 DAYS 5. INSTALL FILL UP TO EL. +9 FT UNIFORMLY OVER MIN 10 DAYS

6. MINIMUM TIME FOR DEWATERING TO EXISTING MUDLINE: 4 DAYS 7. MINIMUM TIME FOR EXCAVATING TO 50% DEPTH: 17 DAYS

8. MINIMUM TIME FOR DEWATERING TO FINAL LEVEL: 3 DAYS 9. MINIMUM TIME FOR EXCAVATING TO 100% DEPTH: 14 DAYS

SECTION C4A 1. INSTALL LEFT AND RIGHT SHEET PILE WALL

2. INSTALL FILL UP TO EL. +0 FT UNIFORMLY OVER MIN 10 DAYS

3. INSTALL TIE ROD AT ELEVATION NOTED ON SHEET S-03 4. INSTALL FILL UP TO EL. +9 FT UNIFORMLY OVER MIN 6 DAYS

5. MINIMUM TIME FOR DEWATERING TO EXISTING MUDLINE: 4 DAYS

6. MINIMUM TIME FOR EXCAVATING TO 50% DEPTH: 17 DAYS 7. MINIMUM TIME FOR DEWATERING TO FINAL LEVEL: 3 DAYS

8. MINIMUM TIME FOR EXCAVATING TO 100% DEPTH: 14 DAYS

SECTION C4

1. INSTALL LEFT AND RIGHT SHEET PILE WALL

2. INSTALL FILL UP TO EL. -3 FT UNIFORMLY OVER MIN 10 DAYS

3. INSTALL TIE ROD AT ELEVATION NOTED ON SHEET S-03

4. INSTALL FILL UP TO EL. +9 FT UNIFORMLY OVER MIN 6 DAYS

5. MINIMUM TIME FOR DEWATERING TO EXISTING MUDLINE: 4 DAYS

6. MINIMUM TIME FOR EXCAVATING TO 50% DEPTH: 17 DAYS 7. MINIMUM TIME FOR DEWATERING TO FINAL LEVEL: 3 DAYS

8. MINIMUM TIME FOR EXCAVATING TO 100% DEPTH: 14 DAYS

SECTION C5

1. INSTALL LEFT AND RIGHT SHEET PILE WALL

2. INSTALL FILL UP TO EL. -1 FT UNIFORMLY OVER MIN 10 DAYS

3. INSTALL TIE ROD AT ELEVATION NOTED ON SHEET S-03

4. INSTALL FILL UP TO EL. +9 FT UNIFORMLY OVER MIN 6 DAYS

5. MINIMUM TIME FOR DEWATERING TO EXISTING MUDLINE: 4 DAYS 6. MINIMUM TIME FOR EXCAVATING TO 50% DEPTH: 17 DAYS

7. MINIMUM TIME FOR DEWATERING TO FINAL LEVEL: 3 DAYS 8. MINIMUM TIME FOR EXCAVATING TO 100% DEPTH: 14 DAYS

SECTION C6, C7

1. INSTALL LEFT AND RIGHT SHEET PILE WALL

2. CUT BETWEEN THE SHEET PILES TO ELEVATION 0 FT

3. INSTALL TIE RODS AT ELEVATION NOTED ON SHEET S-03

4. INSTALL FILL UP TO EL. +9 FT UNIFORMLY OVER MIN 6 DAYS

5. MINIMUM TIME FOR DEWATERING TO EXISTING MUDLINE: 4 DAYS

6. MINIMUM TIME FOR EXCAVATING TO 50% DEPTH: 17 DAYS 7. MINIMUM TIME FOR DEWATERING TO FINAL LEVEL: 3 DAYS

8. MINIMUM TIME FOR EXCAVATING TO 100% DEPTH: 14 DAYS

ABBREVIATIONS

ANGI F ASCE AMERICAN SOCIETY OF CIVIL ENGINEERS

AMERICAN WELDING SOCIETY AWS BEG BEGINNING BOW **BOTTOM OF WALL**

CONST CONSTRUCTION CONTINUOUS OR CONTINUED CONT DIA DIAMETER

DWG DRAWING EΑ EACH **ELEVATION EASTING EXISTING** EXIST. FG FINISH GRADE FOW FACE OF WALL FS FINISH SURFACE FT FEET

HORIZ HORIZONTAL INV INVERT JT JOINT LF LINEAR FEET LT LEFT MAX MAXIMUM

MHW MEAN HIGH WATER MIN MINIMUM MISC. MISCELLANEOUS NORTHING

NTS NOT TO SCALE NAVD NORTH AMERICAN VERTICAL DATUM OC ON CENTER

PROF PROFILE PT POINT QTY QUANTITY RET RETAINING ROW RIGHT OF WAY RT RIGHT SHT SHEET STA STATION STD STANDARD T&B TOP AND BOTTOM TOW TOP OF WALL TYP TYPICAL

UNK UNKNOWN UNLESS NOTED OTHERWISE UNO UNITED STATES ARMY CORPS OF ENGINEERS

USACE **VERT VERTICAL**

WIDTH WITH

2237 S Acadian Thruway Suite 701 Baton Rouge Louisiana 70808 USA **T** 225 292 9007



Reuse of Documents

This document and the ideas and designs incorporated herein, as an instrument of professional service, is the property of GHD and shall not be reused in whole or in part for any other project without GHD's written authorization. © 2024 GHD

SAN JACINTO RIVER WASTE PITS

NORTHERN IMPOUNDMENT FINAL 100% REMEDIAL DESIGN HARRIS COUNTY, TEXAS

100% EPA REVIEW DS SC 07/17/2024 2 90% EPA REVIEW DS SC 06/27/2022 Drawn Issue Designer KM Drawn Check Project Coordinator Date **Jul 17, 2024** This document shall not be used for construction unless signed and sealed for Scale N.T.S.

Project No. **11215702**

Arch D

Original Size

STRUCTURAL NOTES

Bar is one inch on original size drawing

0 1

Sheet No.

S-01


Sheet - of -

THIS DOCUMENT IS RELEASED FOR THE PURPOSE OF EPA REVIEW UNDER THE AUTHORITY OF SATISH CHILKA, P.E. 145120 ON 07/17/2024. IT IS NOT TO BE USED FOR CONSTRUCTION, BIDDING, RECORDATION, CONVEYANCE OR SALES PURPOSES.


GHD TEXAS FIRM REGISTRATION NO. 276

100% EPA SUBMITTAL

GHD SERVICES INC.

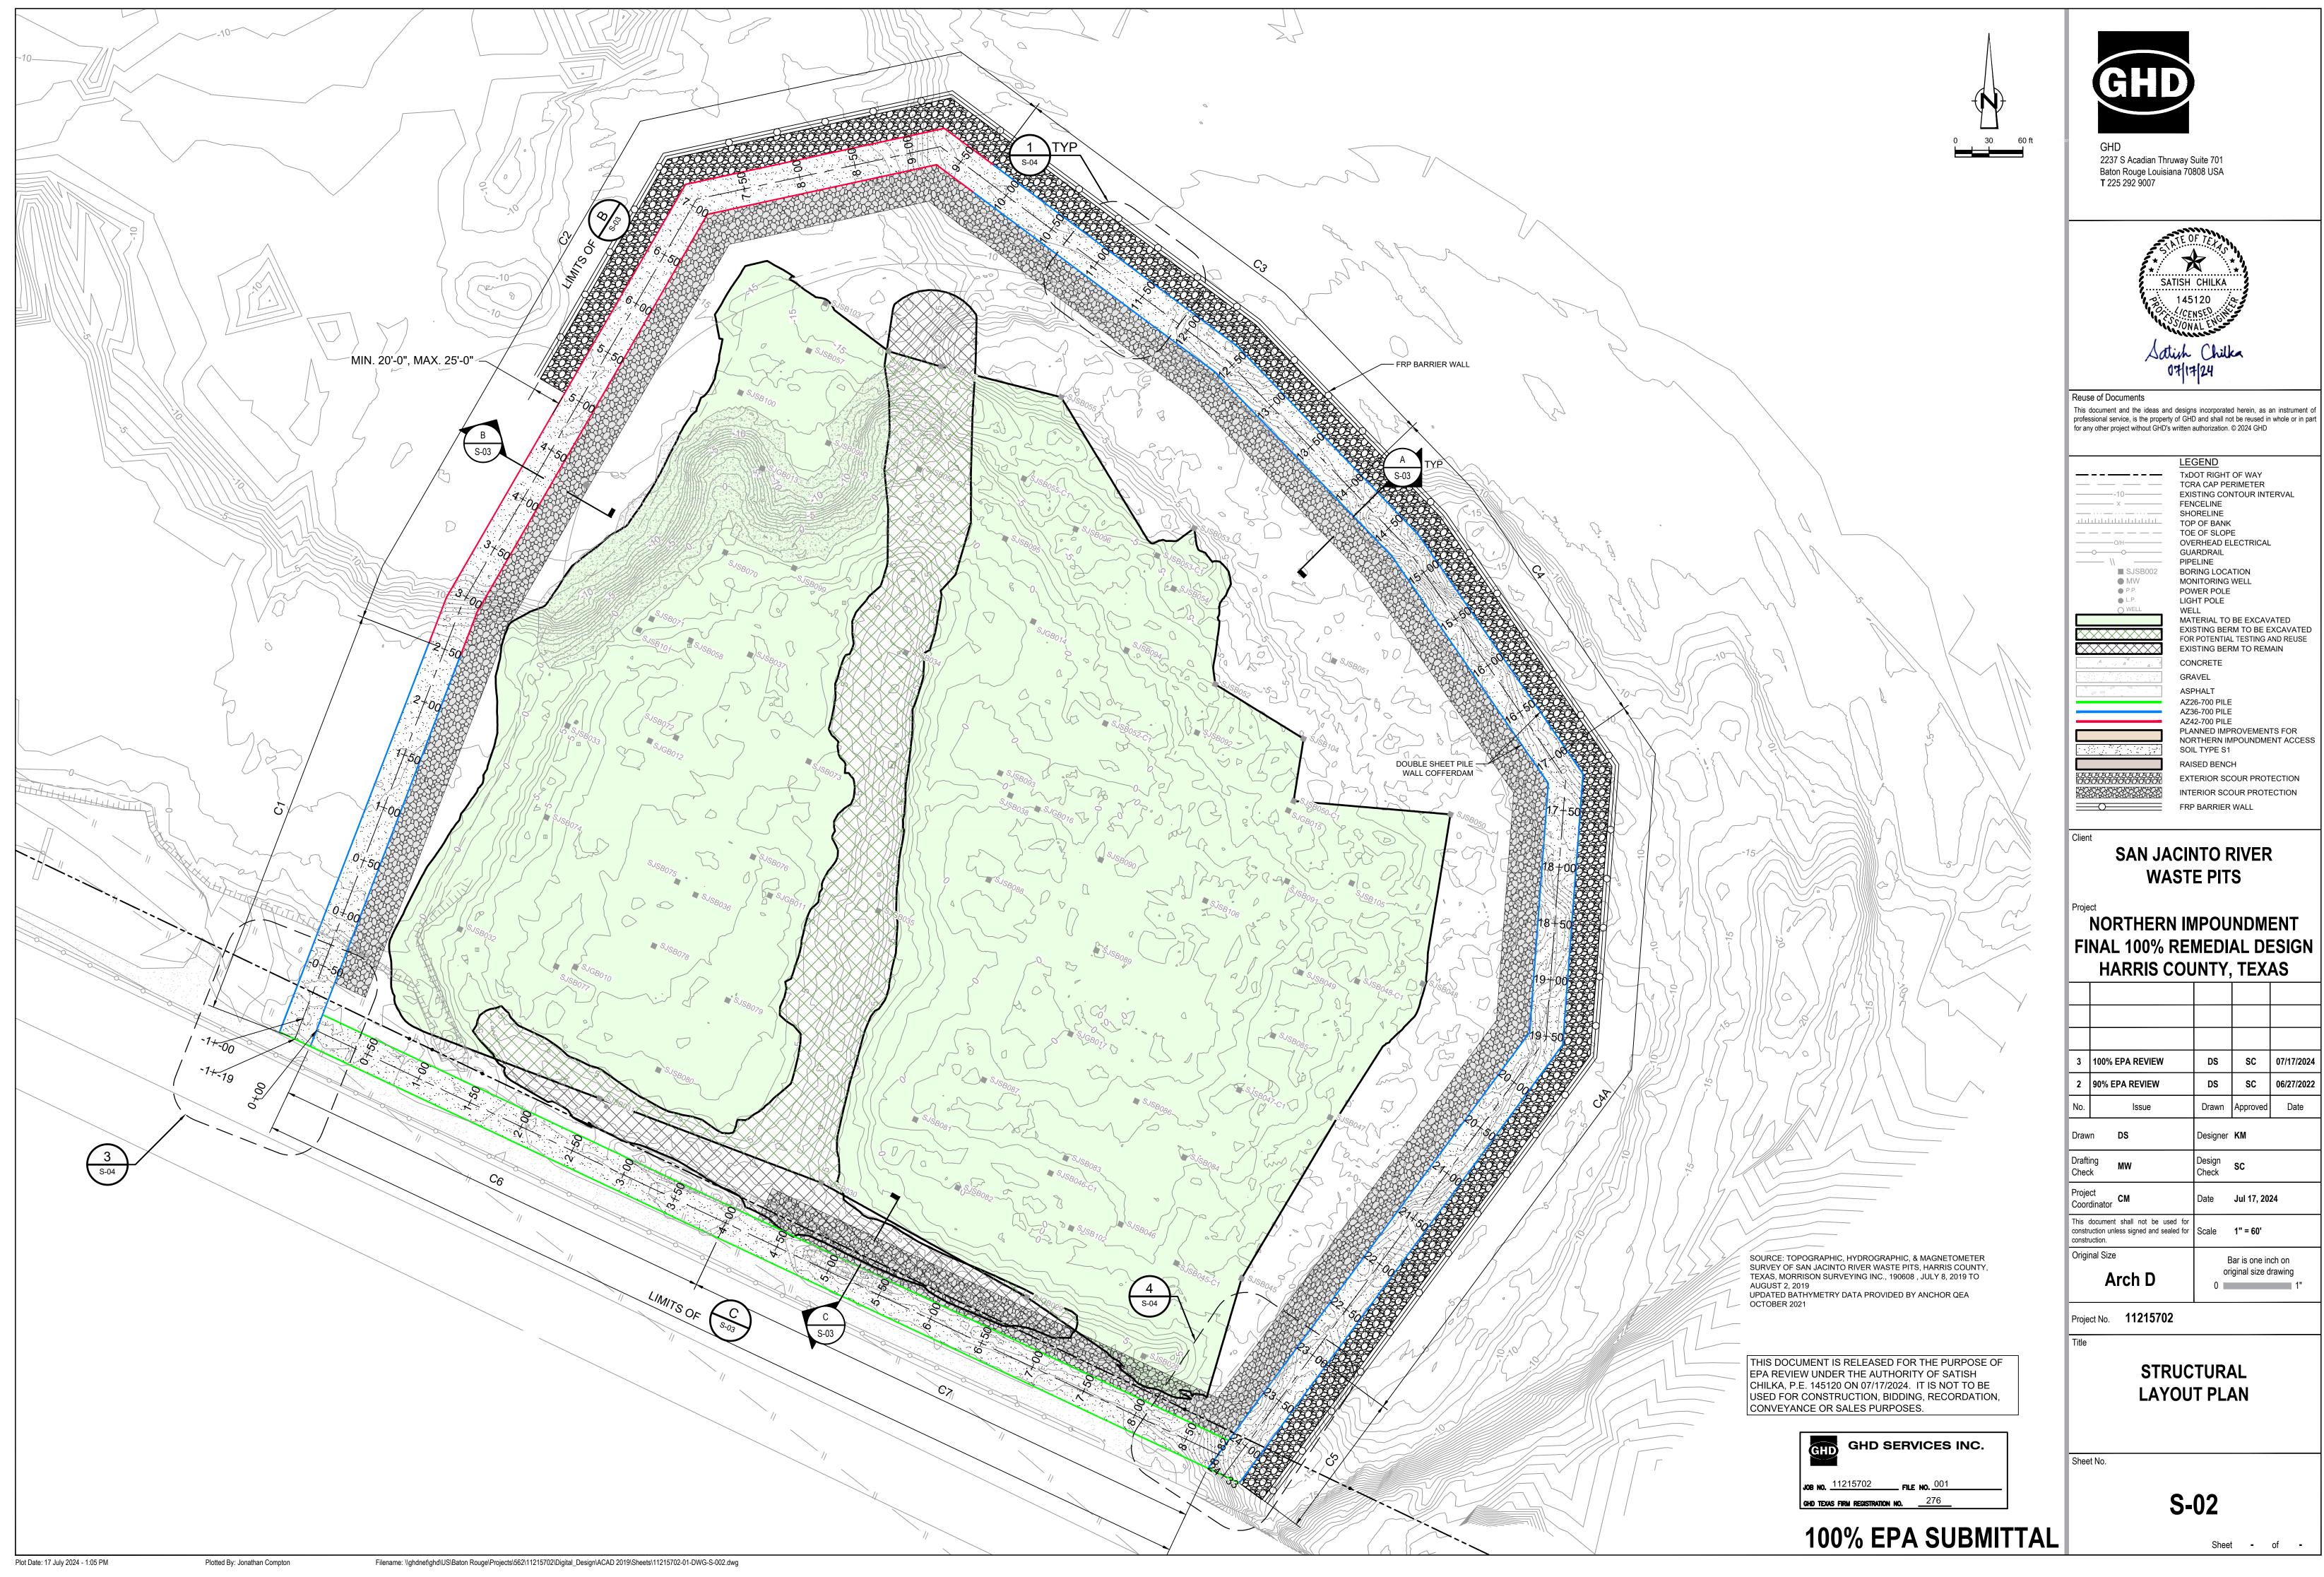

FINAL 100% REMEDIAL DESIGN

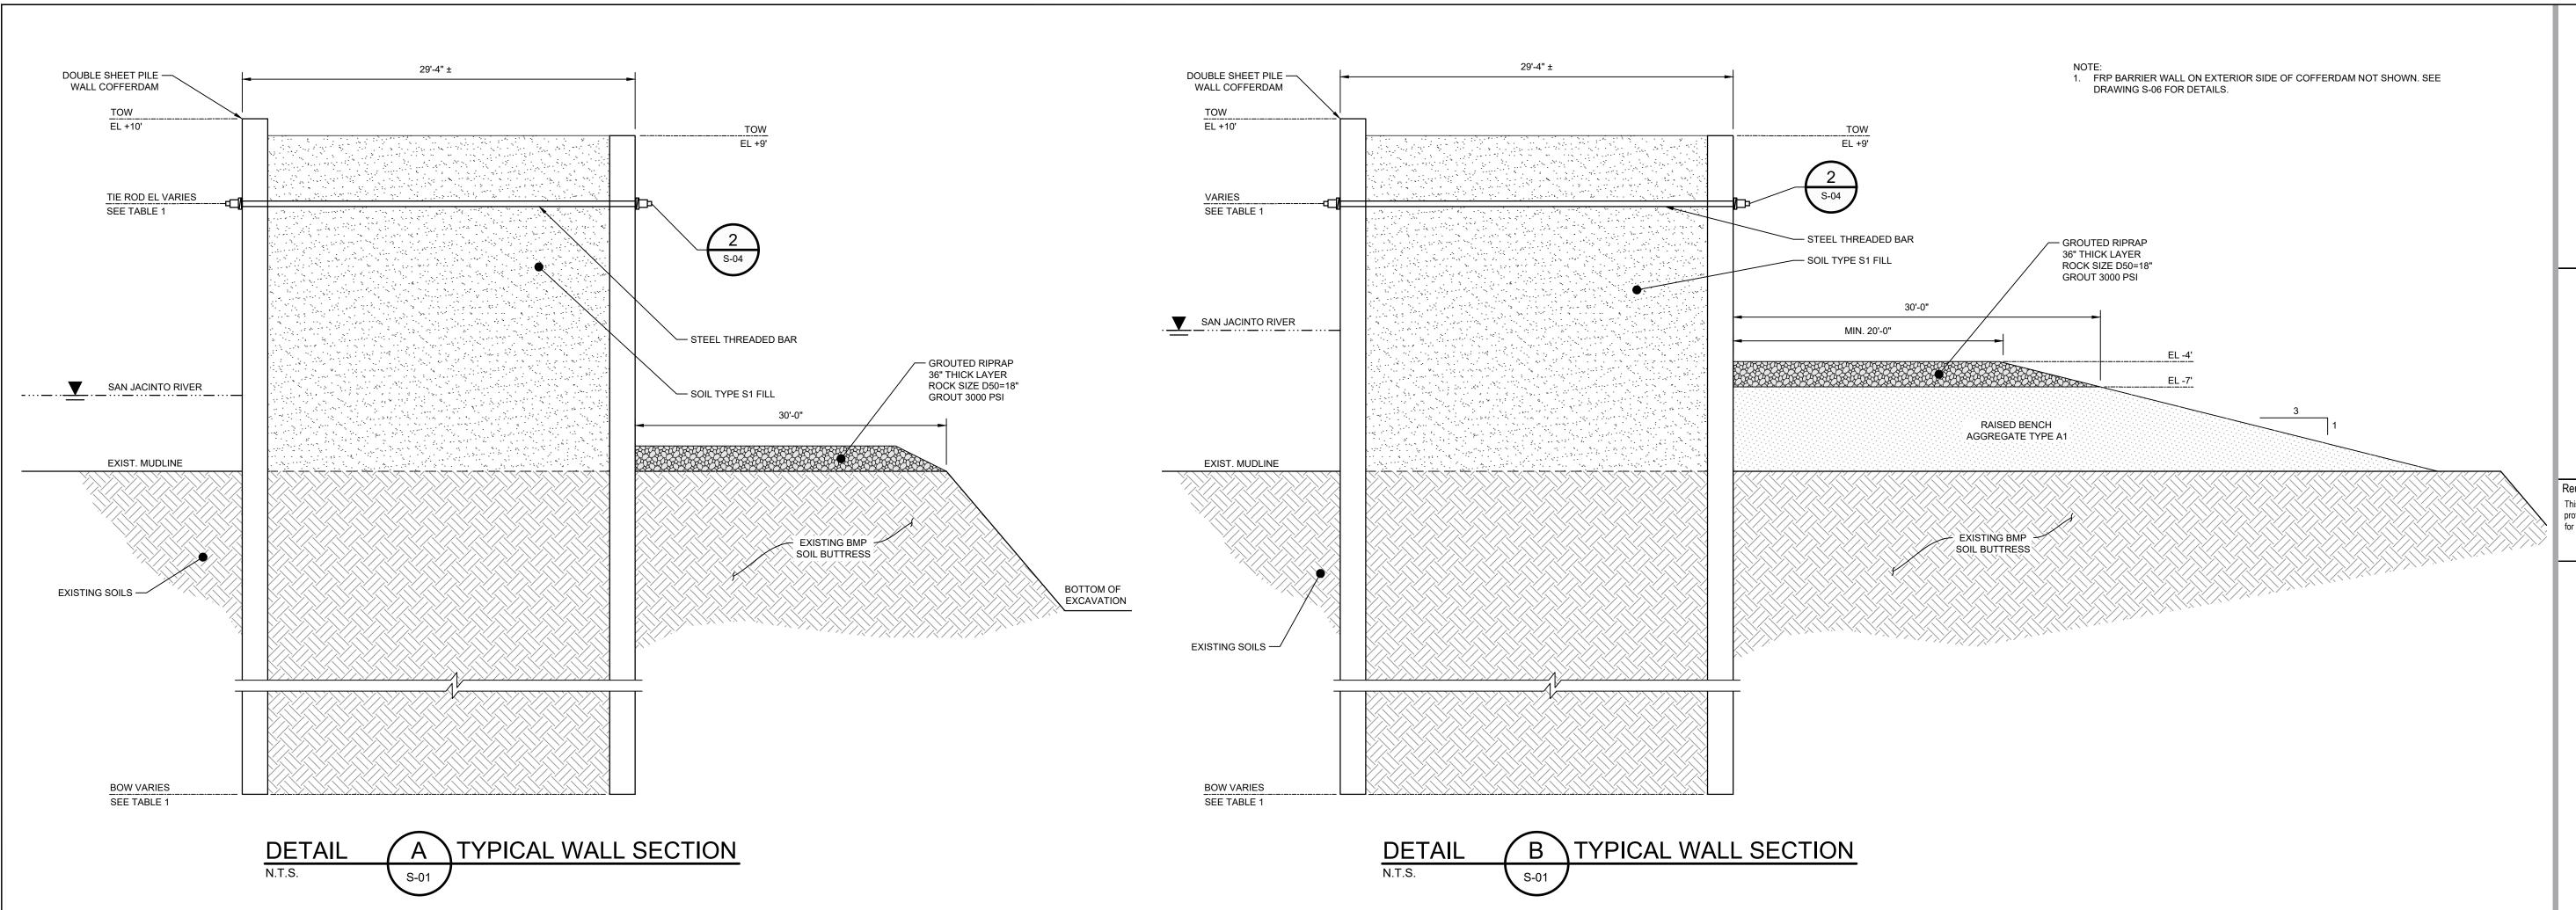


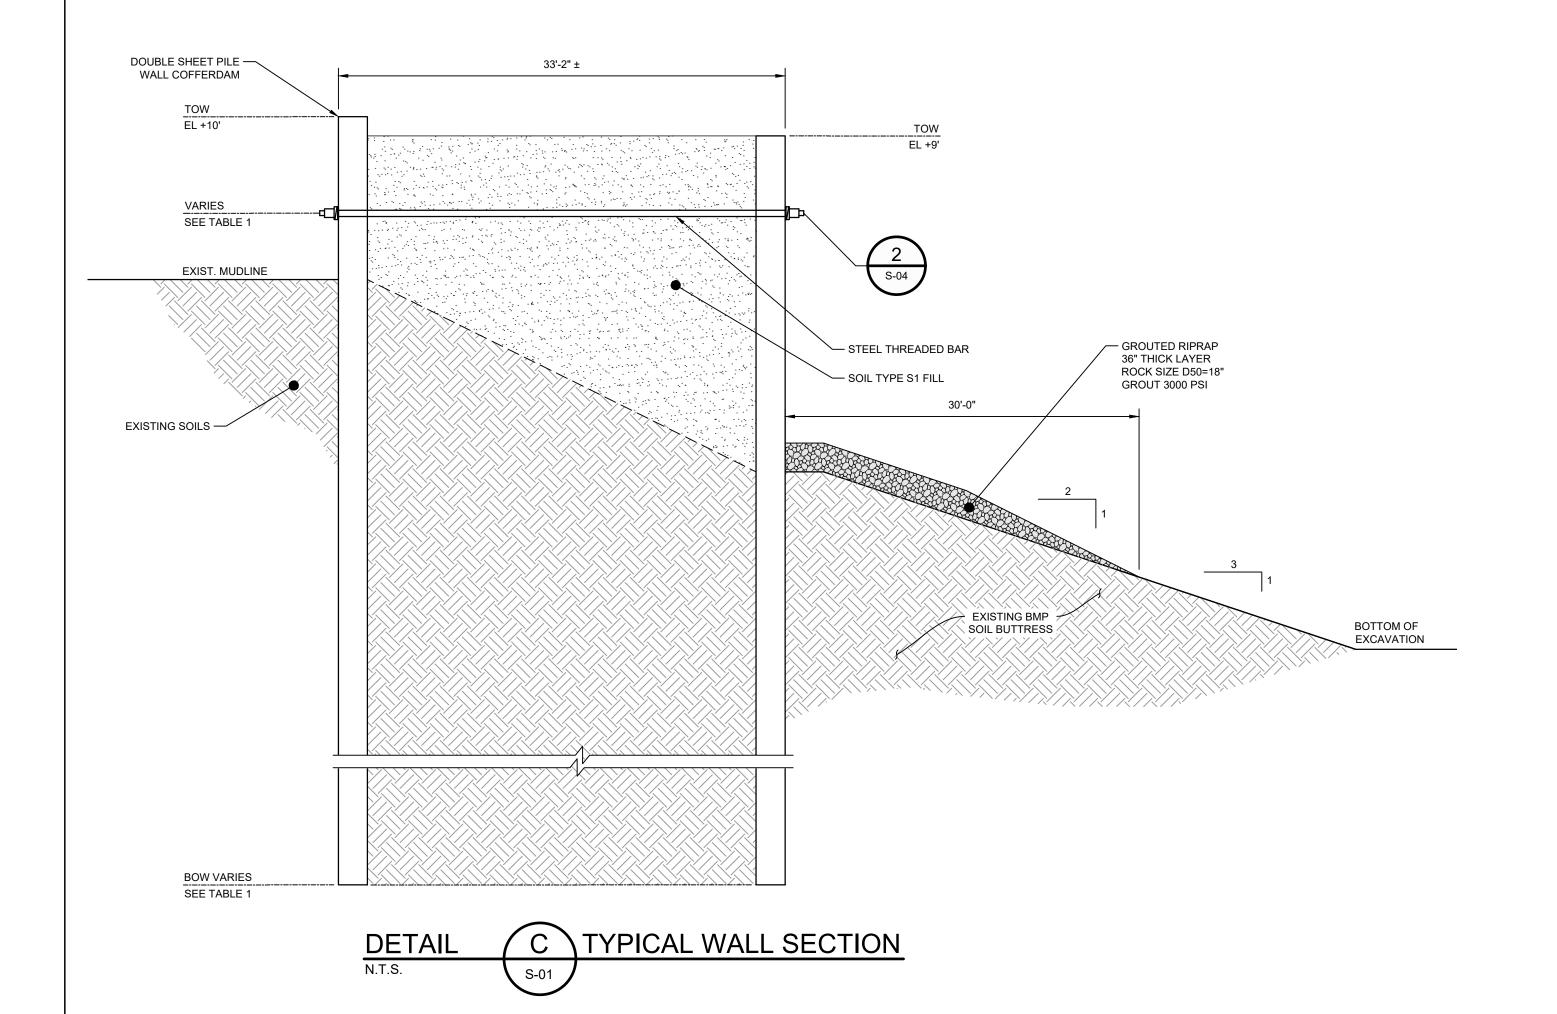


	TABLE 1								
WALL SEGMENT	START STA	END STA	DETAIL	SHEET PILE SECTION	SHEET PILE LENGTH (FT)	TIE ROD NOMINAL DIAMETER (IN)	TIE ROD SPACING (FT)	TIE ROD EL (FT)	
C1	-1+10	2+50	А	AZ36-700N	50		5	3	
C2	2+50	9+75	В	AZ42-700N	55		5	3	
C3	9+75	14+00	А	AZ36-700N	50		5	3	
C4	14+00	17+00	Α	AZ36-700N	50	SEE TABLE 2 ON	5	3	
C4A	17+00	23+00	А	AZ36-700N	50	S-04	5	3	
C5	23+00	24+33	А	AZ36-700N	60]	5	3	
C6	0+00	4+00	С	AZ26-700	60] [5	3	
C7	4+00	8+82	С	AZ26-700	60]	5	3	

MINIMUM STEEL SHEET PILE											
		YIELD	WIDTH w	HEIGHT h	THICKNESS (IN)				WEIGHT		ELASTIC
SSP SECTION	ASTM	STRENGTH (KSI)	(IN)	(IN)	FLANGE tf	WEB tw	SINGLE PILE (LB/FT)	WALL AREA (LB/FT2)	MODULUS (IN3/FT)		
AZ26-700	A572	60	27.56	18.11	0.480	0.480	69.12	30.10	48.4		
AZ36-700N	A572	60	27.56	19.65	0.591	0.441	79.72	34.71	66.8		
AZ42-700N	A572	60	27.56	19.65	0.709	0.551	95.51	41.59	78.2		



THIS DOCUMENT IS RELEASED FOR THE PURPOSE OF EPA REVIEW UNDER THE AUTHORITY OF SATISH CHILKA, P.E. 145120 ON 07/17/2024. IT IS NOT TO BE USED FOR CONSTRUCTION, BIDDING, RECORDATION, CONVEYANCE OR SALES PURPOSES.

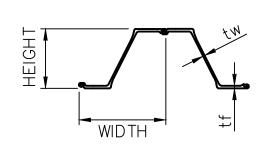

100% EPA SUBMITTAL

GHD	
GHD 2237 S Acadian Thruway Suit	e
Baton Rouge Louisiana 70808	

3 USA **T** 225 292 9007



This document and the ideas and designs incorporated herein, as an instrument of professional service, is the property of GHD and shall not be reused in whole or in part for any other project without GHD's written authorization. © 2024 GHD

> **SAN JACINTO RIVER WASTE PITS**

NORTHERN IMPOUNDMENT FINAL 100% REMEDIAL DESIGN HARRIS COUNTY, TEXAS

}	100% EPA REVIEW	DS	sc	07/17/20
)	90% EPA REVIEW	DS	sc	06/27/20
٥.	Issue	Drawn	Approved	Date
aw	n DS	Designer	KM	
afti nec	ng k MW	Design Check	sc	
oje or	ct dinator	Date	Jul 17, 202	24
nstr	document shall not be used for uction unless signed and sealed for uction.	Scale	N.T.S.	_


Original Size Bar is one inch on original size drawing Arch D


Project No. **11215702**

STRUCTURAL SECTIONS

Sheet No.

S-03

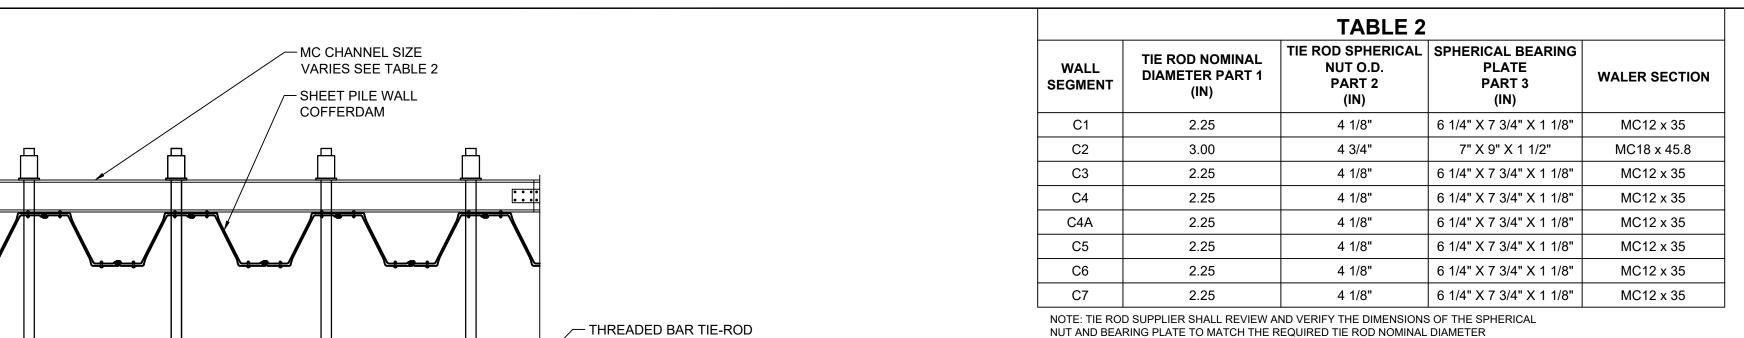

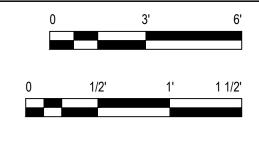



2237 S Acadian Thruway Suite 701 Baton Rouge Louisiana 70808 USA **T** 225 292 9007



Reuse of Documents

This document and the ideas and designs incorporated herein, as an instrument of professional service, is the property of GHD and shall not be reused in whole or in part for any other project without GHD's written authorization. © 2024 GHD

SAN JACINTO RIVER WASTE PITS

NORTHERN IMPOUNDMENT FINAL 100% REMEDIAL DESIGN HARRIS COUNTY, TEXAS

ı					
ı					
ı	3	100% EPA REVIEW	DS	SC	07/17/20
ı	2	90% EPA REVIEW	DS	SC	06/27/20
ı	No.	Issue	Drawn	Approved	Date
l	Draw	n DS	Designer	KM	
l	Drafti Chec	° IVIVV	Design Check	sc	
l	Proje Coor	ct dinator	Date	Jul 17, 202	24
		document shall not be used for uction unless signed and sealed for uction.	Scale	AS SHOW	'N
ı	Origi	nal Size	В	ar is one in	ch on

Project No. **11215702**

Arch D


STRUCTURAL DETAILS 1 of 2

original size drawing

Sheet No.

S-04

Sheet - of -

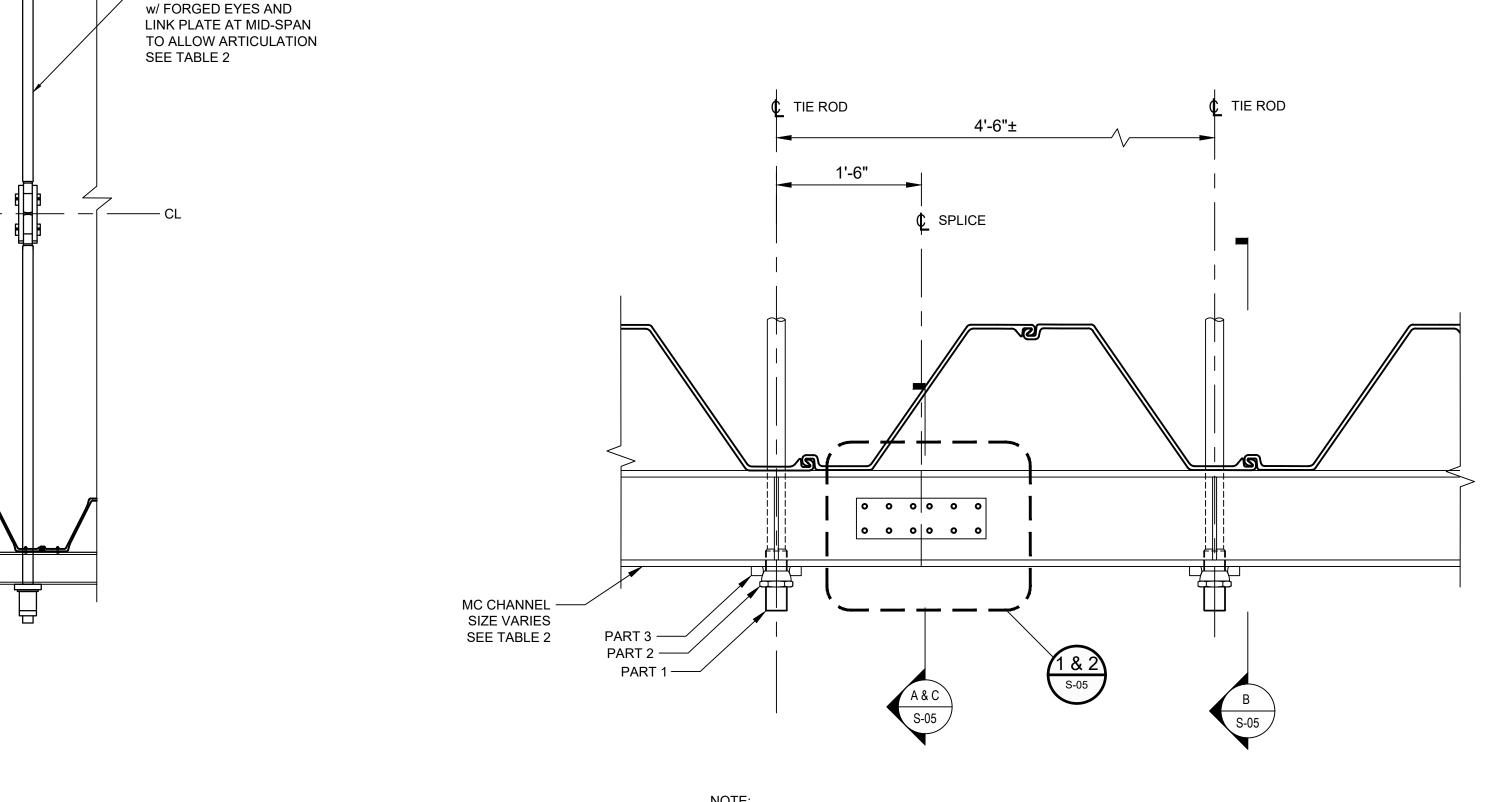

1. STAGGER WALER SPLICE ON INTERIOR AND EXTERIOR WALL BY 10'-0" +/-

2. WELD 1/2" THICK STEEL PLATES BETWEEN T&B WALERS TO MAINTAIN SPACING

2 PLAN VIEW

29'-4" ± 4'-6"± TYP

3 PLAN VIEW


SHEET PILE WALL -

MC CHANNEL SIZE -VARIES SEE TABLE 2


COFFERDAM

SCALE: 1"=3'-0"

DETAIL 1 PLAN VIEW

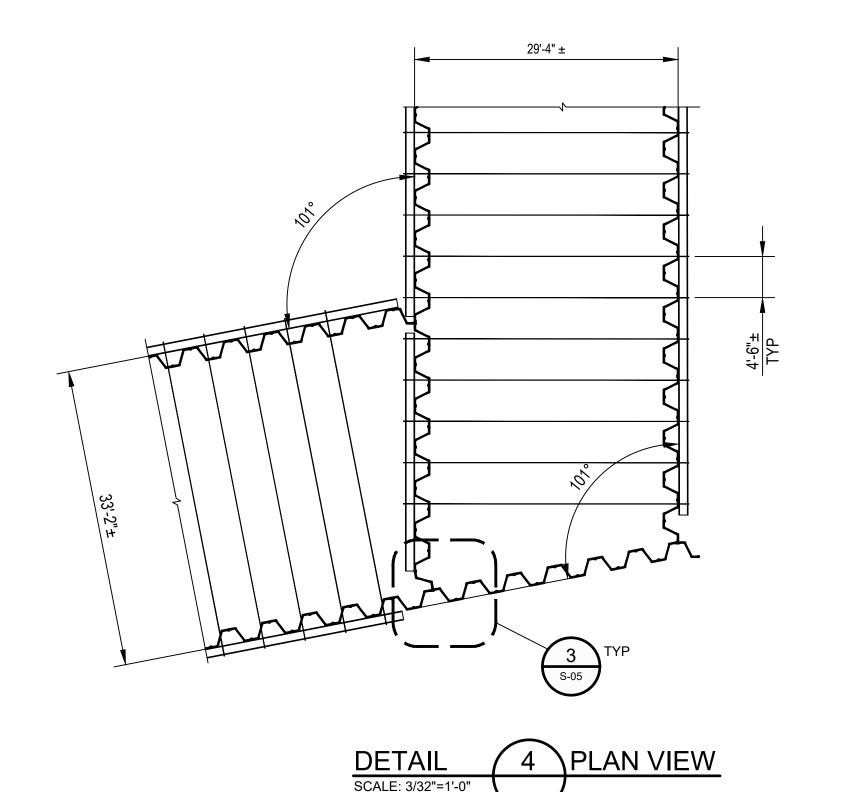


THIS DOCUMENT IS RELEASED FOR THE PURPOSE OF EPA REVIEW UNDER THE AUTHORITY OF SATISH CHILKA, P.E. 145120 ON 07/17/2024. IT IS NOT TO BE USED FOR CONSTRUCTION, BIDDING, RECORDATION, CONVEYANCE OR SALES PURPOSES.

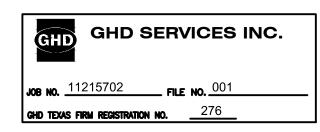



100% EPA SUBMITTAL


DETAIL SCALE: 3/32"=1'-0"


Plot Date: 17 July 2024 - 1:05 PM

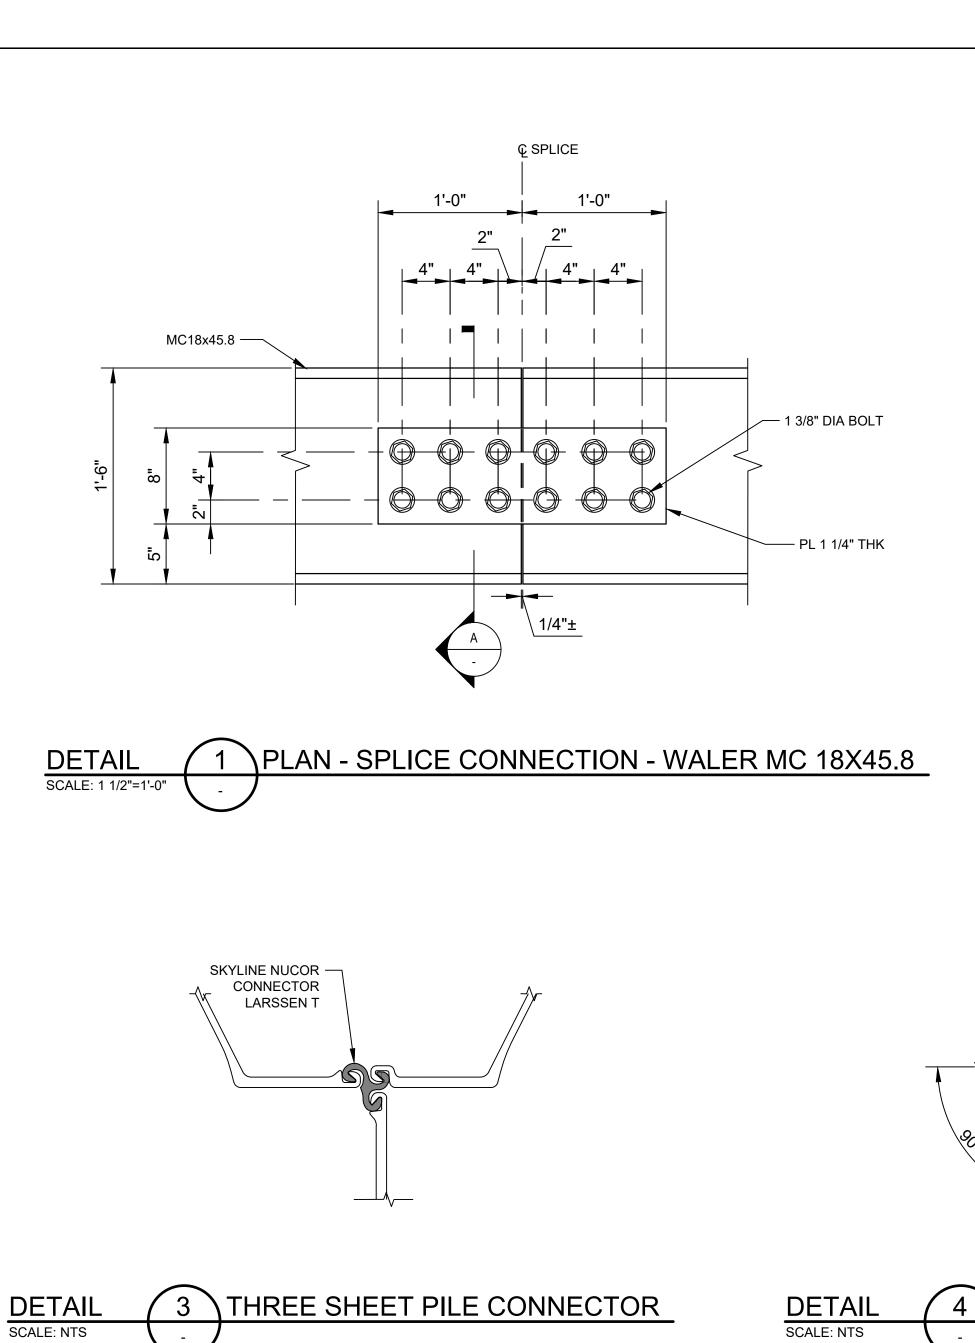


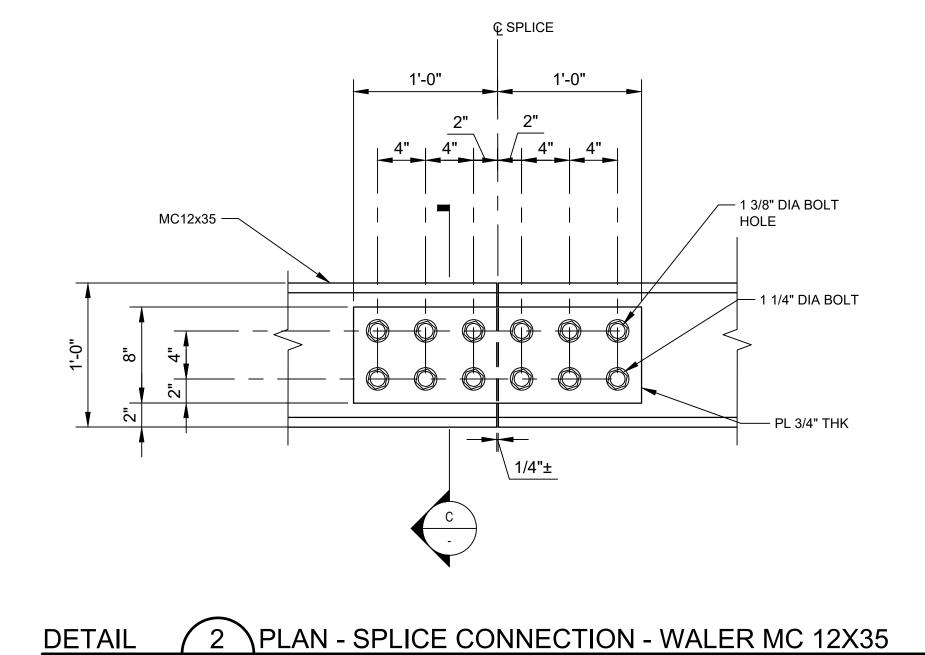

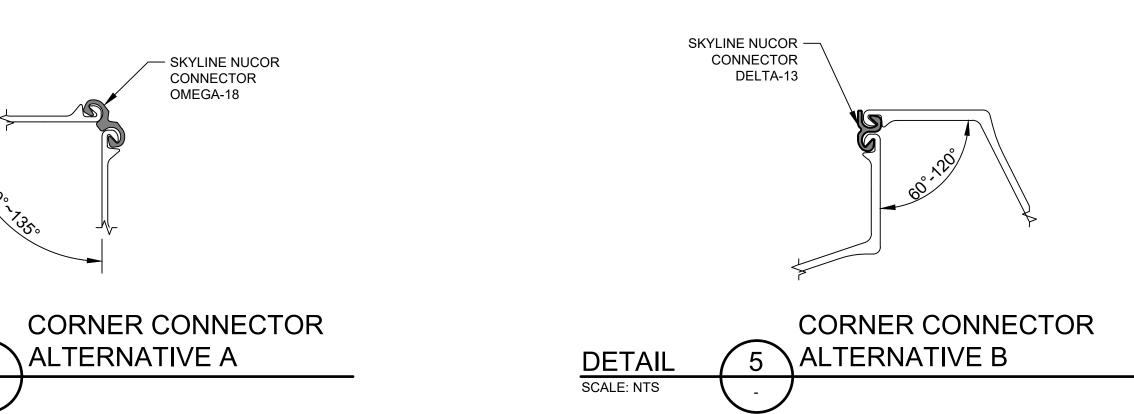

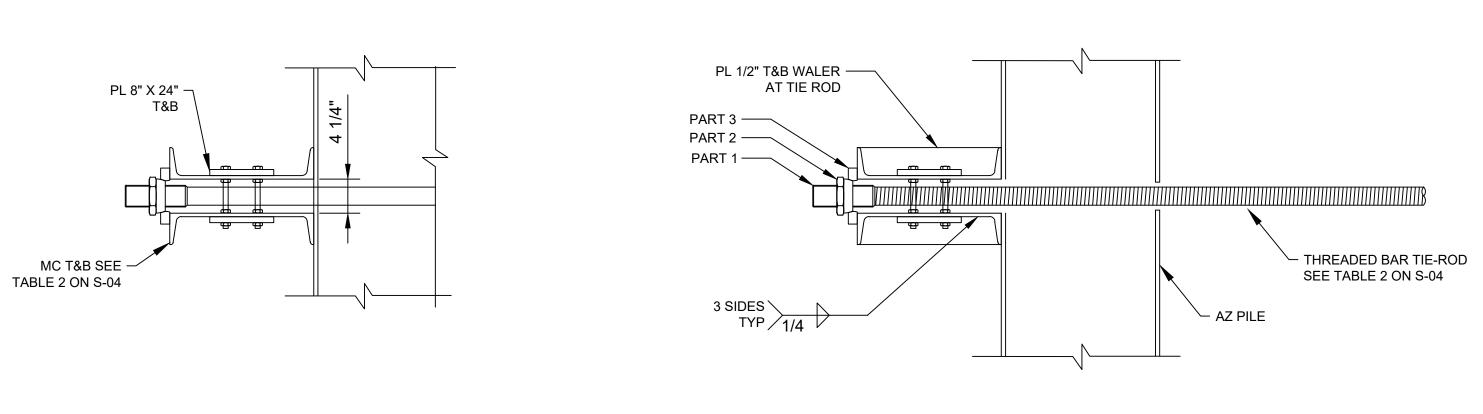

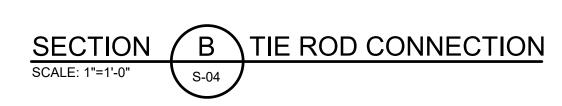

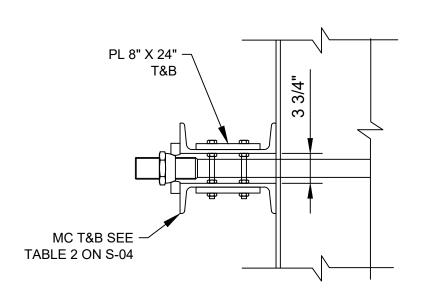

SECTION	C	SPLICE CONNECTION
SCALE: 1"=1'-0"	S-04	

THIS DOCUMENT IS RELEASED FOR THE PURPOSE OF EPA REVIEW UNDER THE AUTHORITY OF SATISH CHILKA, P.E. 145120 ON 07/17/2024. IT IS NOT TO BE USED FOR CONSTRUCTION, BIDDING, RECORDATION, CONVEYANCE OR SALES PURPOSES.



100% EPA SUBMITTAL



2237 S Acadian Thruway Suite 701 Baton Rouge Louisiana 70808 USA **T** 225 292 9007



Reuse of Documents This document and the ideas and designs incorporated herein, as an instrument of professional service, is the property of GHD and shall not be reused in whole or in part for any other project without GHD's written authorization. © 2024 GHD

> **SAN JACINTO RIVER WASTE PITS**

NORTHERN IMPOUNDMENT FINAL 100% REMEDIAL DESIGN HARRIS COUNTY, TEXAS

3	100% EPA REVIEW	DS	SC	07/17/20
2	90% EPA REVIEW	DS	sc	06/27/20
No.	Issue	Drawn	Approved	Date
Draw	n DS	Designer	KM	
Draft Chec	- IVIVV	Design Check	sc	
Proje Coor	ct dinator CM	Date	Jul 17, 20	24
constr	document shall not be used for uction unless signed and sealed for uction.	Scale	AS SHOW	/N

Original Size Bar is one inch on original size drawing Arch D

Project No. **11215702**

STRUCTURAL


DETAILS 2 OF 2

Sheet No.


S-05

Sheet - of -


A SPLICE CONNECTION

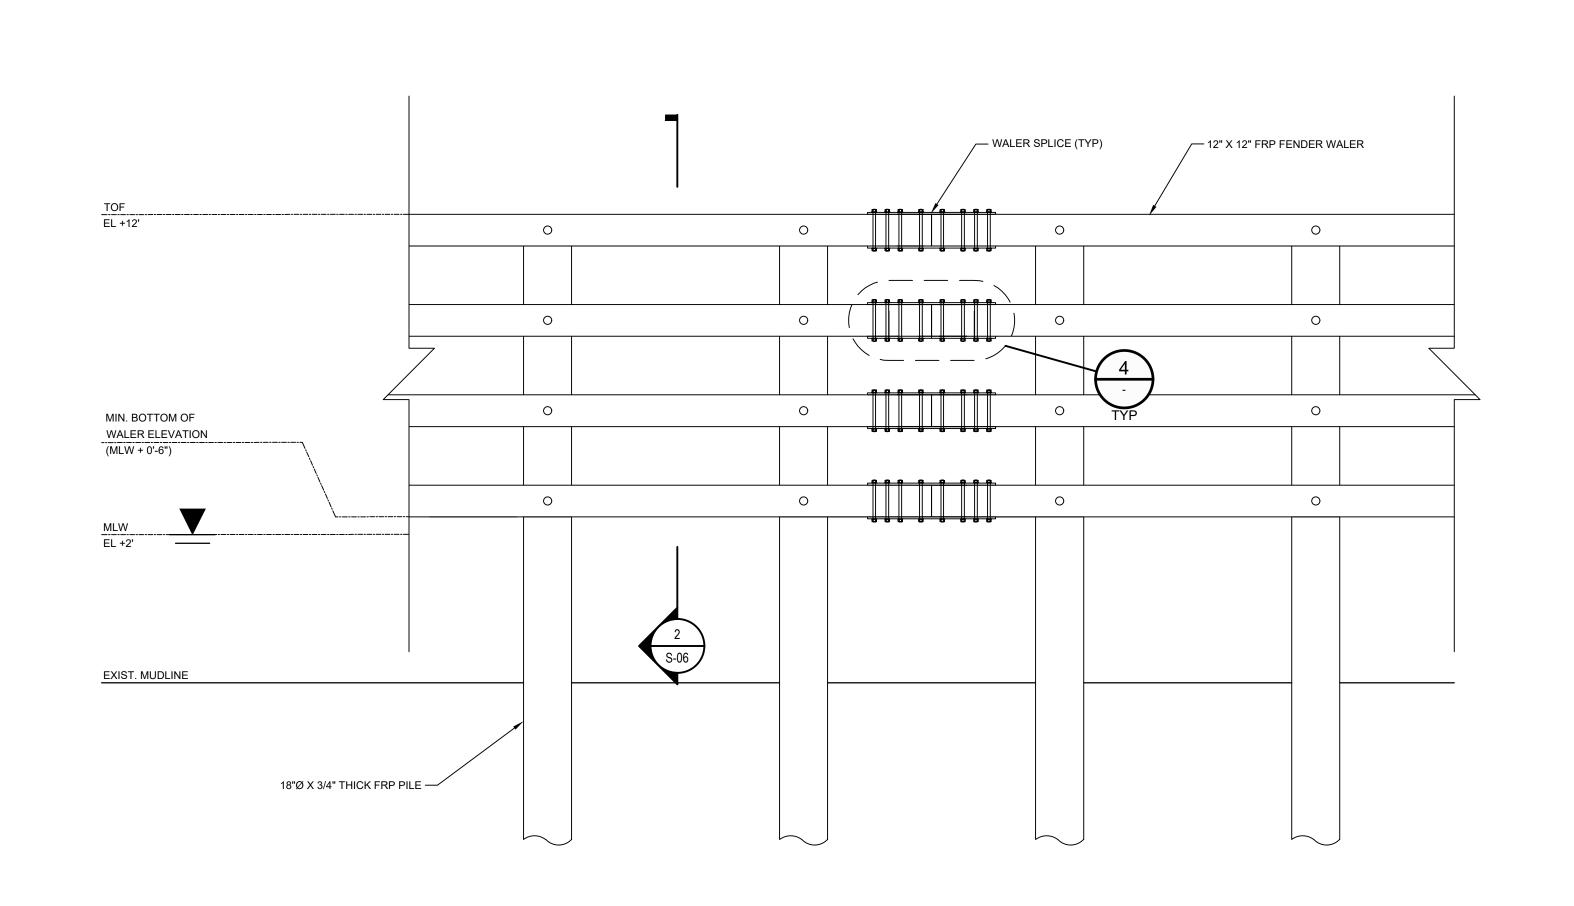



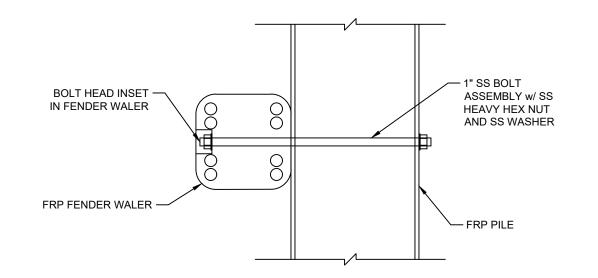




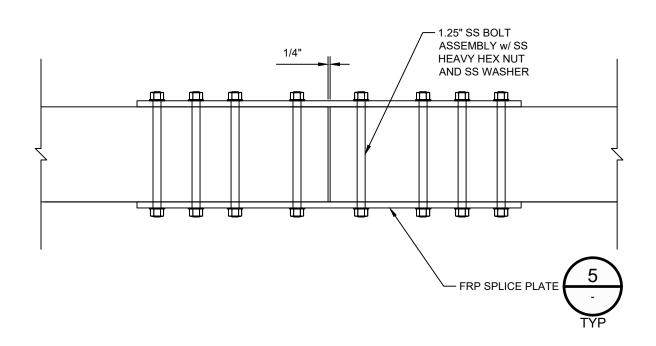


DETAIL
SCALE: 1"=1'-0"

4 TYPICAL WALER SECTION
S-06

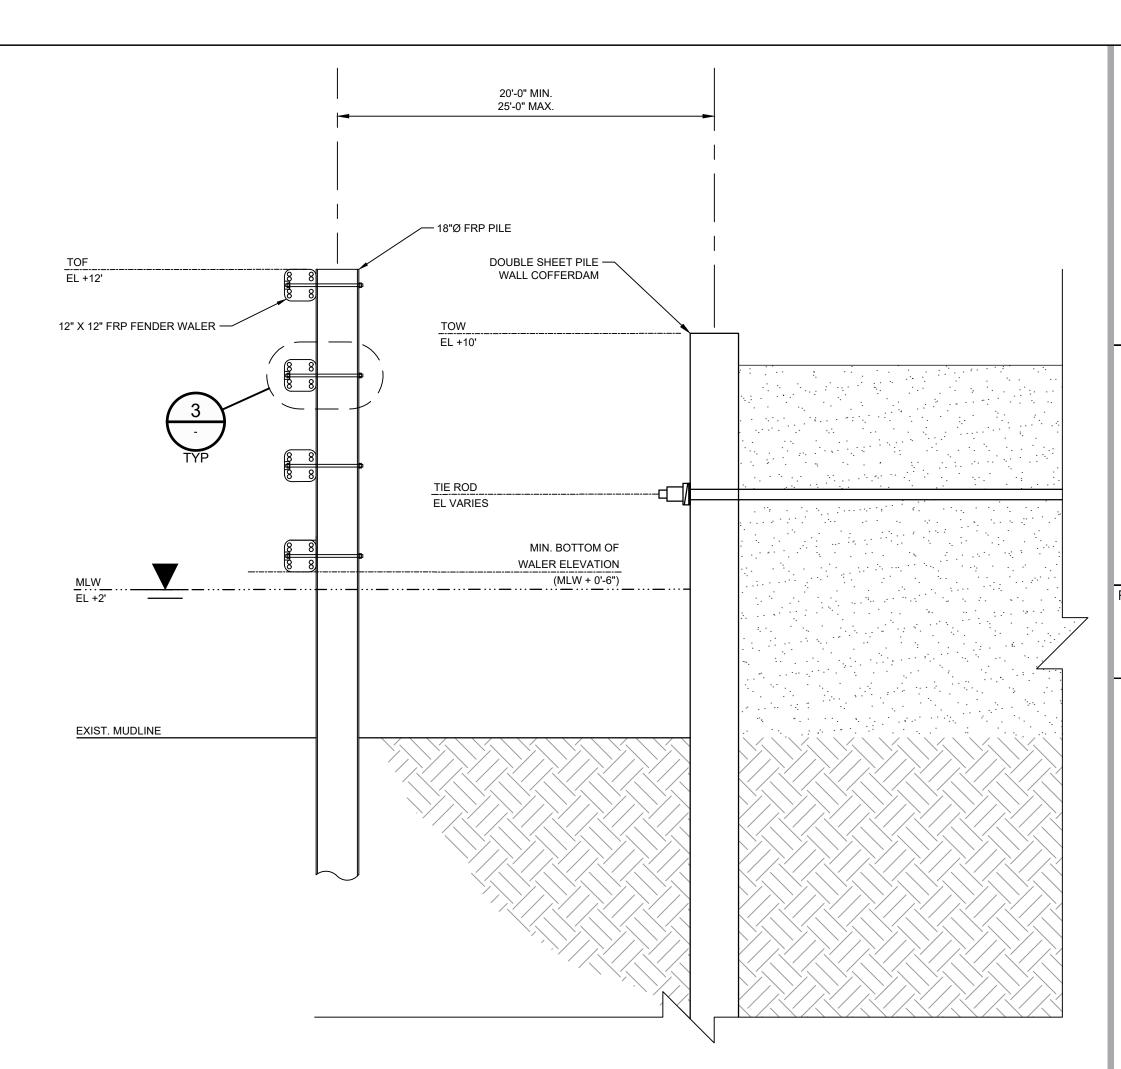

DETAIL
SCALE: 1"=3'-0"

TYPICAL FRP BARRIER SECTION
S-06

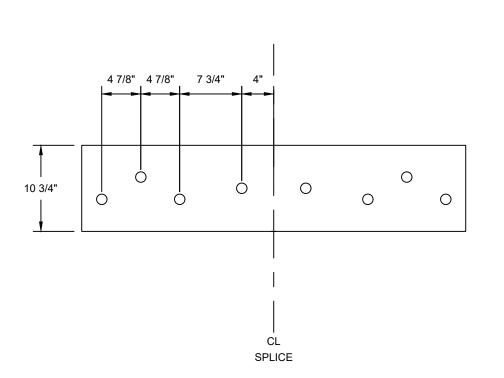

DETAIL
SCALE: 1"=1'-0"

5 TYPICAL BOLT PATTERN FOR FRP SPLICE PLATE

5 S-06


THIS DOCUMENT IS RELEASED FOR THE PURPOSE OF EPA REVIEW UNDER THE AUTHORITY OF SATISH CHILKA, P.E. 145120 ON 07/17/2024. IT IS NOT TO BE USED FOR CONSTRUCTION, BIDDING, RECORDATION, CONVEYANCE OR SALES PURPOSES.



100% EPA SUBMITTAL



GHD
2237 S Acadian Thruway Suite 701
Baton Rouge Louisiana 70808 USA
T 225 292 9007

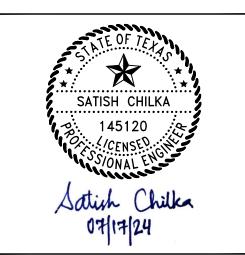

Reuse of Documents

This document and the ideas and designs incorporated herein, as an instrument of professional service, is the property of GHD and shall not be reused in whole or in part for any other project without GHD's written authorization. © 2024 GHD

SAN JACINTO RIVER
WASTE PITS

NORTHERN IMPOUNDMENT FINAL 100% REMEDIAL DESIGN HARRIS COUNTY, TEXAS

3	100% EPA REVIEW	DS	SC	07/17/20
2	90% EPA REVIEW	DS	SC	06/27/202
No.	Issue	Drawn	Approved	Date
Draw	n DS	Designer	KM	
Drafti Chec	- IVIVV	Design Check	sc	
Proje Coor	ct dinator CM	Date	Jul 17, 20	24
	document shall not be used for uction unless signed and sealed for uction.	Scale	N.T.S.	
Origi	nal Size	В	Bar is one in	ch on

Project No. 11215702


Arch D

FRP BARRIER WALL

Sheet No.

S-06

original size drawing

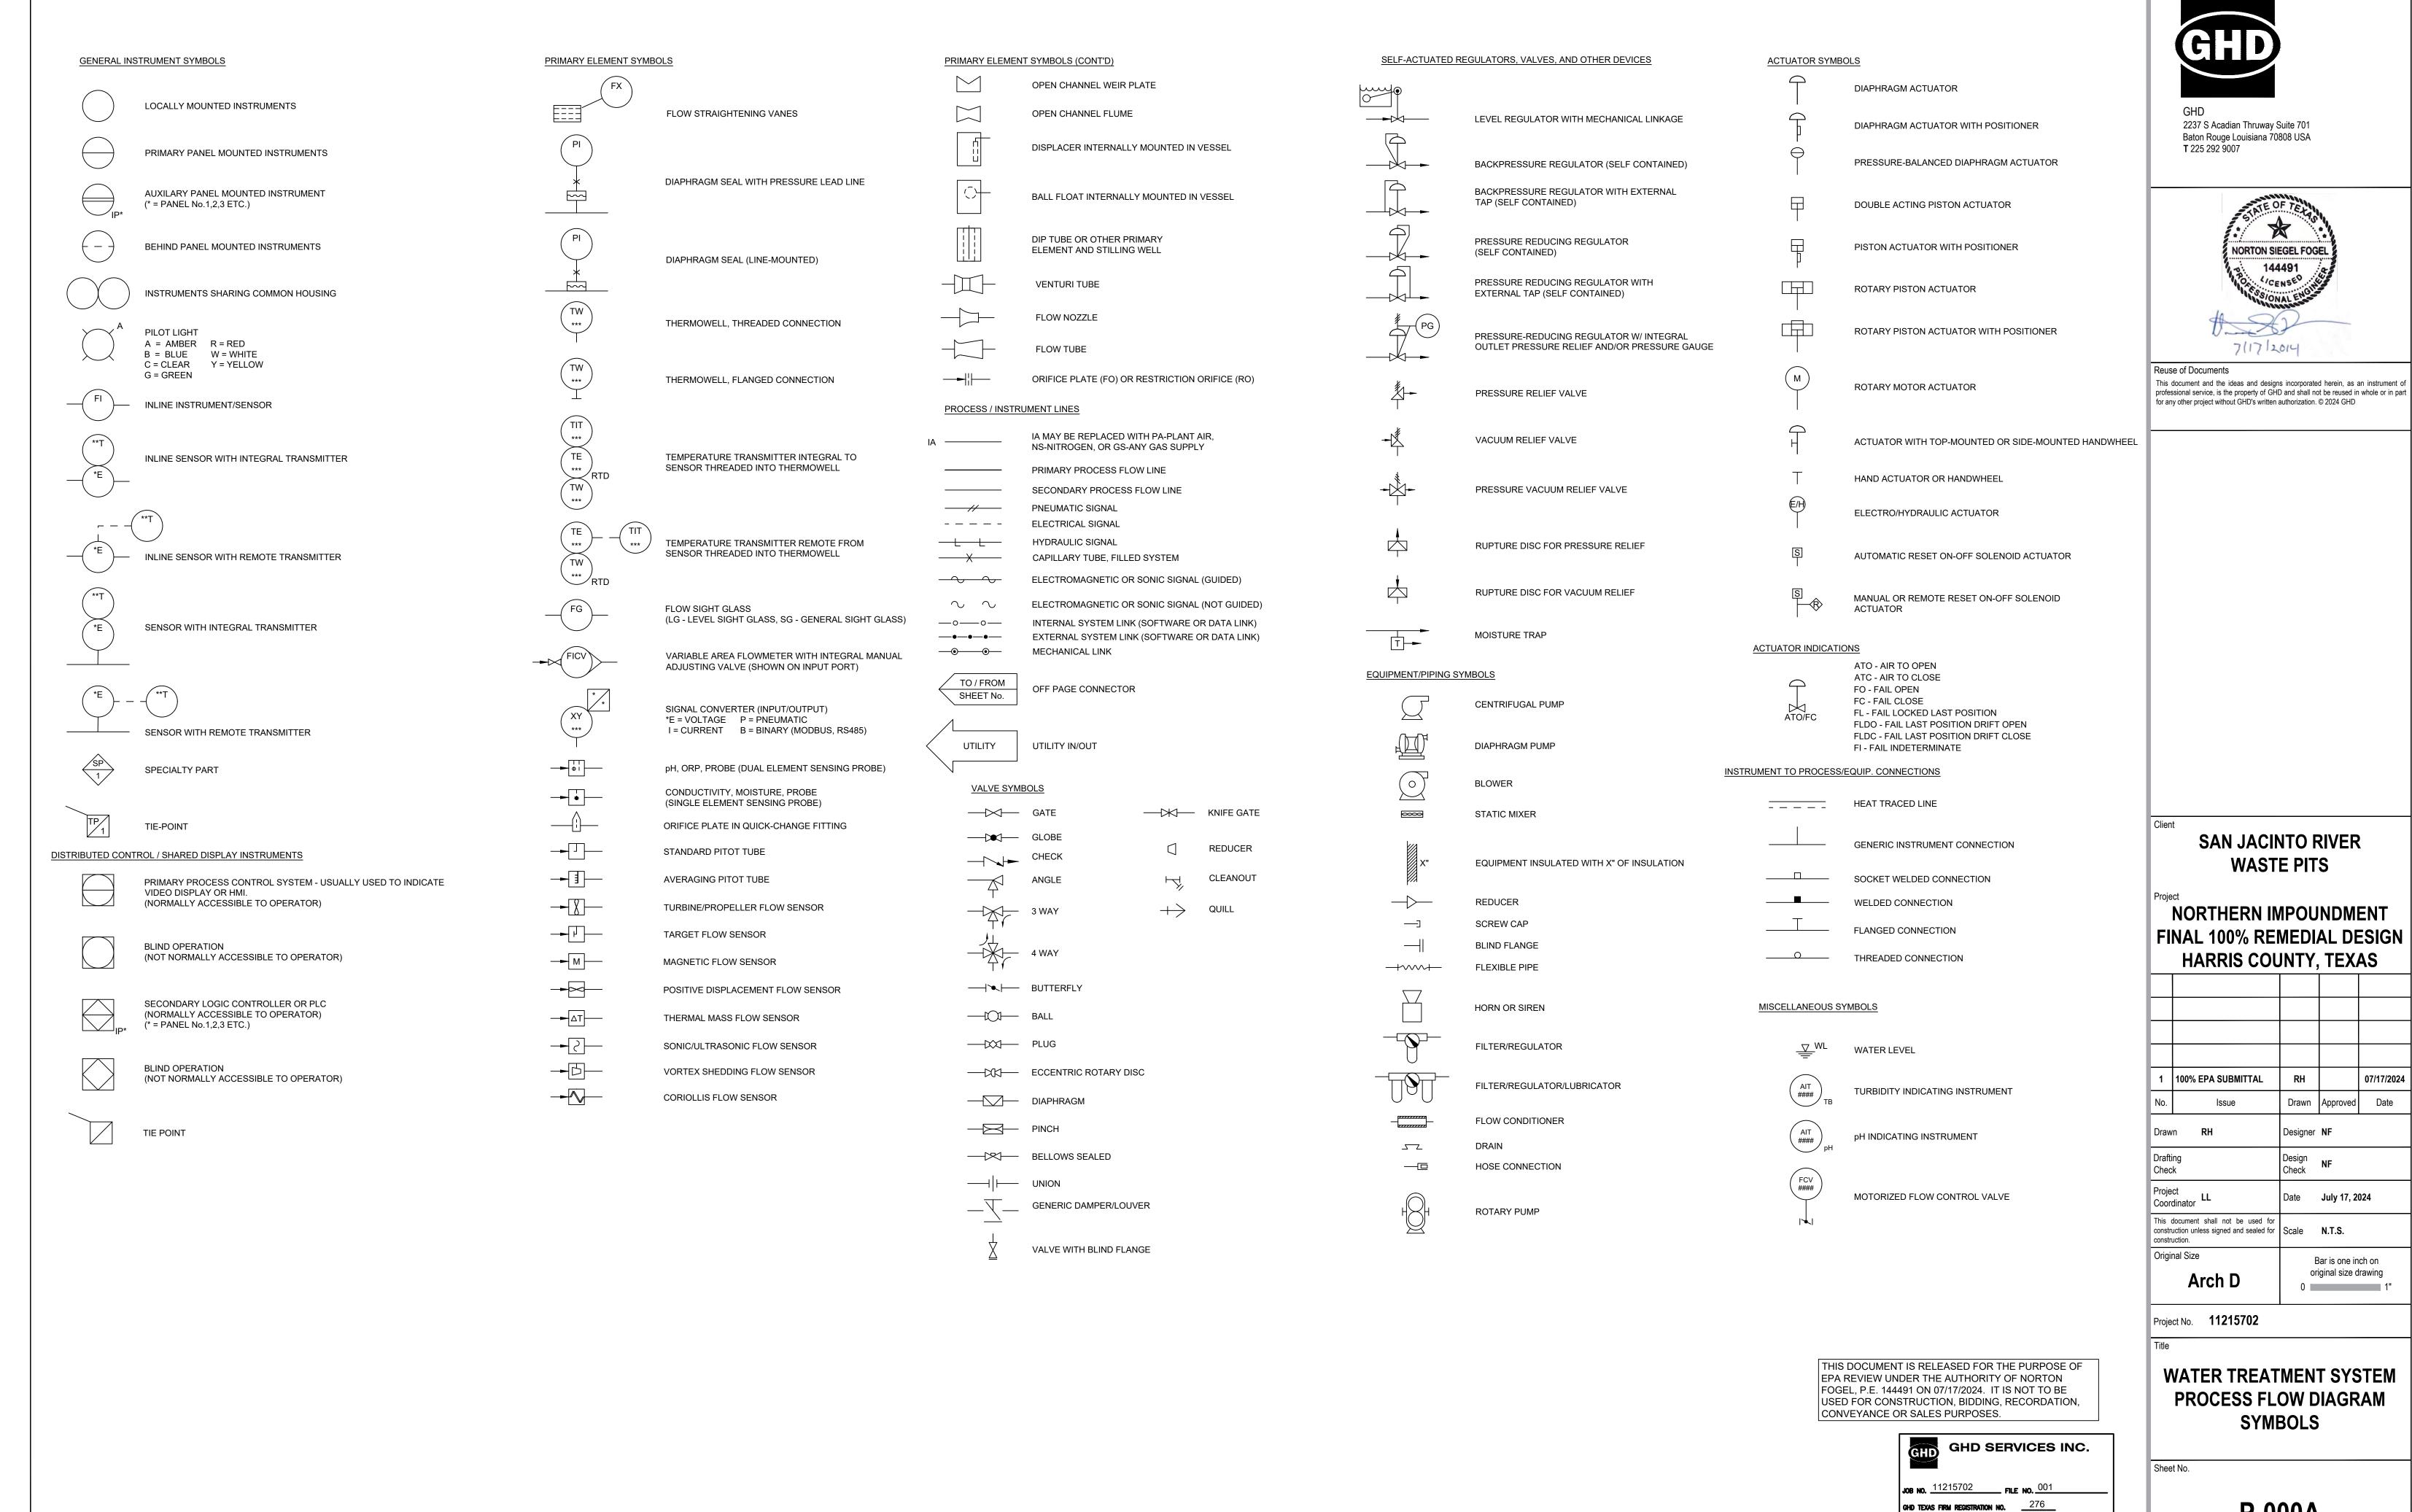

Filename: \\ghdnet\ghd\US\Baton Rouge\Projects\562\11215702\Digital_Design\ACAD 2019\Sheets\11215702-01-DWG-P-000A.dwg

Plot Date: 17 July 2024 - 1:06 PM

Plotted By: Jonathan Compton

P-000ASheet - of -

100% EPA SUBMITTAL

TYPICAL INTERNATIONAL SOCIETY OF AUTOMATION LETTER COMBINATIONS

F: .			Cont	rollers	Self- Actuated	Readout [)evices		witches a		Tı	ransmitteı	rs	Solenoids, Relays,	D :	T .	Well	Viewing		F: 1
First- Letters	Initiating or Measured Variable	Recording	gIndicatin	g Blind	Control Valves	Recording	Indicating	High **	Low	Comb	Recording	gIndicatin	g Blind	Computing Devices	Element	Test Point	or Probe	Device, Glass	Safety Device	Final Element
A	Analysis	ARC	AIC	AC		AR	Al	ASH	ASL	ASHL	ART	AIT	AT	AY	AE	AP	AW			AV
В	Burner/Combustion	BRC	BIC	ВС		BR	ВІ	BSH	BSL	BSHL	BRT	BIT	ВТ	BY	BE		BW	BG		BZ
С	User's Choice																			
D	User's Choice																			
E	Voltage	ERC	EIC	EC		ER	El	ESH	ESL	ESHL	ERT	EIT	ET	EY	EE					EZ
F	Flow Rate	FRC	FIC	FC	FCV,	FR	FI	FSH	FSL	FSHL	FRT	FIT	FT	FY	FE	FP		FG		FV
FQ	Flow Quantity	FQRC	FQIC		FICV	FQR	FQI	FQSH	FQSL			FQIT	FQT	FQY	FQE					FQV
FF	Flow Ratio	FFRC	FFIC	FFC		FFR	FFI	FFSH	FFSL						FE					FFV
G	User's Choice																			
н	Hand		HIC	HC						HS										HV
ı	Current	IRC	IIC			IR	II	ISH	ISL	ISHL	IRT	IIT	IT	IY	IE					IZ
J	Power	JRC	JIC			JR	JI	JSH	JSL	JSHL	JRT	JIT	JT	JY	JE					JV
К	Time	KRC	KIC	KC	KCV	KR	KI	KSH	KSL	KSHL	KRT	KIT	KT	KY	KE					KV
L	Level	LRC	LIC	LC	LCV	LR	LI	LSH	LSL	LSHL	LRT	LIT	LT	LY	LE		LW	LG		LV
М	User's Choice																			
N	User's Choice																			
0	User's Choice																			
Р	Pressure/Vacuum	PRC	PIC	PC	PCV	PR	PI	PSH	PSL	PSHL	PRT	PIT	PT	PY	PE	PP			PSV,	PV
PD	Pressure, Differential	PDRC	PDIC	PDC	PDCV	PDR	PDI	PDSH	PDSL		PDRT	PDIT	PDT	PDY	PE	PP			PSE	PDV
Q	Quantity	QRC	QIC			QR	QI	QSH	QSL	QSHL	QRT	QIT	QT	QY	QE					QZ
R	Radiation	RRC	RIC	RC		RR	RI	RSH	RSL	RSHL	RRT	RIT	RT	RY	RE		RW			RZ
S	Speed/Frequency	SRC	SIC	SC	SCV	SR	SI	SSH	SSL	SSHL	SRT	SIT	ST	SY	SE					SV
Т	Temperature	TRC	TIC	TC	TCV	TR	TI	TSH	TSL	TSHL	TRT	TIT	TT	TY	TE	TP	TW		TSE	TV
TD	Temperature, Differential	TDRC	TDIC	TDC	TDCV	TDR	TDI	TDSH	TDSL		TDRT	TDIT	TDT	TDY	TE	TP	TW			TDV
U	Multivariable					UR	UI							UY						UV
V	Vibration/Machinery Analysis					VR	VI	VSH	VSL	VSHL	VRT	VIT	VT	VY	VE					VZ
W	Weight/Force	WRC	WIC	WC	WCV	WR	WI	WSH	WSL	WSHL	WRT	WIT	WT	WY	WE					WZ
WD	Weight/Force, Differential	WDRC	WDIC	WDC	WDCV	WDR	WDI	WDSH	WDSL		WDRT	WDIT	WDT	WDY	WE					WDZ
X	Unclassified																			
Y	Event/State/Presence		YIC	YC		YR	ΥI	YSH	YSL				ΥT	YY	YE					YZ
Z	Position/Dimension	ZRC	ZIC	ZC	ZCV	ZR	ZI	ZSH	ZSL	ZSHL	ZRT	ZIT	ZT	ZY	ZE					ZV
ZD	Gauging/Deviation	ZDRC	ZDIC	ZDC	ZDCV	ZDR	ZDI	ZDSH	ZDSL		ZDRT	ZDIT	ZDT	ZDY	ZDE					ZDV

NOTE: THIS TABLE IS NOT ALL-INCLUSIVE.

* A, ALARM, THE ANNUNCIATING DEVICE, MAY BE USED IN THE SAME FASHION AS S, SWITCH, THE ACTUATING DEVICE.

** THE LETTERS H AND L MAY BE OMITTED IN THE UNDEFINED CASE.

FO (RESTRICTION ORIFICE)

OTHER POSSIBLE COMBINATIONS:

LLH (LEVEL LIGHT HIGH)

DA - DOUBLE ACTING

KQI (RUNNING TIME INDICATOR) LCH (LEVEL CONTROL HIGH)

FRK, HIK (CONTROL STATIONS LCL (LEVEL CONTROL LOW) HMS (HAND MOMENTARY SWITCH)

ABBREVIATIONS:

INSTRUMENTS

NC - NORMALLY CLOSED HOA - HAND/OFF/AUTO LOR - LOCAL/OFF/REMOTE NO - NORMALLY OPEN ST - START / ENABLE OPN - OPEN CLS - CLOSE SP - STOP / DISABLE STPT - SETPOINT JOG - PUMP MOTOR ES - EMERGENCY STOP SA - SINGLE ACTING

PIPE FLUID SERVICE CODE INDEX SEE PIPING SPECIFICATIONS FOR DETAILS

CODE	SERVICE
CL21	CHLORINE LIQUID OR GAS
CTW1	COOLING TOWER WATER
CW3	PROCESS WATER
CW4	CHILLED WATER
NaOH	CAUSTIC SODA SOLUTION
GCO	GLYCOL
N20	NITROGEN (DRY COMPRESSED GAS)
SI	STEAM
CI	CONDENSATE
PV	PROCESS VENT
STS	STORM SEWER
PR	PROCESS RELIEF
GW	GROUNDWATER
DR	DRAIN
IA	INSTRUMENT AIR
VE	VAPOR EXTRACTION
NPW	NON POTABLE WATER
H2SO4	SULFURIC ACID
DW	DOMESTIC WATER
INF	INFLUENT WATER (CONTACT WATER)
EFF	EFFLUENT WATER (TREATED WATER)
SLG	SLUDGE
BW	BACKWASH
COAG	COAGULANT
POLY	POLYMER
OS	ORGANOSULFIDE
DEC	DECANT WATER
CONT	CONTAINMENT AREA DRAINAGE

MAT'L	DESCRIPTION	SPEC
CS_40	CARBON STEEL SCHEDULE 40 PIPE	
CS_80	CARBON STEEL SCHEDULE 80 PIPE	
316L_10	316L STAINLESS STEEL SCHEDULE 10 PIPE	
304_40	304 STAINLESS STEEL SCHEDULE 40 PIPE	
316L_ST	316L STAINLESS STEEL TUBING	
304_ST	304 STAINLESS STEEL TUBING	
CS_T	CARBON STEEL TUBING	
CU_T	COPPER TUBING	
PE_T	POLYETHYLENE TUBING	
CS_PTFEL	CARBON STEEL PTFE LINED PIPE	
CS-PFAL	CARBON STEEL PFA LINED PIPE	
CS-GL	CARBON STEEL GLASS LINED PIPE	
CPVC_80	CPVC SCHEDULE 80 PIPE	
PCV_80	PVC SCHEDULE 80 PIPE	
304_10	304 STAINLESS STEEL SCHEDULE 10 PIPE	
FRP	FIBERGLASS REINFORCED PIPE	
HDPE_11	HIGH-DENSITY POLYETHYLENE SDR-11	
FRH	FLEXIBLE RUBBER HOSE	
304L_ST	304L STAINLESS STEEL TUBING	
304L_10	304L STAINLESS STEEL SCHEDULE 10 PIPE	
304L_ST	TEFLON TUBING, CPVC CARRIER AND CONTAINMENT PIPE	
HDPE_DW_11	HIGH-DENSITY POLYETHYLENE SDR-11, DOUBLE WALLED CARRIER AND CONTAINMENT PIPE	
PTFE_CPVC	TEFLON TUBING, CPVC CARRIER AND CONTAINMENT PIPE	

PIPE MATERIAL INDEX

SEE PIPING SPECIFICATIONS FOR DETAILS

IDENTIFICATION LETTERS

	FIRST-LETTER		SUCCEEDING-LETTERS		
	MEASURED OR INITIATING VARIABLE	MODIFIER	READOUT OR PASSIVE FUNCTION	OUTPUT FUNCTION	MODIFIER
Α	Analysis		Alarm		
В	Burner/Combustion		User's Choice	User's Choice	User's Choice
С	User's Choice	Conductivity		Control	
D	User's Choice	Differential, Density			
Е	Voltage		Sensor (Primary Element)		
F	Flow Rate	Ratio (Fraction)			
G	User's Choice		Glass, Viewing Device, Gauge		
Н	Hand				High
I	Current (Electrical)		Indicate		
J	Power	Scan			
K	Time, Time Schedule	Time Rate of Change		Control Station	
L	Level		Light		Low
М	User's Choice	Momentary, Moisture			Middle, Intermediate
N	User's Choice		User's Choice	User's Choice	User's Choice
0	User's Choice		Orifice, Restriction		
Р	Pressure, Vacuum		Point (Test) Connection		
Q	Quantity	Integrate, Totalize			
R	Radiation		Record		
S	Speed, Frequency	Safety		Switch	
T	Temperature			Transmit	
U	Multivariable		Multifunction	Multifunction	Multifunction
V	Vibration, Machinery Analysis			Valve, Damper, Louver	
W	Weight, Force		Well		
Χ	Unclassified	X Axis	Unclassified	Unclassified	Unclassified
Υ	Event, State, or Presence	Y Axis		Relay, Compute, Convert	
Z	Position, Dimension	Z Axis		Driver, Actuator, Unclassified Final Control Element	

LINE DESIGNATION

- NOMINAL DIAMETER (INCHES)

 PIPE FLUID SERVICE CODE (SEE PIPE FLUID SERVICE CODE INDEX) PIPE MATERIAL DESCRIPTION (SEE PIPE MATERIAL INDEX) PIPE LINE NUMBER LAST 2 DIGITS OF PID NUMBER &

 SEQUENTIAL LINE NUMBER PIPE INSULATION CODE (IF REQUIRED) (SEE PIPE INSULATION CODE INDEX)

2"-NaOH7-CS_PTFEL-02101-I(2")ET

PIPE INSULATION CODE INDEX SEE PIPING SPECIFICATIONS FOR DETAILS

DESCRIPTION INSULATED (2") NOT INSULATED JACKETED PIPE INSULATED (2") AND ELECTRICALLY TRACED INSULATED (2") AND STEAM TRACED INSULATED (2") AND JACKETED

> THIS DOCUMENT IS RELEASED FOR THE PURPOSE OF EPA REVIEW UNDER THE AUTHORITY OF NORTON FOGEL, P.E. 144491 ON 07/17/2024. IT IS NOT TO BE USED FOR CONSTRUCTION, BIDDING, RECORDATION, CONVEYANCE OR SALES PURPOSES.

> > GHD SERVICES INC. JOB NO. 11215702 FILE NO. 001 GHD TEXAS FIRM REGISTRATION NO. 276

100% EPA SUBMITTAL



2237 S Acadian Thruway Suite 701 Baton Rouge Louisiana 70808 USA **T** 225 292 9007



Reuse of Documents

This document and the ideas and designs incorporated herein, as an instrument of professional service, is the property of GHD and shall not be reused in whole or in part for any other project without GHD's written authorization. © 2024 GHD

Client

SAN JACINTO RIVER WASTE PITS

NORTHERN IMPOUNDMENT FINAL 100% REMEDIAL DESIGN HARRIS COUNTY, TEXAS

ı					
	1	100% EPA SUBMITTAL	RH		07/17/20
	No.	Issue	Drawn	Approved	Date
	Draw	n RH	Designer	NF	
	Drafti Chec	•	Design Check	NF	
	Proje Coor	ct dinator	Date	July 17, 2	024
		document shall not be used for uction unless signed and sealed for uction.	Scale	N.T.S.	
		·		·	

Bar is one inch on original size drawing Arch D 0 1"


Project No. **11215702**

Original Size

WATER TREATMENT SYSTEM PROCESS FLOW DIAGRAM **SCHEDULES**

Sheet No.

P-000B

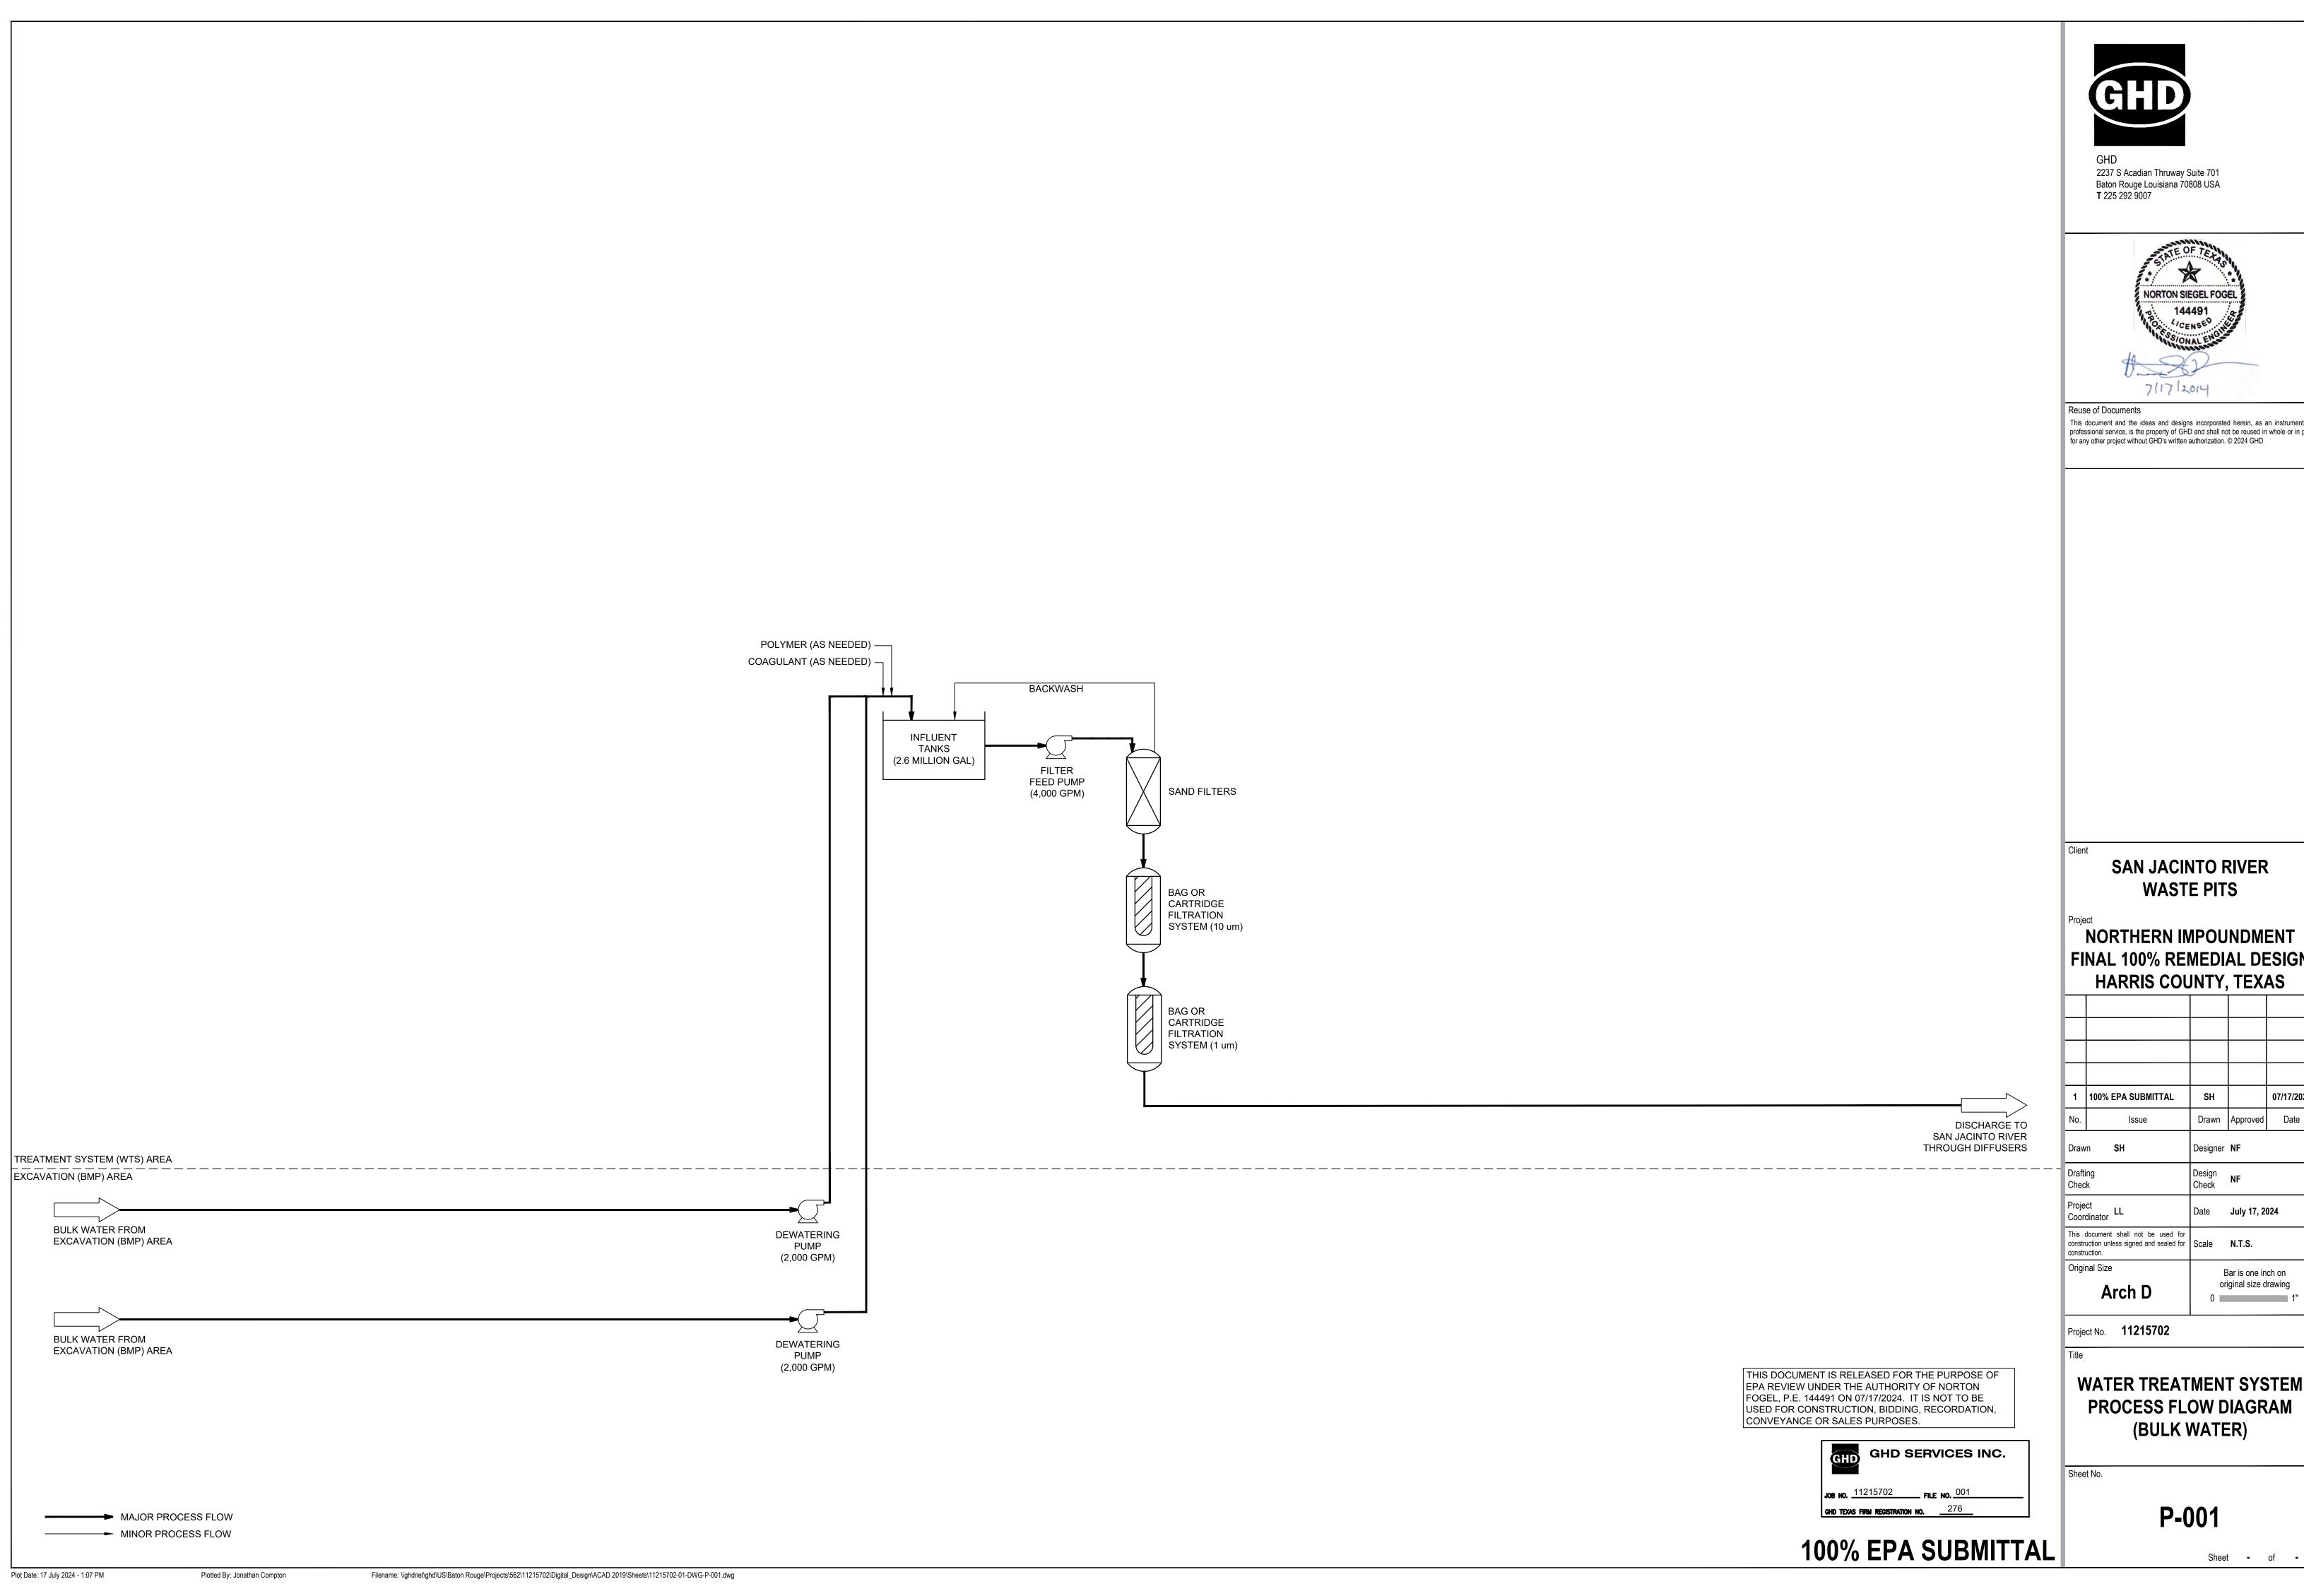



This document and the ideas and designs incorporated herein, as an instrument of professional service, is the property of GHD and shall not be reused in whole or in part

NORTHERN IMPOUNDMENT FINAL 100% REMEDIAL DESIGN

1	100% EPA SUBMITTAL	SH		07/17/2024
No.	Issue	Drawn	Approved	Date
Draw	n SH	Designer	NF	
Drafti Chec	•	Design Check	NF	
Proje Coor	ct dinator	Date	July 17, 2	024

WATER TREATMENT SYSTEM

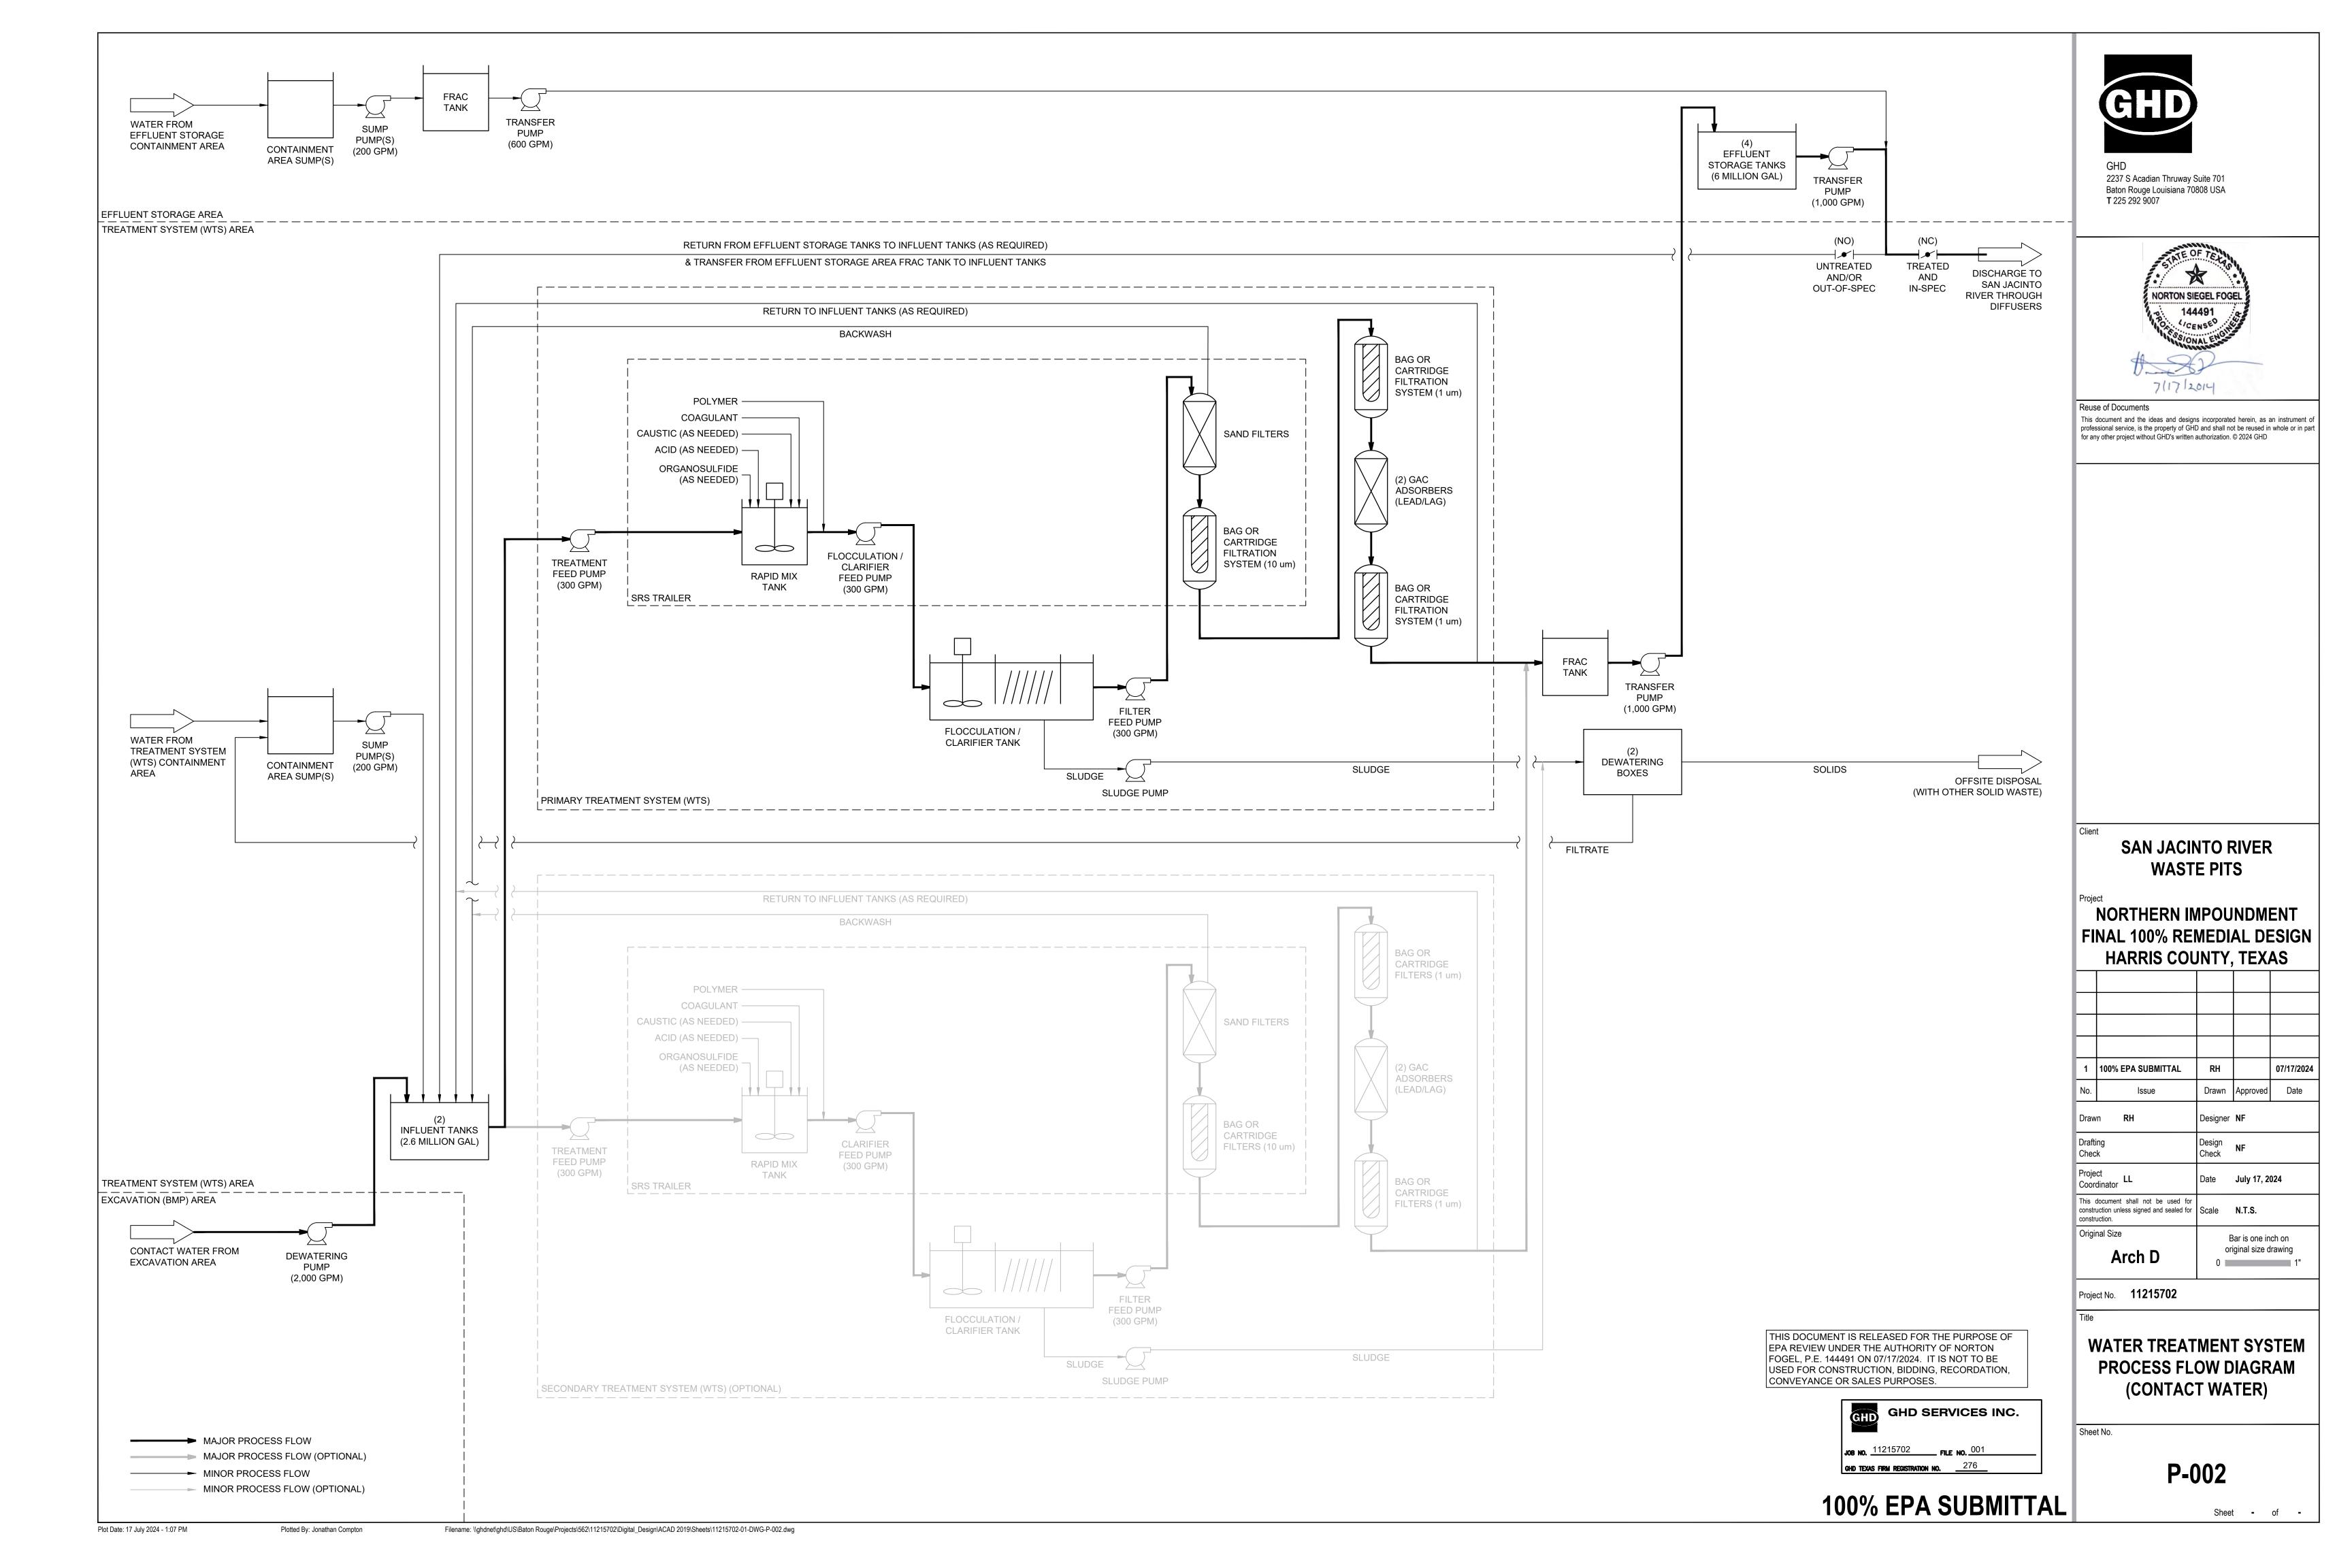

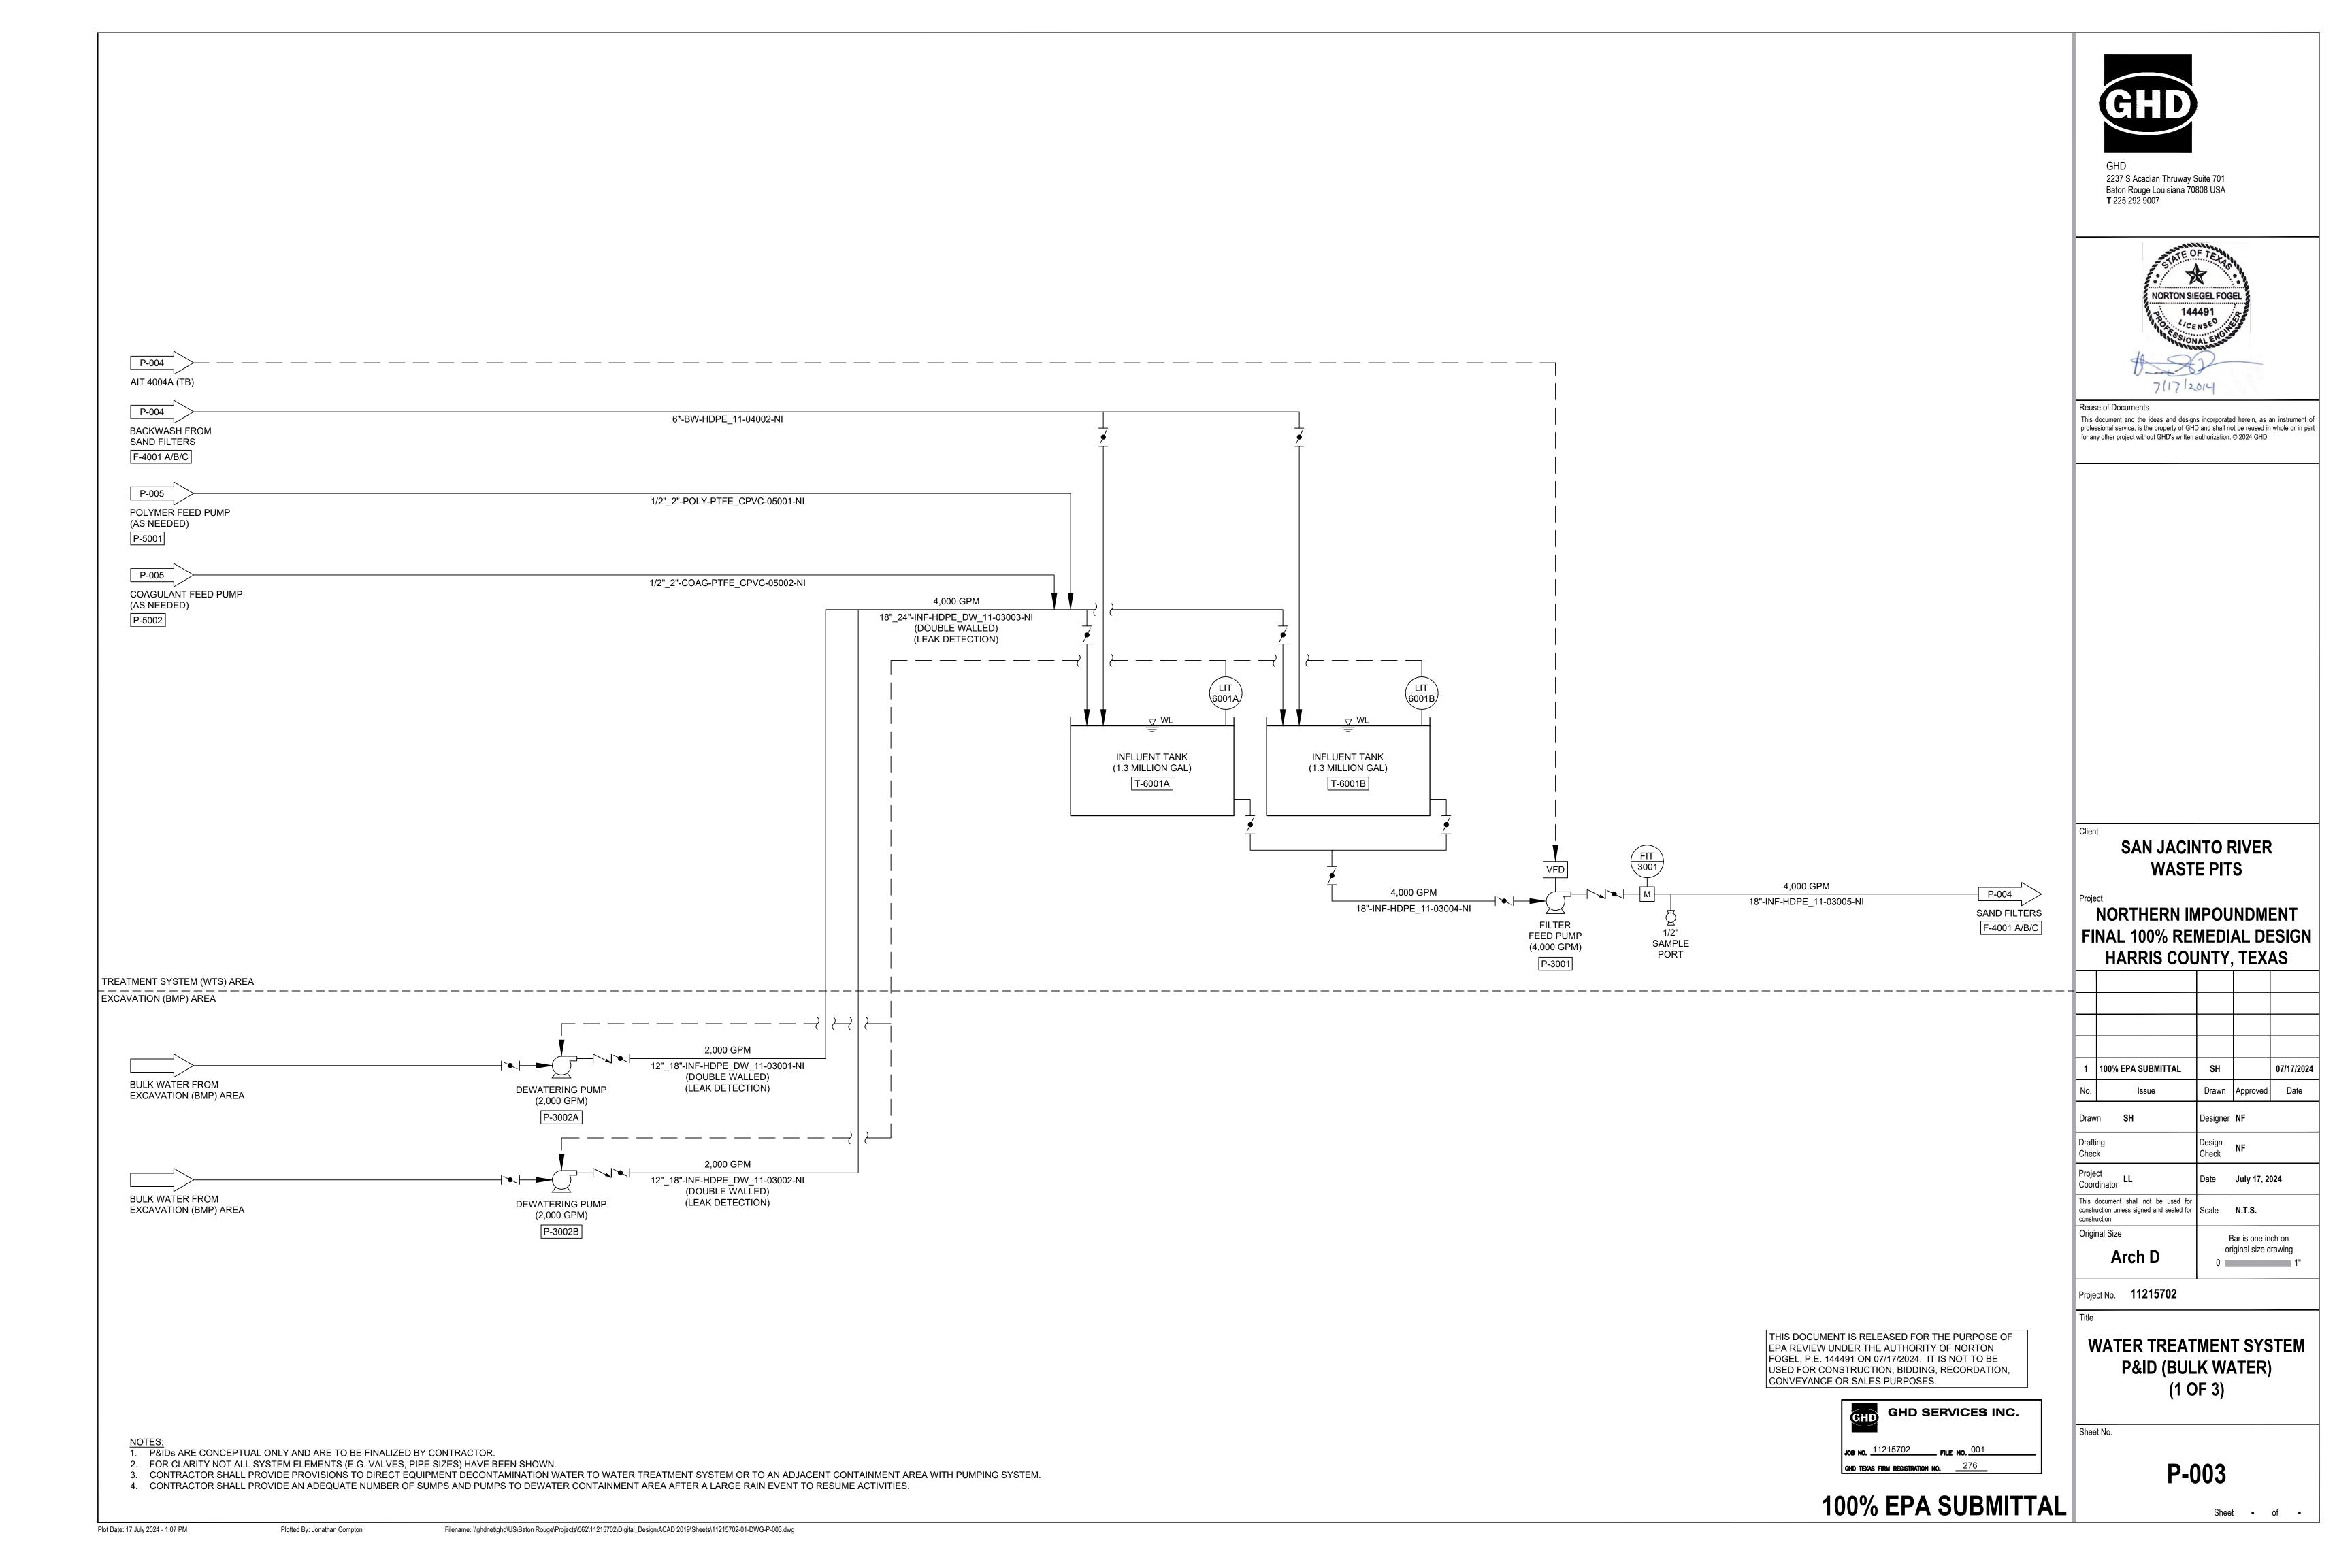



P-003

P-005

P-5001 P-5002

P-003

FILTER FEED PUMP

DISCHARGE TO SAN JACINTO RIVER

THROUGH DIFFUSERS

1/2"

SAMPLE

PORT

P-3001

CHEMICAL FEED PUMPS

BACKWASH TO INFLUENT TANK

T-3001

6"-BW-HDPE_11-04002-NI

4,000 GPM

18"-INF-HDPE_11-04004-NI

CARTRIDGE

FILTRATION


F-4003

SYSTEM (1 um)

FIT 4004 AIT 4004B pH

SAN JACINTO RIVER
WASTE PITS

NORTHERN IMPOUNDMENT FINAL 100% REMEDIAL DESIGN HARRIS COUNTY, TEXAS

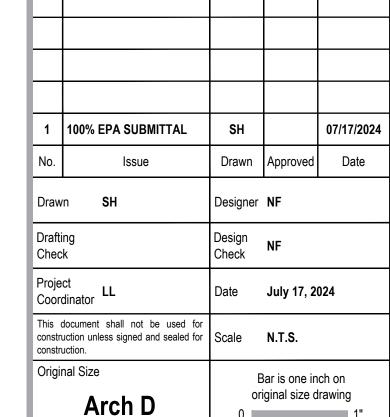

Project No. **11215702**

Title

WATER TREATMENT SYSTEM
P&ID (BULK WATER)
(2 OF 3)

Sheet No.

P-004

Sheet - of -



SAND FILTERS

F-4001 A/B/C

SAMPLE PORT

4,000 GPM

18"-INF-HDPE_11-04001-NI

BAG OR CARTRIDGE

F-4002

4,000 GPM

18"-INF-HDPE_11-04003-NI

FILTRATION

SAMPLE PORT

SYSTEM (10 um)

GHD SERVICES INC.

JOB NO. $\frac{11215702}{}$ FILE NO. $\frac{001}{}$ GHD TEXAS FIRM REGISTRATION NO. $\frac{276}{}$

THIS DOCUMENT IS RELEASED FOR THE PURPOSE OF

USED FOR CONSTRUCTION, BIDDING, RECORDATION,

EPA REVIEW UNDER THE AUTHORITY OF NORTON FOGEL, P.E. 144491 ON 07/17/2024. IT IS NOT TO BE

CONVEYANCE OR SALES PURPOSES.

100% EPA SUBMITTAL

P&IDs ARE CONCEPTUAL ONLY AND ARE TO BE FINALIZED BY CONTRACTOR.
 FOR CLARITY NOT ALL SYSTEM ELEMENTS (E.G. VALVES, PIPE SIZES) HAVE BEEN SHOWN.

4,000 GPM

18"-INF-HDPE_11-03005-NI

- 2. FOR CLARITY NOT ALL SYSTEM ELEMENTS (E.G. VALVES, PIPE SIZES) HAVE BEEN SHOWN.
 3. CONTRACTOR SHALL PROVIDE PROVISIONS TO DIRECT EQUIPMENT DECONTAMINATION WATER TO WATER TREATMENT SYSTEM OR TO AN ADJACENT CONTAINMENT AREA WITH PUMPING SYSTEM.
- 4. CONTRACTOR SHALL PROVIDE AN ADEQUATE NUMBER OF SUMPS AND PUMPS TO DEWATER CONTAINMENT AREA AFTER A LARGE RAIN EVENT TO RESUME ACTIVITIES.

P-003

P-3001

FILTER FEED PUMP

PIT 4001


SAMPLE PORT






Reuse of Documents

This document and the ideas and designs incorporated herein, as an instrument of professional service, is the property of GHD and shall not be reused in whole or in part for any other project without GHD's written authorization. © 2024 GHD

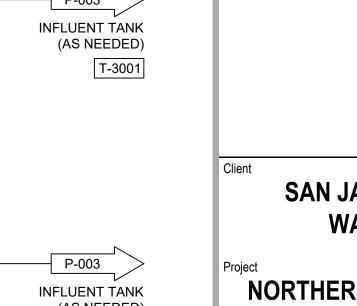

SAN JACINTO RIVER
WASTE PITS
Proiect

NORTHERN IMPOUNDMENT FINAL 100% REMEDIAL DESIGN HARRIS COUNTY, TEXAS

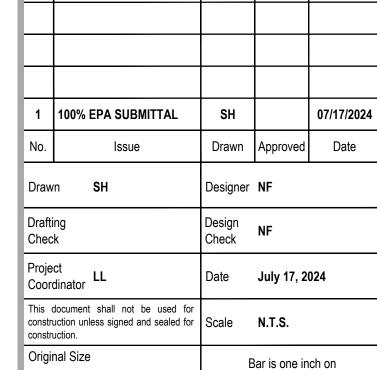

Arch D

Project No. **11215702**

Title

WATER TREATMENT SYSTEM
P&ID (BULK WATER)
(3 OF 3)

original size drawing

Sheet - of -

Sheet No.

P-005

100% EPA SUBMITTAL

GHD GHD SERVICES INC.

JOB NO. 11215702 FILE NO. 001

GHD TEXAS FIRM REGISTRATION NO. 276

THIS DOCUMENT IS RELEASED FOR THE PURPOSE OF

USED FOR CONSTRUCTION, BIDDING, RECORDATION,

EPA REVIEW UNDER THE AUTHORITY OF NORTON FOGEL, P.E. 144491 ON 07/17/2024. IT IS NOT TO BE

CONVEYANCE OR SALES PURPOSES.




NOTES:


1. P&IDs ARE CONCEPTUAL ONLY AND ARE TO BE FINALIZED BY CONTRACTOR.


2. FOR CLARITY NOT ALL SYSTEM ELEMENTS (E.G. VALVES, PIPE SIZES) HAVE BEEN SHOWN.

3. CONTRACTOR SHALL PROVIDE PROVISIONS TO DIRECT EQUIPMENT DECONTAMINATION WATER TO WATER TREATMENT SYSTEM OR TO AN ADJACENT CONTAINMENT AREA WITH PUMPING SYSTEM.

4. CONTRACTOR SHALL PROVIDE AN ADEQUATE NUMBER OF SUMPS AND PUMPS TO DEWATER CONTAINMENT AREA AFTER A LARGE RAIN EVENT TO RESUME ACTIVITIES.

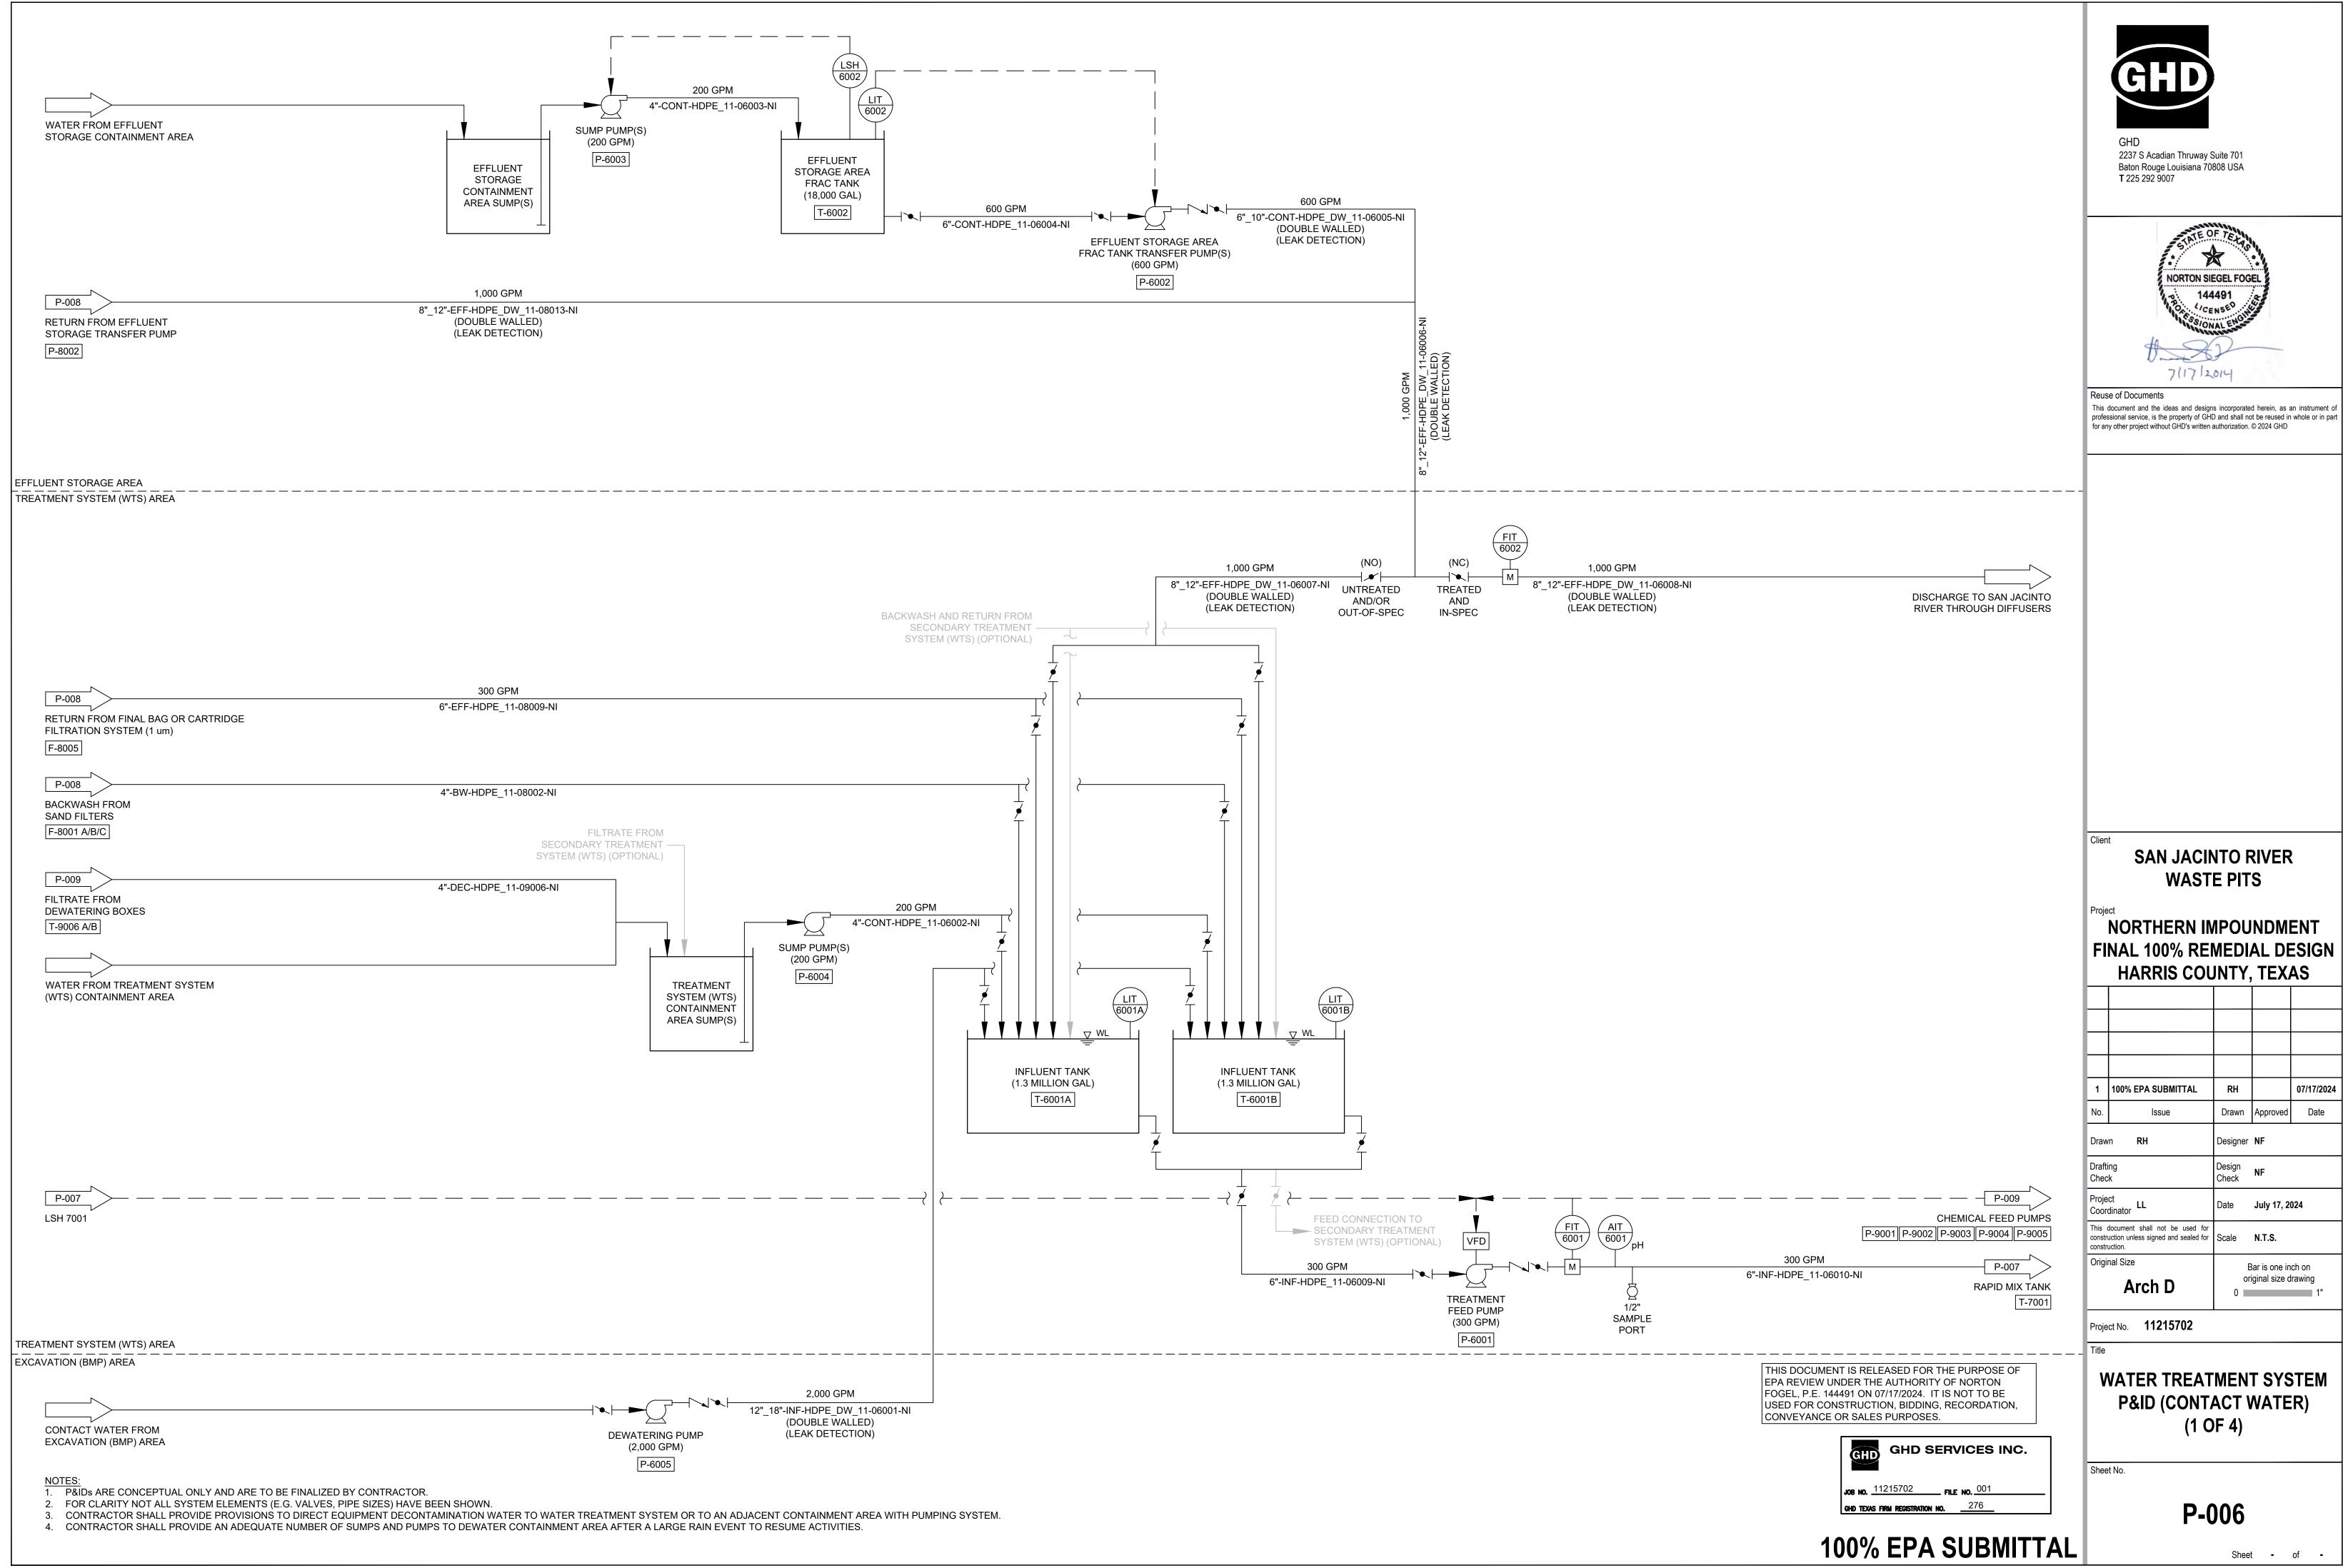

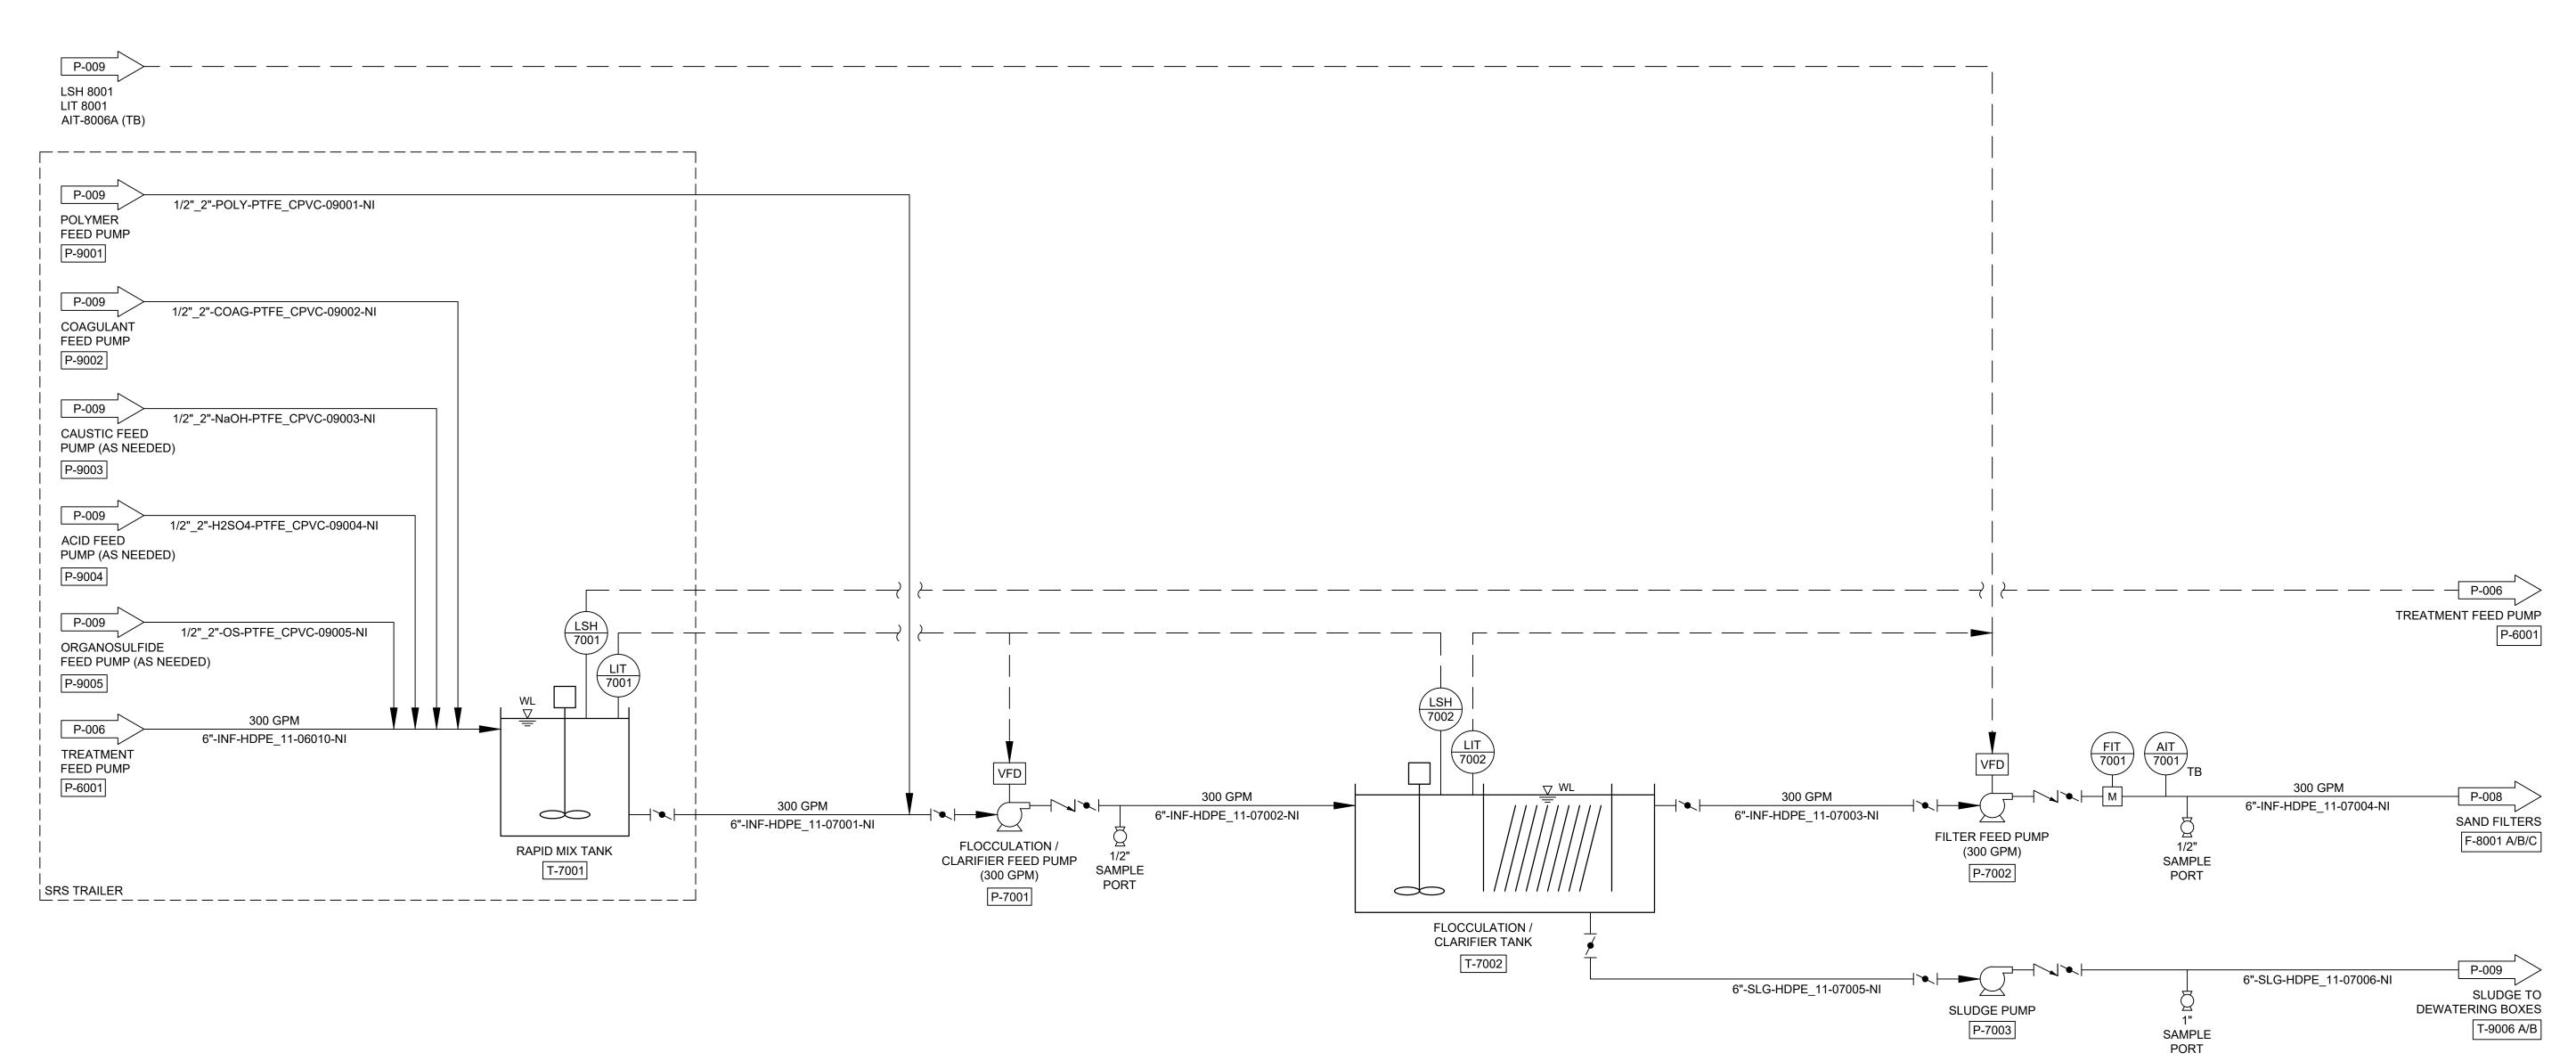

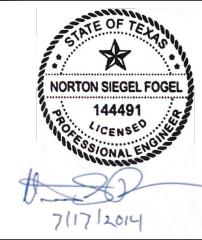


Reuse of Documents

This document and the ideas and designs incorporated herein, as an instrument of professional service, is the property of GHD and shall not be reused in whole or in part for any other project without GHD's written authorization. © 2024 GHD

SAN JACINTO RIVER WASTE PITS

NORTHERN IMPOUNDMENT FINAL 100% REMEDIAL DESIGN HARRIS COUNTY, TEXAS

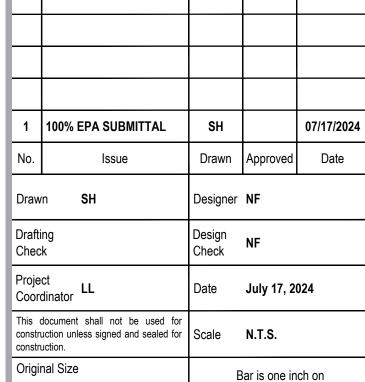

Project No. **11215702**

Arch D

WATER TREATMENT SYSTEM P&ID (CONTACT WATER) (2 OF 4)

original size drawing

Sheet - of -

Sheet No.

P-007

GHD SERVICES INC. JOB NO. 11215702 FILE NO. 001 GHD TEXAS FIRM REGISTRATION NO. 276

THIS DOCUMENT IS RELEASED FOR THE PURPOSE OF

USED FOR CONSTRUCTION, BIDDING, RECORDATION,

EPA REVIEW UNDER THE AUTHORITY OF NORTON FOGEL, P.E. 144491 ON 07/17/2024. IT IS NOT TO BE

CONVEYANCE OR SALES PURPOSES.


100% EPA SUBMITTAL


1. P&IDs ARE CONCEPTUAL ONLY AND ARE TO BE FINALIZED BY CONTRACTOR.


2. FOR CLARITY NOT ALL SYSTEM ELEMENTS (E.G. VALVES, PIPE SIZES) HAVE BEEN SHOWN. 3. CONTRACTOR SHALL PROVIDE PROVISIONS TO DIRECT EQUIPMENT DECONTAMINATION WATER TO WATER TREATMENT SYSTEM OR TO AN ADJACENT CONTAINMENT AREA WITH PUMPING SYSTEM.

4. CONTRACTOR SHALL PROVIDE AN ADEQUATE NUMBER OF SUMPS AND PUMPS TO DEWATER CONTAINMENT AREA AFTER A LARGE RAIN EVENT TO RESUME ACTIVITIES.

Filename: \\ghdnet\ghd\US\Baton Rouge\Projects\562\11215702\Digital_Design\ACAD 2019\Sheets\11215702-01-DWG-P-007.dwg

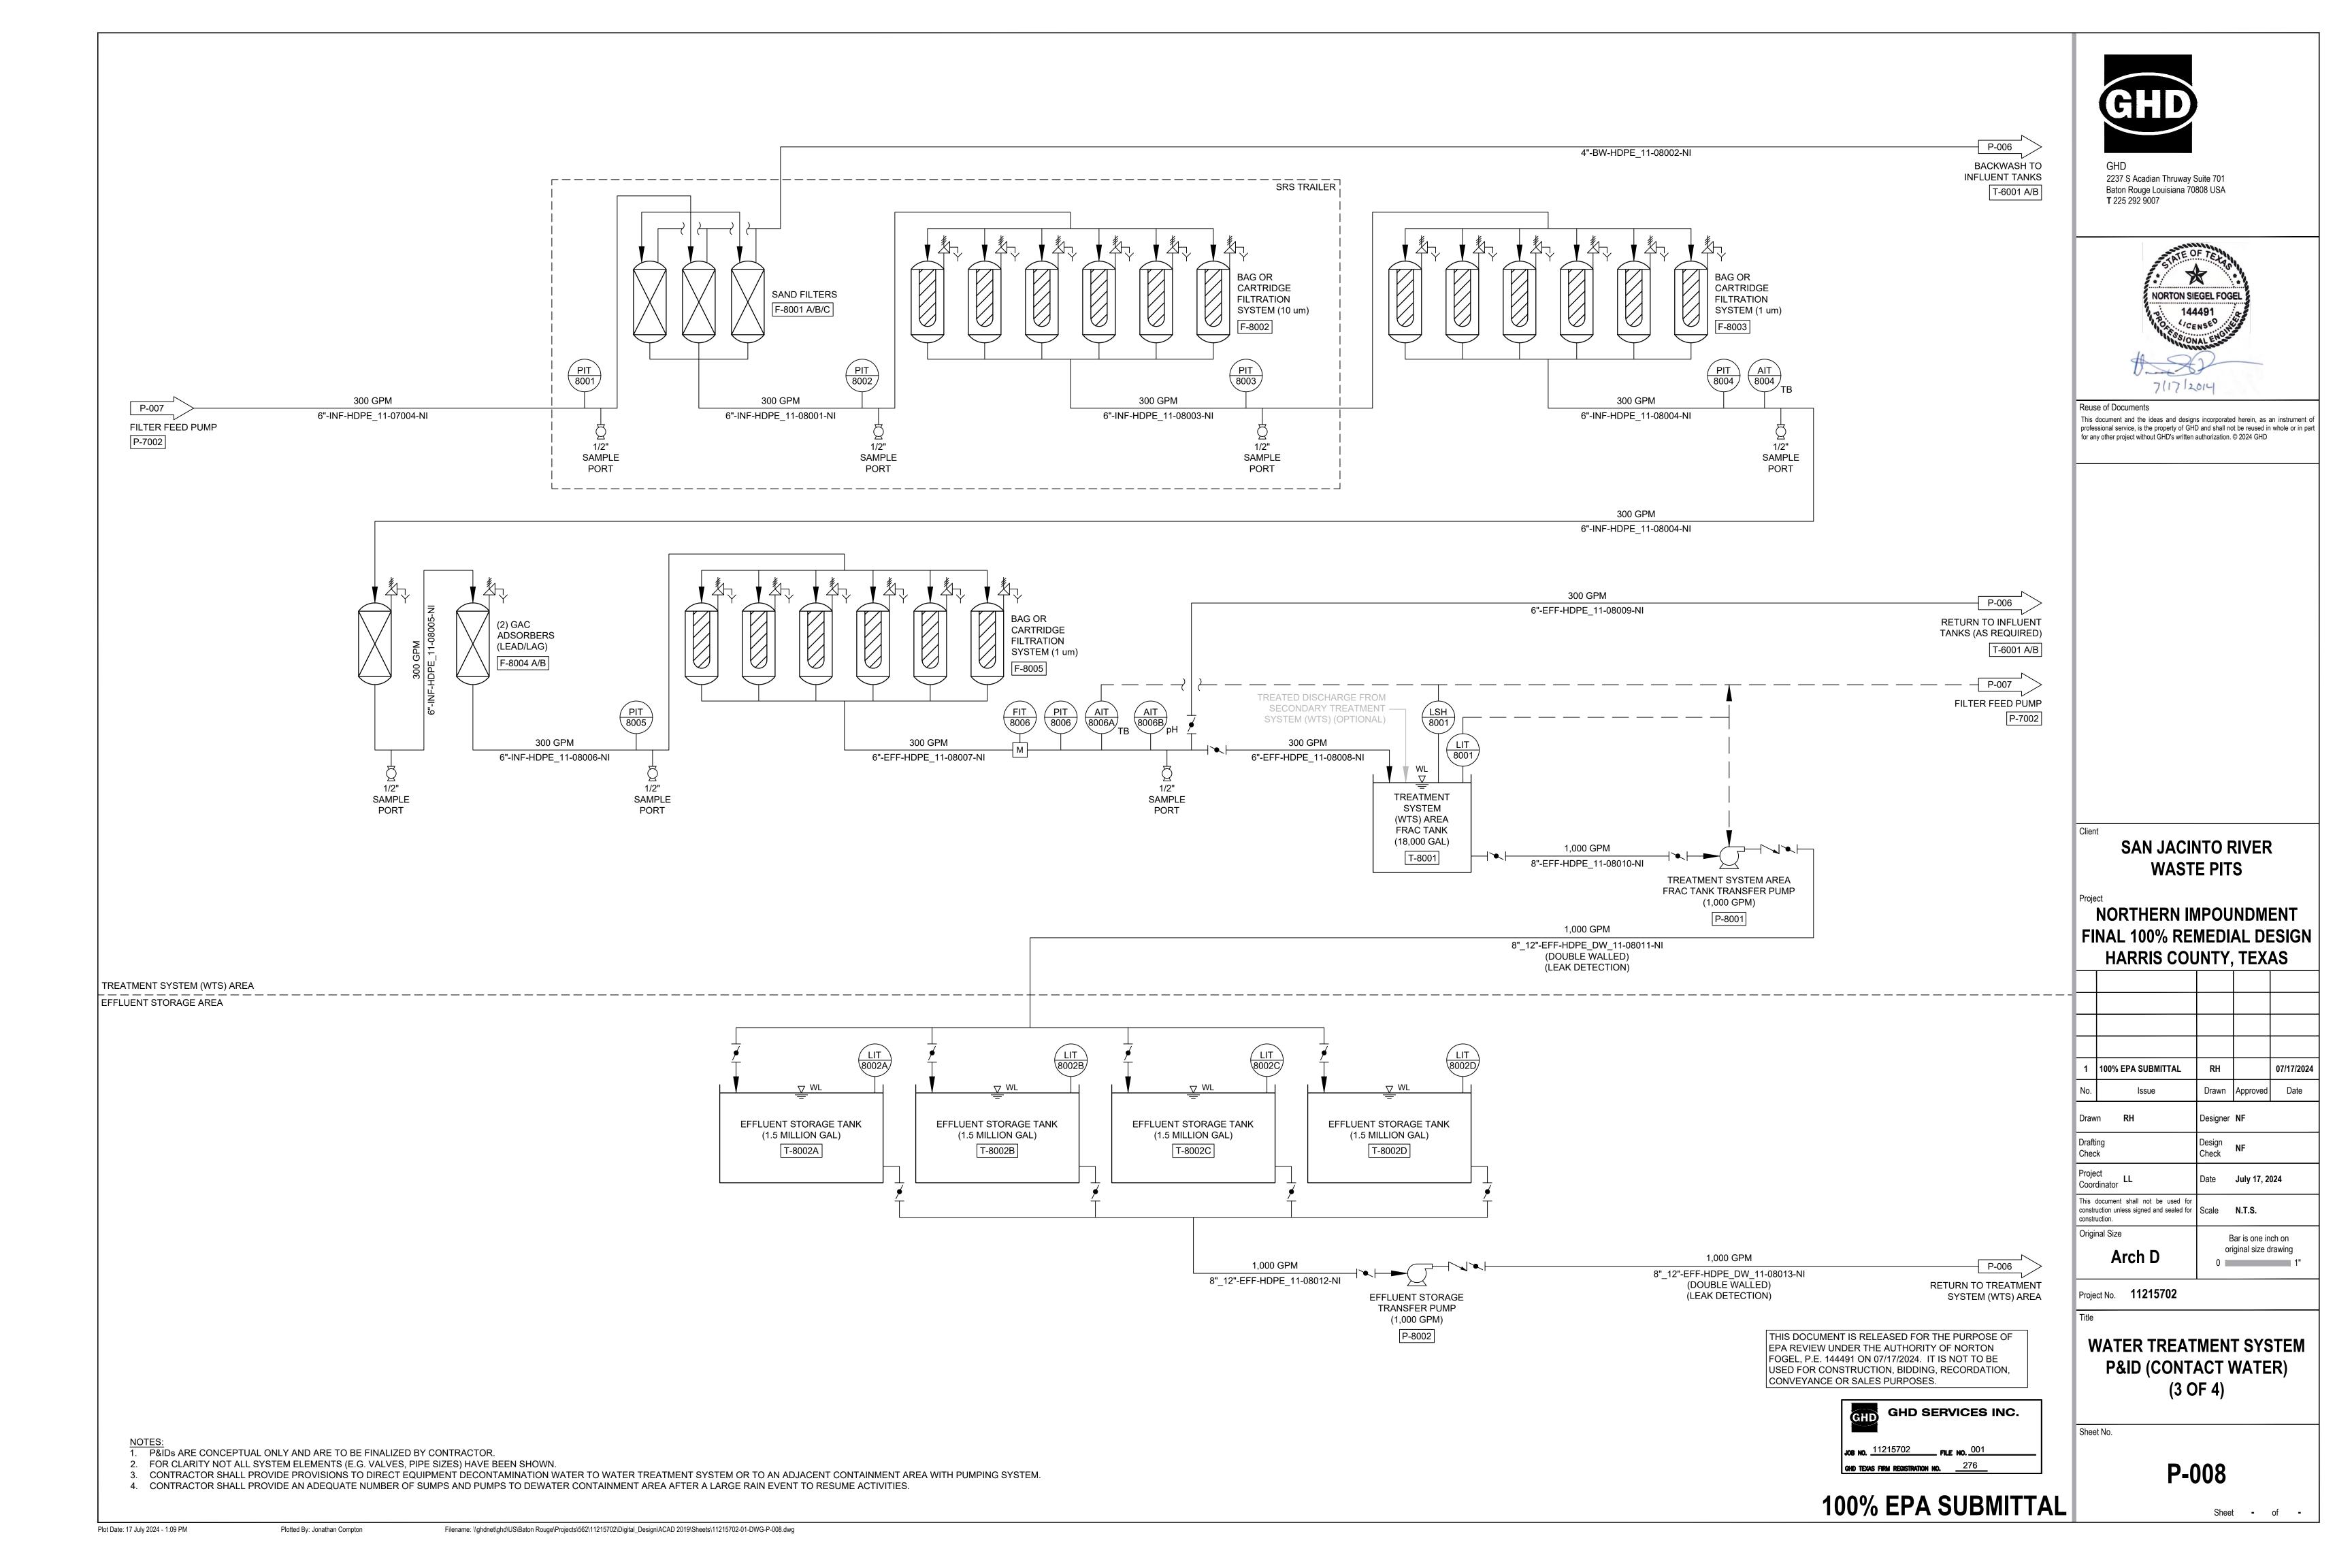

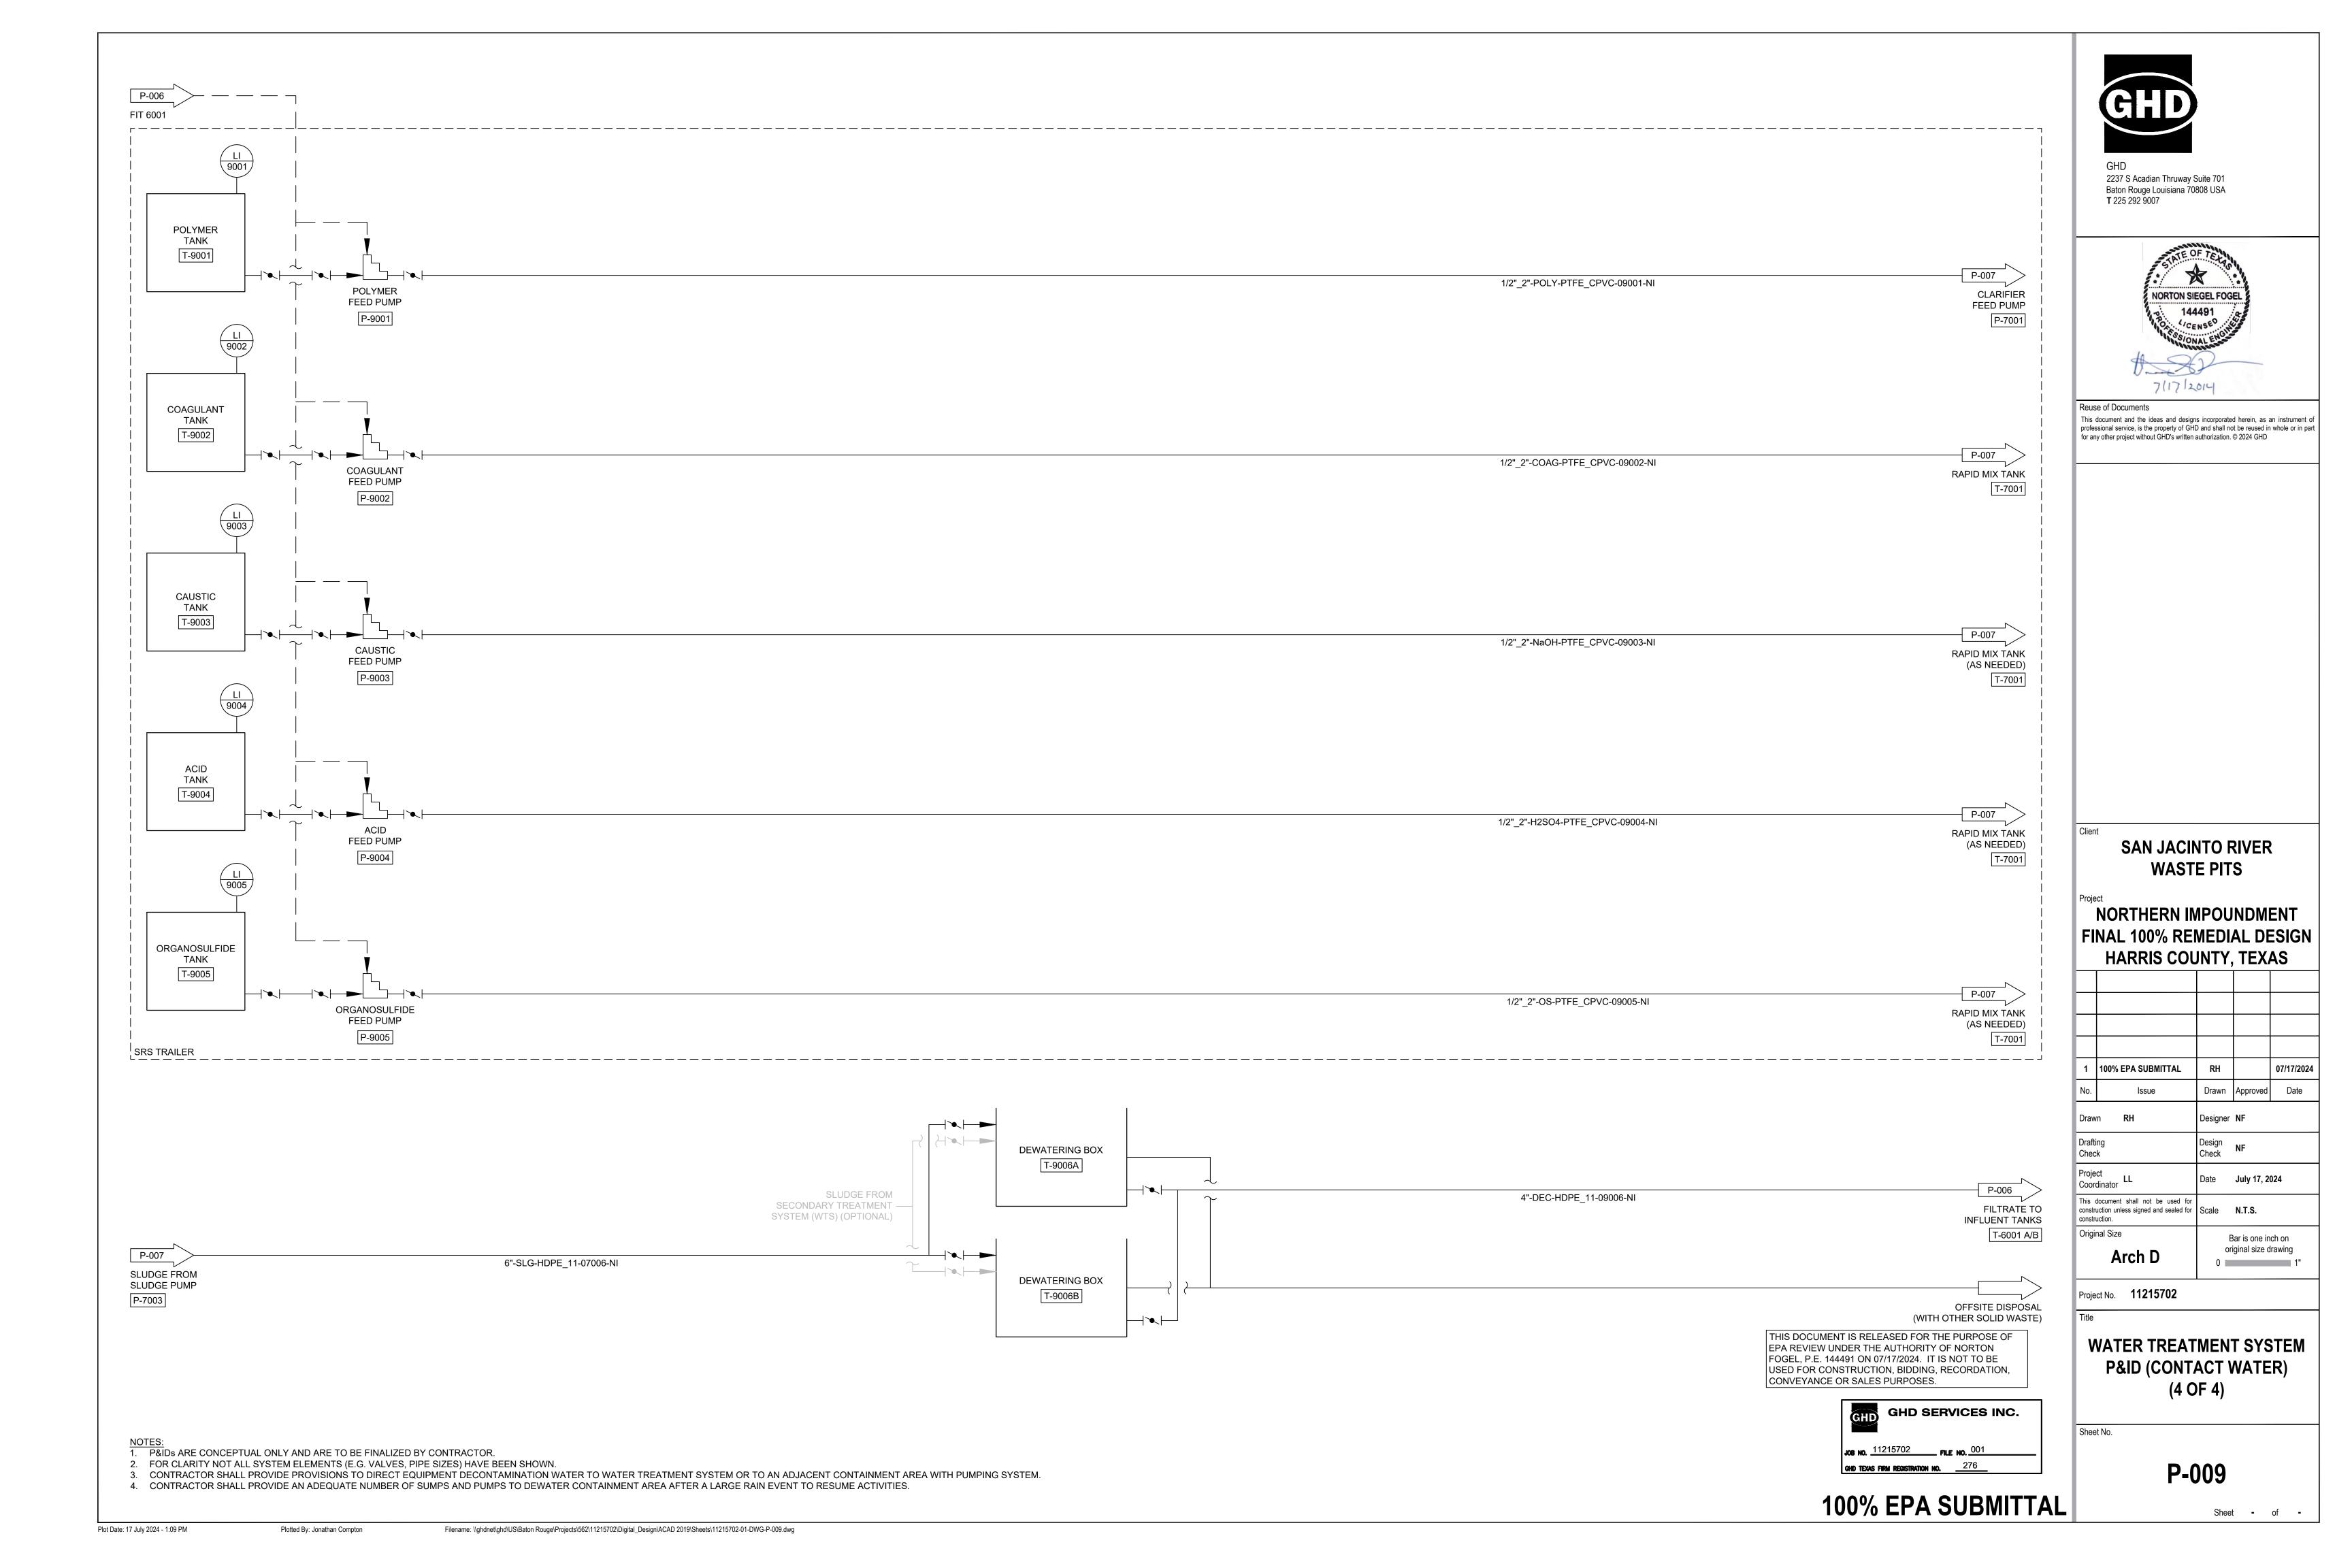

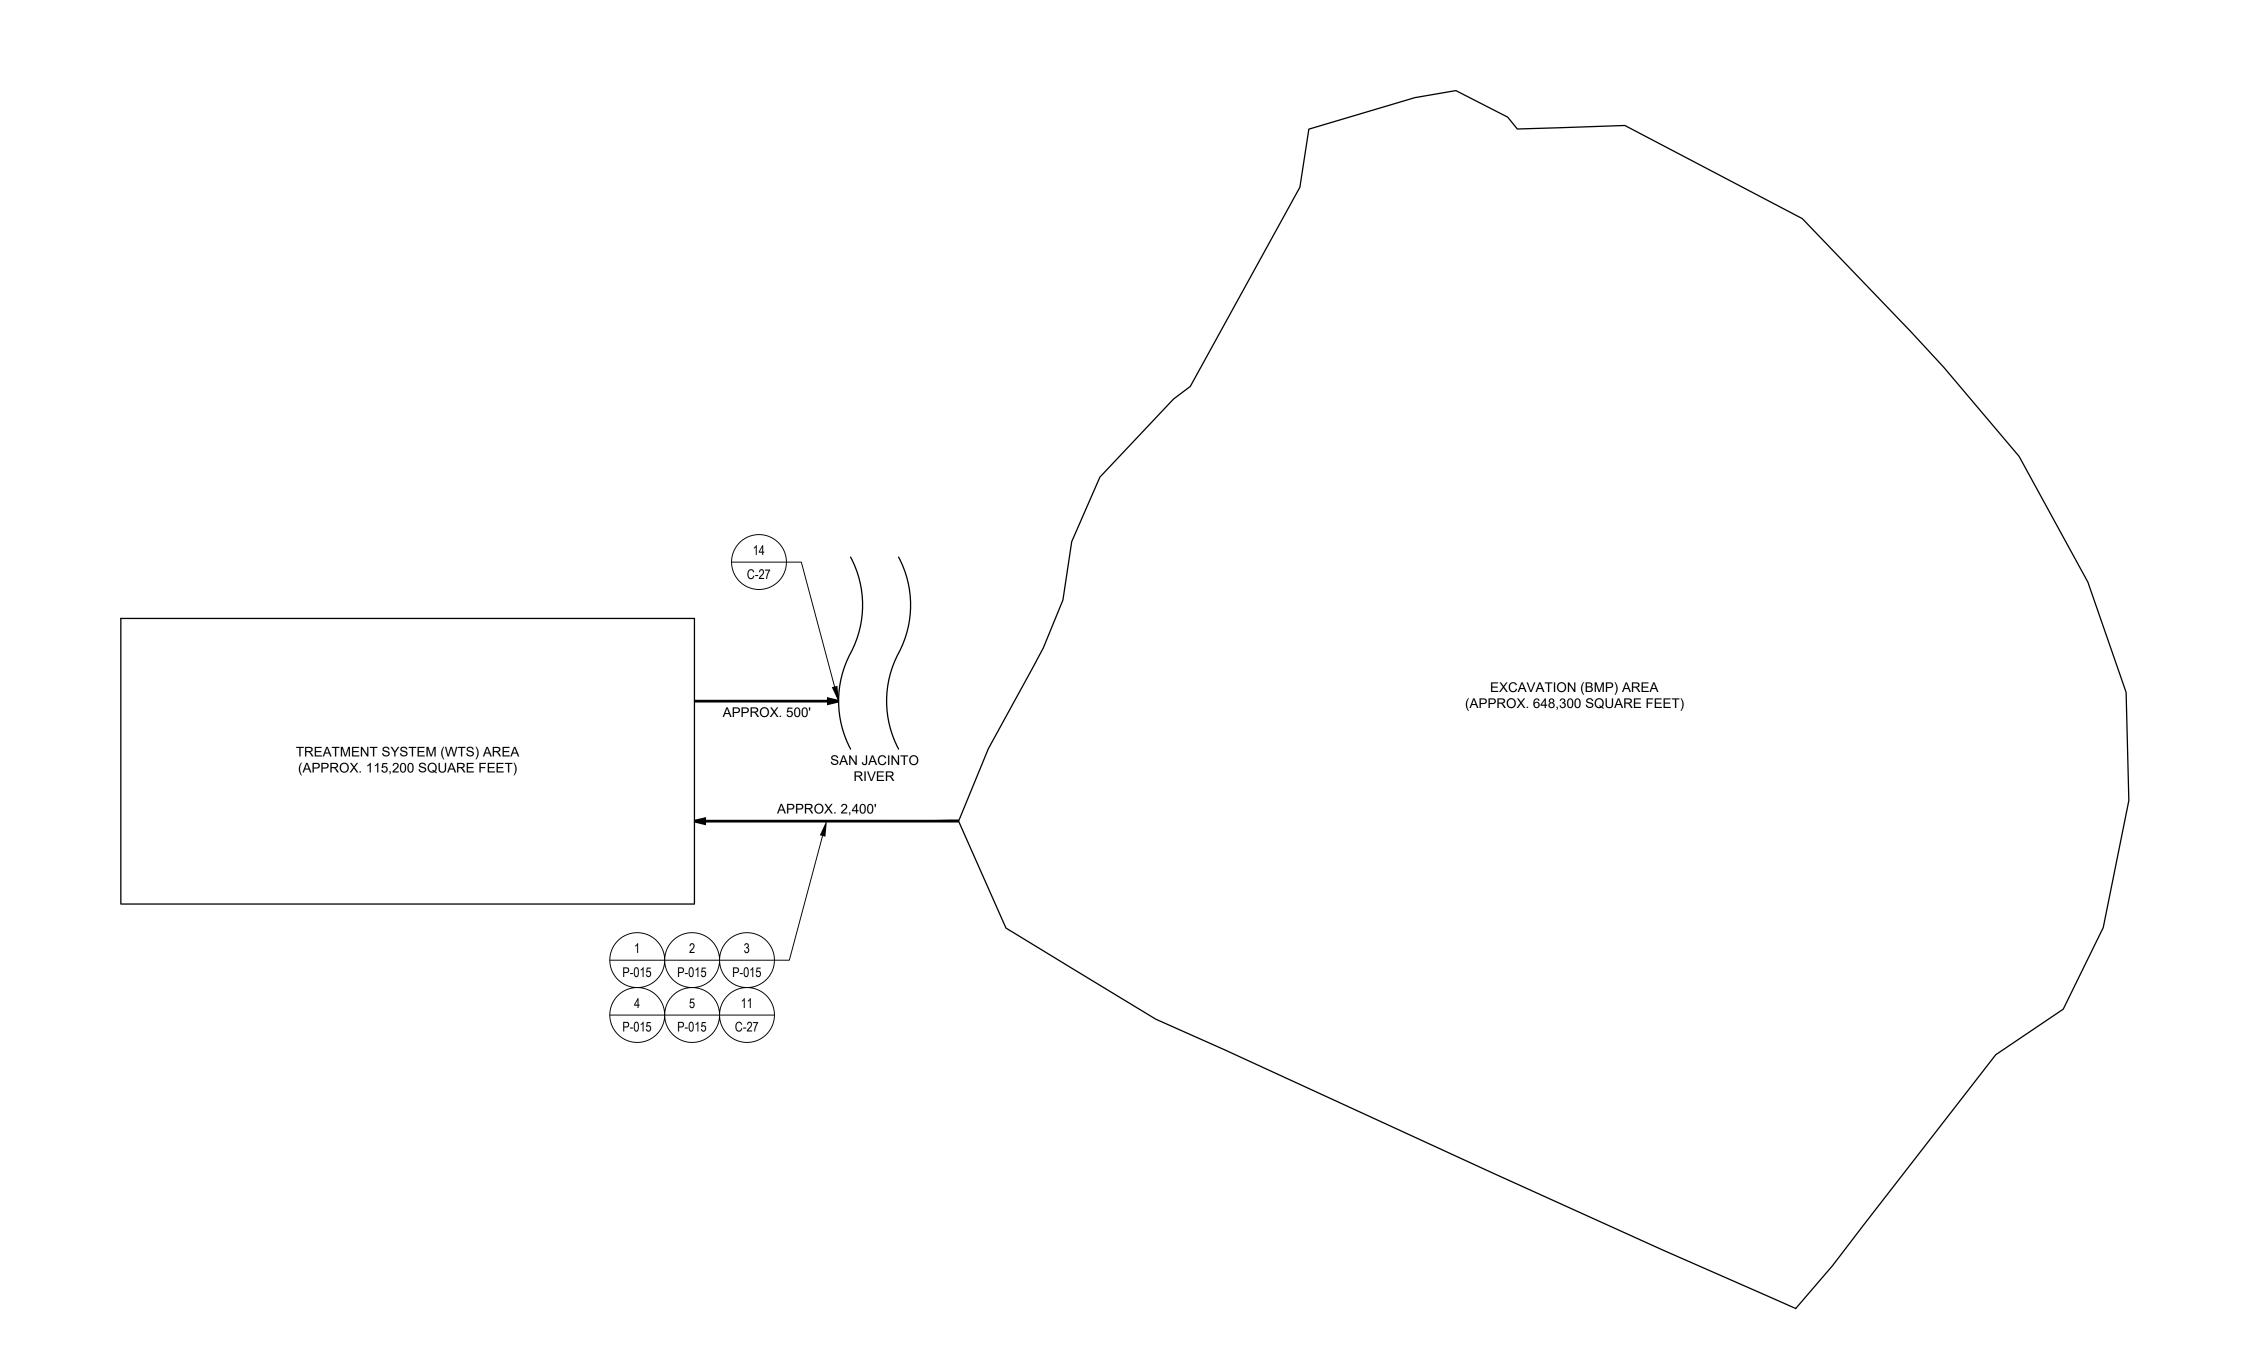





Reuse of Documents

This document and the ideas and designs incorporated herein, as an instrument of professional service, is the property of GHD and shall not be reused in whole or in part for any other project without GHD's written authorization. © 2024 GHD

SAN JACINTO RIVER WASTE PITS

NORTHERN IMPOUNDMENT FINAL 100% REMEDIAL DESIGN HARRIS COUNTY, TEXAS

1	100% EPA SUBMITTAL	RH		07/17/
No.	Issue	Drawn	Approved	Da
Draw	n RH	Designer	NF	
	Drafting Check		NF	
Proje Coor	ct dinator	Date	July 17, 2	024
	document shall not be used for uction unless signed and sealed for uction.	Scale	N.T.S.	

Project No. **11215702**

Arch D

Original Size

WATER TREATMENT SYSTEM SITE PLAN (BULK WATER)

Bar is one inch on original size drawing

Sheet - of -

Sheet No.

P-010

100% EPA SUBMITTAL

THIS DOCUMENT IS RELEASED FOR THE PURPOSE OF EPA REVIEW UNDER THE AUTHORITY OF NORTON FOGEL, P.E. 144491 ON 07/17/2024. IT IS NOT TO BE USED FOR CONSTRUCTION, BIDDING, RECORDATION, CONVEYANCE OR SALES PURPOSES.

GHD SERVICES INC. JOB NO. 11215702 FILE NO. 001 GHD TEXAS FIRM REGISTRATION NO. 276

Plot Date: 17 July 2024 - 1:09 PM

Plotted By: Jonathan Compton


NOTES:

1. SITE PLANS ARE CONCEPTUAL ONLY AND ARE TO BE FINALIZED BY CONTRACTOR.

2. CONTRACTOR SHALL PROVIDE LEAK DETECTION AT LOW POINT ON ALL PIPELINES (SEE DETAIL 4/P-015).

3. CONTRACTOR SHALL INSTALL BIDIRECTIONAL CLEANOUTS EVERY 500' (MINIMUM) ON ALL PIPELINES.

Filename: \\ghdnet\ghd\US\Baton Rouge\Projects\562\11215702\Digital_Design\ACAD 2019\Sheets\11215702-01-DWG-P-010.dwg

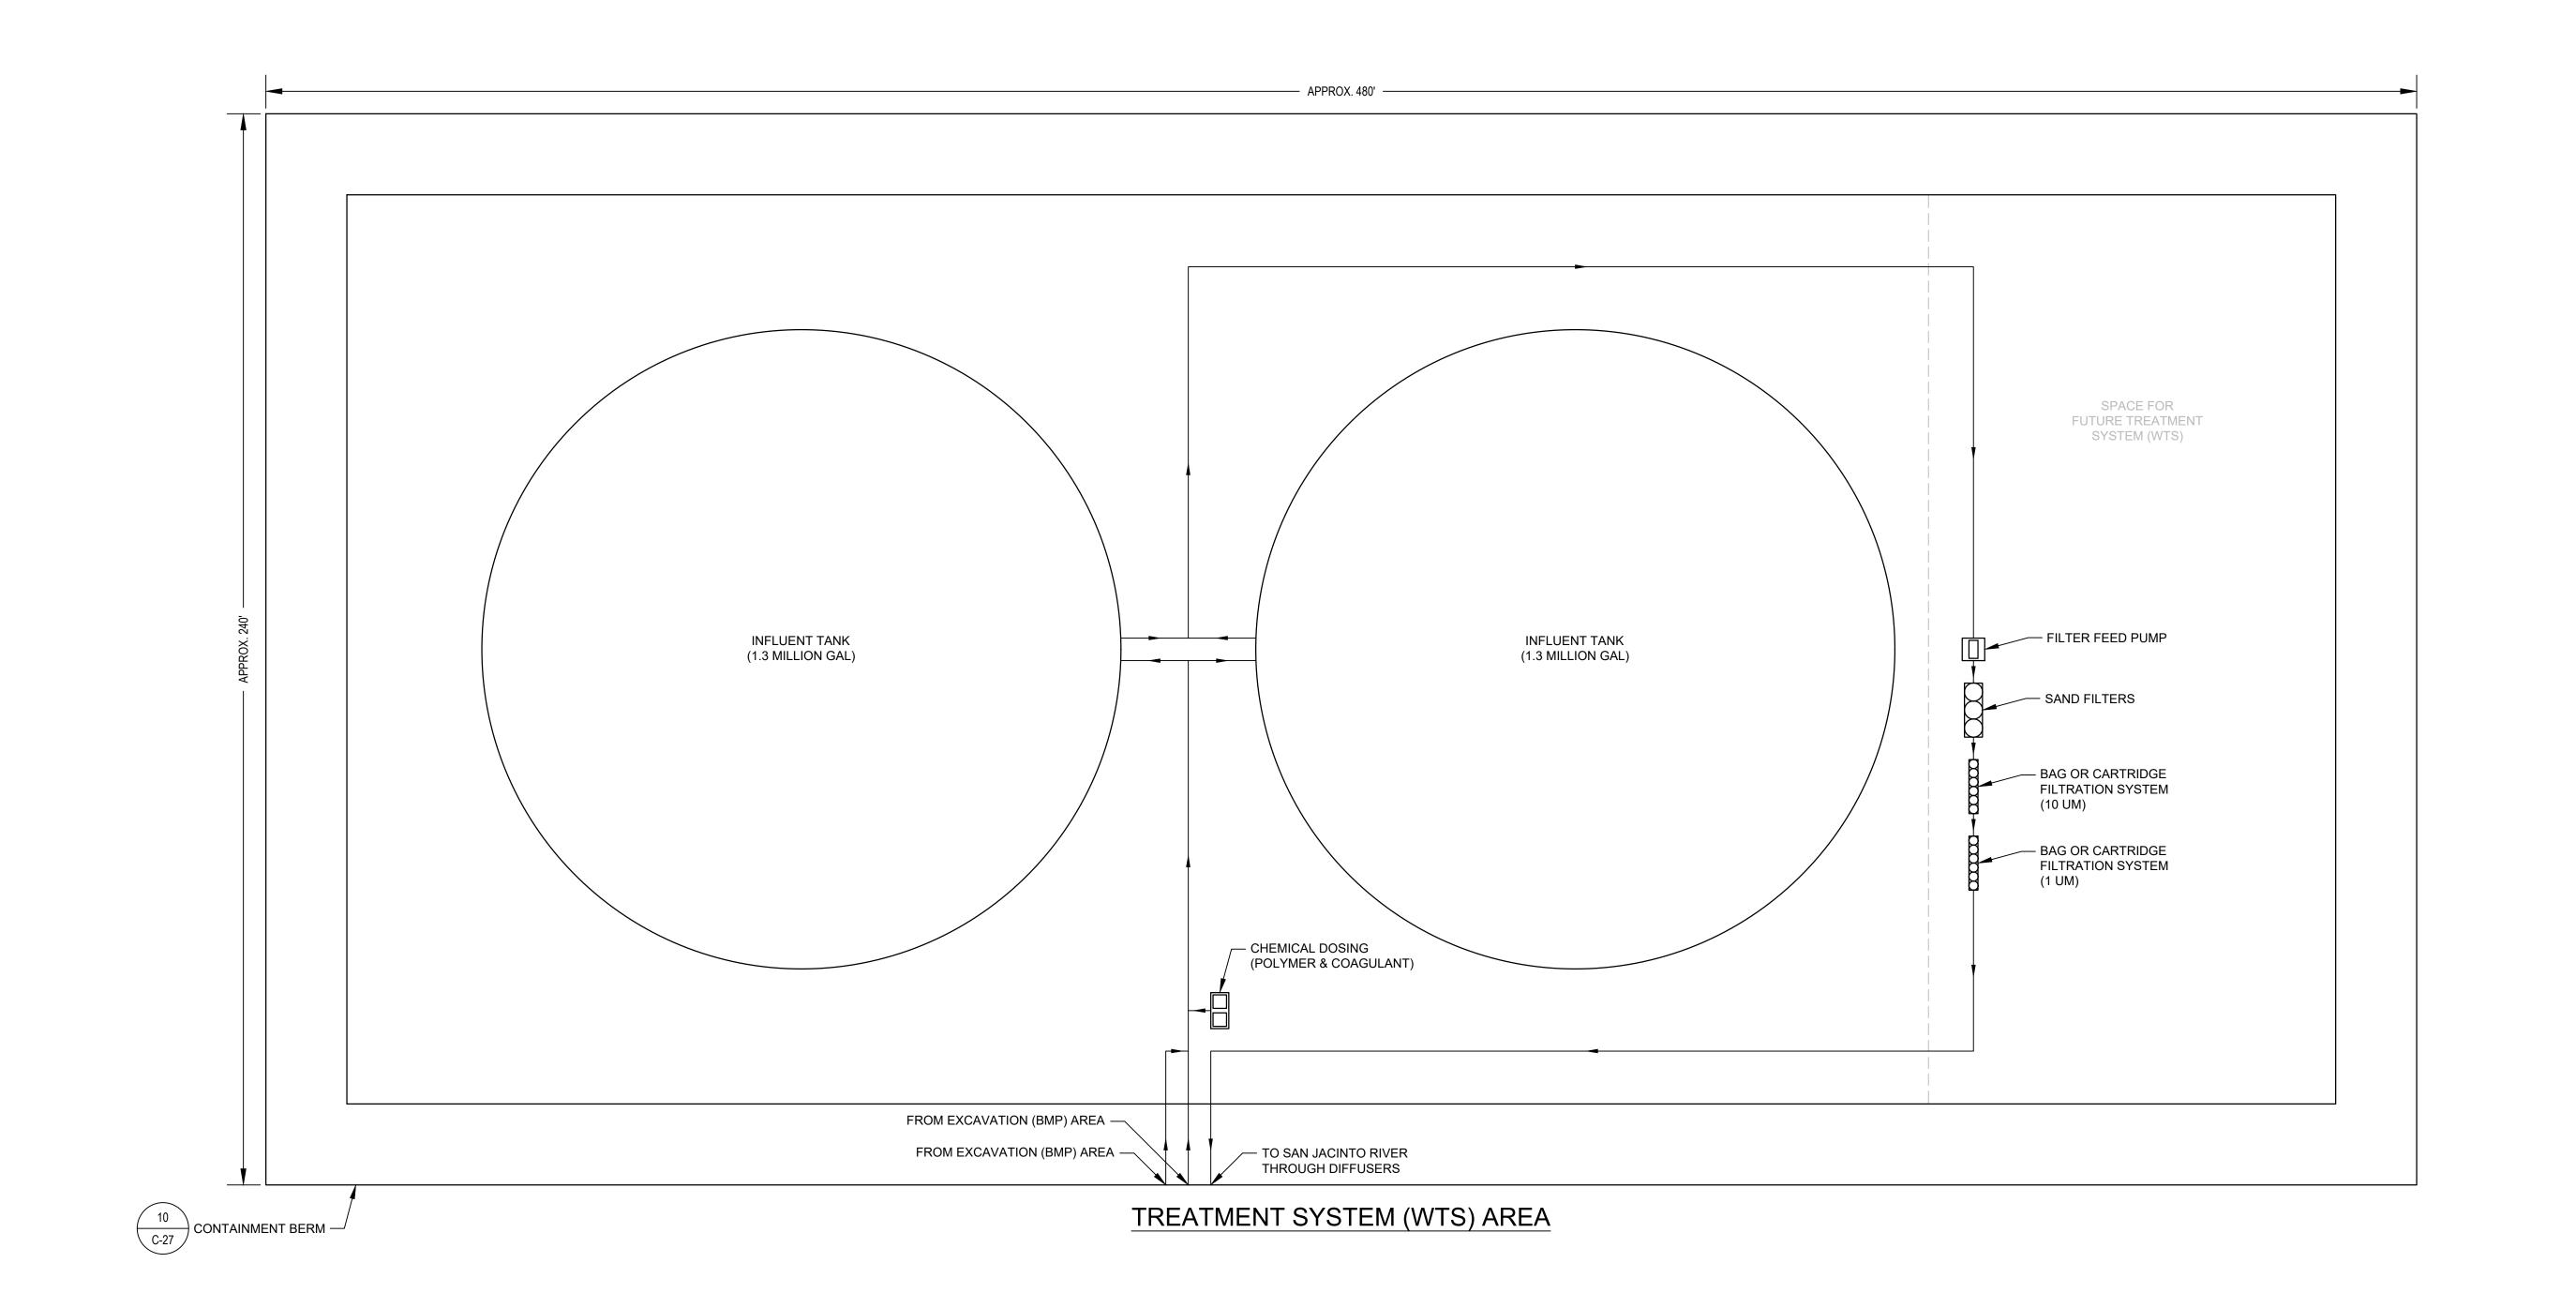

GHD

2237 S Acadian Thruway Suite 701
Baton Rouge Louisiana 70808 USA
T 225 292 9007



Reuse of Documents

This document and the ideas and designs incorporated herein, as an instrument of professional service, is the property of GHD and shall not be reused in whole or in part for any other project without GHD's written authorization. © 2024 GHD

SAN JACINTO RIVER
WASTE PITS

NORTHERN IMPOUNDMENT FINAL 100% REMEDIAL DESIGN HARRIS COUNTY, TEXAS



Project No. **11215702**

Arch D

Title

WATER TREATMENT SYSTEM
EQUIPMENT LAYOUT
(BULK WATER)

Bar is one inch on original size drawing

Sheet - of -

Sheet No.

P-011

100% EPA SUBMITTAL

GHD SERVICES INC.

JOB NO. 11215702 FILE NO. 001


GHD TEXAS FIRM REGISTRATION NO. 276

THIS DOCUMENT IS RELEASED FOR THE PURPOSE OF EPA REVIEW UNDER THE AUTHORITY OF NORTON

FOGEL, P.E. 144491 ON 07/17/2024. IT IS NOT TO BE

CONVEYANCE OR SALES PURPOSES.

USED FOR CONSTRUCTION, BIDDING, RECORDATION,

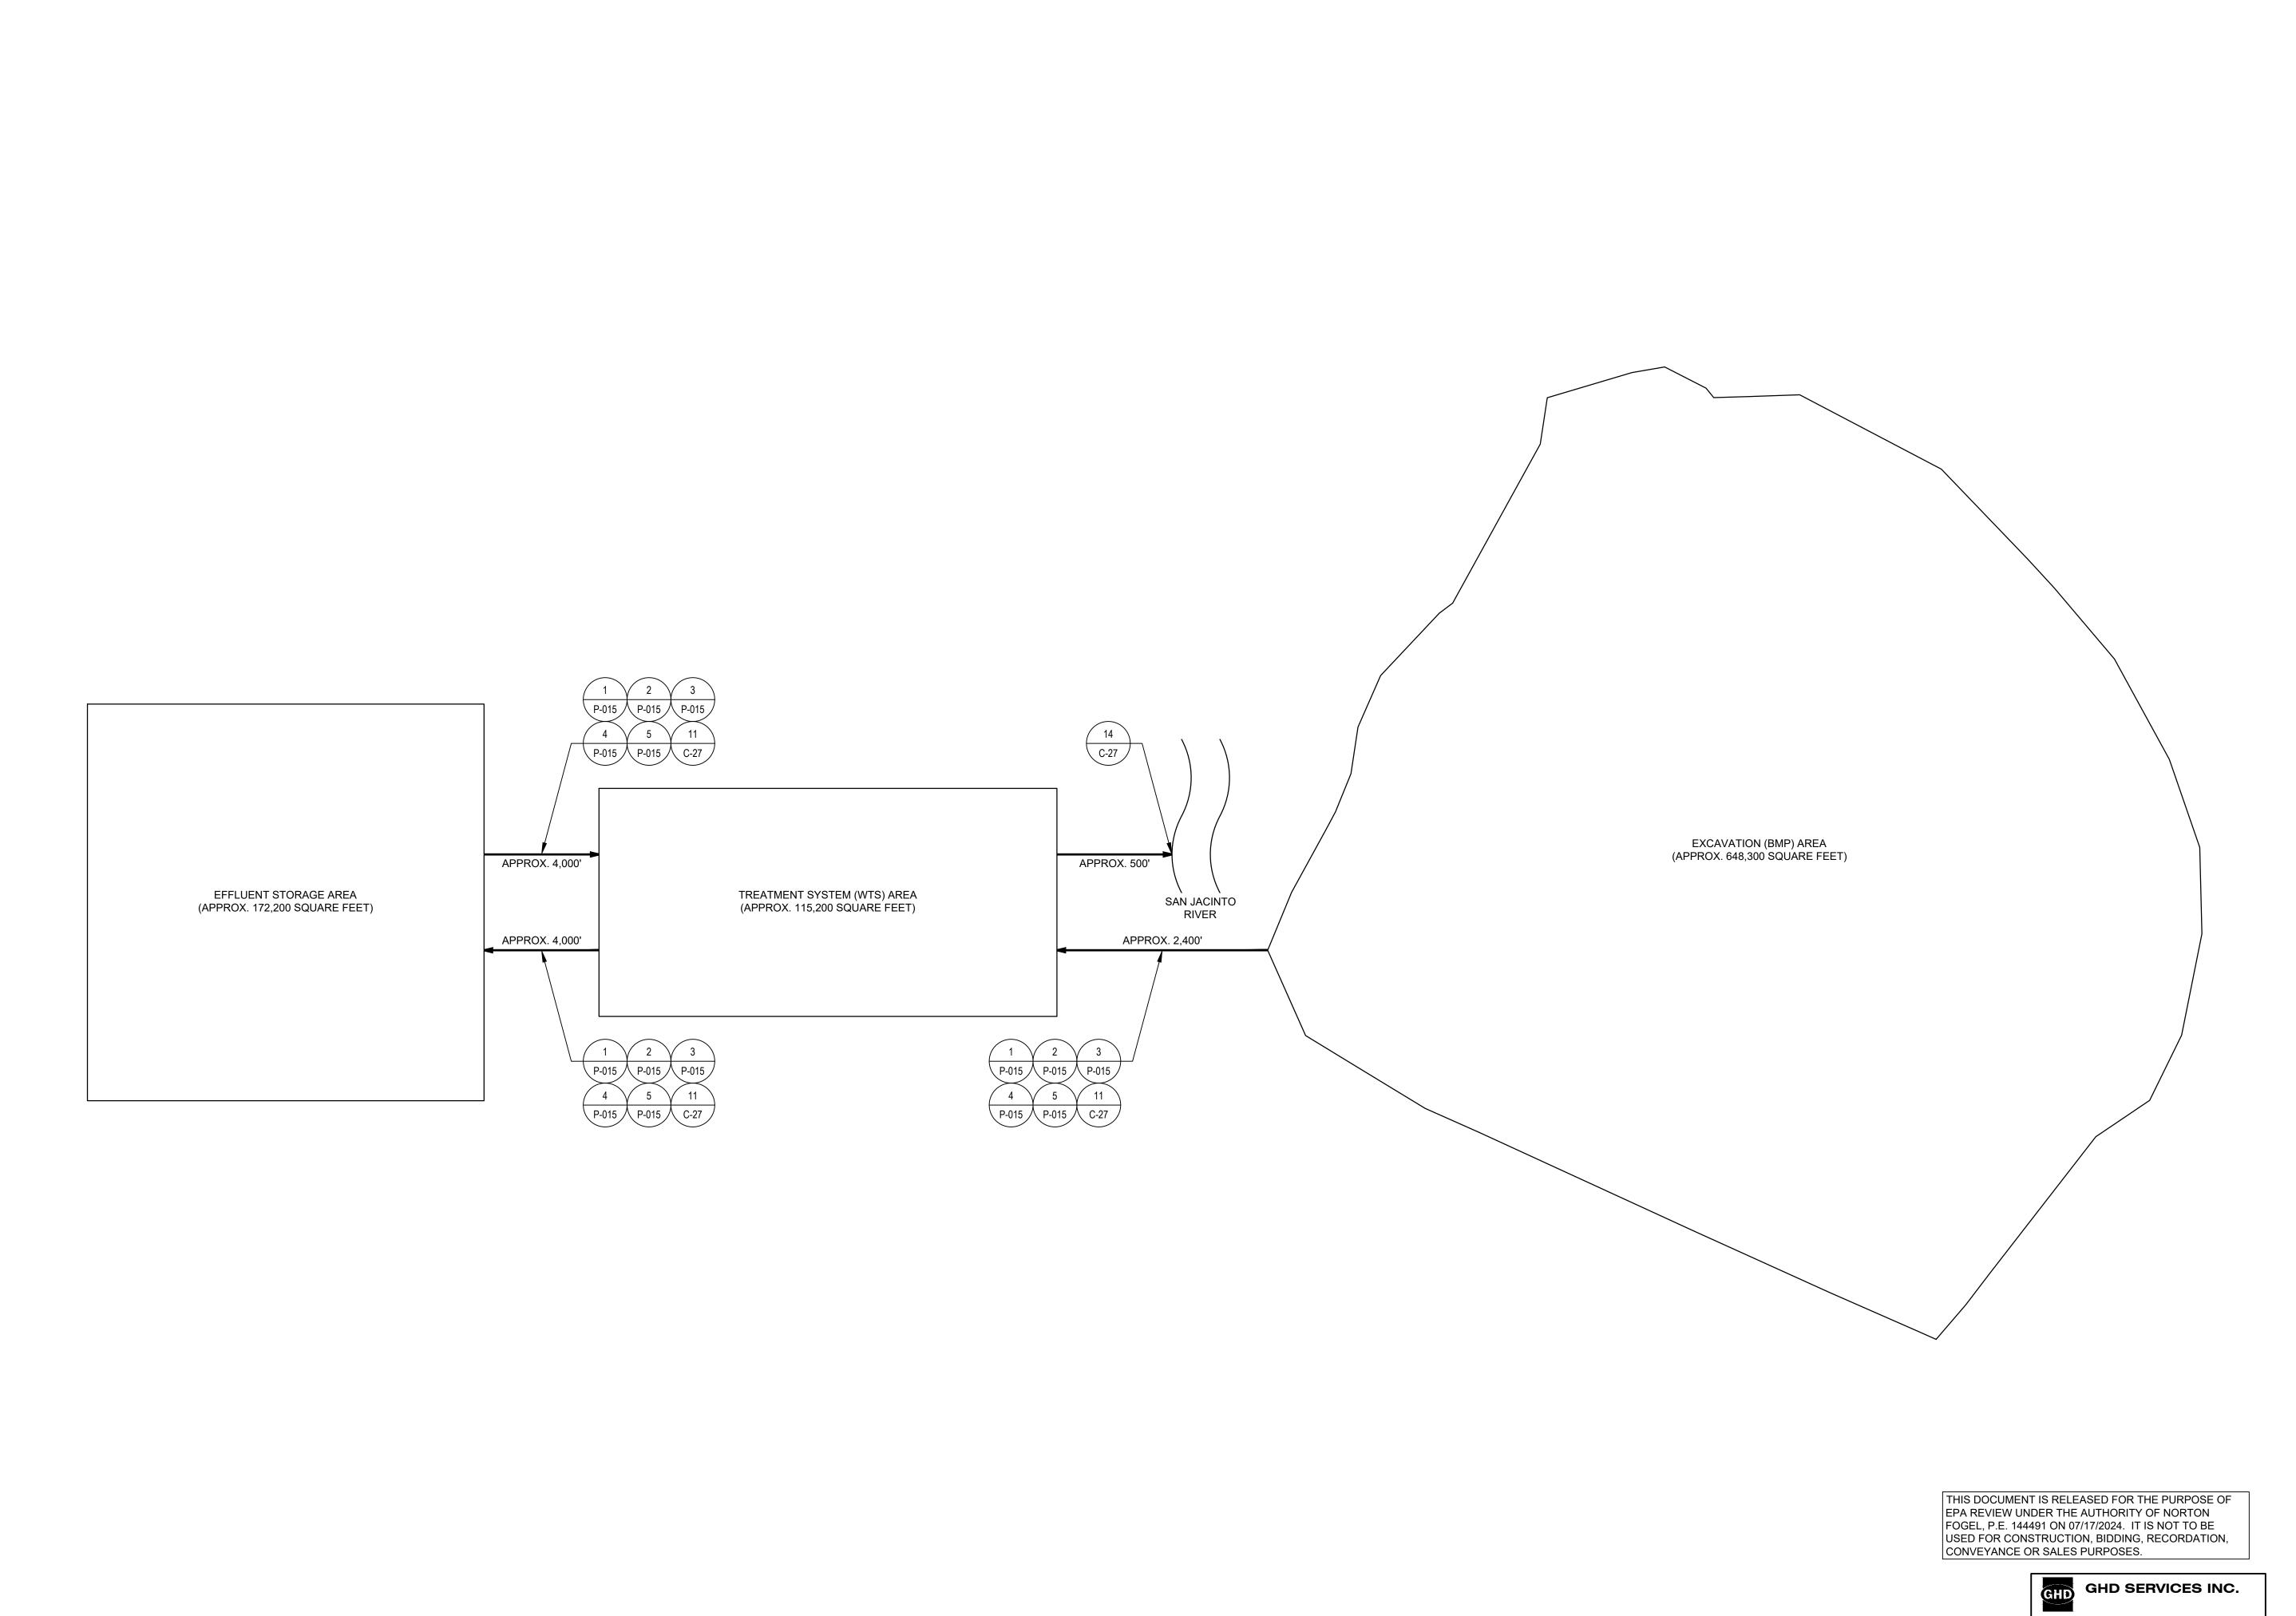



Reuse of Documents

This document and the ideas and designs incorporated herein, as an instrument of professional service, is the property of GHD and shall not be reused in whole or in part for any other project without GHD's written authorization. © 2024 GHD

SAN JACINTO RIVER WASTE PITS

NORTHERN IMPOUNDMENT FINAL 100% REMEDIAL DESIGN HARRIS COUNTY, TEXAS

1	100% EPA SUBMITTAL	RH		07/17
No.	Issue	Drawn	Approved	Da
Draw	n RH	Designer	NF	
Drafting Check		Design Check	NF	
Project LL Coordinator		Date	July 17, 2024	
This document shall not be used for construction unless signed and sealed for construction.		Scale	N.T.S.	

Arch D

Project No. **11215702**

Original Size

WATER TREATMENT SYSTEM SITE PLAN (CONTACT WATER)

Bar is one inch on original size drawing

Sheet - of -

Sheet No.

P-012

100% EPA SUBMITTAL

JOB NO. 11215702 FILE NO. 001

GHD TEXAS FIRM REGISTRATION NO. 276


Plot Date: 17 July 2024 - 1:10 PM


NOTES:

1. SITE PLANS ARE CONCEPTUAL ONLY AND ARE TO BE FINALIZED BY CONTRACTOR.

2. CONTRACTOR SHALL PROVIDE LEAK DETECTION AT LOW POINT ON ALL PIPELINES (SEE DETAIL 4/P-015).

3. CONTRACTOR SHALL INSTALL BIDIRECTIONAL CLEANOUTS EVERY 500' (MINIMUM) ON ALL PIPELINES.

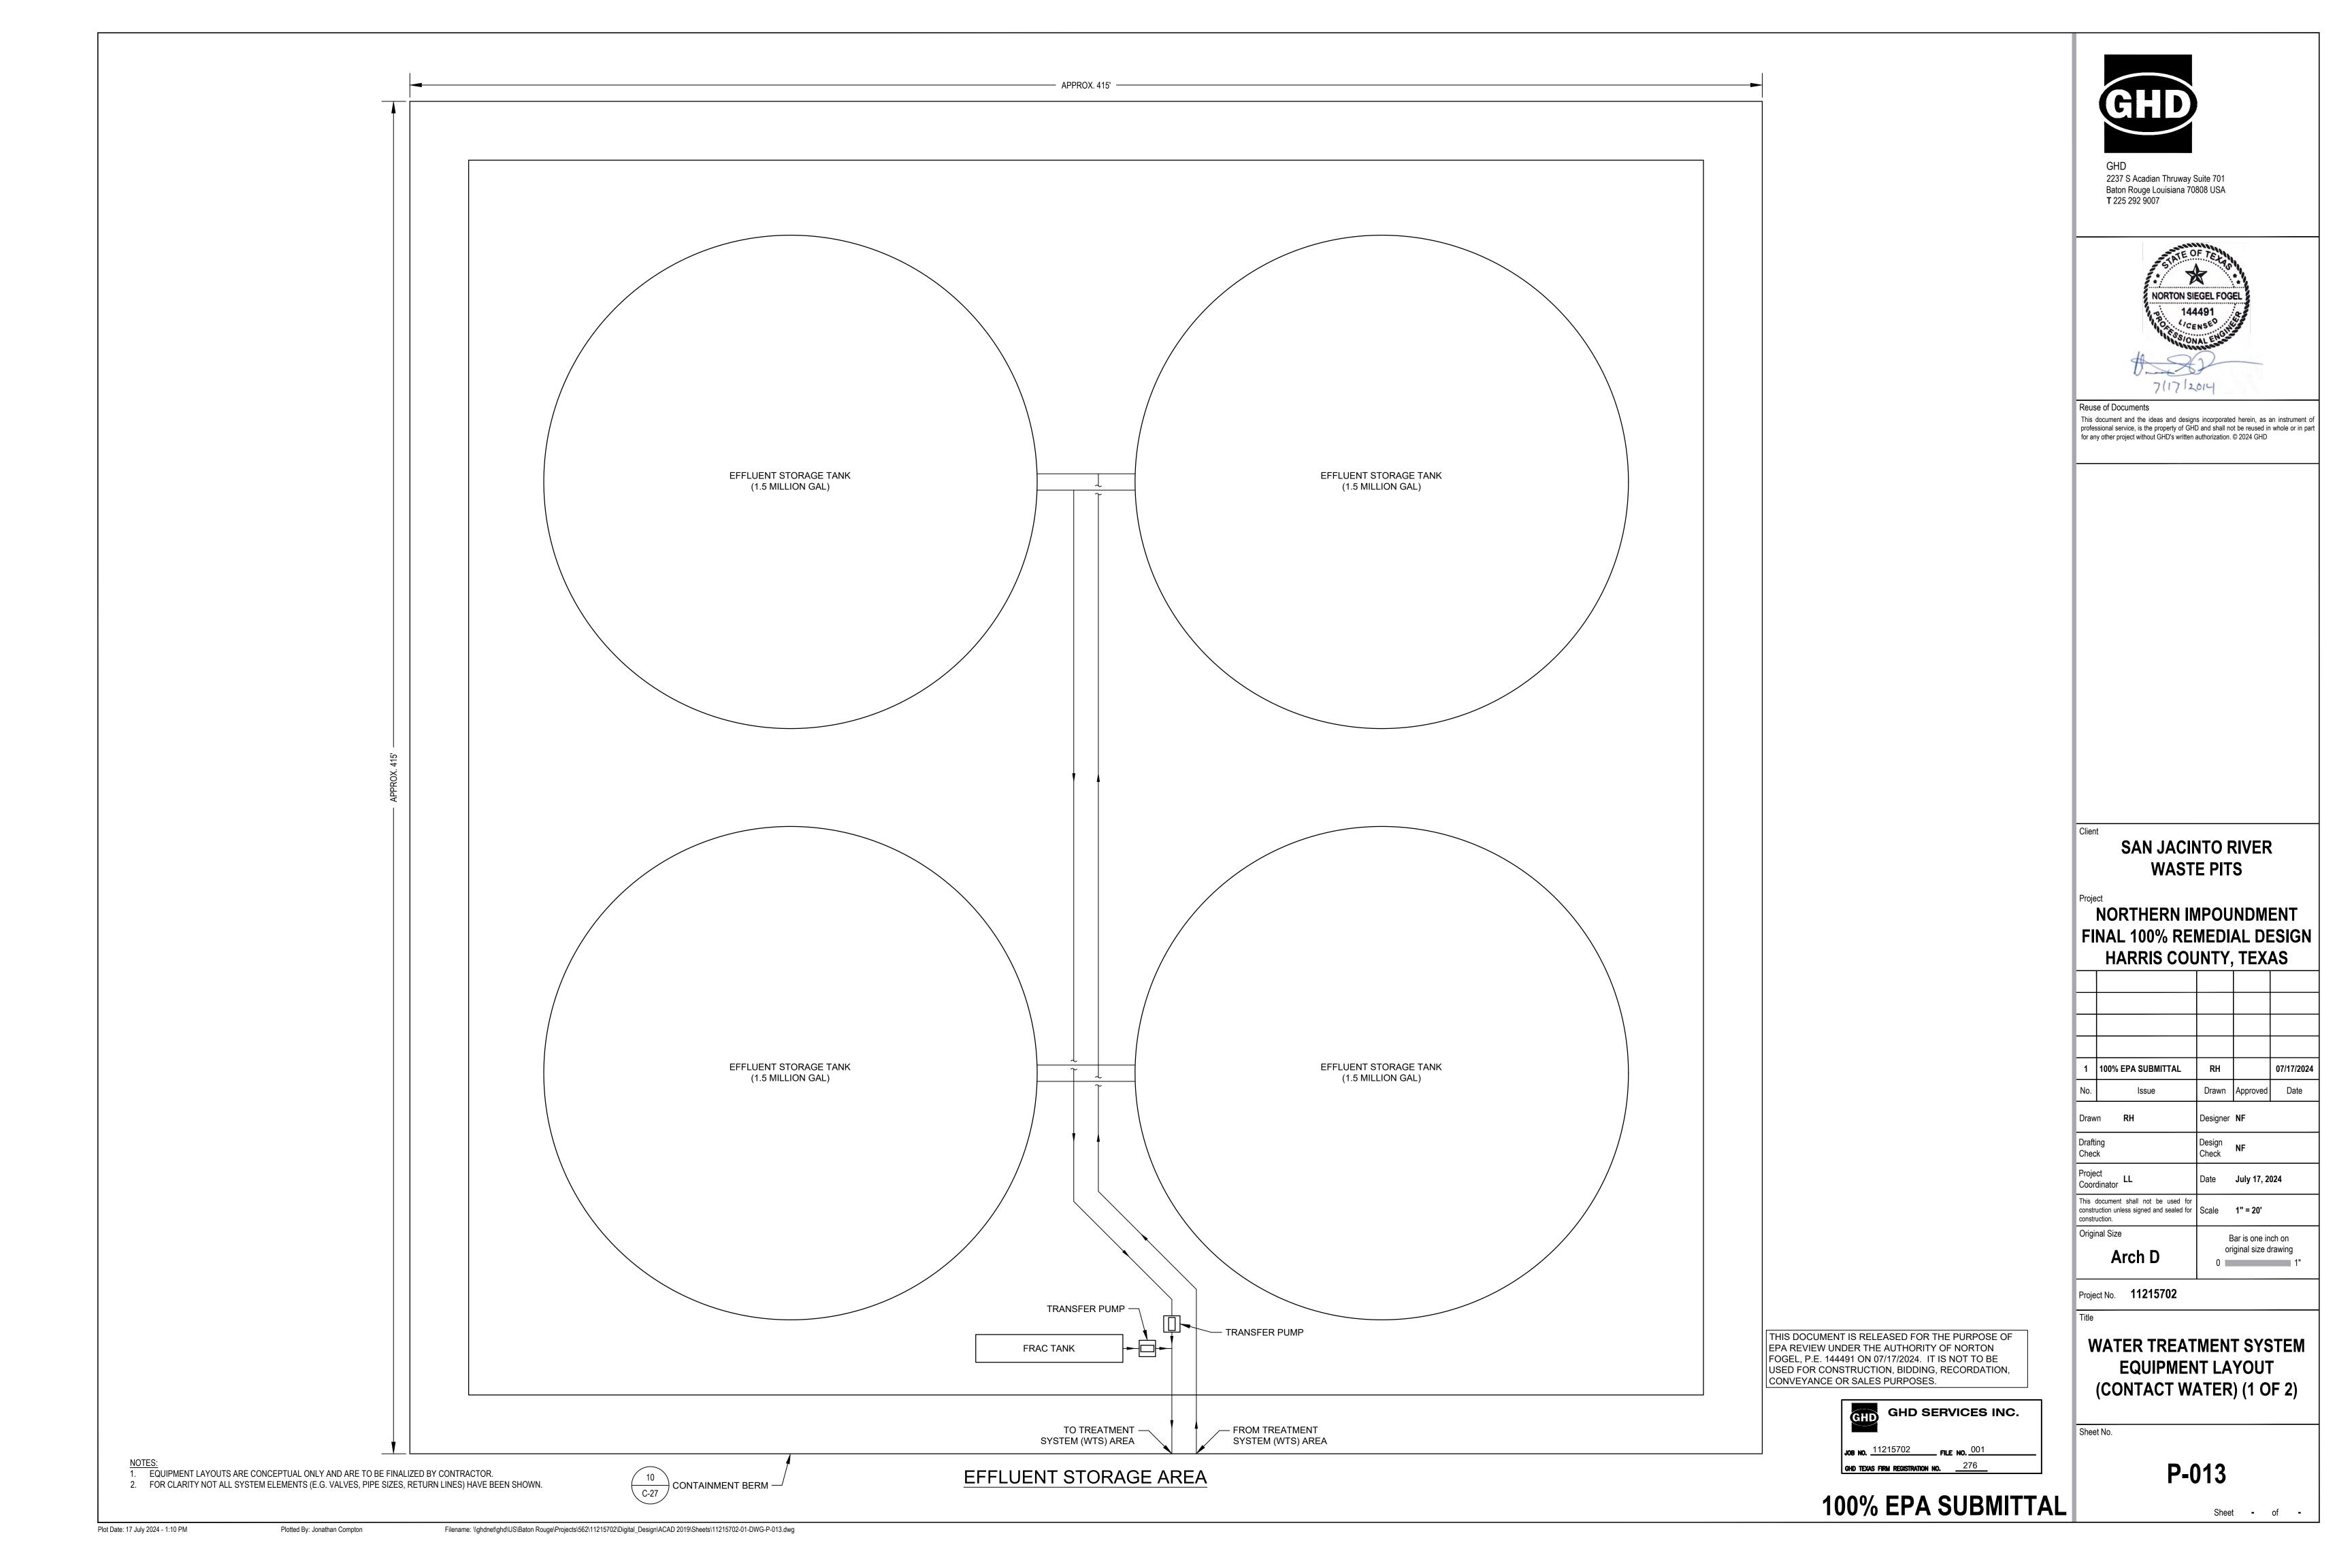

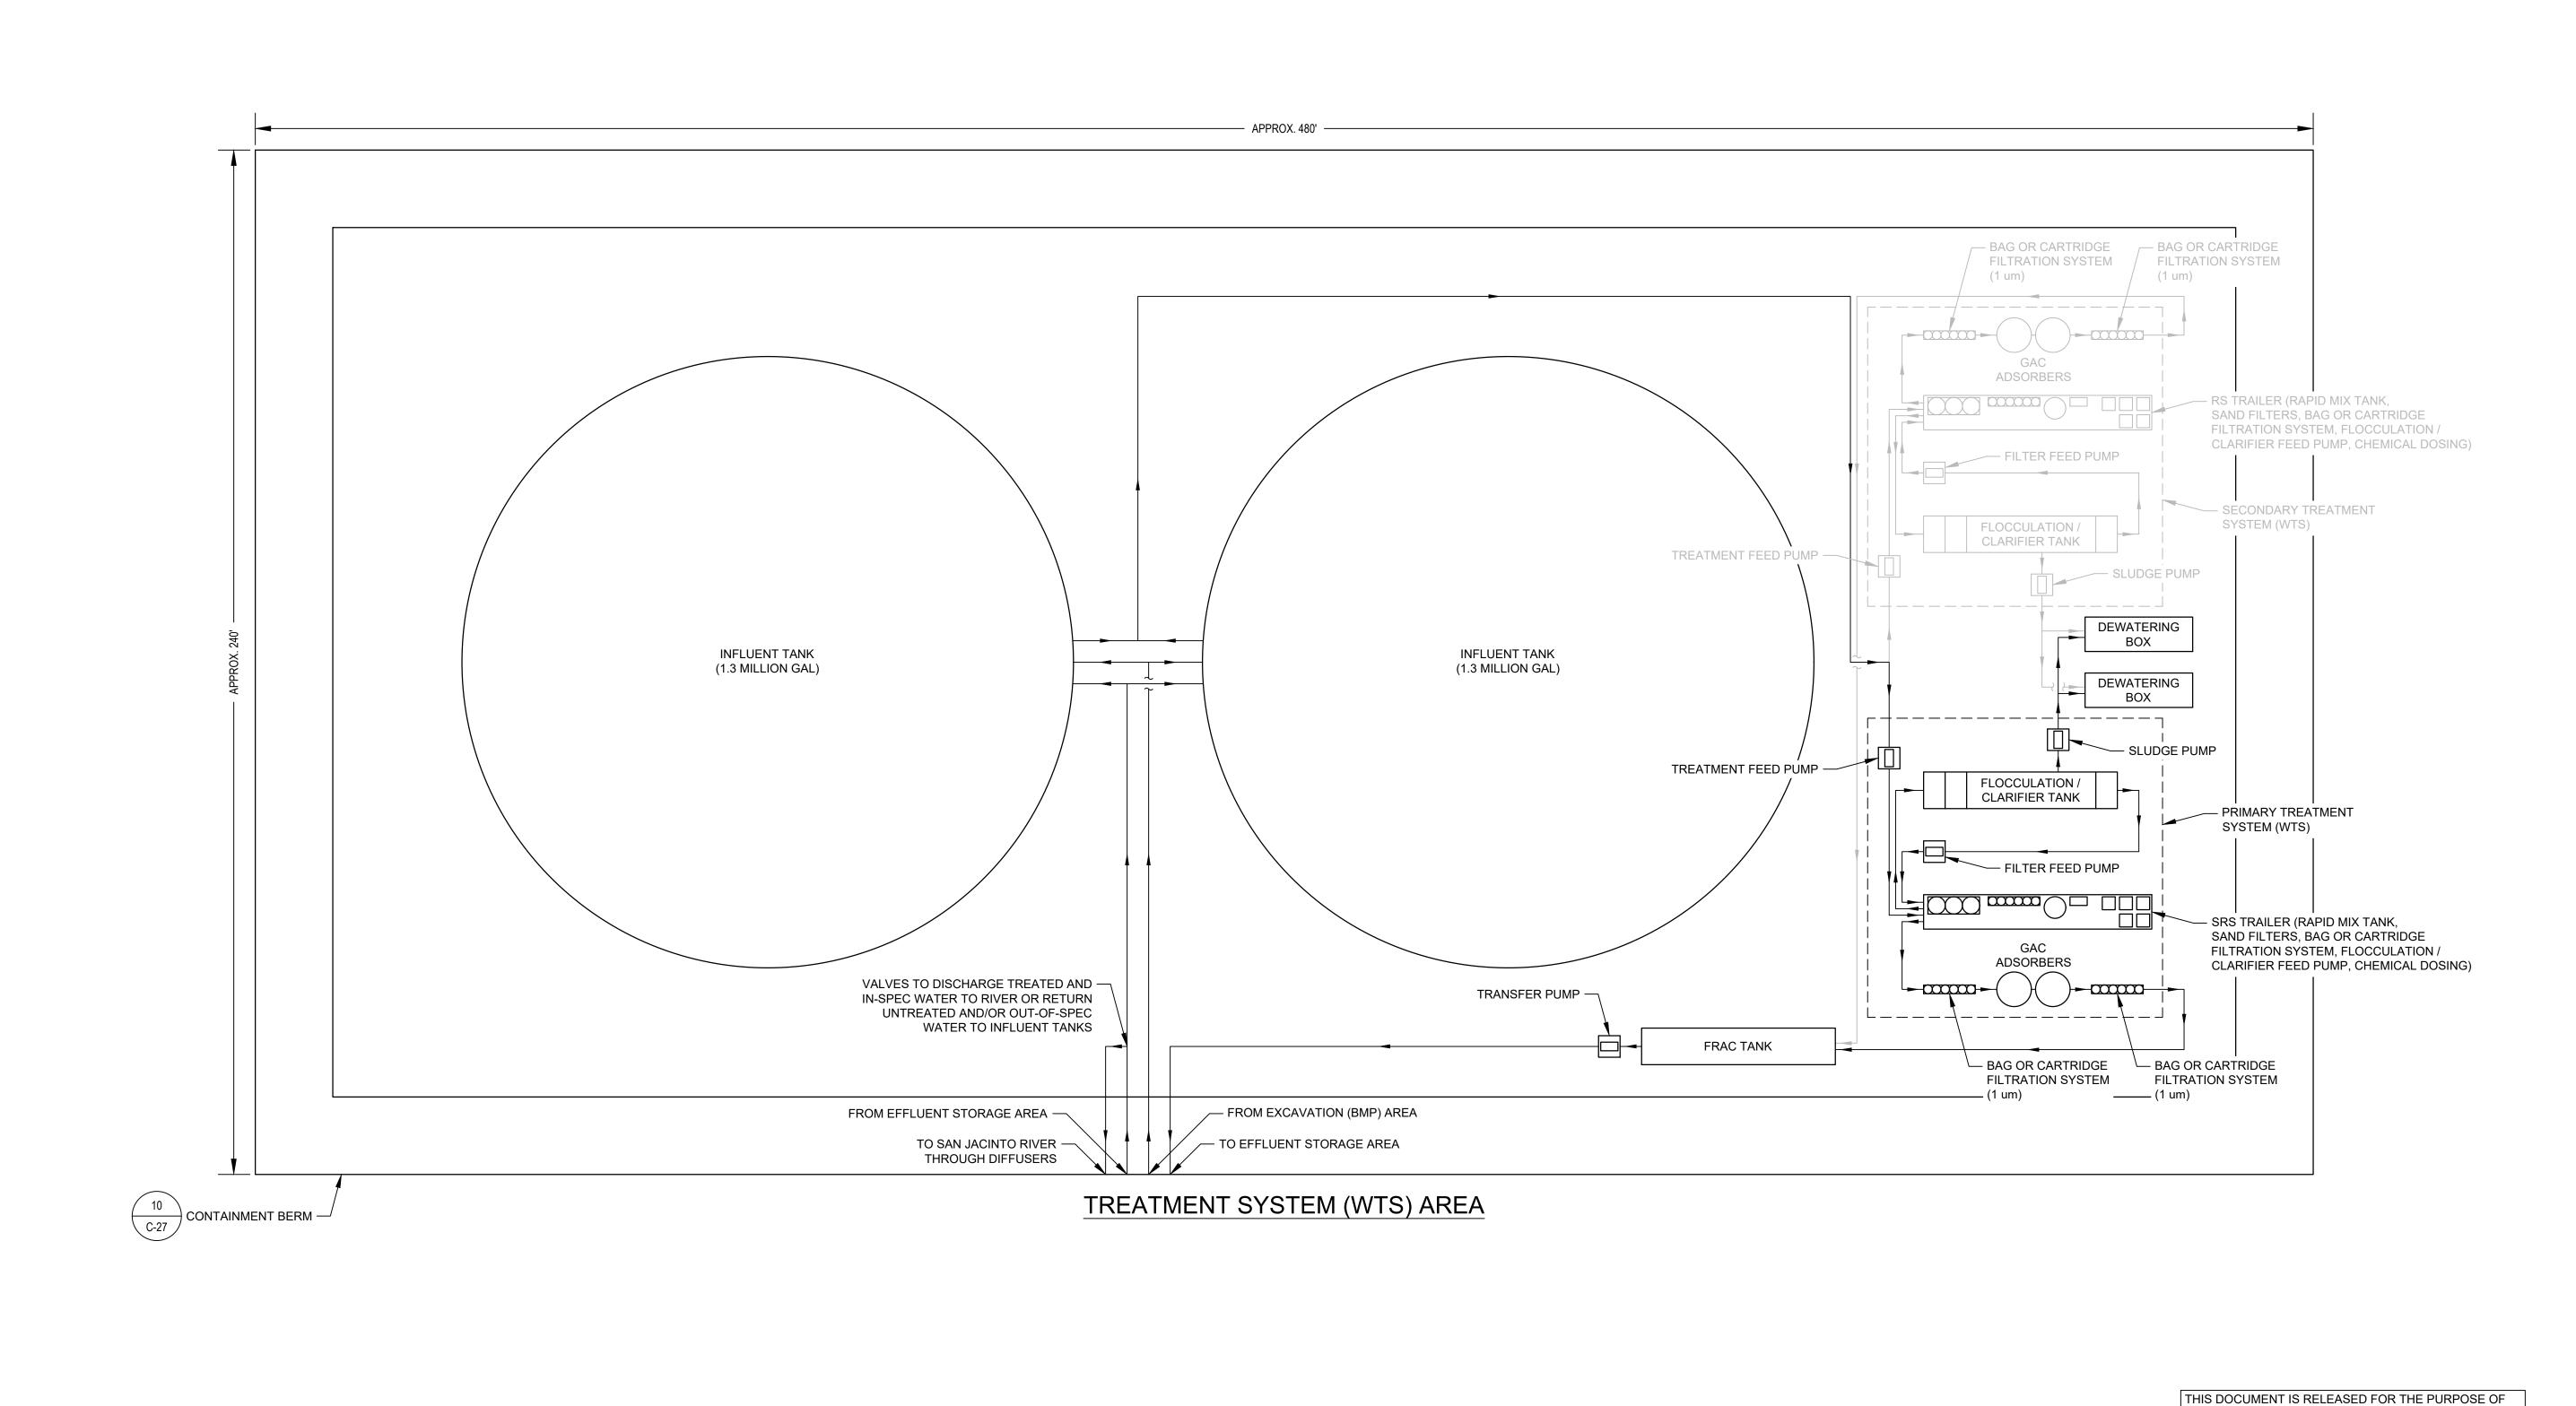




Reuse of Documents

This document and the ideas and designs incorporated herein, as an instrument of professional service, is the property of GHD and shall not be reused in whole or in part for any other project without GHD's written authorization. © 2024 GHD

SAN JACINTO RIVER WASTE PITS

NORTHERN IMPOUNDMENT FINAL 100% REMEDIAL DESIGN HARRIS COUNTY, TEXAS

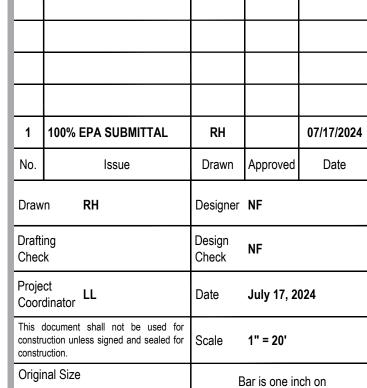

Project No. **11215702**

Arch D

EPA REVIEW UNDER THE AUTHORITY OF NORTON FOGEL, P.E. 144491 ON 07/17/2024. IT IS NOT TO BE

CONVEYANCE OR SALES PURPOSES.

USED FOR CONSTRUCTION, BIDDING, RECORDATION,

GHD SERVICES INC.

100% EPA SUBMITTAL

JOB NO. 11215702 FILE NO. 001

GHD TEXAS FIRM REGISTRATION NO. 276

WATER TREATMENT SYSTEM **EQUIPMENT LAYOUT** (CONTACT WATER) (2 OF 2)

original size drawing

Sheet - of -

Sheet No.

P-014

Plot Date: 17 July 2024 - 1:10 PM


Plotted By: Jonathan Compton

2. FOR CLARITY NOT ALL SYSTEM ELEMENTS (E.G. VALVES, PIPE SIZES, RETURN LINES) HAVE BEEN SHOWN.


NOTES:

1. EQUIPMENT LAYOUTS ARE CONCEPTUAL ONLY AND ARE TO BE FINALIZED BY CONTRACTOR.


Filename: \\ghdnet\ghd\US\Baton Rouge\Projects\562\11215702\Digital_Design\ACAD 2019\Sheets\11215702-01-DWG-P-014.dwg

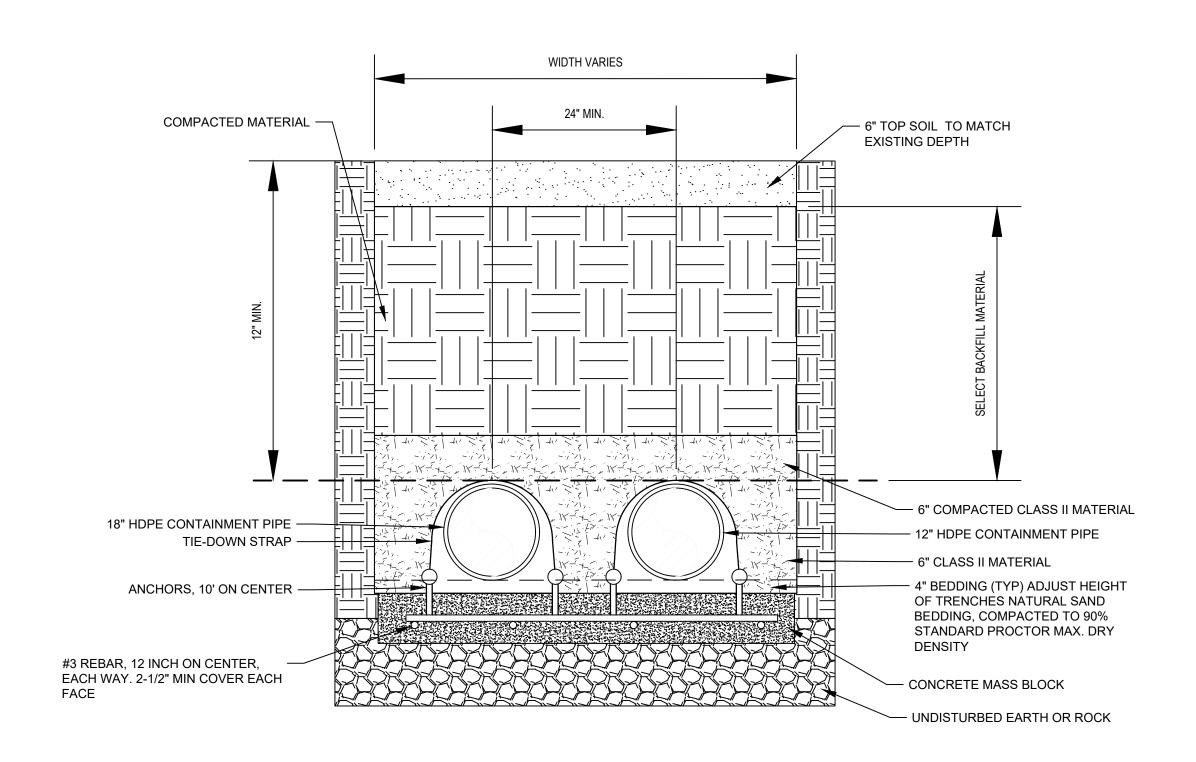


UTILITY TRENCH - GROUND COVER

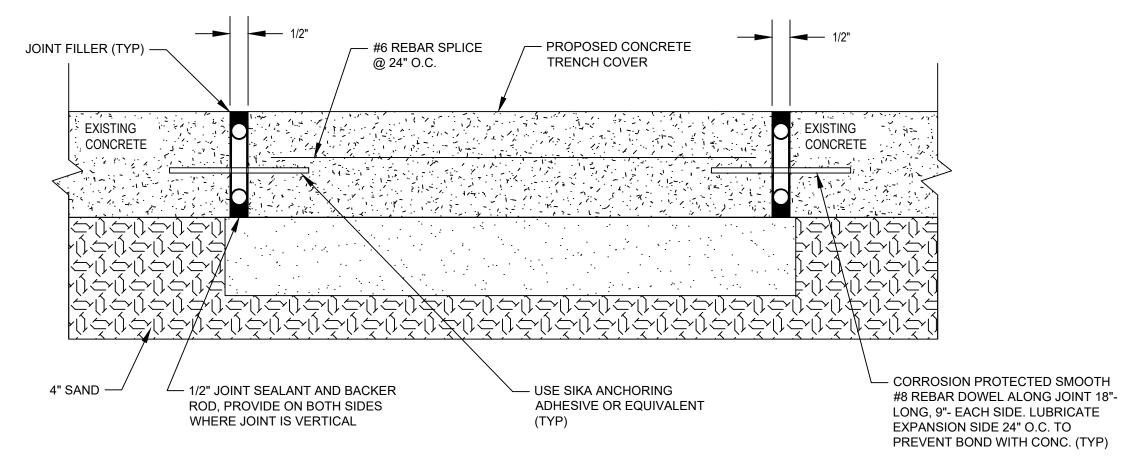


TRENCH COVER OVER RIGID PAVEMENT **DETAIL** SCALE: NTS

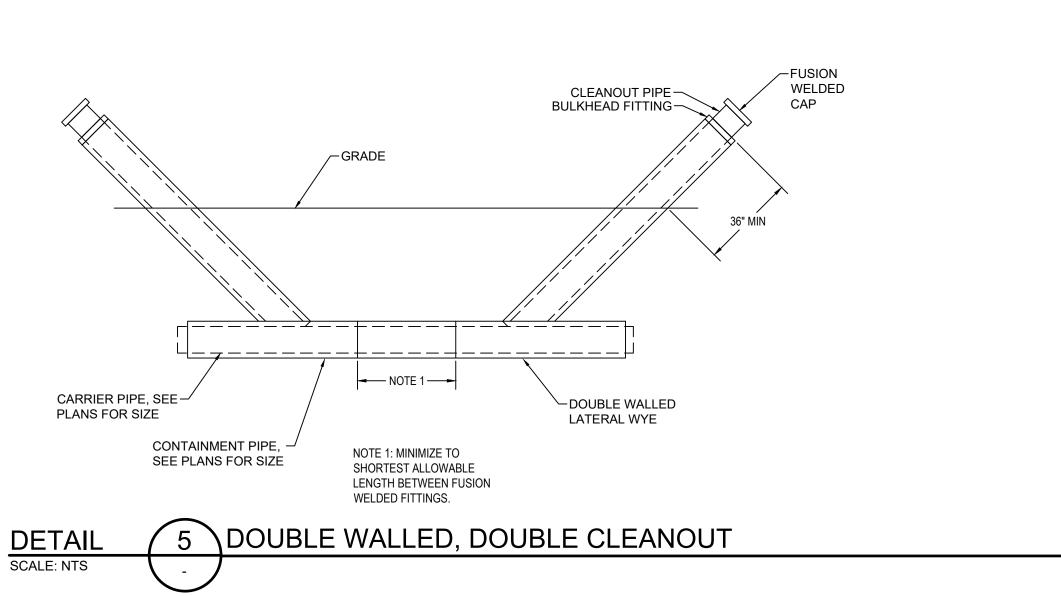

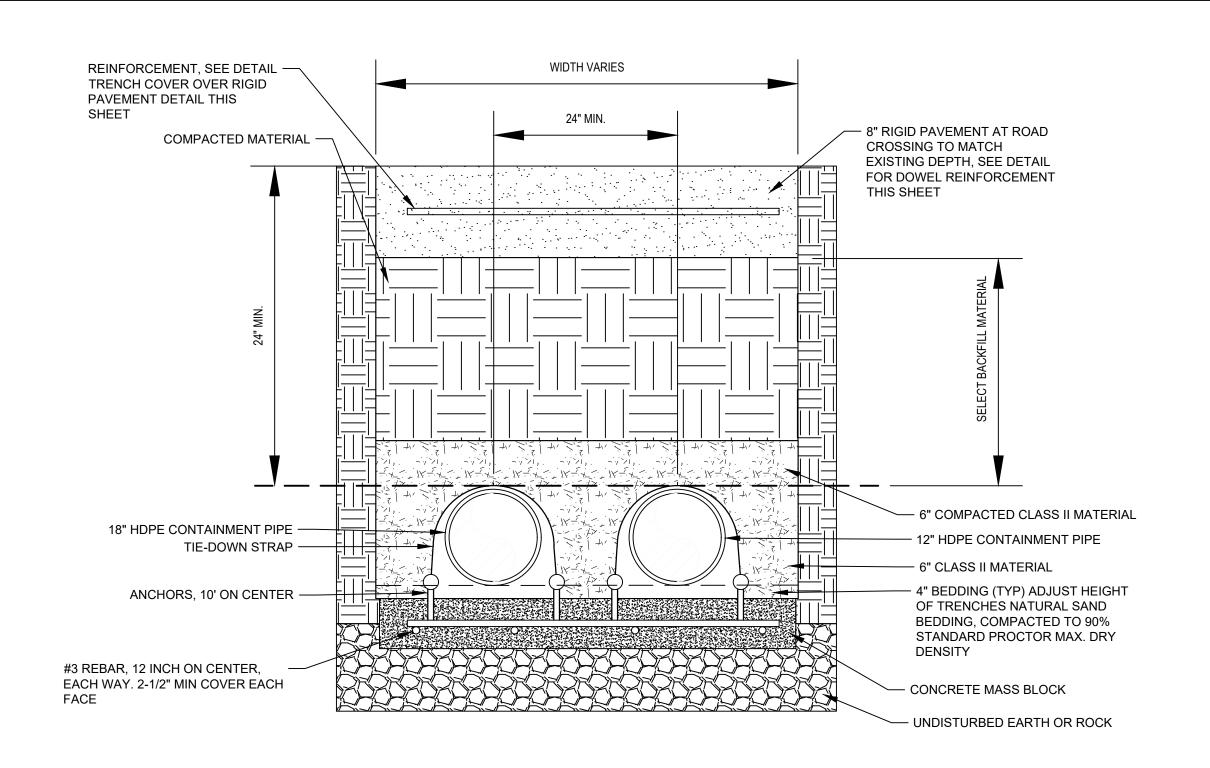


\UTILITY TRENCH - RIGID PAVEMENT OR ROADWAY SURFACE

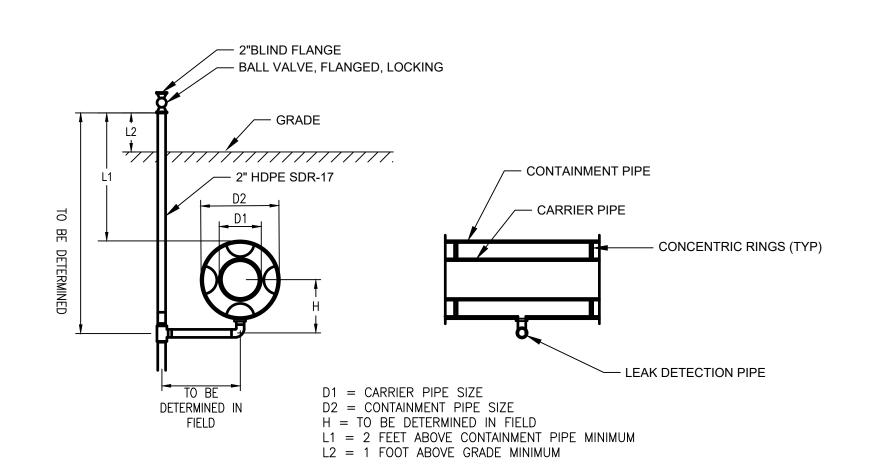

1. FOR ABOVE GROUND INSTALLATIONS, 2" PIPE MUST BE ABOVE GRADE AND CLEAR OF SUPPORTS TO AVOID DAMAGE FROM THERMAL



THIS DOCUMENT IS RELEASED FOR THE PURPOSE OF EPA REVIEW UNDER THE AUTHORITY OF NORTON FOGEL, P.E. 144491 ON 07/17/2024. IT IS NOT TO BE USED FOR CONSTRUCTION, BIDDING, RECORDATION, CONVEYANCE OR SALES PURPOSES.

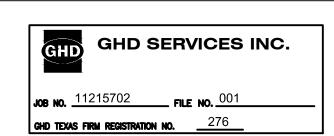

100% EPA SUBMITTAL



2237 S Acadian Thruway Suite 701 Baton Rouge Louisiana 70808 USA **T** 225 292 9007



Reuse of Documents

This document and the ideas and designs incorporated herein, as an instrument of professional service, is the property of GHD and shall not be reused in whole or in part for any other project without GHD's written authorization. © 2024 GHD

Client **SAN JACINTO RIVER WASTE PITS**

NORTHERN IMPOUNDMENT FINAL 100% REMEDIAL DESIGN HARRIS COUNTY, TEXAS

1	100% EPA SUBMITTAL			07/17/2
No.	Issue	Drawn	Approved	Date
Draw	n EAW	Designer	WSK	
Drafting Check		Design Check	WSK	
Project CM Coordinator		Date	July 17, 2	024
This	document shall not be used for			

construction unless signed and sealed for Scale AS SHOWN

Arch D

Project No. **11215702**

Original Size

MECHANICAL DETAILS 1 OF 1

Bar is one inch on original size drawing

Sheet No.


P-015


Sheet - of -

Plot Date: 17 July 2024 - 1:10 PM

Plotted By: Jonathan Compton

Filename: \\ghdnet\ghd\US\Baton Rouge\Projects\562\11215702\Digital_Design\ACAD 2019\Sheets\11215702-01-DWG-P-015.dwg

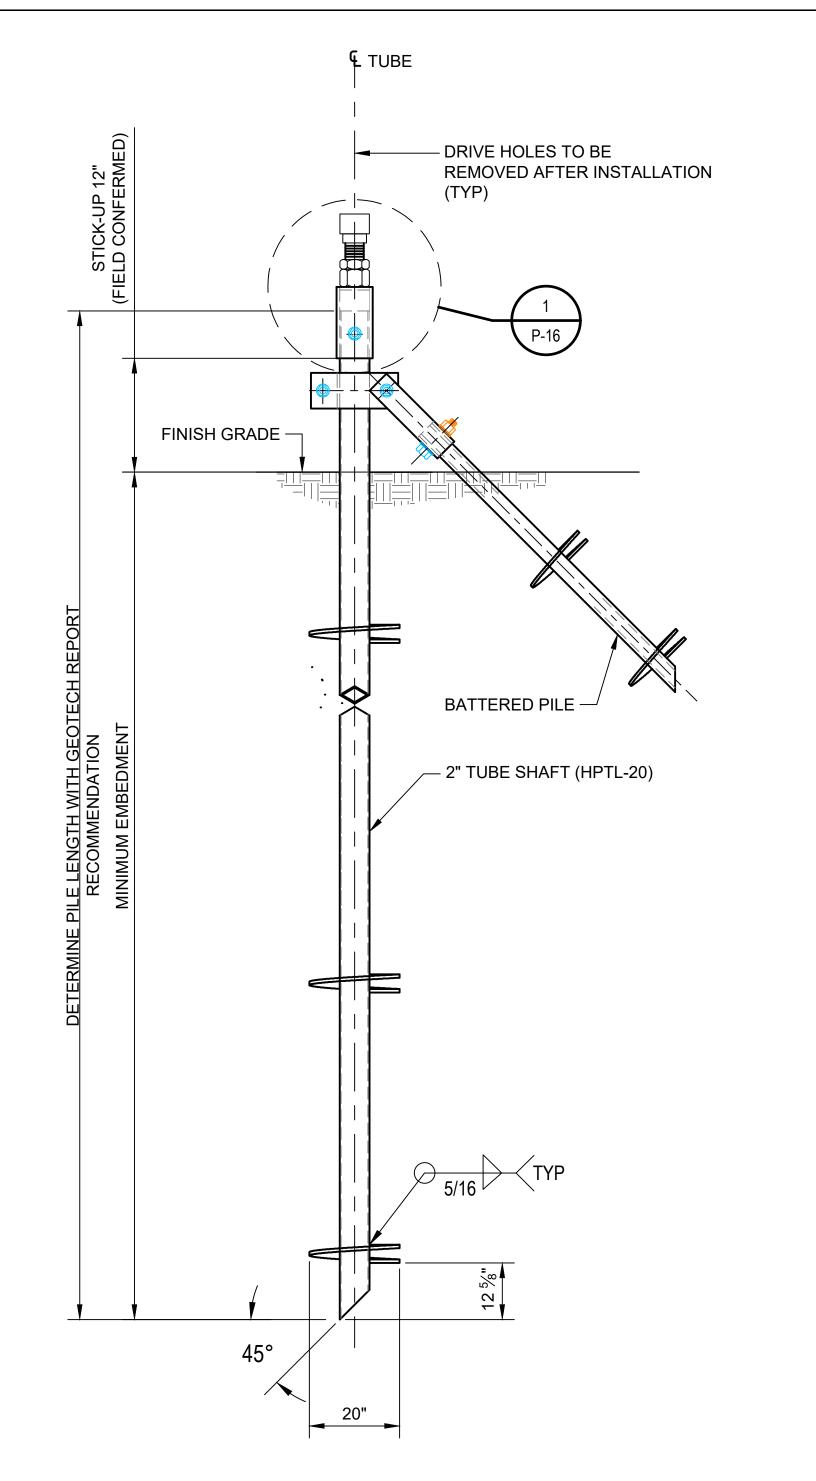

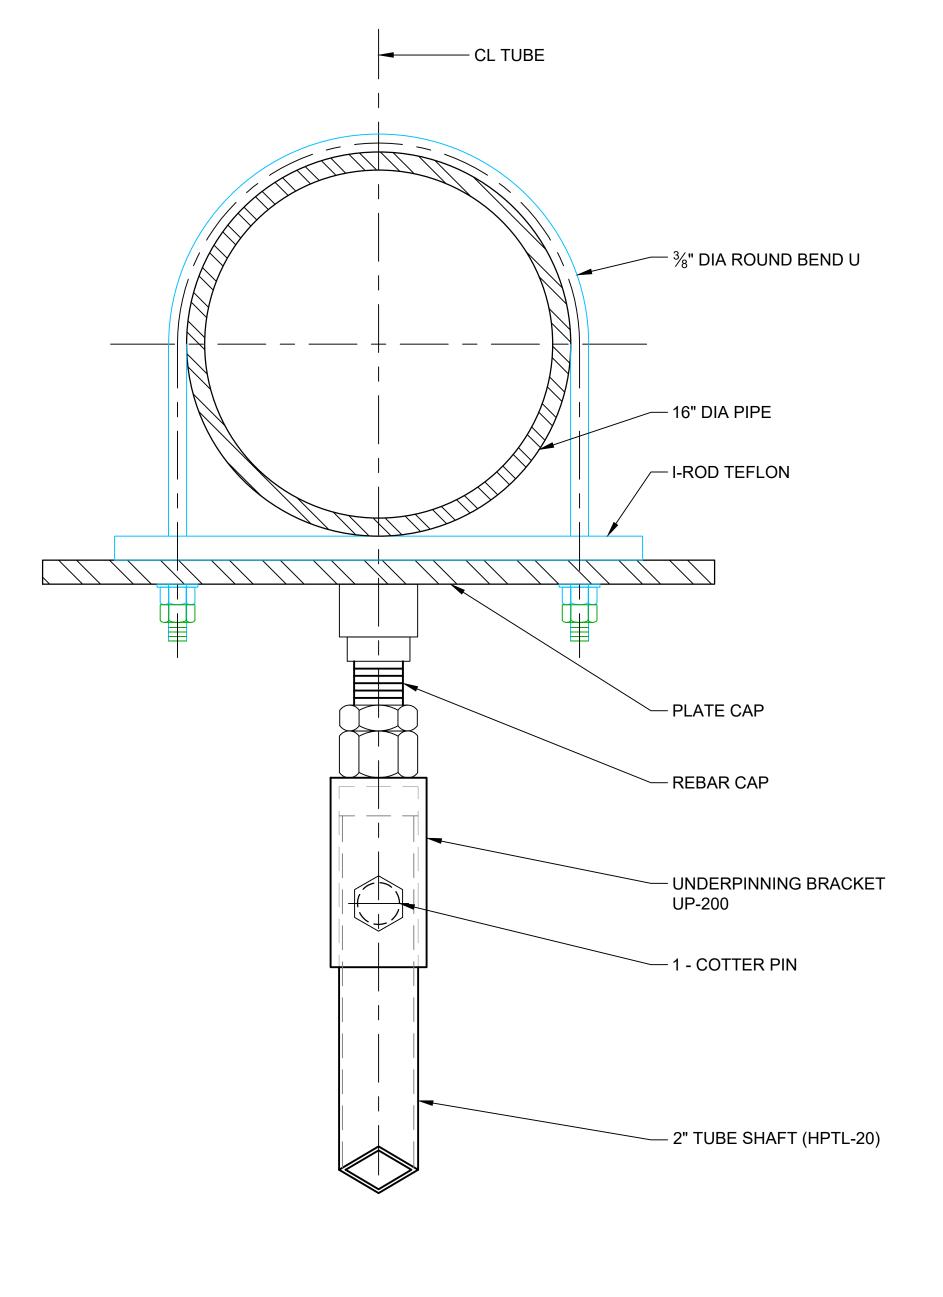

HELICAL COMPOSITE PILE HPTL-20 **DETAIL** SCALE: NTS P-16

DETAIL SCALE: NTS

PIPE SUPPORT BRAKET FOR 16" PIPE

NOTES:

- 1. CONTRACTOR TO SUB-CONTRACT GEOTECH ENGINEER LICENSE IN THE STATE OF TEXAS FOR THE DESIGN OF PIPE SUPPORTS.
- DESIGN CRITERIA

BASIC WIND SPEED, V: 143 mph WIND EXPOSURE:

135 bl/ft (ASSUMING 16" STEEL SCH 40

PIPE WEIGHT: SHELL / 12" HDPE SDR 7)

USE BATTERED PILE AT EACH END OF THE PIPE RUN WITH A MAXIMUM OF 100 FT SPACING FOR BATTERED PILES.

4. HARDWARE TO BE HELI-PILE OR APROVED EQUAL.

CONTACT: **HELI-PILE**

A: 5135 WARD ROAD

WHEATRIDGE, CO 80033

P: 303-423-0591 W: https://helipile.com

2237 S Acadian Thruway Suite 701 Baton Rouge Louisiana 70808 USA **T** 225 292 9007



Reuse of Documents

This document and the ideas and designs incorporated herein, as an instrument of professional service, is the property of GHD and shall not be reused in whole or in part for any other project without GHD's written authorization. © 2024 GHD

SAN JACINTO RIVER WASTE PITS

NORTHERN IMPOUNDMENT FINAL 100% REMEDIAL DESIGN HARRIS COUNTY, TEXAS

ı							
ı	3	3 100% EPA REVIEW		SC	07/17/20		
ı	2	90% EPA REVIEW	DS	SC	06/27/20		
ı	No.	Issue	Drawn	Approved	Date		
ı	Draw	n AL	Designer TN				
ı	Drafti Chec	•	Design Check				
ı	Proje Coor	ct dinator	Date Jul 17, 2024				
	constr	This document shall not be used for construction unless signed and sealed for construction.		Scale AS SHOWN			
ı	Origii	nal Size		ar is one in ginal size d			

Project No. **11215702**

Arch D

HELICAL PILE DETAILS


Sheet No.

P-016

Sheet - of -

100% EPA SUBMITTAL

THIS DOCUMENT IS RELEASED FOR THE PURPOSE OF EPA REVIEW UNDER THE AUTHORITY OF SATISH CHILKA, P.E. 145120 ON 07/17/2024. IT IS NOT TO BE USED FOR CONSTRUCTION, BIDDING, RECORDATION, CONVEYANCE OR SALES PURPOSES.

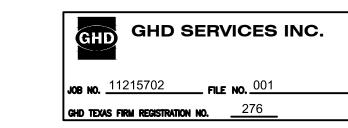

Plot Date: 17 July 2024 - 1:11 PM

		PUM	IP SCH	HEDUL	.E					
	SERVICE	CAPACITY ELECTRICITY			RICITY		POTENTIAL			
PUMP NO.		FLOW (GPM)		KW	HP	VOLTS	PHASE MANUFACTUREER	VENDOR	MODEL	REMARKS
P-3001	FILTER FEED (BULK WATER)	4,000						TREATMENT VENDOR		
P-3002A	EXCAVATION (BMP) AREA DEWATERING TO INFLUENT TANK	2,000	90					RAIN FOR RENT	DV-200C	
P-3002B	EXCAVATION (BMP) AREA DEWATERING TO INFLUENT TANK	2,000	90					RAIN FOR RENT	DV-200C	
P-6001	TREATMENT FEED	300						TREATMENT VENDOR		
P-6002	EFFLUENT STORAGE AREA FRAC TANK TO INFLUENT TANKS	600	208					RAIN FOR RENT	HH-125C	
P-6003	EFFLUENT STORAGE AREA SUMP TO EFFLUENT STORAGE AREA FRAC TANK	200	9					RAIN FOR RENT	DV-80M	
P-6004	TREATMENT SYSTEM (WTS) AREA SUMP TO INFLUENT TANK	200	24					RAIN FOR RENT	DV-80M	
P-6005	EXCAVATION (BMP) AREA DEWATERING TO INFLUENT TANK	2,000	90					RAIN FOR RENT	DV-200C	
P-7001	FLOCCULATION / CLARIFIER FEED	300						TREATMENT VENDOR		
P-7002	FILTER FEED (CONTACT WATER)	300						TREATMENT VENDOR		
P-7003	CLARIFIER SLUDGE							TREATMENT VENDOR		
P-8001	TREATMENT SYSTEM (WTS) AREA FRAC TANK TO EFFLUENT STORAGE TANKS	1,000	140					RAIN FOR RENT	DV-150I	
P-8002	EFFLUENT STORAGE TANKS TO DIFFUSER OR INFLUENT TANKS	1,000	64					RAIN FOR RENT	DV-200C	





Reuse of Documents

This document and the ideas and designs incorporated herein, as an instrument of professional service, is the property of GHD and shall not be reused in whole or in part for any other project without GHD's written authorization. © 2024 GHD

SAN JACINTO RIVER
WASTE PITS

NORTHERN IMPOUNDMENT FINAL 100% REMEDIAL DESIGN HARRIS COUNTY, TEXAS

1	100% EPA SUBMITTAL			07/17/
No.	Issue	Drawn	Approved	Da
Draw	n EAW	Designer	WSK	
	Drafting Check		WSK	
	Project Coordinator CM		July 17, 2	024
This document shall not be used for construction unless signed and sealed for construction.		Scale	AS SHOW	/N
Original Size		Е	Bar is one in	ich on

Project No. **11215702**

Arch D

Title

MECHANICAL SCHEDULE

original size drawing

Sheet - of -

Sheet No.

P-017

THIS DOCUMENT IS RELEASED FOR THE PURPOSE OF EPA REVIEW UNDER THE AUTHORITY OF NORTON FOGEL, P.E. 144491 ON 07/17/2024. IT IS NOT TO BE USED FOR CONSTRUCTION, BIDDING, RECORDATION, CONVEYANCE OR SALES PURPOSES.

GHD SERVICES INC.

JOB NO. $\frac{11215702}{}$ FILE NO. $\frac{001}{}$ CHD TEXAS FIRM REGISTRATION NO. $\frac{}{}$

100% EPA SUBMITTAL