

AECOM 303 E. Wacker Drive, Suite 1400 Chicago, Illinois 60606 312-373-7700 tel 312-373-6800 fax

September 28, 2018

Mr. Robert Wilson Mobilitie, LLC 120 S. Riverside Plaza, Suite 1800 Chicago, IL 60606

RE: Installation of Wireless Cellular Service Equipment

Permit No.: DOT949398

Permit Address: 588 E. Illinois St., Chicago, Illinois

AECOM Project No. 60579801

Dear Mr. Wilson:

Pursuant to conditions specified in a permit (see attached) issued by the City of Chicago, radiation monitoring was required to be performed at the above referenced site. AECOM Technical Services, Inc. (AECOM) provided the required radiation surveillance on September 18, 2018 for an excavation related to an installation of small wireless cellular service equipment.

Surveying was performed on the fill removed at 588 E. Illinois St. (see sketch), required to address a replacement of an existing light-base and an excavation of a related trench. The trench excavation was approximately 15-feet long, 1.5 to 3-feet wide, and to a depth of 3-feet below ground surface (bgs). The light-base excavation utilized a hydro-vacuum truck to excavate a 2-foot diameter hole to 9.5-feet bgs. See attached sketch for the location of excavation.

The monitoring did not indicate that the fill soils were above the removal action level established by the U.S. Environmental Protection Agency (USEPA) for the Streeterville area of Chicago. The USEPA removal action level for Chicago's Streeterville area is 7.1 picocuries per gram (pCi/g) total radium (Ra-226 + Ra-228). Gamma radiation count measurements for the project were recorded using Ludlum Models 2221 survey meter and a shielded 2 x 2 inch Nal probe (Model 44-10). For the instrument used (S/N: 172309), the gamma count threshold indicative of the 7.1 pCi/g removal action level is 6,669 counts per minute (cpm) shielded short cord configuration and 6,456 cpm for the shielded long cord configuration.

The field gamma measurements within the excavation during the excavation process did not exceed the instrument threshold previously stated, and ranged from a minimum of 1,800 cpm to a maximum of 4,000 cpm shielded. The general subsurface stratigraphy was composed of urban fill and gravel. Based on field observations there was no indication of the presence of radiologically-contaminated fill and/or an exceedance of the USEPA removal action level of 7.1 pCi/g total radium. A copy of the permit and a field sketch documenting the area where work was performed, have been included as attachments.

As part of the permit conditions, this letter has been forwarded to:

Chicago Department of Public Health Attention: Mr. Terry Sheahan 333 South State Street, Room 200 Chicago, Illinois 60604 Permit No.: DOT949398

Permit Address: 588 E. Illinois St.

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Please contact us with any questions you have regarding this letter or the reported results.

Regards,

Andrew Kozak Geologist Steven C. Kornder, Ph.D. Senior Project Geochemist

cc: Terry Sheahan, Chicago Department of Public Health

Verneta Simon, USEPA Jose J Galvez, Lyons-Pinner

Attachments: Permit

Annotated Drawing and Results

PERMIT



DEPARTMENT OF PUBLIC HEALTH CITY OF CHICAGO

(STREETERVILLE Right-of-Way)

Notice is hereby given that the site you have requested a permit for is recorded with the City of Chicago Department of Public Health (CDPH) as potentially having environmental contamination on the site and adjacent right-of way. This environmental contamination could present a threat to human health and safety in connection with work performed at the site, or in the adjacent right-of-way, if proper safeguards are not employed.

A file containing detailed information regarding the aforementioned environmental contamination is available for review at CDPH at 333 S. State St., Room 200, Chicago, Illinois 60604 during normal business hours (8:30AM-4:30PM, Monday through Friday). Contact (312) 745-3152 for an appointment. This file must be reviewed and the remainder of this form completed before the permit can be issued if the ground is exposed or excavated. Please note that for some locations, additional health and safety procedures may be required by law.

Please complete the following:

For CDPH Use Only

I have reviewed and understand the documents, maintained by CDPH, regarding environmental contamination of the site and adjacent right-of-way. Further, I will ensure that all work at the subject site and adjacent right-of-way, and any monitoring required including but not limited to radiation monitoring, will be performed in a manner that is protective of human health and the environment and in compliance with all applicable local, state, and federal laws, rules, and regulations, especially those pertaining to worker safety and waste management. I will ensure that the results of any radiation monitoring and/or surveying conducted shall be provided to the CDPH and the United States Environmental Protection Agency within two (2) weeks of their completion. If any elevated levels of radioactive material are detected, I will immediately contact the United States Environmental Protection Agency at (800) 424-8802.

infilediatery confact the officed states Environmental Protection Agency at	.1 (000) 424-0002.	1	. 1	
Applicant Name (print): Robert Wilson	Signature:	Webst 2		
Site Address and Work Location (Describe exact site location and attach r	<u>map</u>):			
588 E Illinois (see attached construction drawings)				
Nature of Work: Attach small cell wireless equipment to replacement	nt light pole.			
Company Name, Address, Phone No.: Mobilitie, LLC, 120 S. Riverside	e Plaza, Suite 1800, C	Chicago, IL, 606	06, (312) 343-48	382
General / Prime Contractor Name, Address, Phone No.: Lyons-Pinner, J Include subcontractor information if applicable) 708-588-6813 Safety Officer / Phone No.	lose Galvez, 650 E El	m Ave, La Gran	ige, IL 60525	
Radiation Contractor / Phone No. and email address (if applicable) AECO	OM, Steve Kornder, 2	62 515-7700		
Check if City Department Work Department Name:				
CDOT Permit No.: DOT949398		10		
Today's Date: <u>5/9/2018</u> Expected Start Date: <u>5/14/2018</u>	CDPH Approval	/ Date	ealum:	5-15-18
Please return this completed form to the Chicago Department of Transports Office, City Hall – Room 905, 121 N. LaSalle St., Chicago, Illinois 60602 Friday)	ation, Division of Infras during normal business	structure Manager hours (8:30 AM	nent, Public Way - 4:30 PM, Monda	Permit ay through


INDEX OF SHEETS SHEET NO. SHEET TITLE INDING RISER DIAGRAM PALE LOADING REPORT

Intelligent infrastructure

DASC CH90XSA77F

SITE ADDRESS

588 E. ILLINOIS ST.

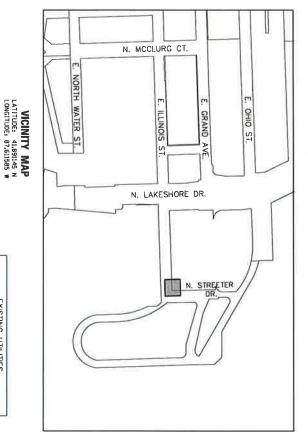

DEO WORK ORDER #: 11717026



WARD:

PROJECT INFORMATION

ADDRESS/CROSS ST:

SBB E. ILLINOIS ST. CHICAGO, IL 60611

UTILITIES: COUNTY:

POWER: "COMED"
TELEPHONE: "AT&T"
CABLE: "COMCAST"
GAS: "PEOPLES"

COOK COUNTY

PUBLIC RIGHT-OF-WAY MOBILITIE LLC

POLE LOCATION
588 E. ILLINOIS ST.
LATITUDE: 41.891145 N
LONGITUDE: 87.611585 W

EXISTING POLE TO BE REMOVED AND REPLACED TO MOUNT PROPOSED LESSEE ANTENNA, RRU AND EQUIPMENT.

		BUS P	400	A NEW	SPEED		*	0	*	4	b	0	0	0	*	Ħ	
APPROX LO	RAILROAD	PAD BUS PAD	OLD ADA SDEWALK R	NEW ADA SIDEWALK F	SPEED BUMP	TO BE DETERMINED BY	MEDALLION	POLE	LIGHT POLE	SIGN	חשרונה שסרב	STORM CATCH BASIN	STORM WH	UTILITY MH	TREE W/GRATE	FIRE HYDRANT	MXS
X. LOCATION H-H-H-H-H-H-H-H-H-H-H-H-H-H-H-H-H-H-H-	AD TRACKS		RAMP	RAMP		BY FIELD ENGINEER		DIVVY BIKE STATION	PARKING METER OLD	BUS SHELTER BUS SHELTER	TRAFFIC SIGNAL CAMERA	BIKE LANE	PM PARKING METER NEW	PLANTER PLANTER	TREE > 6"	* TREE < 6"	YMBOLS



PROFESSIONAL LICENSURE



REVISIONS

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200	
GTLL LIBES	ISSUED FOR
	F QR
	OLC.
	OUC REVIEW
	3/28/2018

TITLE SHEET

NAME OF THE PARTY	CBF
ECKED BY:	MUH
ATT.	3/28/2018
DASC: *	DASC CHOOKS 7225 (OHC# 2018-81318)

FULL SIZE PLANS HAVE BEEN PREPARED USING STANDARD ENGRERING SCALES, REDUCED SIZE PLANS HIL HOT CONFORM TO STANDARD SCALES, IN MAKING MEASUREMINTS ON REDUCED PLANS, THE ABOVE SCALES MAY BE USED,

MOBILITIE:
PROJECT MANAGER
CONTACT:

ROBERT WILSON
120 S. RIVERSIDE PLAZA,
CHICAGO, IL 60606
PHONE: 312-638-5363

AT&T AND COMMUNICATIONS HECH PRESSURE CAS MAIN LOW PRESSURE GAS MAIN

EXISTING UTILITIES

PROJECT CONTACTS

100-1"= 20"

IDOT HIGHWAY STANDARDS * 701801-06 701901-07 701501-06 701006-05

STANDARDS

CDOT RULES & REGULATIONS FOR CONSTRUCTION IN THE PUBLIC WAY MARCH 2016

INSTALL 20' ELECTRICAL PVC
CONNECT TO COM-ED SECONDARY FEED

PROJECT SUMMARY

JURISDICTION: APPLICANT: PROPERTY OWNER:

CDOT

DIGGER: 312-744-7000 CONTRACTOR SHALL CALL DIGGER TWO (2) WORKING DAYS (48 HOURS) BEFORE DIGGING.

DB STERLIN CONSULTANTS, INC. ENGINEER CONTACT:

123 N. WACKER DR. SUITE 2000 CHICAGO, IL 60606 PHONE: 312-B57-1006

SEWER DEO COMED

WATER MAIN

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18.0	


AS SHOWN

ANNOTATED DRAWING AND RESULTS

3. HAND EXCAVATION IS REQUIRED TO FIELD VERIFY THE HORIZONTIAL AND VERTICAL LOCATION OF THE 12-INCH WATER MAIN PRIOR TO CROSSING. A MINIMUM OF 4 FEET OF UNDISTURBED SOIL IS TO REMAIN ON EITHER SIDE OF THIS EXISTING MAIN. EXTREME CAUTION MUST BE TAKEN TO AVOID DAMAGE TO THESE WATER FACILITIES. IF ANY DAMAGE OCCURS TO THIS DEPARTMENTS FACILITIES THE CONTRACTOR AND/OR OWNER WILL BE RESPONSIBLE FOR THE COST OF REPAIRING OR REPLACING THE DAMAGED FACILITIES.

4. UPON PROJECT COMPLETION, RESIDENT ENGINEERS MUST CONTACT THE DWM SEWER EVALUATION SECTION AT 312-747-4680 TO SCHEDULE A FIELD MEETING FOR PROJECT ACCEPTANCE. PRIVATE SEWER DRAINS (W/BASEMENTS) TYPICALLY HAVE APPROXIMATELY 5 FEET OF COVER. DUE TO POTENTIAL VERTICAL CONFLICTS IN THE PARKWAY, THE CONTRACTOR MUST TELEVISE ALL PRIVATE DRAINS AFTER CONSTRUCTION. A COPY OF THE DVD MUST BE PRESENTED TO THE DWM SEWER INSPECTOR FOR PROJECT ACCEPTANCE.

5. USE #6 AWG STRANDED CABLE UNLESS OTHERWISE NOTED.

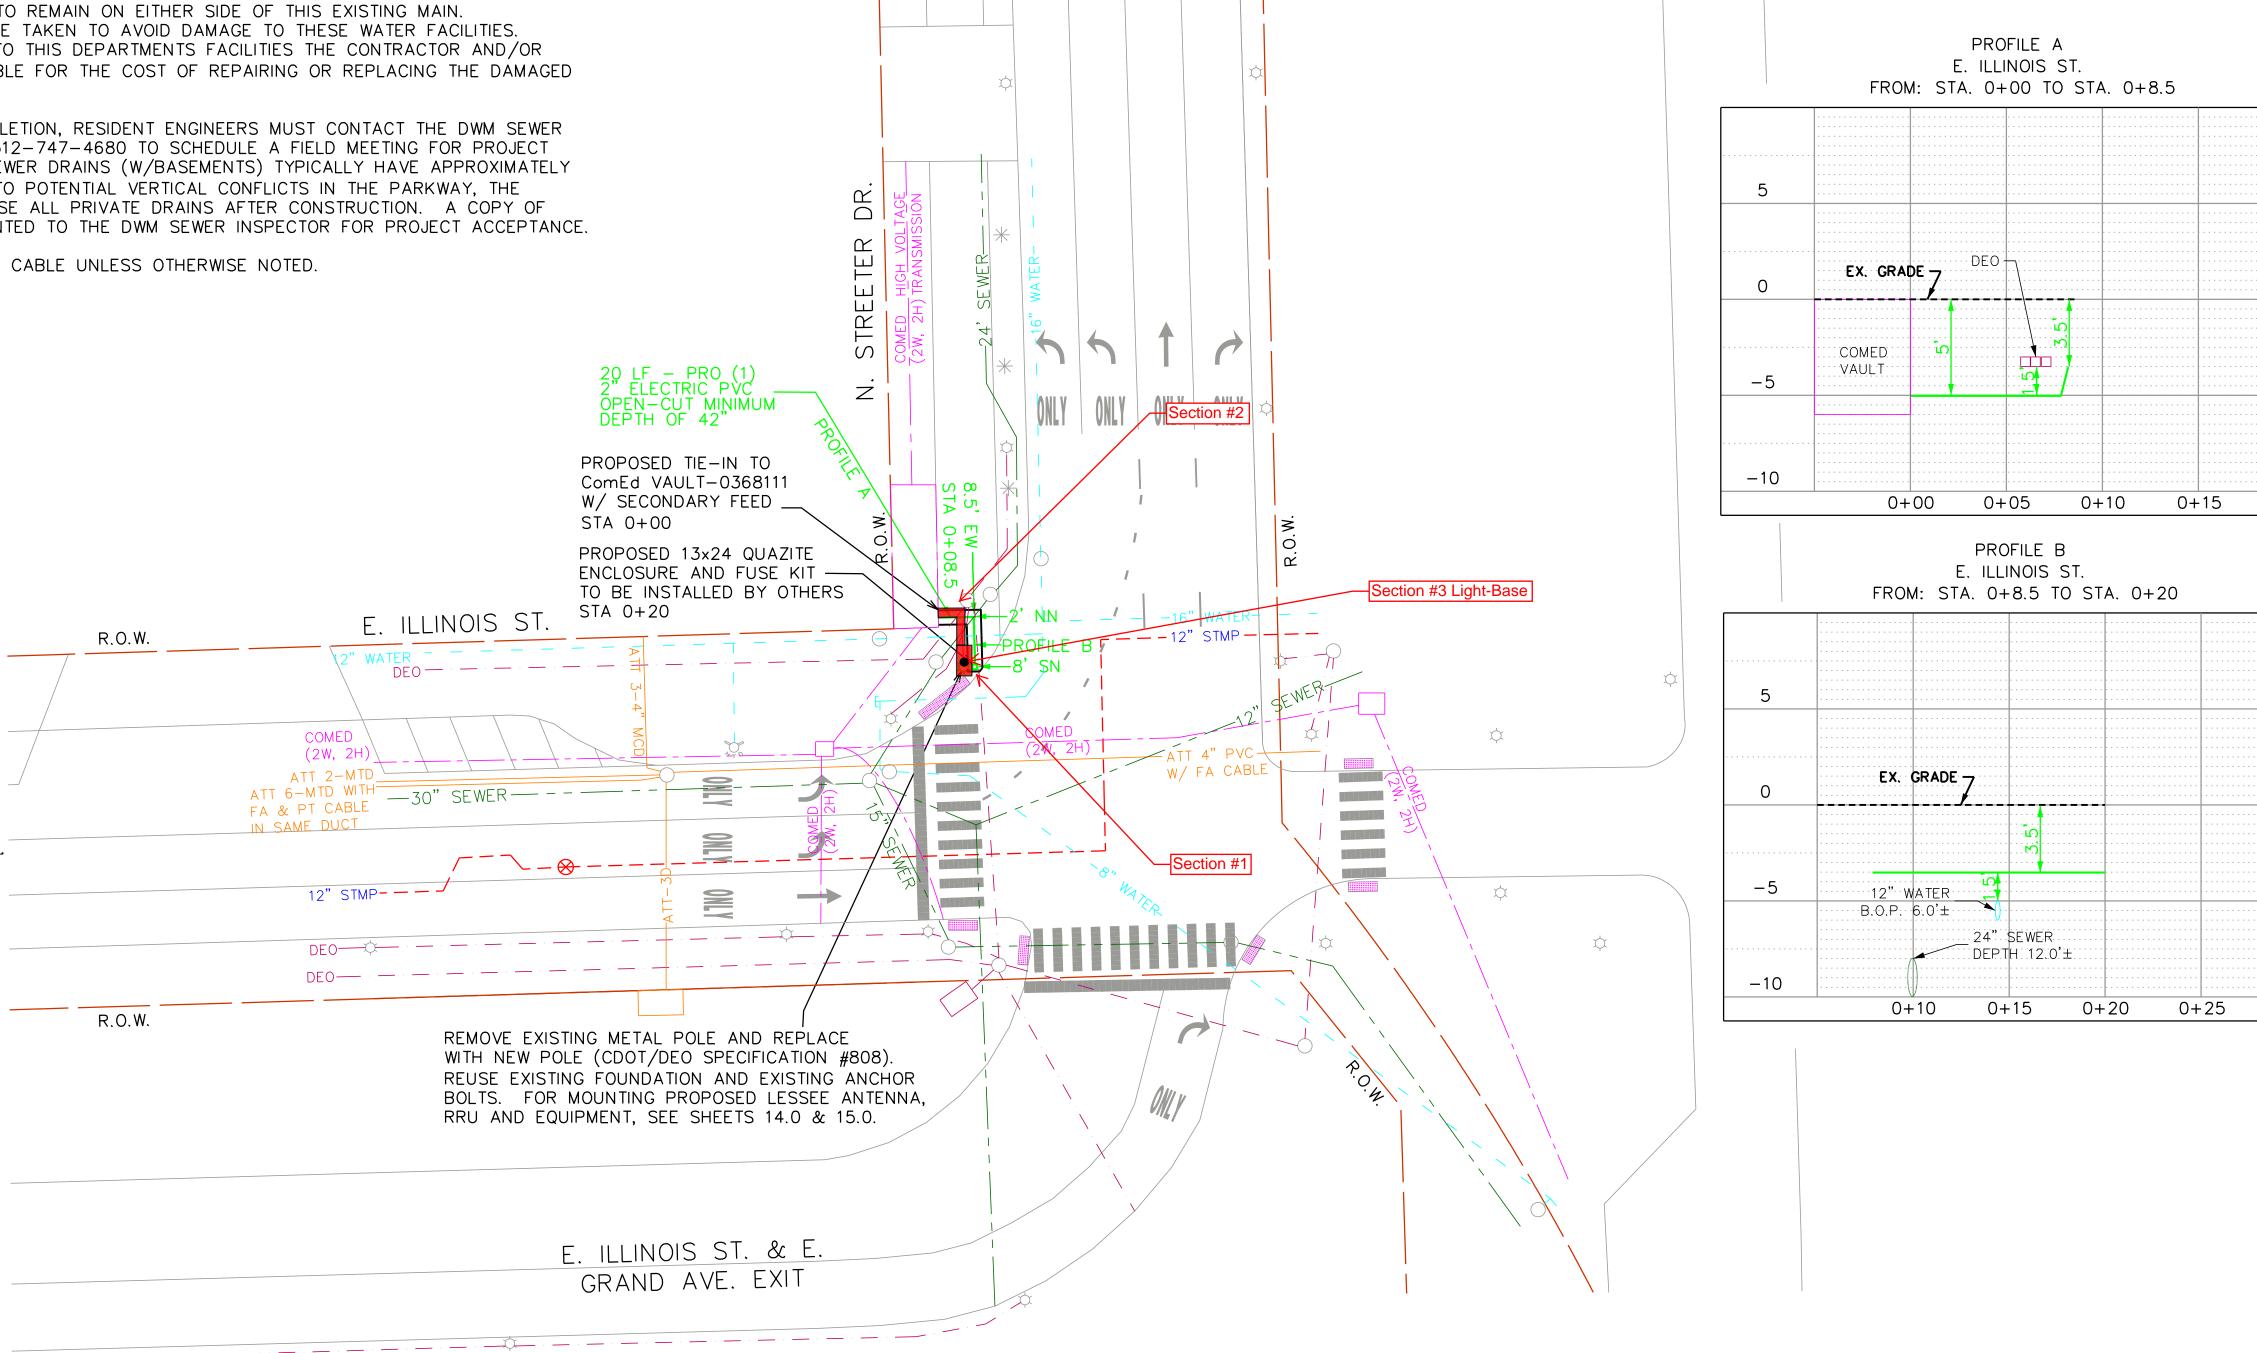


80'

CONTRACTOR TO COORDINATE WITH BUILDING OWNER REGARDING CONSTRUCTION SCHEDULE AND TO VERIFY NO VAULTED SIDEWALK IS PRESENT AT PROPOSED POLE LOCATION.

CONTRACTOR TO USE EXTREME CAUTION WHEN CROSSING OVER THE 12" WATER MAIN IN N. ILLINOIS ST. SEE WATER DEPT GENERAL NOTE ON SHEET 2

NOTE: MOBILITIE EQUIPMENT TO BE PAINTED BLACK.



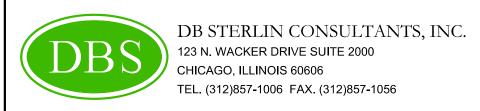

PROFESSIONAL LICENSURE



3/28/2018

REVISIONS

ISSUED FOR OUC REVIEW - 3/28/2018

SHEET TITLE:

1"= 20' HORIZONTAL

1"= 5 VERTICAL

SITE PLAN

DRAWN BY:	CBF	
CHECKED BY:	HJM	
DATE:	3/28/2018	
PROJECT #		

DASC CH90XSA77F (OUC# 2018-81318) TITLE: 588 E ILLINOIS ST

SCALE: AS SHOWN 4.0 18.0

Gamma Survey Results 588 E. Illinois St. Lyons-Pinner DOT949398

Survey Equipment

Ludlum 2221 S/N:	172039
Probe 2x2 Nal S/N:	PR179406
shielded cutoff (long cable):	6,669 cpm (6,456 cpm)
background:	-
Personnel:	D. Domino
Date of Screening:	8.18.18
Permit #:	DOT949398

Survey Results

Location	Depth (inches)	Readings (CPM)
1	0	concrete
	6	1800 - 2500
2	0	concrete
	6	1800 - 2500
	24	1800 - 2000
3	0	concrete
	6	1800 - 2500*
	24	2000 - 2500*
	60	2200 - 3300*
	78	2200 - 4000*
	114	3400 - 3500*

Note: * - long cable